FOR PROFESSIONAL SEALS AND SIGNATURES, SEE SHEET NO. 2

STATE OF ILLINOIS 04-24-2020 LETTING ITEM 186 DEPARTMENT OF TRANSPORTATION

KANE 415 1 18-00215-21-BR CONTRACT NO. 61GO2

FOR INDEX OF SHEETS, SEE SHEET NO. 3

DESIGN DESIGNATION

LONGMEADOW PKWY: 30,000 (40) MINOR ARTERIAL 5.36 (PCC-20) BOLZ RD: 13,000 (40) MAJOR COLLECTOR 1.93 (FD-20) BOLZ RD CONNECTOR: 13,000 (40) MAJOR COLLECTOR 1.93 (FD-20) IL RTE 25: 34,000 (40) OTHER PRINCIPAL ARTERIAL 10.05 (PCC-20)

TRAFFIC DATA

TRAFFIC DATA

LONGMEADOW PARKWAY: IL ROUTE 25

30,000 (2040)

 \bigcirc

SPEED LIMIT:

20,000 (2010) 34,000 (2040)

POSTED - 45 MPH DESIGN - 50 MPH

SPEED LIMIT:

POSTED – 45 MPH DESIGN – 50 MPH

LONGMEADOW PKWY

SEC C2 IMPROVEMENTS

BEGIN STA. 2217 + 65.00

COMPOSITION:

P.V. - 97.0% S.U. - 2.0% M.U. - 1.0%

COMPOSITION:

P.V. - 96.2% S.U. - 2.2% M.U. - 1.6%

BOLZ ROAD

SCHAUMBURG,

CARMEN

ENGINEER:

PROGRAM

AID

 \bigcirc

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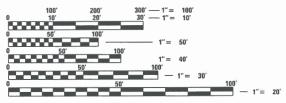
2,390 (2010) 11,000 (2040)

SPEED LIMIT: POSTED - 30 MPH DESIGN - 30 MPH

COMPOSITION:

P.V. - 96.0% S.U. - 2.0% M.U. - 2.0%

PROJECT IS LOCATED IN THE VILLAGE OF CARPENTERSVILLE & DUNDEE TOWNSHIP



ENGINEERING SCALES. REDUCED SIZED PLANS WILL NOT CONFORM TO STANDARD SCALES. IN MAKING MEASUREMENTS ON REDUCED PLANS, THE ABOVE SCALES MAY BE USED.

J.U.L.I.E.


JOINT UTILITY LOCATION INFORMATION FOR EXCAVATION 1-800-892-0123

OR 811

CONTRACT NO. 61G02

VOLUME 1 PLANS FOR PROPOSED FEDERAL AID HIGHWAY

FAU 2298 (LONGMEADOW PARKWAY) ROADWAY CORRIDOR CONSTRUCTION WEST OF SANDBLOOM RD TO IL RTE. 25 SECTION 18-00215-21-BR **PROJECT NUMBER XGDF(875)**

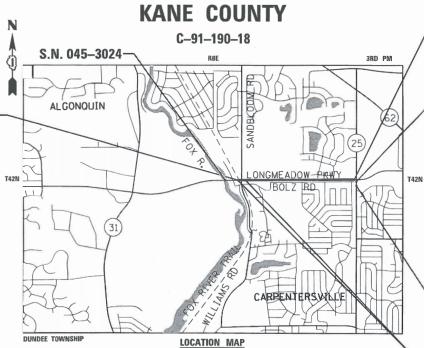

ROAD	FROM TO STATION STATION		LENGTH (FEET)	LENGTH (MILES)	
LONGMEADOW PKWY	2217 + 65.00	2270 + 39.80	5,274.80	1.00	
SANDBLOOM BRIDGE	2217 + 58.21	2218 + 40.85	82.64	0.01	
BOLZ ROAD	504 + 32.79	532 + 50.00	2,817.21	0.53	
BOLZ ROAD CONNECTOR	699 + 89.80	705 + 05.16	515.36	0.10	
ILLINOIS ROUTE 25	608 + 75.88 612 + 15.82		339.94	0.06	
NET AND GROSS LENGTH	8,947.31	1.69			

LONGMEADOW PKWY **SEC C2 IMPROVEMENTS** END STA. 2270 + 39.80

ILLINOIS RTE 25 SEC C2 IMPROVEMENTS END STA. 612 + 15.82

ILLINOIS RTE 25 SEC C2 IMPROVEMENTS **BEGIN STA. 608 + 75.88**

SANDBLOOM BRIDGE **BEGIN STA. 2217 + 58.21** END STA. 2218 + 40.85 S.N. 045-3077



STATE OF ILLINOIS DEPARTMENT OF TRANSPORTATION SUBMITTED ANURRY 6 20 20 ANE COUNTY ENGINEER DISTRICT ONE ENGINEER OF LOCAL ROADS & STREETS RELEASING FOR BID BASED ON LIMITED

REGIONAL ENGINEER

PRINTED BY THE AUTHORITY OF THE STATE OF ILLINOIS

REVIEW FEBRUARY 5 20 20

DESIGN ENGINEERING RESPONSIBILITY:

CMT RESPONSIBILITY: SHEETS 1 TO 118 , 136 TO 224 , 230 TO 231 , 257 TO 415

License No. 184-000613

License No. 184-000613

BLA RESPONSIBILITY: SHEETS 119 TO 135

BMD RESPONSIBILITY: SHEETS 232 TO 256

HITCHCOCK DESIGN GROUP RESPONSIBILITY: SHEETS 225 TO 229



JEFFERY M. SEDIG, P.E. IL REGISTRATION #062-061748 CMT, INC. (630) 820-1022

DATE EXP. 11/30/2021



JOSEPH T. HEGER, P.E. S.E. IL REGISTRATION #081–008156 CMT, INC. (630) 820–1022

DATE EXP. 11/30/2020



License No. 184-000613











Asad Bajwa

Fcb-27-2020

ASAD M. BAJWA, P.E. IL REGISTRATION #062-055662 CMT, INC. (630) 820-1022 DATE EXP. 11/30/2021

KEVIN KENNIFF, P.E. IL REGISTRATION #062-054009 BLA, INC. (630) 438-6400 01/27/20

DATE EXP. 11/30/2021

with Carried

ROBERT M. GOVEIA, P.E. IL REGISTRATION #062-005534 BMD, INC. (312) 521-8918

DATE EXP. 11/30/2021

EXCMT

USER NAME = Jeff Sedig	DESIGNED - JMS	REVISED -
	DRAWN - JMS	REVISED -
PLOT SCALE = 2.0000 '/ in.	CHECKED - KDF	REVISED -
PLOT DATE = 3/2/2020	DATE - 01/13/2020	REVISED -

STATE OF ILLINOIS **DEPARTMENT OF TRANSPORTATION**

LONGM	LONGMEADOW			
SEALS	AND	SIGN	NATURES	

SECTION	COUNTY	TOT
00215-21-BR	KANF	41

2298 18-0 CONTRACT NO. 61G02 SCALE: NTS SHEET 1 OF 1 SHEETS STA. TO STA.

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INDEX OF SHEETS (VOLUME 1)
                  COVER SHEET (VOLUME 1)
                  SEALS AND SIGNATURES
                  INDEX OF SHEETS, HIGHWAY STANDARDS, AND COMMITMENTS (VOLUME 1)
                  GENERAL NOTES
      ΤO
           24
                  SUMMARY OF QUANTITIES
  25
      ΤO
                  EARTHWORK SCHEDULES
      TO
  27
           30
                  TYPICAL SECTIONS -- LONGMEADOW PARKWAY
      ΤO
  31
           35
                  TYPICAL SECTIONS -- BOLZ ROAD
  36
      TO 38
                  TYPICAL SECTIONS -- BOLZ ROAD CONNECTOR / SANDBLOOM
  39
                  SUPERELEVATION TABLES
  40
      TO 44
                  ALIGNMENT, TIES & BENCHMARKS
  45
      ΤO
           48
                  REMOVAL PLAN - LONGMEADOW PARKWAY
      ΤO
           55
                  PLAN & PROFILE - LONGMEADOW PARKWAY
  49
      TO
                  PLAN & PROFILE - BOLZ ROAD / BOLZ ROAD CONNECTOR
                  SUGGESTED STAGES OF CONSTRUCTION & TRAFFIC CONTROL -- GENERAL NOTES
  60
      TΟ
  61
                  SUGGESTED STAGES OF CONSTRUCTION & TRAFFIC CONTROL -- STAGE 1
                  SUGGESTED STAGES OF CONSTRUCTION & TRAFFIC CONTROL -- STAGE 2
      TΟ
  68
       ΤO
           71
                  SUGGESTED STAGES OF CONSTRUCTION & TRAFFIC CONTROL -- STAGE 3
                  SUGGESTED STAGES OF CONSTRUCTION & TRAFFIC CONTROL -- STAGE 4
      ΤO
                  SUGGESTED STAGES OF CONSTRUCTION & TRAFFIC CONTROL -- STAGE 5
      ΤO
           82
                  SUGGESTED STAGES OF CONSTRUCTION & TRAFFIC CONTROL -- IDOT D1 DETAILS
  83
      ΤO
           88
  89
      ΤO
           92
                  GRADING PLAN -- LONGMEADOW PARKWAY
                  STORMWATER PREVENTION POLLUTION PLAN
      ΤO
                  EROSION & SEDIMENT CONTROL PLAN -- STAGE 1
                  EROSION & SEDIMENT CONTROL PLAN -- STAGE 2
      TO
  97
           99
  100
      TΩ
          103
                  EROSION & SEDIMENT CONTROL PLAN -- STAGE 3
      ΤO
                  EROSION & SEDIMENT CONTROL PLAN -- STAGE 4
  104
  108
      ΤO
          109
                  EROSION & SEDIMENT CONTROL PLAN -- STAGE 5
      TO 118
                  EROSION & SEDIMENT CONTROL PLAN -- DETAILS
  110
  119
      TO 125
                  DRAINAGE & UTILITIES - LONGMEADOW PARKWAY
  126
      TO 128
                  DRAINAGE & UTILITIES - BOLZ ROAD
  129
                  POND GRADING PLAN; LONGMEADOW PARKWAY
  130
                  IDOT D1 DETAIL - MANHOLE WITH RESTRICTOR PLATE
  131
                  DRAINAGE DETAILS; DOUBLE INLET, SPECIAL
      TO 135
  132
                  DRAINAGE TABLES
  136
      TO 140
                  WATERMAIN RELOCATION PLAN
  141
      TO 142
                  FORCE MAIN RELOCATION PLAN
                  JOINTING PLANS -- LONGMEADOW PARKWAY
  143
      TO 150
  151
                   JOINTING PLANS -- CONSTRUCTION DETAILS
  152
                  ROADWAY DETAILS, NORTHEAST PATH TRANSITION
                  ROADWAY DETAILS; SANDBLOOM ROAD & BOLZ ROAD
  153
  154
                  ROADWAY DETAILS; SEGMENTAL CONCRETE BLOCK WALL
  155
                  ROADWAY DETAILS; ORNAMENTAL RAILING DETAILS
  156
                  ROADWAY DETAILS; BOLZ ROAD
  157
                  ROADWAY DETAILS; OXFORD DRIVE & BOLZ ROAD
  158
                  ROADWAY DETAILS; FUTURE TOLL PLAZA SITE GRADING PLAN
                  ROADWAY DETAILS; CELL TOWER ACCESS DRIVE
```

160 ROADWAY DETAILS; CELL TOWER ACCESS DRIVE GATE 161 ROADWAY DETAILS; LONGMEADOW PARKWAY & BOLZ ROAD CONNECTOR ADA RAMPS 162 ROADWAY DETAILS; BOLZ ROAD PATH 163 ROADWAY DETAILS; BOLZ ROAD PATH & SIDEWALK 164 ROADWAY DETAILS: LONGMEADOW PARKWAY & ILLINOIS ROUTE 25 ADA RAMPS 165 TO 171 BOL7 ROAD ROUNDABOUT DETAILS 172 TO 176 IDOT DISTRICT 1 DETAILS - BUREAU OF DESIGN 177 PAVEMENT MARKING PLAN -- GENERAL NOTES 178 TO 183 PAVEMENT MARKING PLAN -- LONGMEADOW PARKWAY 184 PAVEMENT MARKING PLAN -- ILLINOIS 25 185 TO IDOT DISTRICT 1 DETAILS - BUREAU OF TRAFFIC TO 190 SIGNING PLAN -- SIGN SCHEDULE 191 TO 197 SIGNING PLAN -- LONGMEADOW PARKWAY & ILLINOIS 25 198 TO 217 SIGN PANEL -- DETAILS TO 219 218 SIGNING PLAN -- DETAILS 220 TO 223 LANDSCAPING PLAN -- LONGMEADOW PARKWAY LANDSCAPING PLAN -- DETAILS 224 225 TO 228 TREE PLANTING PLAN 229 TREE PLANTING DETAILS

INDEX OF SHEETS (VOLUME 2)

COVER SHEET (VOLUME 2) 230 231 INDEX OF SHEETS, HIGHWAY STANDARDS, AND COMMITMENTS (VOLUME 2) 232 TO 239 FIBER-OPTIC CABLE INTERCONNECT PLAN - LONGMEADOW PARKWAY 240 TO 254 TRAFFIC SIGNAL PLANS TO 256 255 TOLL PLAZA PLANS LIGHTING PLAN 257 TO 261 262 TO 273 LIGHTING PLAN DETAILS 274 TO 298 STRUCTURAL DRAWINGS, LONGMEADOW PARKWAY BRIDGE OVER SANDBLOOM (SN 045-3077) 299 TΟ 313 STRUCTURAL DRAWINGS, MSE WALL #3 (SN 045-3077) TO 370 314 CROSS SECTIONS -- LONGMEADOW PARKWAY 371 TO 398 CROSS SECTIONS -- BOLZ ROAD 399 TO 401 CROSS SECTIONS -- BOLZ ROAD CONNECTOR TO 405 CROSS SECTIONS -- HILL EAST OF BOLZ CONNECTOR 406 TO 409 CROSS SECTIONS -- POND WEST OF BOLZ CONNECTOR CROSS SECTIONS -- CELL TOWER ACCESS 410 TO 412 413 TO 415 CROSS SECTIONS -- ILLINOIS 25

COMMITMENTS

- FORESTED AREAS CAN BE CLEARED ONLY BETWEEN OCTOBER 15TH AND MARCH 14TH TO AVOID THE ACTIVE SEASON FOR THE RUSTY PATCHED BUMBLE BEE.
- 2. GRASSED AREAS WITHIN THE PROJECT CONSTRUCTION LIMITS SHALL BE MOWED WEEKLY FROM MARCH 15TH TO OCTOBER 14TH OF THE YEAR OF CONSTRUCTION. THE CONTRACTOR SHALL BEGIN WITH MOWING OPERATIONS IMMEDIATLEY FOLLWING NOTICE TO PROCEED IF WITHIN THESE DATES.

HIGHWAY STA	NDARDS	630301-09	SHOULDER WIDENING FOR TYPE 1 (SPECIAL) GUARDRAIL TERMINALS	
000001-07	STANDARD SYMBOLS AND ABBREVIATIONS	631011-10	TRAFFIC BARRIER TERMINAL, TYPE 2	
001001-02	AREAS OF REINFORCEMENT BARS	631031-1 6	TRAFFIC BARRIER TERMINAL, TYPE 6	
001006	DECIMAL OF AN INCH AND OF A FOOT	701006-05	OFF-RD OPERATIONS, 2L, 2W, 15' TO 24" FROM PAVEMENT EDGE	
280001-07	TEMPORARY EROSION CONTROL SYSTEMS	701011-04	OFF-RD MOVING OPERATIONS, 2L, 2W, DAY ONLY	
420001-09	PAVEMENT JOINTS	701101-05	OFF-RD OPERATIONS, MULTILANE, 15' TO 24" FROM PAVEMENT EDGE	
420111-04	PCC PAVEMENT ROUNDOUTS	701106-02	OFF-RD OPERATIONS, MULTILANE, MORE THAN 15' AWAY	
420401-13	PAVEMENT CONNECTOR (PCC) FOR BRIDGE APPROACH SLAB	701301-04	LANE CLOSURE, 2L, 2W, SHORT TIME OPERATIONS	
420701-03	PAVEMENT WELDED WIRE REINFORCEMENT	701311-03	LANE CLOSURE 2L, 2W MOVING OPERATIONS - DAY ONLY	
424001-11	PERPENDICULAR CURB RAMPS FOR SIDEWALKS	701421-08	LANE CLOSURE, MULTILANE, DAY OPER. ONLY, FOR SPEEDS 2 45 MPH TO 55 MPH	
424031-02	MEDIAN PEDESTRIAN CROSSINGS	701426-09	LANE CLOSURE, MULTILANE, INTERMITTENT OR MOVING OPER., FOR SPEEDS 245 MPH	
442201-03	CLASS C AND D PATCHES	701501-06	URBAN LANE CLOSURE, 2L, 2W, UNDIVIDED	
515001-0 4	NAME PLATES FOR BRIDGES	701601-09	URBAN LANE CLOSURE, MULTILANE, 1W OR 2W WITH NONTRAVERSABLE MEDIAN	
542301-03	PRECAST REINFORCED CONCRETE FLARED END SECTION	701602-10	URBAN LANE CLOSURE, MULTILANE, 2W WITH BIDIRECTIONAL LEFT TURN LANE	
542306-03	PRECAST REINFORCED CONCRETE ELLIPTICAL FLARED END SECTION	701701-10	URBAN LANE CLOSURE, MULTILANE INTERSECTION	
542546-01	FLUSH INLET BOX FOR MEDIAN	701801-06	SIDEWALK, CORNER OR CROSSWALK CLOSURE	
601001-05	PIPE UNDERDRAINS	701901-08	TRAFFIC CONTROL DEVICES	
602001-02	CATCH BASIN TYPE A	704001-08	TEMPORARY CONCRETE BARRIER	
602301-04	INLET - TYPE A	720001-01	SIGN PANEL MOUNTING DETAILS	
602401-06	PRECAST MANHOLE TYPE A 4' DIAMETER	720006-04	SIGN PANEL ERECTION DETAILS	
602402-02	PRECAST MANHOLE TYPE A 5' DIAMETER	720011-01	METAL POSTS FOR SIGNS, MARKERS & DELINEATORS	
602406-10	PRECAST MANHOLE TYPE A 6' DIAMETER	720016-04	MAST ARM MOUNTED STREET NAME SIGNS	
602601-06	PRECAST REINFORCED CONCRETE FLAT SLAB TOP	725001-01	OBJECT AND TERMINAL MARKERS	
602701-02	MANHOLE STEPS	729001-01	APPLICATIONS OF TYPES A & B METAL POSTS (FOR SIGNS & MARKERS)	
604001-04	FRAMES AND LIDS TYPE 1	780001-05	TYPICAL PAVEMENT MARKINGS	
604036-03	GRATE TYPE 8	782006-01	GUARDRAIL AND BARRIER WALL REFLECTOR MOUNTING DETAILS	
604051-04	FRAME AND GRATE TYPE 11	814001-03	HANDHOLES	
604091-03	FRAME AND GRATE TYPE 24	814006-02	DOUBLE HANDHOLES	
606001-07	CONCRETE CURB TYPE B AND COMBINATION CONCRETE CURB AND GUTTER	838001-01	BREAKAWAY DEVICES	
606006-04	OUTLETS FOR CONCRETE CURB AND GUTTER TYPE B-6.24	878001-10	CONCRETE FOUNDATION DETAILS	

DISTRICT ONE STANDARDS

DRIVEWAY DETAILS - DISTANCE BETWEEN R.O.W. AND CURB OR EDGE GREATER THAN OR EQUAL TO 15' (4.5M)

OUTLET FOR CONCRETE CURB AND GUTTER

MANHOLE WITH RESTRICTOR PLATE

BD-22 PAVEMENT PATCHING FOR HMA SURFACED PAVEMENT

BD-48 PCC PAVEMENT ROUNDOUTS AT CURB AND GUTTER

BENCHING DETAIL FOR EMBANKMENT WIDENING

LIGHTING CONTROLLER SINGLE DOOR BE-215

BF-300 LIGHT POLE FOUNDATION 30' TO 35' M.H. 11.5" BOLT CIRCLE

BE-702 MISCELLANEOUS ELECTRICAL DETAILS SHEET A

TRAFFIC CONTROL AND PROTECTION FOR SIDE ROADS, INTERSECTIONS, AND DRIVEWAYS TYPICAL APPLICATIONS RAISED REFLECTIVE PAVEMENT MARKERS (SNOW-PLOW RESISTANT) TC-11

TC-13 DISTRICT ONE TYPICAL PAVEMENT MARKING

TRAFFIC CONTROL AND PROTECTION AT TURN BAYS (TO REMAIN OPEN TO TRAFFIC)

SHORT TERM PAVEMENT MARKING LETTERS AND SYMBOLS TC-16

DETOUR SIGNING FOR CLOSING STATE HIGHWAYS TC-21

TC-22 ARTERIAL ROAD INFORMATION SIGN

DRIVEWAY ENTRANCE SIGNING TC-26

DISTRICT ONE STANDARD TRAFFIC SIGNAL DESIGN DETAILS

PC CONCRETE ISLANDS AND MEDIANS STEEL PLATE BEAM GUARDRAIL

PCC/HMA STABILIZATION AT STEEL PLATE BEAM GUARDRAIL

DBERNAME = Jeff Sedig	DESIGNED	-	JMS	REVISED	=
MODEL NAME =	DRAWN	-	JMS	REVISED	=
PLOT SCALE = 2.0000 '/ in.	CHECKED	-	KDF	REVISED	=
PLOT DATE = 3/2/2020	DATE	-	01/13/2020	REVISED	- -

STATE OF ILLINOIS **DEPARTMENT OF TRANSPORTATION**

INDEX OF		LONGMEAL HIGHWAY			COMMITMENTS
SCALE: NA	SHEET 1	OF 1	SHEETS	STA	TO STA

F.A.U. RTE.	SECTIO	N		COUNTY	TOTAL SHEETS	SHEE NO.
2298	18-00215-2	18-00215-21-BR			415	3
				CONTRACT	NO. 6	31G02
	ILL	INOIS	FED. AI	D PROJECT		

SPECIFICATIONS, STANDARDS, AND SPECIAL PROVISIONS

- 1. ANY REFERENCE TO STANDARDS THROUGHOUT THE PLANS OR SPECIAL PROVISIONS SHALL BE INTERPRETED AS THE LATEST STANDARD OF THE ILLINOIS DEPARTMENT OF TRANSPORTATION UNLESS OTHERWISE NOTED.
- 2. ALL TRAFFIC CONTROL AND OTHER ADVISORY SIGNS NEEDED FOR CONSTRUCTION ARE TO BE FURNISHED BY THE CONTRACTOR IN ACCORDANCE WITH ARTICLE 107.14 OF THE STANDARD
- 3. THE CONTRACTOR SHALL AT ALL TIMES PROVIDE PROTECTION FOR TRAFFIC AS CALLED FOR IN THE APPLICATION OF TRAFFIC CONTROL DEVICES, THE STANDARD SPECIFICATIONS AND

UTILITIES

- 1. THE CONTRACTOR SHALL COOPERATE WITH THE COUNTY AND STATE IF ANY UTILITY IMPROVEMENTS ARE REQUIRED BY THE COUNTY OR STATE WITHIN THE DURATION OF THE
- 2. THE CONTRACTOR SHALL BE RESPONSIBLE FOR CONTACTING THE OWNERS OF ALL UTILITIES PRIOR TO CONSTRUCTION TO DETERMINE THE LOCATION OF ALL UTILITY EQUIPMENT. THE CONTRACTOR SHALL COOPERATE WITH ALL UTILITY OWNERS AS PROVIDED FOR IN THE STANDARD SPECIFICATIONS IF UTILITY RELOCATION, ADJUSTMENT, OR PROTECTION IS NECESSARY.
- THE LOCATION OF EXISTING DRAINAGE STRUCTURES, STORM SEWERS, WATER MAINS, SANITARY SEWERS, AND ANY OTHER PUBLIC OR PRIVATE UTILITIES AS SHOWN ON THE PLANS IS APPROXIMATE, AND THEIR EXACT LOCATION IS TO BE DETERMINED IN THE FIELD BY THE CONTRACTOR.
- 4. MANY OF THE UTILITIES WITHIN THE PROJECT LIMITS WILL BE RELOCATED EITHER BEFORE THE START OF CONSTRUCTION OR DURING CONSTRUCTION. IF UTILITY RELOCATION PERMIT PLANS WERE AVAILABLE PRIOR TO COMPLETION OF DESIGN, THE PLANS SHOW THE PROPOSED UTILITY LOCATION IN A BOLD LINESTYLE. EXISTING UTILITIES TO BE REMOVED OR RETIRED ARE SHOWN WITH A SLASH THROUGH THE UTILITY LINESTYLE. THE ANTICIPATED DATES AND DURATIONS OF THE UTILITY RELOCATION WORK, AS REPORTED BY THE UTILITY COMPANY, ARE SHOWN WITHIN THE STATUS OF UTILITIES SPECIFICATION.
- 5. THE CONTRACTOR SHALL BE RESPONSIBLE FOR THE PROTECTION OF ALL UNDERGROUND AND SURFACE UTILITIES EVEN THOUGH THEY MAY NOT BE SHOWN ON THE PLANS, ANY UTILITY THAT IS DAMAGED DURING CONSTRUCTION SHALL BE REPAIRED OR REPLACED TO THE SATISFACTION OF THE OWNER.
- 6. BEFORE STARTING ANY EXCAVATIONS, THE CONTRACTOR SHALL CALL JULIE AT 1-800-892-0123 FOR FIELD LOCATIONS OF UTILITIES. THE UTILITY CONTACTS OPERATING WITHIN THE PROJECT LIMITS ARE AS FOLLOWS:

COMCAST MARTHA GIERAS Martha_Gieras@cable.comcast.com 688 INDUSTRIAL DR. ELMHURST, IL. 60126 (224)-229-5862

COMED AMIR MAHMUTAGIC amir.mahmutagic@ComEd.com 1 LINCOLN CENTER OAKBROOK TERRACE, IL. 60181 (630)-437-2212

NICOR BRUCE KOPPANG BKoppan@southernco.com 1844 FERRY ROAD NAPERVILLE, IL. 60563 (630)-388-3046

HECTOR GARCIA ha2929@att.com 1000 COMMERCE DRIVE OAK BROOK, IL. 60523 (630)-573-5465

VILLAGE OF CARPENTERSVILLE KEVIN GRAY kgray@cville.org 1075 TAMARAK DRIVE CARPENTERSVILLE, IL. 60110 (224)-293-1613

SEWERS AND WATER MAINS

- 1. INLET FILTERS SHALL BE USED ON ALL EXISTING DRAINAGE STRUCTURES.
- 2. ANY LOOSE MATERIAL DEPOSITED IN THE FLOW LINE OF DRAINAGE STRUCTURES, WHICH OBSTRUCTS THE NATURAL FLOW OF WATER SHALL BE REMOVED AT THE CLOSE OF EACH WORKING DAY. PRIOR TO ACCEPTANCE OF THE IMPROVEMENT, ALL DRAINAGE STRUCTURES SHALL BE FREE OF DIRT AND DEBRIS.
- 3. WHEN EXISTING DRAINAGE FACILITIES ARE DISTURBED, THE CONTRACTOR SHALL PROVIDE AND MAINTAIN IN AN OPERATING CONDITION TEMPORARY OUTLETS AND CONNECTIONS FOR ALL DRAINS, SEWERS, AND CATCH BASINS. THE CONTRACTOR SHALL PROVIDE FACILITIES WHICH HAVE THE CAPACITY TO RECEIVE AND DISCHARGE THE STORM WATER FLOW RATES NORMALLY ACCEPTED AND RELEASED BY EXISTING DRAINAGE FACILITIES.
- ALL FRAMES, GRATES, LIDS, AND BOXES SCHEDULED TO BE REMOVED FROM EXISTING STRUCTURES SHALL REMAIN THE PROPERTY OF THE COUNTY OR STATE, AS APPLICABLE. ANY ITEMS DAMAGED DURING REMOVAL SHALL BE REPLACED BY THE CONTRACTOR.
- ALL FRAMES WITH CLOSED LIDS TO BE FURNISHED, AS PART OF THIS CONTRACT SHALL HAVE CAST INTO THE LID ONE OF THE FOLLOWING WORDS: FOR STORM SEWER STRUCTURES "STORM". FOR SANITARY SEWER STRUCTURES "SANITARY". FOR WATER SYSTEM STRUCTURES "WATER".
- 6. FRAME ELEVATIONS GIVEN ON THE PLANS ARE ONLY TO ASSIST THE CONTRACTOR IN DETERMINING THE APPROXIMATE OVERALL HEIGHT OF THE STRUCTURE. FRAMES ON ALL STRUCTURES WILL BE ADJUSTED TO THE FINAL ELEVATION AND CROSS SLOPE OF THE AREA IN WHICH THEY ARE LOCATED.
- 7. ALL STORM SEWERS SHALL BE RCCP, CLASS IV, UNLESS NOTED OTHERWISE ON THE PLAN.

BACKFILL

1. STORM SEWER, WATER MAIN, AND SANITARY SEWER SHALL BE BACKFILLED IN ACCORDANCE WITH ARTICLE 550.07 OF THE LATEST STANDARD SPECIFICATION FOR ROAD AND BRIDGE CONSTRUCTION, METHOD 1 ONLY, OR AS DIRECTED BY THE ENGINEER.

STAKING

- 1. THE CONTRACTOR SHALL PROTECT AND CAREFULLY PRESERVE ALL SECTION OR SUBSECTION MONUMENTS, PROPERTY CORNERS, AND REFERENCE MARKERS UNTIL THE OWNER, HIS/HER AGENT, OR AN AUTHORIZED SURVEYOR HAS WITNESSED OR OTHERWISE REFERENCED THEIR LOCATIONS.
- 2. ALL RADII FOR PROPOSED CURB AND GUTTER ARE TO THE EDGE OF PAVEMENT, UNLESS OTHERWISE NOTED. CURB AND GUTTER ELEVATIONS SHOWN AT POINTS OF CURVE, ETC., ARE EDGE OF PAVEMENT, UNLESS OTHERWISE NOTED.
- STRUCTURE OFFSET LOCATIONS GIVEN ON THE DETAILED PLANS ARE TO THE FOLLOWING POINTS: A) FOR STRUCTURES FALLING IN THE CURB LINE TO EDGE OF PAVEMENT; B) FOR ALL OTHER STRUCTURES TO THE CENTER OF THE STRUCTURE.
- 4. ALL ELEVATIONS ARE ON U.S.G.S NAVD 88 DATUM.
- 5. ALL OFFSET LOCATIONS GIVEN ON THE DETAILED PLANS FOR STRUCTURES, EDGE OF PAVEMENT, ETC. ARE FROM THE CENTERLINE OR BASELINE AS SHOWN ON THE PLANS.

SEDIMENTATION AND EROSION CONTROL NOTES

- EROSION CONTROL AND SEDIMENT CONTROL MEASURES SHALL BE IN ACCORDANCE WITH THE SWPPP FOR THE PROJECT AND THE FOLLOWING COMMENTS.
- 2. SOIL DISTURBANCE SHALL BE CONDUCTED IN SUCH A MANNER AS TO MINIMIZE EROSION. SOIL-STABILIZATION MEASURES SHALL CONSIDER THE TIME OF YEAR, SITE CONDITIONS, AND THE USE OF TEMPORARY OR PERMANENT MEASURES.
- 3. SOIL-EROSION AND SEDIMENT-CONTROL FEATURES SHALL BE CONSTRUCTED PRIOR TO THE COMMENCEMENT OF LAND OR EARTH DISTURBANCE OF UPLAND AREAS.
- 4. DISTURBED AREAS SHALL BE STABILIZED WITH TEMPORARY OR PERMANENT MEASURES AS SOON AS PRACTICAL IN PORTIONS OF THE SITE WHERE CONSTRUCTION ACTIVITIES HAVE TEMPORARILY OR PERMANENTLY CEASED, BUT IN NO CASE MORE THAN 7 DAYS AFTER THE CONSTRUCTION ACTIVITY.
- 5. ALL STORM SEWERS THAT ARE OR WILL BE FUNCTIONING DURING CONSTRUCTION SHALL BE PROTECTED BY AN APPROPRIATE SEDIMENT-CONTROL MEASURE AS FOUND IN THE SWPPP.
- 6. ALL TEMPORARY EROSION AND SEDIMENT-CONTROL MEASURES SHALL BE REMOVED WITHIN 30 DAYS AFTER FINAL SITE STABILIZATION IS ACHIEVED OR AFTER THE TEMPORARY MEASURES ARE NO LONGER NEEDED.
- 7. ALL TEMPORARY AND PERMANENT EROSION-CONTROL MEASURES MUST BE MAINTAINED AND REPAIRED BY THE CONTRACTOR AS NEEDED WITHIN 24 HOURS OF DISCOVERY. MAINTENANCE NOT PERFORMED IN A TIMELY FASHION MAY RESULT IN AN INCIDENCE OF NON-COMPLIANCE.
- A STABILIZED MAT OF AGGREGATE UNDERLAIN WITH FILTER CLOTH (OR OTHER APPROPRIATE MEASURE) SHALL BE LOCATED AT ANY POINT WHERE TRAFFIC WILL BE ENTERING OR LEAVING A CONSTRUCTION SITE TO OR FROM A PUBLIC RIGHT-OF-WAY, STREET, ALLEY, OR PARKING AREA. ANY SEDIMENT OR SOIL REACHING AN IMPROVED PUBLIC RIGHT-OF-WAY, STREET, ALLEY, OR PARKING AREA SHALL BE REMOVED BY SCRAPING OR STREET CLEANING AS ACCUMULATIONS WARRANT AND TRANSPORTED TO A CONTROLLED SEDIMENT-DISPOSAL AREA.
- 9. SOIL STOCKPILES SHALL NOT BE LOCATED IN A FLOOD-PRONE AREA OR A DESIGNATED BUFFER PROTECTING WATERS OF THE UNITED STATES.
- 10. IF DE-WATERING SERVICES ARE USED, ADJOINING PROPERTIES AND DISCHARGE LOCATIONS SHALL BE PROTECTED FROM EROSION. DISCHARGES SHALL BE ROUTED THROUGH AN EFFECTIVE SEDIMENT-CONTROL MEASURE (e.g., SEDIMENT TRAP, SEDIMENT BASIN, FILTER BAG OR OTHER APPROVED MEASURE).
- 11. THE EROSION-CONTROL MEASURES INDICATED ON THE PLANS ARE THE MINIMUM REQUIREMENTS. ADDITIONAL MEASURES MAY BE REQUIRED, AS DIRECTED BY THE ENGINEER OR GOVERNING AGENCY.

PAVING AND EXCAVATING

- CONTRACTOR MUST BE OFF THE JOB BY 7:00 P.M. ON P.C.C. POUR DAYS WITH NO EXCEPTIONS. CUTTING JOINTS WILL NOT BE PERMITTED OVERNIGHT.
- 2. SUBGRADE STABILITY SHALL BE VERIFIED BY PROOF-ROLLING WITH A FULLY LOADED TANDEM-AXLE TRUCK.
- AGGREGATE SUBGRADE IMPROVEMENT (CU YD) HAS BEEN PROVIDED FOR USE AT LOCATIONS INDICATING SOILS THAT TEND TO BE UNSTABLE AND/OR UNSUITABLE. THE ACTUAL NEED FOR REMOVAL AND REPLACEMENT WITH ASI SHALL BE DETERMINED IN THE FIELD AT THE TIME OF CONSTRUCTION BY THE GEOTECHNICAL ENGINEER. ALL POTENTIALLY UNSTABLE SOILS SHALL BE TESTED WITH A STATIC OR DYNAMIC CONE PENETROMETER AND TREATED IN ACCORDANCE WITH ARTICLE 301.04 OF THE STANDARD SPECIFICATIONS AND THE ILLINOIS SUBGRADE STABILITY MANUAL.

PAVING AND EXCAVATING (CONTINUED)

- 4. ANY AGGREGATE SUBGRADE IMPROVEMENT CONTAMINATED AND/OR DAMAGED BY THE CONTRACTOR'S VEHICLES AND/OR EQUIPMENT SHALL BE REMOVED AND REPLACED BY THE CONTRACTOR, AS DIRECTED BY THE ENGINEER.
- 5. PIPE UNDERDRAINS SHALL BE INSTALLED ACCORDING TO SECTION 601 OF THE STANDARD SPECIFICATIONS, STANDARD 601001, AND THE SPECIAL PROVISION FOR PIPE UNDERDRAINS, TYPE 2, 4".

- PRIOR TO THE START OF CONSTRUCTION, THE CONTRACTOR, ENGINEER AND KANE CO. DOT MAINTENANCE PERSONNEL SHALL INVENTORY THE LOCATION, SIZE, TYPE AND CONDITION OF ALL EXISTING SIGNS. ANY SIGN DAMAGED DURING CONSTRUCTION SHALL BE REPLACED AS DIRECTED BY THE ENGINEER.
- ALL SIGNS SHALL BE ERECTED IN STRICT CONFORMANCE WITH SECTION 720 OF THE STANDARD SPECIFICATIONS FOR ROAD AND BRIDGE CONSTRUCTION AND BY STATE PRE-QUALIFIED CONTRACTOR PERSONNEL, SUCH AS A SUB CONTRACTOR THAT SPECIALIZES IN TRAFFIC CONTROL AND SIGN PLACEMENT. TO ENSURE THIS OPERATION IS PERFORMED CORRECTLY THERE WILL BE A WALKTHRU ON THE JOB WITH THE ENGINEER AND IDOT MAINTENANCE PERSONNEL AS PART OF THE OVERALL PUNCH LIST.
- 3. ALL WORK INVOLVING SIGNS SHALL BE GOVERNED BY THE FOLLOWING REQUIREMENTS:
 - A. SIGNS SHALL NOT BE MOVED UNTIL PROGRESS OF WORK NECESSITATES IT.
 - B. THE CONTRACTOR WILL BE REQUIRED TO TEMPORARILY RESET ALL SUCH SIGNS THAT INTERFERE WITH HIS WORK DURING CONSTRUCTION OPERATIONS. ALL SUCH SIGNS MUST BE MAINTAINED STRAIGHT AND CLEAN FOR THE DURATION OF THE TEMPORARY SETTING AND MUST BE RE-ERECTED AT A TEMPORARY LOCATION IN A WORKMANLIKE MANNER AND BE VISIBLE TO TRAFFIC FOR WHICH IT IS INTENDED.
 - C. ALL REMOVED SIGNS WILL BE RETURNED TO THE COUNTY, MUNICIPALTIY, OR STATE, AS
 - LONGER POSTS MAY BE REQUIRED AT SOME TEMPORARY OR PERMANENT SIGN LOCATIONS TO MAINTAIN PROPER SIGN ELEVATIONS.
 - THE ENGINEER SHALL NOTIFY THE IDOT TRAFFIC CONTROL SUPERVISOR AT KALPANA.KANNAN-HOSADURGA@ILLINOIS.GOV A MINIMUM OF 72 HOURS PRIOR TO BEGINNING WORK.

- 1. THE CONTRACTOR SHALL NOT BE ALLOWED TO SET UP A YARD OR FIELD OFFICE ON COUNTY PROPERTY WITHOUT WRITTEN PERMISSION FROM THE COUNTY.
- 2. WHEN ARTIFICIAL LIGHTING IS USED IN NIGHT OPERATIONS THE CONTRACTOR SHALL EXERCISE THE UTMOST PRECAUTIONS IN PREVENTING ADVERSE VISIBILITY TO THE MOTORING PUBLIC
- 3. THE CONTRACTOR SHALL MAINTAIN EXISTING SIDE STREET ACCESS, EXISTING DRIVEWAY ACCESS, AND PEDESTRIAN ACCESS TO ABUTTING PROPERTY AT ALL TIMES DURING CONSTRUCTION OF THE PROJECT UNLESS A DETOUR PLAN IS PROVIDED IN THE PLANS.
- 4. IT IS THE CONTRACTOR'S RESPONSIBILITY TO ASCERTAIN EXISTING FIELD CONDITIONS BEFORE BIDDING ON THIS CONTRACT.
- 5. WHERE NEW WORK MEETS EXISTING FEATURES TO REMAIN, FIELD CHECK ALL DIMENSIONS AND ELEVATIONS BEFORE PROCEEDING WITH CONSTRUCTION. NOTIFY ENGINEER IMMEDIATELY OF ANY DISCREPANCIES.
- 6. THE CONTRACTOR SHALL COMPLY WITH ALL STATE REGULATIONS REGARDING AIR, WATER, AND NOISE POLLUTION. THE CONTRACTOR IS PROHIBITED FROM BURNING ANY MATERIAL WITHIN OR ADJACENT TO THE IMPROVEMENT.
- 7. ALL DISTURBED AREAS WITHIN THE PROJECT THAT ARE NOT OTHERWISE SURFACED SHALL BE SEEDED. SEED LIMITS SHOWN ON THE PLANS ARE THE MAXIMUM PAY WIDTHS FOR PAYMENT
- THE CONTRACTOR SHALL PREPARE THE SUBGRADE IN ACCORDANCE WITH ARTICLE 301.03 OF THE STANDARD SPECIFICATIONS PRIOR TO THE REMOVAL OF ANY UNSTABLE MATERIALS.
- 9. FERTILIZER NUTRIENTS: USE A FERTILIZER WITH AN ANALYSIS OF 1:1:1 RATIO AT THE FOLLOWING RATE PER ACRE:

NITROGEN FERTILIZER NUTRIENT 90 LBS. POTASSIUM FERTILIZER NUTRIENT 90 LBS.

FERTILIZER WILL NOT BE REQUIRED FOR AREAS WITH SEEDING, CLASS 3 (SPECIAL) AND SEEDING, CLASS 4 (SPECIAL), CLASS 4B (SPECIAL).



USER NAME = Jeff Sedig	DESIGNED	-	JMS/PFR	REVISED -
	DRAWN	-	PFR	REVISED -
PLOT SCALE = 2.0000 '/ in.	CHECKED	-	KDF	REVISED -
PLOT DATE = 3/2/2020	DATE	-	01/13/2020	REVISED -

STATE OF ILLINOIS **DEPARTMENT OF TRANSPORTATION**

07117011 110770	F.A.U. RTE.	SECTION	COUNTY	TOTAL SHEETS	SHEET NO.
GENERAL NOTES	2298	18-00215-21-BR	KANE	415	4
			CONTRACT	NO.	61G02
SCALE: NTS SHEET 1 OF 1 SHEETS STA. TO STA.		ILLINOIS FED. A	ID PROJECT		

		•					CONSTRU	JCTION CO	DDES	
					PAR	TICIPATI	NG URBAN	& RURAL	FUNDING	NON - PART
	SUMMARY OF QUANTITIES					STU (75%/25%), STR (80%/20%)				
SPECIALTY ITEM	CODE NO.	ITEM	UNIT	TOTAL QUANTITY	NEW ROAD 0001	ROAD RECON 0004	NEW BRIDGE 0008	SAFETY 0021	**SAFETY 0021	PUBLIC AGENCY
	20101000	TEMPORARY FENCE	FOOT	2,860 `	2,860					
*	20101200	TREE ROOT PRUNING	EACH	25	25					
	20101200	TREE ROOT FRUNING	EACH	25	25					
	20101300	TREE PRUNING (1 TO 10 INCH DIAMETER)	EACH	147	147					
*	20101350	TREE PRUNING (OVER 10 INCH DIAMETER)	EACH	167	167					
	20200100	EARTH EXCAVATION	CU YD	192,013	188,049	3,964				
	20201200	REMOVAL AND DISPOSAL OF UNSUITABLE MATERIAL	CU YD	275,817	244,707	31,110				
	20700220	POROUS GRANULAR EMBANKMENT	CU YD	2			2			
	20100220	TOROGS GRANGEAR EMBANKMENT	COTO	2						
	20800150	TRENCH BACKFILL	CU YD	3,396	2,787	500				109
	21001000	GEOTECHNICAL FABRIC FOR GROUND STABILIZATION	SQ YD	7,091	5,079	2,000				12
	21101625	TOPSOIL FURNISH AND PLACE, 6"	SQ YD	106,626	101,012	5,614				
	21101645	TOPSOIL FURNISH AND PLACE, 12"	SQ YD	17,123	17,123					
	21101685	TOPSOIL FURNISH AND PLACE, 24"	SQ YD	5,558	5,558					
	21301072	EXPLORATION TRENCH 72" DEPTH	FOOT	100		75				25
	21400100	GRADING AND SHAPING DITCHES	FOOT	200		200				
*	25000210	SEEDING, CLASS 2A	ACRE	5.5	4.7	0.8				
	25000400	NATROCEN FERTH IZER MUTRICHT	Bolan	405	427	70				
*	25000400	NITROGEN FERTILIZER NUTRIENT	POUND	495	423	72				
*	25000600	POTASSIUM FERTILIZER NUTRIENT	POUND	495	423	72				
*	25100127	MULCH, METHOD 3A	ACRE	5	3	2				
*	25100630	EROSION CONTROL BLANKET	SQ YD	9,463	7,670	1,793				•



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PLOT DATE = 3/26/2020	DATE - 01/13/2020	REVISED -

STATE OF ILLINOIS DEPARTMENT OF TRANSPORTATION

		_					RTE.	SEC
į		S	UMMARY	OF QU	ANTITIES		2298	18-002
	SCALE: NTS	SHEET 1	OF 20	SHEETS	STA.	TO STA.		

							CONSTR	JCTION C	ODES	
					PAR	TICIPATI	NG URBAN	& RURAL	FUNDING	NON - PART
		SUMMARY OF QUANTITIES				STU (75	%/25%),	STR (80%	/20%)	100% LOCAL
SPECIALTY ITEM	CODE NO.	ITEM	UNIT	TOTAL QUANTITY	NEW ROAD 0001	ROAD RECON 0004	NEW BRIDGE 0008	SAFETY 0021	**SAFETY 0021	PUBLIC AGENC
*	25200200	SUPPLEMENTAL WATERING	UNIT	2,147	2,103	44				
	28000250	TEMPORARY EROSION CONTROL SEEDING	POUND	1.011	683	328			:	
	28000315	AGGREGATE DITCH CHECKS	TON	101	101					
	28000500	INLET AND PIPE PROTECTION	EACH	21	10	11				
	28000510	INLET FILTERS	EACH	90	79	11				
	28001000	AGGREGATE (EROSION CONTROL)	TON	48	48					
	28100105	STONE RIPRAP, CLASS A3	SQ YD	53	53					
	28100107	STONE RIPRAP, CLASS A4	SQ YD	525	447	78				
	28200200	FILTER FABRIC	SQ YD	585	507	78				
	30300001	AGGREGATE SUBGRADE IMPROVEMENT	CU YD	3,177		3,177				
	30300112	AGGREGATE SUBGRADE IMPROVEMENT 12"	SQ YD	50,794	36,748	14,046				
	31101100	SUBBASE GRANULAR MATERIAL, TYPE B	CU YD	121	46	75				
	31101200	SUBBASE GRANULAR MATERIAL, TYPE B 4"	SQ YD	617	250	177	190			
	35101800	AGGREGATE BASE COURSE, TYPE B 6"	SQ YD	8,614	8,349	265				
	40600275	BITUMINOUS MATERIALS (PRIME COAT)	POUND	19,626	18,784	597	245			
	40603085	HOT-MIX ASPHALT BINDER COURSE, IL-19.0, N70	TON	5,813	5,813					
	40604060	HOT-MIX ASPHALT SURFACE COURSE, IL-9.5, MIX "D", N50	TON	1,316	1,275	41				
	40604062	HOT-MIX ASPHALT SURFACE COURSE, IL-9.5, MIX "D", N70	TON	1,346	709	637				

40700100



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PLOT DATE = 3/26/2020	DATE -	01	/13/2020	REVISED	-

BITUMINOUS MATERIALS (TACK COAT)

STATE	E OF	ILLINOIS
DEPARTMENT	0F	TRANSPORTATION

POUND

5,409

							F.A.U. RTE.	SECTION	COUNTY	SHEETS	NO.
		SUMM	ARY	OF QU	ANTITIES		2298	18-00215-21-BR	KANE	415	6
									CONTRACT	NO. 6	61G02
SCALE: NTS	SHEET 2	OF	20	SHEETS	STA.	TO STA.		ILLINOIS FED. AI	D PROJECT		

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							001151111	30,10,100	,,,,,,,,,,,,,,,,,,,,,,,,,,,,,,,,,,,,,,,	
					PAF	RTICIPATI	ING URBAN	& RURAL	FUNDING	NON-PART
		SUMMARY OF QUANTITIES				STU (75	%/25%),	STR (80%,	/20%)	100% LOCAL
SPECIALTY ITEM	CODE NO.	ITEM	UNIT	TOTAL	NEW ROAD 0001	ROAD RECON 0004	NEW BRIDGE 0008	SAFETY 0021	**SAFETY 0021	PUBLIC AGENCY
	42000060	WELDED WIRE REINFORCEMENT	SQ YD	334	334					
	42000080	PAVEMENT CONNECTOR (PCC) FOR BRIDGE APPROACH SLAB	SQ YD	56			56			
	42000501	PORTLAND CEMENT CONCRETE PAVEMENT 10" (JOINTED)	SQ YD	29,713	29,327	386				
	42001300	PROTECTIVE COAT	SQ YD	39,759	36,068	3,691				
	42300400	PORTLAND CEMENT CONCRETE DRIVEWAY PAVEMENT, 8 INCH	SQ YD	201		201				
	42400200	PORTLAND CEMENT CONCRETE SIDEWALK 5 INCH	SQ FT	4,161	3,414	747				
	44000100	PAVEMENT REMOVAL	SQ YD	9,565		9,565				
	44000157	HOT-MIX ASPHALT SURFACE REMOVAL, 2"	SQ YD	1,632		1,632				
	44000200	DRIVEWAY PAVEMENT REMOVAL	SQ YD	288		288				
	44000500	COMBINATION CURB AND GUTTER REMOVAL	FOOT	687		687				
	44000600	SIDEWALK REMOVAL	SQ FT	350		350			***************************************	
	44201765	CLASS D PATCHES, TYPE II, 10 INCH	SQ YD	35						35
	48101500	AGGREGATE SHOULDERS, TYPE B 6"	SQ YD	381		381				
	48203021	HOT-MIX ASPHALT SHOULDERS, 6"	SQ YD	190			190			
	50105220	PIPE CULVERT REMOVAL	FOOT	589		589				
	50200100	STRUCTURE EXCAVATION	CU YD	1,760			1,760			
	50200450	REMOVAL AND DISPOSAL OF UNSUITABLE MATERIAL FOR STRUCTURES	CU YD	640			640			
	50300225	CONCRETE STRUCTURES	CU YD	116			116			
	50300255	CONCRETE SUPERSTRUCTURE	CU YD	562			562			***************************************



USER NAME = Jeff Sedig	DESIGNED	-	JMS/PFR	REVISED -	
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PLOT DATE = 3/26/2020	DATE	-	01/13/2020	REVISED	

STATE	OF	ILLINOIS
DEPARTMENT	0F	TRANSPORTATION

							F.A.U. RTE.	SECTION	COUNTY	SHEETS	
	SU	IMM	ARY	OF QUA	ANTITIES		2298	18-00215-21-BR	KANE	415	7
									CONTRACT	NO.	61G02
SCALE: NTS	SHEET 3	OF	20	SHEETS	STA.	TO STA.		ILLINOIS FED. AI	D PROJECT		

CONSTRUCTION CODES

							CONSTR	UCTION CO	DDES	
					PAR	TICIPATI	NG URBAN	1 & RURAL	FUNDING	NON - PART
		SUMMARY OF QUANTITIES				STU (75	%/25%),	STR (80%	/20%)	100% LOCAL
SPECIALTY ITEM	CODE NO.	ITEM	UNIT	TOTAL QUANTITY	NEW ROAD 0001	ROAD RECON 0004	NEW BRIDGE 0008	SAFETY 0021	**SAFETY 0021	PUBLIC AGENCY
	50300300	PROTECTIVE COAT	SQ YD	1,291			1,291			
	50301350	CONCRETE SUPERSTRUCTURE (APPROACH SLAB)	CU YD	95			95			
	50500105	FURNISHING AND ERECTING STRUCTURAL STEEL	L SUM	1			1			
	50500505	STUD SHEAR CONNECTORS	EACH	3,399			3,399			
	50800205	REINFORCEMENT BARS, EPOXY COATED	POUND	147,100			147,100			
	50800515	BAR SPLICERS	EACH	69			69			
*	50900805	PEDESTRIAN RAILING	FOOT	292			292			
*	50901750	PARAPET RAILING	FOOT	290			290			
	52000110	PREFORMED JOINT STRIP SEAL	FOOT	138			138			
	52100010	ELASTOMERIC BEARING ASSEMBLY, TYPE I	EACH	11			11			
	52100510	ANCHOR BOLTS, 3/4"	EACH	44			44			
	52200020	TEMPORARY SOIL RETENTION SYSTEM	SQ FT	1,741		949	792			
	52200800	SEGMENTAL CONCRETE BLOCK WALL	SQ FT	410		410			,	
	54213657	PRECAST REINFORCED CONCRETE FLARED END SECTIONS 12"	EACH	2	2					
	54213660	PRECAST REINFORCED CONCRETE FLARED END SECTIONS 15"	EACH	2	2					
	54213669	PRECAST REINFORCED CONCRETE FLARED END SECTIONS 24"	EACH	4	1	3				
	54213681	PRECAST REINFORCED CONCRETE FLARED END SECTIONS 36"	EACH	2	1	1	,			
	54214731	PRECAST REINFORCED CONCRETE FLARED END SECTIONS - ELLIPTICAL, EQUIVALENT ROUND-SIZE 36"	EACH	4	4					

54244405



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FLUSH INLET BOX FOR MEDIAN, STANDARD 542546

STATI	E OI	: ILLINOIS
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EACH

						F.A.U. RTE.	SECTION	COUNTY	SHEETS	SHEET NO.
	SUN	MAR	OF QU	ANTITIES		2298	18-00215-21-BR	KANE	415	8
, , , , , , , , , , , , , , , , , , , ,								CONTRACT	NO.	61GO2
SCALE: NTS S	SHEET 4	OF 20	SHEETS	STA.	TO STA.		ILLINOIS FED. AI	D PROJECT		

							CONSTR	UCTION CO	DDES	
					PAF	RTICIPATI	NG URBAN	& RURAL	FUNDING	NON - PART
		SUMMARY OF QUANTITIES				STU (75%/25%), STR (80%/20%)				100% LOCAL
SPECIALTY ITEM	CODE NO.	ITEM	UNIT	TOTAL QUANTITY	NEW ROAD 0001	ROAD RECON 0004	NEW BRIDGE 0008	SAFETY 0021	**SAFETY 0021	PUBLIC AGENCY
	55101200	STORM SEWER REMOVAL 24"	FOOT	95		95				
	55201300	STORM SEWERS JACKED IN PLACE, 36"	FOOT	147		147				
*	56103300	DUCTILE IRON WATER MAIN 12"	FOOT	1,791						1,791
*	56105200	WATER VALVES 12"	EACH	4						4
ж	56400300	FIRE HYDRANTS TO BE ADJUSTED	EACH	1						1
	58700300	CONCRETE SEALER	SQ FT	1,686			1,686			
	59300100	CONTROLLED LOW-STRENGTH MATERIAL	CU YD	30		30				
	60108204	PIPE UNDERDRAINS, TYPE 2, 4"	FOOT	12.141	10,634	1,507				
	60200105	CATCH BASINS, TYPE A, 4'-DIAMETER, TYPE 1 FRAME, OPEN LID	EACH	2	2					
	60200205	CATCH BASINS, TYPE A, 4'-DIAMETER, TYPE 1 FRAME, CLOSED LID	EACH	1	1					
	60200805	CATCH BASINS, TYPE A, 4'-DIAMETER, TYPE 8 GRATE	EACH	16	9	7				
	60201105	CATCH BASINS, TYPE A, 4'-DIAMETER, TYPE 11 FRAME AND GRATE	EACH	9	9					
	60201340	CATCH BASINS, TYPE A, 4'-DIAMETER, TYPE 24 FRAME AND GRATE	EACH	39	33	6				
	60203905	CATCH BASINS, TYPE A, 5'-DIAMETER, TYPE 1 FRAME, CLOSED LID	EACH	1	1					
	60204505	CATCH BASINS, TYPE A, 5'-DIAMETER, TYPE 8 GRATE	EACH	14	11	3				
	60205040	CATCH BASINS, TYPE A, 5'-DIAMETER, TYPE 24 FRAME AND GRATE	EACH	2	1	1				
	60218400	MANHOLES, TYPE A, 4'-DIAMETER, TYPE 1 FRAME, CLOSED LID	EACH	13	13					
	60219000	MANHOLES, TYPE A, 4'-DIAMETER, TYPE 8 GRATE	EACH	3	1	2				
				1	1					



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PLOT DATE = 3/26/2020	DATE	-	01/13/2020	REVISED -

60219300 MANHOLES, TYPE A, 4'-DIAMETER, TYPE 11 FRAME AND GRATE

STATI	E OF	ILLINOIS
DEPARTMENT	0F	TRANSPORTATION

EACH

SUMMARY OF QUANTITIES								SECTION	COUNTY	TOTAL	SHEET NO.
								2298 18-00215-21-BR KANE			9
									CONTRACT	NO.	61G02
SCALE: NTS	SHEET 5	OF	20	SHEETS	STA.	TO STA.	ILLINOIS FED. AID PROJECT				

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							CONSTRU	JCTION CO	DDES	
					PAR	TICIPATI	NG URBAN	& RURAL	FUNDING	NON-PART
		SUMMARY OF QUANTITIES				STU (759	%/25%), S	STR (80%	/20%)	100% LOCAL
SPECIALTY ITEM	CODE NO.	ITEM	UNIT	TOTAL QUANTITY	NEW ROAD 0001	ROAD RECON 0004	NEW BRIDGE 0008	SAFETY 0021	**SAFETY 0021	TRUDE TO ACENION
	60221100	MANHOLES, TYPE A, 5'-DIAMETER, TYPE 1 FRAME, CLOSED LID	EACH	7	2	5				
	60223800	MANHOLES, TYPE A, 6'-DIAMETER, TYPE 1 FRAME, CLOSED LID	EACH	1		1				
	60224005	MANHOLES, TYPE A, 6'-DIAMETER, TYPE 8 GRATE	EACH	2	1	1				
	60224039	MANHOLES, TYPE A, 6'-DIAMETER, TYPE 24 FRAME AND GRATE	EACH	1		1				
	60236800	INLETS, TYPE A, TYPE 11 FRAME AND GRATE	EACH	2	2					
	60237470	INLETS, TYPE A, TYPE 24 FRAME AND GRATE	EACH	34	30	4				
*	60248900	VALVE VAULTS, TYPE A, 5'-DIAMETER, TYPE 1 FRAME, CLOSED LID	EACH	4						4
	60251500	CATCH BASINS TO BE ADJUSTED WITH NEW TYPE 11 FRAME AND GRATE	EACH	1		1				
	60251740	CATCH BASINS TO BE ADJUSTED WITH NEW TYPE 24 FRAME AND GRATE	EACH	2		2				
	60255500	MANHOLES TO BE ADJUSTED	EACH	15		15				
:	60255800	MANHOLES TO BE ADJUSTED WITH NEW TYPE 1 FRAME, CLOSED LID	EACH	1		1				
	60261325	INLETS TO BE ADJUSTED WITH NEW TYPE 11 GRATE	EACH	1		1				
*	60265700	VALVE VAULTS TO BE ADJUSTED	EACH	2						2
	60500050	REMOVING CATCH BASINS	EACH	4		4				
	60600095	CLASS SI CONCRETE (OUTLET)	CU YD	4		4				
***************************************	60600605	CONCRETE CURB, TYPE B	FOOT	347	347					
	60603500	COMBINATION CONCRETE CURB AND GUTTER, TYPE B-6.06	FOOT	70		70				
	60603800	COMBINATION CONCRETE CURB AND GUTTER, TYPE B-6.12	FOOT	7,590	7,019	571				



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		DRAWN	-	PFR	REVISED	-
i	PLOT SCALE = 2.0000 ' / in.	CHECKED	-	KDF	REVISED	-
	PLOT DATE = 3/26/2020	DATE	-	01/13/2020	REVISED	-

60605000 COMBINATION CONCRETE CURB AND GUTTER, TYPE B-6.24

STAT	E OI	FILLINOIS
DEPARTMENT	0F	TRANSPORTATION

15,854

	F.A.U. RTE.	SECTION	COUNTY	SHEETS	NO.			
SUMMARY	OF QUANTI	ES	2298	18-00215-21-BR	KANE	415	10	
					CONTRACT	NO.	61G02	i
SCALE: NTS SHEET 6 OF 20	SHEETS STA.	TO STA.	ILLINOIS FED. AID PROJECT					

					PAR	TICIPATI	NG URBAN	& RURAL	FUNDING	NON - PART
		SUMMARY OF QUANTITIES				STU (75	75%/25%), STR (80%/20%)			100% LOCAL
SPECIALTY ITEM	CODE NO.	ITEM	UNIT	TOTAL QUANTITY	NEW ROAD 0001	ROAD RECON 0004	NEW BRIDGE 0008	SAFETY 0021	**SAFETY 0021	JUNE TO VOENCY
	60608562	COMBINATION CONCRETE CURB AND GUTTER, TYPE M-4.12	FOOT	768	768					
	60608582	COMBINATION CONCRETE CURB AND GUTTER, TYPE M-4.24	FOOT	638	638					
	60618300	CONCRETE MEDIAN SURFACE, 4 INCH	SQ FT	1,907		1,907				
	60618760	CONCRETE MEDIAN, TYPE M-4.12	SQ FT	1,772	1,772					
	60619600	CONCRETE MEDIAN, TYPE SB-6.12	SQ FT	14,023		14,023				
. *	63000001	STEEL PLATE BEAM GUARDRAIL, TYPE A, 6 FOOT POSTS	FOOT	238			238			
*	63000007	STEEL PLATE BEAM GUARDRAIL, TYPE B, 6 FOOT POSTS	FOOT	282				282		
*	63100045	TRAFFIC BARRIER TERMINAL, TYPE 2	EACH	2			1	1		
*	63100085	TRAFFIC BARRIER TERMINAL, TYPE 6	EACH	2			2			
*	63100167	TRAFFIC BARRIER TERMINAL, TYPE 1 (SPECIAL) TANGENT	EACH	1				1		
*	63100169	TRAFFIC BARRIER TERMINAL, TYPE 1 (SPECIAL) FLARED	EACH	1			1			
	63200310	GUARDRAIL REMOVAL	FOOT	511		511				
*	66900200	NON-SPECIAL WASTE DISPOSAL	CU YD	6,191	6,191					
*	66900210	HAZARDOUS WASTE DISPOSAL	CU YD	38,695	38,695					
	66900530	SOIL DISPOSAL ANALYSIS	EACH	40	40					
*	66901001	REGULATED SUBSTANCES PRE-CONSTRUCTION PLAN	LSUM	1	1					
#	66901003	REGULATED SUBSTANCES FINAL CONSTRUCTION REPORT	LSUM	1	1					
	66901006	REGULATED SUBSTANCES MONITORING	CAL DA	130	130					
	67000400	ENGINEER'S FIELD OFFICE, TYPE A	CAL MO	15	15					



USER NAME = Jeff Sedig	DESIGNED	-	JMS/PFR	REVISED		
	DRAWN	-	PFR	REVISED	-	
PLOT SCALE = 2.0000 '/ in.	CHECKED	-	KDF	REVISED	-	
PLOT DATE = 3/26/2020	DATE	-	01/13/2020	REVISED	-	

STATE OF ILLINOIS DEPARTMENT OF TRANSPORTATION

							F.A.U. RTE.	SECTION	COUNTY	SHEETS	
	St	MIN	ARY	OF QU	ANTITIES		2298	18-00215-21-BR	KANE	415	11
									CONTRACT	NO.	61G02
SCALE: NTS	SHEET 7	OF	20	SHEETS	STA.	TO STA.		ILLINOIS FED. AI	D PROJECT		

							771 (710)		JULJ	
					PAR	TICIPATI	NG URBAN	I & RURAL	FUNDING	NON - PART
		SUMMARY OF QUANTITIES				STU (75	%/25%),	STR (80%	/20%)	100% LOCAL
SPECIALTY ITEM	CODE NO.	ITEM	UNIT	TOTAL QUANTITY	NEW ROAD 0001	ROAD RECON 0004	NEW BRIDGE 0008	SAFETY 0021	**SAFETY 0021	1
	67100100	MOBILIZATION	L SUM	1	1					
	70103815	TRAFFIC CONTROL SURVEILLANCE	CAL DA	40				40		
	70107025	CHANGEABLE MESSAGE SIGN	CAL DA	1,020				1,020		
	70300100	SHORT TERM PAVEMENT MARKING	FOOT	75				75		
	70300150	SHORT TERM PAVEMENT MARKING REMOVAL	SO FT	75				75		
	70300900	PAVEMENT MARKING TAPE, TYPE IV - LETTERS AND SYMBOLS	SO FT	218				218		
	70300904	PAVEMENT MARKING TAPE, TYPE IV 4"	FOOT	13,109				13,109		
	70300906	PAVEMENT MARKING TAPE, TYPE IV 6"	FOOT	2,994		:		2,994		
	70300912	PAVEMENT MARKING TAPE, TYPE IV 12"	FOOT	112				112		
	70300924	PAVEMENT MARKING TAPE, TYPE IV 24"	FOOT	294				294		
*	72000100	SIGN PANEL - TYPE 1	SO FT	780				750	30	
*	72000200	SIGN PANEL - TYPE 2	SO FT	184				146	38	**************************************
*	72000300	SIGN PANEL - TYPE 3	SO FT	202				202		
	72400100	REMOVE SIGN PANEL ASSEMBLY - TYPE A	EACH	28				28		
,	72400200	REMOVE SIGN PANEL ASSEMBLY - TYPE B	EACH	6				6		
*	72400500	RELOCATE SIGN PANEL ASSEMBLY - TYPE A	EACH	12				12		
*	72501000	TERMINAL MARKER - DIRECT APPLIED	EACH	4				4		
*	72800100	TELESCOPING STEEL SIGN SUPPORT	FOOT	2,031				2,031		
	i			1	I .	I	ı	I	1	I



 USER NAME = Jeff Sedig	DESIGNED	-	JMS/PFR	REVISED -	
	DRAWN	-	PFR	REVISED -	
PLOT SCALE = 2.0000 '/ :n.	CHECKED	-	KDF	REVISED -	
PLOT DATE = 3/26/2020	DATE	_	01/13/2020	REVISED -	

WOOD SIGN SUPPORT

STATE OF ILLINOIS
DEPARTMENT OF TRANSPORTATION

FOOT

			F.A.U. RTE.	SECTION	COUNTY	TOTAL	SHEET NO.
SUMMAR	OF QUANTITIES		2298	18-00215-21-BR	KANE	415	12
					CONTRACT	NO.	61G02
SCALE: NTS SHEET 8 OF 20	SHEETS STA.	TO STA.		ILLINOIS FED. AI	D PROJECT		

CONSTRUCTION CODES

					CONSTRUCTION CODES									
					PAR	TICIPATI	NG URBAN	& RURAL	FUNDING	NON - PART				
		SUMMARY OF QUANTITIES				STU (75	%/25%),	STR (80%	/20%)	100% LOCAL				
SPECIALTY ITEM	CODE NO.	ITEM	UNIT	TOTAL QUANTITY	NEW ROAD 0001	ROAD RECON 0004	NEW BRIDGE 0008	SAFETY 0021	**SAFETY 0021	PUBLIC AGENCY				
	78009000	MODIFIED URETHANE PAVEMENT MARKING - LETTERS AND SYMBOLS	SQ FT	1,154				1,154						
	78009004	MODIFIED URETHANE PAVEMENT MARKING - LINE 4"	FOOT	19,563				19,563						
	78009006	MODIFIED URETHANE PAVEMENT MARKING - LINE 6"	FOOT	4,260				4,260						
•	78009008	MODIFIED URETHANE PAVEMENT MARKING - LINE 8"	FOOT	971				971						
*	78009012	MODIFIED URETHANE PAVEMENT MARKING - LINE 12"	FOOT	1,537				1,537						
*	78009024	MODIFIED URETHANE PAVEMENT MARKING - LINE 24"	FOOT	569				569						
	78100100	RAISED REFLECTIVE PAVEMENT MARKER	EACH	14				14						
*	78200005	GUARDRAIL REFLECTORS, TYPE A	EACH	14	:			14						
*	80400100	ELECTRIC SERVICE INSTALLATION	EACH	2				2						
*	80400200	ELECTRIC UTILITY SERVICE CONNECTION	L SUM	1				0.5	0.5					
*	81028200	UNDERGROUND CONDUIT, GALVANIZED STEEL, 2" DIA.	FOOT	1,566				1,240	326					
*	81028210	UNDERGROUND CONDUIT, GALVANIZED STEEL, 2 1/2" DIA.	FOOT	95				95						
*	81028220	UNDERGROUND CONDUIT, GALVANIZED STEEL, 3" DIA.	FOOT	396				379	17					
*	81028240	UNDERGROUND CONDUIT, GALVANIZED STEEL, 4" DIA.	FOOT	1,137				1,137						
*	81028340	UNDERGROUND CONDUIT, PVC, 1 1/2" DIA.	FOOT	125				125						
*	81028380	UNDERGROUND CONDUIT, PVC, 3 1/2" DIA.	FOOT	290				290						
	81028740	UNDERGROUND CONDUIT, COILABLE NONMETALLIC CONDUIT, 1 1/2" DIA.	FOOT	760				760						
	81028750	UNDERGROUND CONDUIT, COILABLE NONMETALLIC CONDUIT, 2" DIA.	FOOT	210				210						
-	01020130	GNDERGROUND CONDUIT, COTEABLE MONIMETALLIC CONDUIT, Z DIA.	F 00 1	210				210						

81028770



USER NAME = Jeff Sedig	DESIGNED - JMS/PFR	REVISED -
	DRAWN - PFR	REVISED -
PLOT SCALE = 2.0000 '/ in.	CHECKED - KDF	REVISED -
PLOT DATE = 3/26/2020	DATE - 01/13/2020	REVISED -

UNDERGROUND CONDUIT, COILABLE NONMETALLIC CONDUIT, 3" DIA.

STATI	E OF	FILLINOIS
DEPARTMENT	0F	TRANSPORTATION

FOOT

210

							F.A.U. RTÉ.	SECTION	COUNTY	TOTAL	SHEET NO.	ı
	SUN	/IM/	ARY	OF QUA	ANTITIES		2298	18-00215-21-BR	KANE	415	13	ı
							•		CONTRACT	NO.	31G02	i
SCALE: NTS	SHEET 9	OF	20	SHEETS	STA.	TO STA.		ILLINOIS FED. AI	D PROJECT			ı

CONSTRUCTION CODES

							CONSTRU	JCTION CO	DDES	
					PAR	TICIPATI	NG URBAN	& RURAL	FUNDING	NON-PART
		SUMMARY OF QUANTITIES				STU (759	%/25%), S	STR (80%	/ 20%)	100% LOCAL
SPECIALTY ITEM	CODE NO.	ITEM	UNIT	TOTAL QUANTITY	NEW ROAD 0001	ROAD RECON 0004	NEW BRIDGE 0008	SAFETY 0021	**SAFETY 0021	PUBLIC AGENCY
×	81028790	UNDERGROUND CONDUIT, COILABLE NONMETALLIC CONDUIT, 4" DIA.	FOOT	4,329				4,329		
*	81200230	CONDUIT EMBEDDED IN STRUCTURE, 2" DIA., PVC	FOOT	610				610		
	81300550	JUNCTION BOX, STAINLESS STEEL, ATTACHED TO STRUCTURE, 12" X 12" X 6"	EACH	2				2		
	81400100	HANDHOLE	EACH	13				12	1	
•	81400200	HEAVY-DUTY HANDHOLE	EACH	4				3	1	
****	81400300	DOUBLE HANDHOLE .	. EACH	4				4		
*	81603010	UNIT DUCT, 600V, 2-1C NO.10, 1/C NO.10 GROUND, (XLP-TYPE USE), 3/4" DIA. POLYETHYLENE	FOOT	720				720		
*	81603096	UNIT DUCT, 600V, 4-1C NO.8, 1/C NO.8 GROUND, (XLP-TYPE USE), 1 1/4" DIA. POLYETHYLENE	FOOT	965				965		
	81702100	ELECTRIC CABLE IN CONDUIT, 600V (XLP-TYPE USE) 1/C NO. 12	FOOT	625				625		
#	81702101	ELECTRIC CABLE IN CONDUIT, 600V (XLP-TYPE USE) 1/C NO. 14	FOOT	40				40		
*	81702110	ELECTRIC CABLE IN CONDUIT, 600V (XLP-TYPE USE) 1/C NO. 10	FOOT	1,250				1,250		
	81702130	ELECTRIC CABLE IN CONDUIT, 600V (XLP-TYPE USE) 1/C NO. 6	FOOT	18,520				18 , 520		
*	82500350	LIGHTING CONTROLLER, BASE MOUNTED, 240VOLT, 100AMP	EACH	1			,	1		
	83600200	LIGHT POLE FOUNDATION, 24" DIAMETER	FOOT	81				81		
*	83800505	BREAKAWAY DEVICE, COUPLING WITH ALUMINUM SKIRT	EACH	36				36		
*	85000205	MAINTENANCE OF EXISTING TRAFFIC SIGNAL INSTALLATION (SPECIAL)	EACH	2				1	1	
*	85700200	FULL-ACTUATED CONTROLLER AND TYPE IV CABINET	EACH	1				1		
*	87300925	ELECTRIC CABLE IN CONDUIT, TRACER, NO. 14 1C	FOOT	5,288				5,288		
*	87301215	ELECTRIC CABLE IN CONDUIT, SIGNAL NO. 14 2C	FOOT	2,046				886	1,160	



USER NAME = Jeff Sedig	DESIGNED - JMS/PFR	REVISED -
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PLOT DATE = 3/26/2020	DATE - 01/13/2020	REVISED -

STAT	E OI	F ILLINOIS
DEPARTMENT	0F	TRANSPORTATION

								F.A.U. RTE.	SECTION	COUNTY	TOTAL SHEETS	SHEET NO.
		SUN	ЛM.	ARY	OF QU	ANTITIES		2298	18-00215-21-BR	KANE	415	14
								•		CONTRACT	NO. 6	51GO2
SCALE: NTS	SHEET 1	10	OF	20	SHEETS	STA.	TO STA.		ILLINOIS FED. AII	PROJECT		

							CONSTRU	OCTION C	JUL3	
					PAR	TICIPATI	NG URBAN	I & RURAL	FUNDING	NON - PART
		SUMMARY OF QUANTITIES				STU (75	%/25%),	STR (80%	./20%)	100% LOCAL
SPECIALTY ITEM	CODE NO.	ITEM	UNIT	TOTAL QUANTITY	NEW ROAD 0001	ROAD RECON 0004	NEW BRIDGE 0008	SAFETY 0021	**SAFETY 0021	PUBLIC AGENCY
*	87301225	ELECTRIC CABLE IN CONDUIT, SIGNAL NO. 14 3C	FOOT	2,944				1,326	1,618	
*	87301245	ELECTRIC CABLE IN CONDUIT, SIGNAL NO. 14 5C	FOOT	5,892				3,736	2,156	
*	87301255	ELECTRIC CABLE IN CONDUIT, SIGNAL NO. 14 7C	FOOT	4,445				938	3,507	
*	87301305	ELECTRIC CABLE IN CONDUIT, LEAD-IN, NO. 14 1 PAIR	FOOT	9,720				3,905	5,815	
	87301805	ELECTRIC CABLE IN CONDUIT, SERVICE, NO. 6 2 C	FOOT	107				30	77	
#	87301815	ELECTRIC CABLE IN CONDUIT, SERVICE, NO. 6 3 C	FOOT	754				754		
	87301900	ELECTRIC CABLE IN CONDUIT, EQUIPMENT GROUNDING CONDUCTOR, NO. 6 1C	FOOT	3,031				1,488	1,543	
*	87502440	TRAFFIC SIGNAL POST, GALVANIZED STEEL 10 FT.	EACH	2					2	
*	87502500	TRAFFIC SIGNAL POST, GALVANIZED STEEL 16 FT.	EACH	7				4	3	
*	87702197	STEEL COMBINATION MAST ARM ASSEMBLY AND POLE WITH DUAL MAST ARMS, 16 FT. AND 44 FT.	EACH	1 .					1	
*	87702203	STEEL COMBINATION MAST ARM ASSEMBLY AND POLE WITH DUAL MAST ARMS, 18 FT. AND 46 FT.	EACH	1					1	
	87702765	STEEL MAST ARM ASSEMBLY AND POLE WITH DUAL MAST ARMS, 58 FT. AND 30 FT.	EACH	1					1	
*	87702930	STEEL COMBINATION MAST ARM ASSEMBLY AND POLE 40 FT.	EACH	1				1		
	87702960	STEEL COMBINATION MAST ARM ASSEMBLY AND POLE 46 FT.	EACH	1					1	
*	87702980	STEEL COMBINATION MAST ARM ASSEMBLY AND POLE 50 FT.	EACH	1				1		
#	87702990	STEEL COMBINATION MAST ARM ASSEMBLY AND POLE 54 FT.	EACH	2				2		
*	87800100	CONCRETE FOUNDATION, TYPE A	FOOT	20				16	4	
#	87800150	CONCRETE FOUNDATION, TYPE C	FOOT	4				4		
-	07000415									

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	USER NAME = Jeff Sedig	DESIGNED	•	JMS/PFR	REVISED	-
		DRAWN	-	PFR	REVISED	-
	PLOT SCALE = 2.0000 ' / in.	CHECKED	-	KDF	REVISED	-
	PLOT DATE = 3/26/2020	DATE	-	01/13/2020	REVISED	-

CONCRETE FOUNDATION, TYPE E 36-INCH DIAMETER

STATI	E OF	- ILLINOIS
DEPARTMENT	0F	TRANSPORTATION

						F.A.U. RTE.	SECTION	COUNTY	TOTAL	
SUMMARY 0				ANTITIES	5 [2298 18-00215-21-BR		KANE	415	15
								CONTRAC	T NO.	61G02
SCALE: NTS	SHEET 11	OF 20	SHEETS	STA,	TO STA.		ILLINOIS FE	D. AID PROJECT		

CONSTRUCTION CODES

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						CONSTRUCTION CODES								
					PAR	TICIPATI	ING URBAN	I & RURAL	FUNDING	NON-PART				
		SUMMARY OF QUANTITIES			STU (75%/25%), STR (80%/20%)									
SPECIALTY ITEM	CODE NO.	ITEM	UNIT	TOTAL QUANTITY	NEW ROAD 0001	ROAD RECON 0004	NEW BRIDGE 0008	SAFETY 0021	**SAFETY 0021	PUBLIC AGENCY				
*	87800420	CONCRETE FOUNDATION, TYPE E 42-INCH DIAMETER	FOOT	22					22					
*	88030020	SIGNAL HEAD, LED, 1-FACE, 3-SECTION, MAST-ARM MOUNTED	EACH	19				11	8					
*	88030050	SIGNAL HEAD, LED, 1-FACE, 3-SECTION, BRACKET MOUNTED	EACH	3				2	1					
*	88030070	SIGNAL HEAD, LED, 1-FACE, 4-SECTION, BRACKET MOUNTED	EACH	7				7						
*	88030080	SIGNAL HEAD, LED, 1-FACE, 4-SECTION, MAST ARM MOUNTED	EACH	2				2						
*	88030100	SIGNAL HEAD, LED, 1-FACE, 5-SECTION, BRACKET MOUNTED	EACH	3					3					
	88030110	SIGNAL HEAD, LED, 1-FACE, 5-SECTION, MAST-ARM MOUNTED	EACH	13					13					
*	88102710	PEDESTRIAN SIGNAL HEAD, LED, 1-FACE, BRACKET MOUNTED	EACH	12				4	8					
#	88200510	TRAFFIC SIGNAL BACKPLATE, RETROREFLECTIVE	EACH	34				13	21					
*	88500100	INDUCTIVE LOOP DETECTOR	EACH	28				16	12					
*	88600700	PREFORMED DETECTOR LOOP	FOOT	776				436	340					
*	88700090	CONFIRMATION BEACON	EACH	4						4				
8	88700200	LIGHT DETECTOR	EACH	8						8				
# # **********************************	88700300	LIGHT DETECTOR AMPLIFIER	EACH	2						2				
	88800100	PEDESTRIAN PUSH-BUTTON	EACH	11				3	8					
	542A0229	PIPE CULVERTS, CLASS A, TYPE 1 24"	FOOT	181	181									
	542A5491	PIPE CULVERTS, CLASS A, TYPE 1 EQUIVALENT ROUND-SIZE 36"	FOOT	118	118									
	542JC036	PIPE CULVERTS, CLASS C 36" (JACKED)	FOOT	47		47								
	· · · · · · · · · · · · · · · · · · ·			1				-1		1				

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USER NAME = Jeff Sedig	DESIGNED	-	JMS/PFR	REVISED -
	DRAWN	-	PFR	REVISED -
PLOT SCALE = 2.0000 '/ in.	CHECKED	-	KDF	REVISED -
PLOT DATE = 3/26/2020	DATE	-	01/13/2020	REVISED -

STORM SEWERS, CLASS A, TYPE 2 12"

STATE	: OF	ILLINOIS
DEPARTMENT	0F	TRANSPORTATION

FOOT

							F.A.U. RTE.	SECTION	COUNTY	TOTAL	SHEET NO.	
SUMMARY OF QUANTITIES						2298	18-00215-21-BR	KANE	415	16		
									CONTRACT	NO. 1	61GO2	
SCALE: NTS	SHEET 12	OF	20	SHEETS	STA,	TO STA.	ILLINOIS FED. AID PROJECT					

CONSTRUCTION CODES

A2005620

A2006420



USER NAME = Jeff Sedig	DESIGNED	-	JMS/PFR	REVISED -	Γ
	DRAWN	-	PFR	REVISED -	
PLOT SCALE = 2.0000 ' / in.	CHECKED	-	KDF	REVISED -	ı
PLOT DATE = 3/26/2020	DATE	-	01/13/2020	REVISED -	ı

TREE, OSTRYA VIRGINIANA (AMERICAN HOPHORNBEAM), 2-1/2" CALIPER, BALLED AND BURLAPPED

TREE, QUERCUS ALBA (WHITE OAK), 2-1/2" CALIPER, BALLED AND BURLAPPED

STATI	OF	ILLINOIS
DEPARTMENT	OF '	TRANSPORTATION

						F.A.U. RTE.	SECTION
	SI	UMMARY	OF QUA	ANTITIES		2298	18-00215-21-B
CALE: NTS	SHEET 13	0F 20	SHEETS	STA.	TO STA.		ILLINOI

34

53

34

53

EACH

CONSTRUCTION CODES

PARTICIPATING URBAN & RURAL FUNDING

NON - PART

COUNTY TOTAL SHEET NO.

KANE 415 17

CONTRACT NO. 61GO2

							CONSTR	OCTION C	ODE 2	
					PAI	RTICIPATI	NG URBAN	I & RURAL	FUNDING	NON - PART
		SUMMARY OF QUANTITIES				STU (75	%/25%),	STR (80%	0/20%)	100% LOCAL
SPECIALTY ITEM	CODE NO.	ITEM	UNIT	TOTAL QUANTITY	NEW ROAD 0001	ROAD RECON 0004	NEW BRIDGE 0008	SAFETY 0021	**SAFETY 0021	PUBLIC AGENCY
*	A2006520	TREE, QUERCUS BICOLOR (SWAMP WHITE OAK), 2-1/2" CALIPER, BALLED AND BURLAPPED	EACH	5	5					
**	A2006720	TREE, QUERCUS MACROCARPA (BUR OAK), 2-1/2" CALIPER, BALLED AND BURLAPPED	EACH	13	13					
×	A2007120	TREE, QUERCUS RUBRA (RED OAK), 2-1/2" CALIPER, BALLED AND BURLAPPED	EACH	39	39					
*	A2007820	TREE, TILIA AMERICANA (AMERICAN LINDEN/ BASSWOOD), 2-1/2" CALIPER, BALLED AND BURLAPPED	EACH	21	21					
•	A2007920	TREE, TILIA AMERICANA REDMOND (REDMOND AMERICAN LINDEN), 2-1/2" CALIPER, BALLED AND BURLAPPED	EACH	58	58					
*	A2008470	TREE, ULMUS AMERICANA PRINCETON (PRINCETON AMERICAN ELM), 2-1/2" CALIPER, BALLED AND BURLAPPED	EACH	27	27					
*	A2008519	TREE, ULMUS MORTON GLOSSY (TRIUMPH ELM), 2-1/2" CALIPER, BALLED AND BURLAPPED	EACH	67	67					
•	B2000964	TREE, AMELANCHIER LAEVIS (ALLEGHENY SERVICEBERRY), 5' HEIGHT, CLUMP FORM, BALLED AND BURLAPPED	EACH	97	97					
	B2001167	TREE, CERCIS CANADENSIS (EASTERN REDBUD), 8' HEIGHT, BALLED AND BURLAPPED	EACH	106	106					
*	B2001266	TREE, CORNUS ALTERNIFOLIA (PAGODA DOG WOOD), 6' HEIGHT, CLUMP FORM, BALLED AND BURLAPPED	EACH	85	85					
	B2001770	TREE, CRATAEGUS CRUSGALLI VAR. INERMIS (THORNLESS COCKSPUR HAWTHORN), 8' HEIGHT, BALLED AND BURLAPPED, MULTI-HEADS	EACH	84	84					
*	B2001866	TREE, CRATAEGUS MOLLIS (DOWNY HAWTHORN), 6' HEIGHT, CLUMP FORM, BALLED AND BURLAPPED	EACH	31	31					
*	B2001966	TREE, CRATAEGUS PHAENOPYRUM (WASHINGTON HAWTHORN), 6' HEIGHT, CLUMP FORM, BALLED AND BURLAPPED	EACH	53	53					
*	B2004586	TREE, MALUS RED PEACOCK (RED PEACOCK CRABAPPLE), 7' HEIGHT, CLUMP FORM, BALLED AND BURLAPPED	EACH	79	79					
	B2005066	TREE, MALUS SNOWDRIFT (SNOWDRIFT CRABAPPLE), 6' HEIGHT, CLUMP FORM, BALLED AND BURLAPPED	EACH	70	70					
	B00									
**************************************	B2006166	TREE, SYRINGA PEKINENSIS MORTON (CHINA SNOW PEKING LILAC), 6' HEIGHT, CLUMP FORM, BALLED AND BURLAPPED	EACH	65	65					
*	B2006370	TREE, SYRINGA RETICULATA IVORY SILK (IVORY SILK JAPANESE TREE LILAC), 8' HEIGHT, CLUMP FORM,	EACH	120	120					



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	USER NAME = Jeff Sedig	DESIGNED	-	JMS/PFR	REVISED	-
		DRAWN	-	PFR	REVISED	-
	PLOT SCALE = 2.0000 '/ in.	CHECKED	-	KDF	REVISED	-
	PLOT DATE = 3/26/2020	DATE	-	01/13/2020	REVISED	-

BALLED AND BURLAPPED

STATI	E OF	ILLINOIS
DEPARTMENT	0F	TRANSPORTATION

							RTE.	SECTION	COUNTY	SHEETS	5 N
	SI	JMMA	ARY	OF QUA	ANTITIES	5	2298	18-00215-21-BR	KANE	415	1
									CONTRACT	NO.	61G
SCALE: NTS	SHEET 14	0F	20	SHEETS	STA.	TO STA.		ILLINOIS FED. AI	D PROJECT		

CONSTRUCTION CODES

LongmoodowPkwu\Drow\CADD_Sheets\SectionC2-sht-SumOtu-14.cm

							CONSTITU	JCTTON CO	JD L 3	
					PAF	RTICIPATI	NG URBAN	& RURAL	FUNDING	NON - PART
		SUMMARY OF QUANTITIES				STU (75	%/25%),	STR (80%	/20%)	100% LOCAL
SPECIALTY ITEM	CODE NO.	ITEM	UNIT	TOTAL QUANTITY	NEW ROAD 0001	ROAD RECON 0004	NEW BRIDGE 0008	SAFETY 0021	**SAFETY 0021	PUBLIC AGENCY
*	B2010120	TREE, CLADRASTIS LUTEA (AMERICAN YELLOWWOOD), 2-1/2" CALIPER, BALLED AND BURLAPPED	EACH	36	36					
	C2000536	SHRUB, ARONIA MELANOCARPA (BLACK CHOKE BERRY), 3' HEIGHT, BALLED AND BURLAPPED	EACH	91	91					
	C2001536	SHRUB, CORNUS RACEMOSA (GREY DOGWOOD), 3' HEIGHT, BALLED AND BURLAPPED	EACH	49	49					
•	C2001636	SHRUB, CORNUS SERICEA (REDOSIER DOGWOOD), 3' HEIGHT, BALLED AND BURLAPPED	EACH	57	57					
•	C2002036	SHRUB, CORYLUS AMERICANA (AMERICAN FILBERT), 3' HEIGHT, BALLED AND BURLAPPED	EACH	35	35					
	C2003336	SHRUB, HAMAMELIS VIRGINIANA (COMMON WITCHHAZEL), 3' HEIGHT, BALLED AND BURLAPPED	EACH	21	21					
*	C2012436	SHRUB, VIBURNUM LENTAGO (NANNYBERRY VIBURNUM), 3' HEIGHT, BALLED AND BURLAPPED	EACH	43	43					
*	C2012736	SHRUB, VIBURNUM PRUNIFOLIUM (BLACKHAW VIBURNUM), 3' HEIGHT, BALLED AND BURLAPPED	EACH	44	44					
*	C2C05225	SHRUB, PRUNUS VIRGINIANA (COMMON CHOKE CHERRY), 3' HEIGHT, CONTAINER	EACH	10	10					
*	C2C06036	SHRUB, RHUS TYPHINA (STAGHORN SUMAC). 3' HEIGHT, CONTAINER	EACH	51	51					
	D2001988	EVERGREEN, PICEA GLAUCA DENSATA (BLACK HILLS SPRUCE), 8' HEIGHT, BALLED AND BURLAPPED	EACH	60	60					
*	D2002188	EVERGREEN, PICEA PUNGENS (COLORADO SPRUCE), 8' HEIGHT, BALLED AND BURLAPPED	EACH	74	74					
	D2003172	EVERGREEN, PSUEDOTSUGA MENZIESII (DOUGLAS FIR), 6' HEIGHT, BALLED AND BURLAPPED	EACH	85	85					
*	K0013030	PERENNIAL PLANTS, WETLAND TYPE, 2" DIAMETER BY 4" DEEP PLUG	UNIT	124	124					
	X0301797	GATE REMOVAL	EACH	2		2				
	X0322917	PROPOSED STORM SEWER CONNECTION TO EXISTING MANHOLE	EACH	2		2				
	X0322936	REMOVE EXISTING FLARED END SECTION	EACH	3		3				
*	X0323013	TUBULAR STEEL GATE	EACH	1	1					
*	X0323906	CAMERA POLE, 45 FT	EACH	1				1		
	1	1	LACII	<u> </u>	L	1		J	L	



 					_
USER NAME = Jeff Sedig	DESIGNED	-	JMS/PFR	REVISED -	_
	DRAWN	-	PFR	REVISED -	
PLOT SCALE = 2.0000 '/ in.	CHECKED	-	KDF	REVISED -	
PLOT DATE = 3/26/2020	DATE	-	01/13/2020	REVISED -	

STATE	OF	ILLINOIS
DEPARTMENT	OF '	TRANSPORTATION

						RTE.	SECTION	COUNTY	SHEETS	NO.
	SU	MMARY	OF QU	ANTITIES		2298	18-00215-21-BR	KANE	415	19
								CONTRACT	NO.	51G02
SCALE: NTS	SHEET 15	0F 20	SHEETS	STA.	TO STA.		ILLINOIS FED. AI	D PROJECT		

CONSTRUCTION CODES

sdowPkwy/Drow/CADD_Sheets/SectionC2-sht-SumOty-15_cmt.d

							CONSTRU	JCTION CO	DDES	
					PAR	TICIPATI	NG URBAN	I & RURAL	FUNDING	NON-PART
		SUMMARY OF QUANTITIES				STU (75	%/25%),	STR (80%	/20%)	100% LOCAL
SPECIALTY ITEM	CODE NO.	ITEM	UNIT	TOTAL QUANTITY	NEW ROAD 0001	ROAD RECON 0004	NEW BRIDGE 0008	SAFETY 0021	**SAFETY 0021	PUBLIC AGENCY
	X0324044	EROSION CONTROL, TEMPORARY PIPE SLOPE DRAIN	EACH	6	6					
*	X0324085	EMERGENCY VEHICLE PRIORITY SYSTEM LINE SENSOR CABLE, NO. 20 3/C	FOOT	817						817
B	X0325476	RADAR VEHICLE DETECTION SYSTEM	EACH	2				1	1	
	X0326447	FORCEMAIN CLEANOUT VAULT	EACH	1		1				
	X0326749	AIR RELEASE VALVE MANHOLE	EACH	1		1				
*	X0326810	WIRELESS COMMUNICATION DEVICE	EACH	2				2		
***************************************	X0327036	BIKE PATH REMOVAL	SQ YD	170		170				
*	X0327078	REMOVE FIRE HYDRANT AND VALVE ASSEMBLY	EACH	4						4
*	X0327369	SANITARY SEWER, DUCTILE IRON, 10"	FOOT	149						149
	X0327583	STAMPED COLORED PORTLAND CEMENT CONCRETE PAVEMENT 10" (JOINTED)	SQ YD	334	334					
	X0327979	PAVEMENT MARKING REMOVAL - GRINDING	SQ FT	1,227				1,227		
	X0327999	ANTI-GRAFFITI COATING	SQ FT	7,974						7,974
*	X1200068	FORCE MAIN BYPASS PUMPING	L SUM	1						1
*	X1400101	NETWORK CONFIGURATION	L SUM	1			***************************************	0.5	0.5	
*	X1400107	FULL-ACTUATED CONTROLLER AND TYPE SUPER P CABINET	EACH	1					1	
	X1400150	SERVICE INSTALLATION, GROUND MOUNTED, METERED	EACH	2				1	1	
*	X1400238	LUMINAIRE, LED, SPECIAL	EACH	9				9		
	X1700034	FORM LINER TEXTURED SURFACE, SPECIAL	SQ FT	60			60			VI
	X1700045	REMOVE TEMPORARY CONCRETE BARRIER NO SALVAGE	FOOT	380				380		



USER NAME = Jeff Sedig	DESIGNED	-	JMS/PFR	REVISED	-
	DRAWN	-	PFR	REVISED	-
PLOT SCALE = 2.0000 '/ in.	CHECKED	-	KDF	REVISED	-
PLOT DATE = 3/26/2020	DATE	_	01/13/2020	REVISED	_

STATI	ë OF	ILLINOIS
DEPARTMENT	OF	TRANSPORTATION

								RTE.	SECTION	COUNTY	SHEETS	NO.
		SUI	VIIVI	ARY	OF QU	ANTITIES		2298	18-00215-21-BR	KANE	415	20
										CONTRACT	NO.	61G02
SCALE: NTS	SHEET :	16	OF	20	SHEETS	STA.	TO STA.		ILLINOIS FED. AI	D PROJECT		

							CONSTRU	JCTION CO	DDES	
					PAR	TICIPATI	NG URBAN	& RURAL	FUNDING	NON - PART
		SUMMARY OF QUANTITIES			STU (75%/25%), STR (80%/20%)					100% LOCAL
SPECIALTY ITEM	CODE NO.	ITEM	UNIT	TOTAL QUANTITY	NEW ROAD 0001	ROAD RECON 0004	NEW BRIDGE 0008	SAFETY 0021	**SAFETY 0021	PUBLIC AGENCY
	X2020205	ROCK EXCAVATION (SPECIAL)	CU YD	5		5				
*	X2501100	SEEDING, CLASS 3 (SPECIAL)	ACRE	16	15.8	0.2				
*	X2501750	SEEDING, CLASS 4 (SPECIAL)	ACRE	2.0	1.9	0.1				
	X2502019	SEEDING, CLASS 4B (SPECIAL)	ACRE	3,5	3.5					
	X2503110	MOWING (SPECIAL)	ACRE	1,166	1,166					
*	X2510635	HEAVY DUTY EROSION CONTROL BLANKET, SPECIAL	SQ YD	1,235	737	498				
	X2511630	EROSION CONTROL BLANKET (SPECIAL)	SQ YD	15,342	15,342					
*	X2511640	EROSION CONTROL BLANKET (MODIFIED)	SQ YD	100,834	98,323	2,511				
-	X2800302	TEMPORARY DITCH CHECKS (SPECIAL)	FOOT	2,842	2,548	294				
	X2800400	PERIMETER EROSION BARRIER, SPECIAL	FOOT	8,286	7,569	717				
	X4022000	TEMPORARY ACCESS (COMMERCIAL ENTRANCE)	EACH	3		3				
	X4240800	DETECTABLE WARNINGS (SPECIAL)	SO FT	270	197	73				
	X5030290	STAINING CONCRETE STRUCTURES	SQ FT	7,974			7,974			
	X5150110	NAME PLATES (SPECIAL)	EACH	1			1			
*	X5610700	WATER MAIN REMOVAL	FOOT	1,862						1,862
*	X5630712	CONNECTION TO EXISTING WATER MAIN 12"	EACH	4						4
*	X5631210	CONNECTION TO EXISTING FORCE MAIN 10"	EACH	2						2
*	X5640150	FIRE HYDRANT ASSEMBLY COMPLETE	EACH	5						5
	X6020094	MANHOLES, TYPE A, 6'-DIAMETER, TYPE 1 FRAME, CLOSED LID, RESTRICTOR PLATE	EACH	1	1					

	USER NAME = Jeff Sedig	DESIGNED -	JMS/PFR	REVISED -					F.A.U. RTF.	SECTION	COUNTY	TOTAL	SHEET NO.
SCMT		DRAWN -	PFR	REVISED -	STATE OF ILLINOIS		SUMMARY OF QUANT	ITIES	2298	18-00215-21-BR	KANE	415	21
	PLOT SCALE = 2.0000 '/ in.	CHECKED -	KDF	REVISED -	DEPARTMENT OF TRANSPORTATION						CONTRAC	T NO. F	1G02
Lingto No. 194-0000:3 . compose cut se	PLOT DATE = 3/26/2020	DATE -	01/13/2020	REVISED -		SCALE: NTS	SHEET 17 OF 20 SHEETS STA	. TO STA.	1	ILLINOIS FED.	AID PROJECT		

							CONSTRU	JCTION CO	DDES	
					PAR	TICIPATI	NG URBAN	& RURAL	FUNDING	NON-PART
		SUMMARY OF QUANTITIES				STU (759	%/25%),	STR (80%,	(20%)	100% LOCAL
SPECIALTY ITEM	CODE NO.	ITEM	UNIT	TOTAL QUANTITY	NEW ROAD 0001	ROAD RECON 0004	NEW BRIDGE 0008	SAFETY 0021	**SAFETY 0021	PUBLIC AGENCY
	X6024210	DOUBLE INLET, SPECIAL	EACH	6	6					
*	X6026622	VALVE VAULTS TO BE REMOVED	EACH	2						2
	X6062206	STAMPED COLORED PORTLAND CEMENT CONCRETE MEDIAN SURFACE 6 INCH	SQ FT	1,496	1496					
	X7010216	TRAFFIC CONTROL AND PROTECTION, (SPECIAL)	L SUM	1				1		
	X7030005	TEMPORARY PAVEMENT MARKING REMOVAL	SQ FT	6,757	***************************************			6,757		
*	X7200105	SIGN PANEL - TYPE 1 (SPECIAL)	SO FT	36				36		
*	X7800100	PAINT PAVEMENT MARKING - RAISED MEDIAN	SQ FT	646				646		
*	X7800200	PAINT PAVEMENT MARKING CURB	FOOT	598				598		
	X8211000	UNDERPASS LUMINAIRE (SPECIAL)	EACH	2				2		
	X8250505	LIGHTING CONTROLLER, SPECIAL	EACH	1				1		
*	X8300001	LIGHT POLE, SPECIAL	EACH	25				25		
	X8304515	LIGHT POLE, ALUMINUM, 30 FT. M.H., 6 FT. MAST ARM (SPECIAL)	EACH	9				9		
*	X8360103	LIGHT POLE FOUNDATION, INTEGRAL WITH BARRIER WALL	EACH	5				5		
86	X8360367	LIGHT POLE FOUNDATION, METAL, 15" BOLT CIRCLE, 10" X 10"	EACH	1				1		
44	X8620200	UNINTERRUPTABLE POWER SUPPLY, SPECIAL	EACH	2				1	1	
R	X8710031	FIBER OPTIC CABLE 36 FIBERS, SINGLE MODE	FOOT	6,976				6,976		
	XX000856	MAILBOX REMOVAL AND RELOCATION	EACH	2		2				
*	XX001249	ORNAMENTAL FENCE	FOOT	104				104	-	
	XX004210	STORM SEWER DUCTILE IRON 12"	FOOT	113	113					

	USER NAME = Jeff Sedig	DESIGNED - JMS/PFR	REVISED -	
SCMT		DRAWN - PFR	REVISED -	STATE OF ILLINOIS
	PLOT SCALE = 2.0000 '/ in.	CHECKED - KDF	REVISED -	DEPARTMENT OF TRANSPORTATION
Theorem No. 195,5556.3	PLOT DATE = 3/26/2020	DATE - 01/13/2020	REVISED -	

					F.A.U. RTE.	SECTION	COUNTY	TOTAL	SHEET NO.
	SU	JMMARY	OF QUANTITIES		2298	18-00215-21-BR	KANE	415	22
								NO.	61G02
SCALE: NTS	SHEET 18	0F 20	SHEETS STA.	TO STA.		ILLINOIS FED. AI	D PROJECT		

			D 4 F	T.C.D.A.T.I	NC UDDAN	C DUDAL	ELIND INC	NON-PART		
					PAF				FUNDING	NON-TAILT
		SUMMARY OF QUANTITIES				STU (75	%/25%),	STR (80%)	/20%)	100% LOCAL
SPECIALTY ITEM	CODE NO.	ITEM	UNIT	UNIT TOTAL QUANTITY	NEW ROAD 0001	ROAD RECON 0004	NEW BRIDGE 0008	SAFETY 0021	**SAFETY 0021	PUBLIC AGENCY
	XX006238	STORM SEWER DUCTILE IRON 15"	FOOT	41	41					
N.	XX007251	INTERSECTION VIDEO TRAFFIC MONITORING SYSTEM WITH PTZ CAMERA	EACH	1				1		
*	XX008392	OUTDOOR RATED NETWORK CABLE	FOOT	357				357		
*	XX008453	ETHERNET SWITCH, TYPE 1	EACH	1				1		
*	XX008454	ETHERNET SWITCH, TYPE 2	EACH	1				1		
*	XX008829	REMOVAL AND DISPOSAL OF EXISTING FORCE MAIN	FOOT	260						260
	XX008865	PERMEABLE PLASTIC BERM	FOOT	3,350	3,003	347				
*	XX008963	THREE CELL FABRIC INNERDUCT	FOOT	4,329				4,329		
*	XX009297	LUMINAIRE, LED, HORIZONTAL MOUNT, SPECIAL	EACH	4				4		
***************************************	Z0012193	BRIDGE DECK THIN POLYMER OVERLAY 3/8"	SQ YD	800			800			
	Z0013796	SEDIMENT CONTROL, STABILIZED CONSTRUCTION ENTRANCE	SQ YD	667		667				
	Z0013798	CONSTRUCTION LAYOUT	L SUM	1	1					
	Z0018000	DRAINAGE SCUPPERS (SPECIAL)	EACH	2			2			-
	Z0018004	DRAINAGE SCUPPERS, DS-12	EACH	8			8			
	Z0018800	DRAINAGE SYSTEM	L SUM	1			1			
	Z0019600	DUST CONTROL WATERING	TINU	825	625	200				
	Z0023202	SEDIMENT CONTROL, DRAINAGE STRUCTURE INLET FILTER CLEANING	EACH	180	158	22				
	Z0030850	TEMPORARY INFORMATION SIGNING	SQ FT	115				115	·	

SCMT	
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USER NAME = Jeff Sedig	DESIGNED	-	JMS/PFR	REVISED -
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PLOT SCALE = 2.0000 ' / in.	CHECKED	-	KDF	REVISED -
PLOT DATE = 3/26/2020	DATE	-	01/13/2020	REVISED -

ELECTRIC SERVICE DISCONNECT, LIGHTING AND TRAFFIC SIGNAL

STATI	E OF	ILLINOIS
DEPARTMENT	0F	TRANSPORTATION

						F.A.U. RTE.	SECTION	COUNTY	TOTAL	SHEET NO.	
	SUN	IMARY	OF QUA	F QUANTITIES			18-00215-21-BR	KANE	415	23	
······								CONTRACT	NO.	61G02	
SCALE: NTS	SHEET 19	OF 20	SHEETS	STA.	TO STA.	ILLINOIS FED. AID PROJECT					

CONSTRUCTION CODES

				PARTICIPATING URBAN & RURAL FUNDING NON-PART									
					PAR	RTICIPATI	NG URBAN	& RURAL	FUNDING	NON-PART			
		SUMMARY OF QUANTITIES				STU (75	%/25%),	STR (80%)	/20%)	100% LOCAL			
SPECIALTY ITEM	CODE NO.	ITEM	UNIT	TOTAL QUANTITY	NEW ROAD 0001	ROAD RECON 0004	NEW BRIDGE 0008	SAFETY 0021	**SAFETY 0021	PUBLIC AGENCY			
*	Z0033046	RE-OPTIMIZE TRAFFIC SIGNAL SYSTEM LEVEL 2	EACH	1					1				
	Z0034212	MECHANICALLY STABILIZED EARTH RETAINING WALL, SPECIAL	SO FT	11,205			11,205						
	Z0046306	PIPE UNDERDRAINS FOR STRUCTURES 6"	FOOT	530			530						
	Z0054406	ROCK FILL - FOUNDATION	CU YD	961	961								
	Z0056612	STORM SEWER (WATER MAIN REQUIREMENTS) 18 INCH	FOOT	246	246								
	Z0062456	TEMPORARY PAVEMENT	SQ YD	651		651							
	Z0066700	STABILIZED DRIVEWAYS 10"	SQ YD	605		605							
	Z0076600	•••TRAINEES	HOUR	1,500									
	Z0076604	•••TRAINEES TRAINING PROGRAM GRADUATE	HOUR	1,500									
*	Z0077900	WOOD POST AND RAIL FENCE	FOOT	103				103					
~	2001.300	WOOD FOR THE WIND FEROE											

**SAFETY ITEMS SEPARATED FOR IL-25 INTERSECTION

*** UNDER CODE 0042 TRAINEES

RCMT	
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USER NAME = Jeff Sedig	DESIGNED -	JMS/PFR	REVISED -
	DRAWN -	PFR	REVISED -
PLOT SCALE = 2.0000 '/ in.	CHECKED -	KDF	REVISED -
PLOT DATE = 3/26/2020	DATE -	01/13/2020	REVISED -

STATE OF ILLINOIS
DEPARTMENT OF TRANSPORTATION

			F.A.U. RTE.	SECTION	COUNTY	TOTAL SHEETS	SHEET NO.	
	SUMMARY	OF QUANTITIES		2298	18-00215-21-BR	KANE	415	24
						CONTRACT	NO.	61G02
SCALE: NTS	SHEET 20 OF 20	SHEETS STA.	TO STA.		ILLINOIS FED. AI	D PROJECT		

CONSTRUCTION CODES

SCHEDULE OF EARTHWORK (MEASURED VOLUMES)									
		(C1)	(C2)	(F1)	(F2)	(F3)	(F4)		
FROM	ТО	SUITABLE MATERIAL EXCAVATION VOLUME	UNSUITABLE MATERIAL EXCAVATION VOLUME	•ROADWAY EMBANKMENT	*ROADSIDE EMBANKMENT	ROCK FILL FOUNDATION	AGG SUBGRADE IMPROVEMENT		
STATION	STATION	(CU YD)	(CU YD)	(CU YD)	(CU YD)	(CU YD)	(CU YD)		
LONGMEADOW	PARKWAY								
2218+35.85	2219+30.00	101	931	1,966	787	961	0		
2219+30.00	2220+20.00	337	412	1,860	225	0	0		
2220+20.00	2221+10.00	938	521	991	307	0	0		
2221+10.00	2222+00.00	7,628	758	346	359	0	0		
2222+00.00	2223+00.00	15,512	941	0	194	0	0		
2223+00.00	2224+00.00	22,315	911	0	6	0	0		
2224+00.00	2225+00.00	24,823	945	4	7	0	0		
2225+00.00	2226+00.00	20,839	925	0	12	0	0		
2226+00.00	2227+00.00	16,447	904	0	12	0	0		
2227+00.00	2228+00.00	13,321	701	0	12	0	0		
2228+00.00	2229+00.00	19,437	257	0	13	0	0		
2229+00.00	2230+00.00	23,976	248	0	182	0	0		
2230+00.00	2231+00.00	22,963	753	0	100	0	0		
2231+00.00	2232+00.00	18,769	756	0	12	0	0		
2232+00.00	2233+00.00	12,880	946	0	12	0	0		
2233+00.00	2234+00.00	9,192	688	0	12	0	0		
2234+00.00	2235+00.00	5,902	653	4	7	0	0		
2235+00.00	2236+00.00	3,560	1,717	319	44	0	0		
22236+00.00	2236+50.00	294	2,477	830	151	0	0		
2236+50.00	2239+00.00	994	11.965	5,102	1,155	0	0		
2239+00.00	2240+00.00	620	579	115	204	0	0		
2240+00.00	2241+00.00	684	547	232	131	0	0		
2241+00.00	2242+00.00	1,683	546	256	109	0	0		
2242+00.00	2243+00.00	3,703	575	12	24	0	0		
2243+00.00	2244+00.00	5,703	530	0	53	0	0		
2244+00.00	2245+00.00	4,895	696	0	320	0	0		
				0		0	0		
2245+00.00	2246+00.00	2,557	770	·	1,089	-	-		
2246+00.00	2247+00.00	2,006	770 770	0	1,316	0	0		
2247+00.00	2248+00.00	1,379			1,573		-		
2248+00.00	2249+00.00	766	768	39	1,917	0	0		
2249+00.00	2250+00.00	311	768	250	2,376	0	0		
2250+00.00	2251+00.00	108	770	407	2,641	0	0		
2251+00.00	2252+00.00	129	768	248	2,449	0	0		
2252+00.00	2253+00.00	157	768	176	2,294	0	0		
2253+00.00	2254+00.00	227	770	236	2,263	0	0		
2254+00.00	2255+00.00	358	770	258	2,156	0	0		
2255+00.00	2256+00.00	570	770	157	1,965	0	0		
2256+00.00	2257+00.00	700	769	108	1,723	0	0		
2257+00.00	2258+00.00	801	770	110	1,825	0	0		
2258+00.00	2259+00.00	764	770	111	1,808	0	0		
2259+00.00	2260+00.00	700	770	151	1,863	0	0		
2260+00.00	2261+00.00	574	771	134	2,205	0	0		
2261+00.00	2262+00.00	426	771	130	2,420	0	0		
2262+00.00	2263+00.00	440	711	73	1,897	0	0		
2263+00.00	2264+00.00	618	534	31	427	0	0		
2264+00.00	2265+00.00	883	525	12	242	0	0		
2265+00.00	2266+00.00	876	522	23	149	0	0		
2266+00.00	2267+00.00	248	535	328	300	0	0		
2267+00.00	2268+00.00	77	557	602	442	0	0		
2268+00.00	2269+00.00	14	677	364	453	0	0		
2269+00.00	2270+00.00	62	62	62	62	0	0		
TOWER ROAD									
01+25.00	02+00.00	963	288	0	66	0	0		
02+00.00	03+35.00	1233	345	4	10	0	0		
BOLZ ROAD C									
701+00.00	702+10.00	1,538	839	166	2,047	0	0		
702+10.00	703+10.00	2,235	740	10	1,527	0	0		
703+10.00	703+50.00	1,118	1,118	1,118	1,118	0	0		

SCHEDULE C	F EARTHWORI	K (MEASURED	VOLUMES)				
		(C1)	(C2)	(F1)	(F2)	(F3)	(F4)
FROM	то	SUITABLE MATERIAL EXCAVATION VOLUME	UNSUITABLE MATERIAL EXCAVATION VOLUME	*ROADWAY EMBANKMENT	*ROADSIDE EMBANKMENT	ROCK FILL FOUNDATION	AGG SUBGRADE IMPROVEMENT
STATION	STATION	(CU YD)	(CU YD)	(CU YD)	(CU YD)	(CU YD)	(CU YD)
BOLZ ROAD	T	T		1	T		
504+69.42	506+00.00	408	1,121	0	95	0	207
506+00.00	506+95.38	80	1,659	0	279	0	730
506+95.38	507+72.58	106	952	3	124	0	547
507+72.58	509+00.00	344	617	165	71	0	0
509+00.00	510+00.00	569	2,498	631	196	0	0
510+00.00	511+00.00	2,563	2,117	277	92	0	0
511+00.00	511+77.17	6,180	874	61	36	0	0
511+77.17	513+00.00	5,062	1,091	116	78	0	0
513+00.00	514+00.00	1,774	764	109	77	0	0
514+00.00	515+00.00	1,507	451	72	54	0	0
515+00.00	516+00.00	305	1,085	278	111	0	0
516+00.00	517+00.00	640	1,494	206	100	0	0
517+00.00	518+00.00	422	1,348	182	93	0	0
518+00.00	519+00.00	108	738	220	204	0	0
519+00.00	520+00.00	20 125	310	343	373 93	0	0
520+00.00	521+00.00	144	800 1 . 417	194	88	0	0
521+00 . 00 522+00 . 00	522+00.00	716	5,732	898	461	0	0
526+00.00	526+00 . 00	276	1,103	236	156	0	0
527+00.00	528+00.00	16	568	217	296	0	0
528+00.00	529+00.00	30	556	204	254	0	0
529+00.00	530+00.00	48	738	318	258	0	0
530+00.00	531+00.00	20	1,188	662	322	0	0
531+00.00	532+00.00	16	1.086	662	311	0	0
532+00.00	532+50.00	6	6	6	6	0	0
		_		_	_		_
HILL IMMEDIA	TELY EAST OF	BOLZ ROAD CO	NNECTOR				
2238+00.00	2239+00.00	40	800	0	11,207	0	0
2239+00.00	2240+00.00	0	969	0	18,414	0	0
2240+00.00	2241+00.00	0	653	0	10,377	0	0
2241+00.00	2242+00.00	14	144	0	2,580	0	0
2242+00.00	2243+00.00	2	23	0	218	0	0
POND IMMEDIA	TELY WEST OF	BOLZ ROAD CO	ONNECTOR				
2231+40.00	2232+00.00	6,086	444	0	0	0	0
2232+00.00	2233+00.00	10,947	1,057	0	0	0	0
2233+00.00	2234+00.00	12,395	1,112	0	0	0	0
2234+00.00	2235+00.00	12,216	1,112	0	0	0	0
2235+00.00	2236+00.00	12,566	1,112	0	0	0	0
2236+00.00	2236+50.00	7,106	814	0	0	0	0
ТО	TAL	363,237	91,326	23,129	93,429	961	1,484

UNDERCUT SCHEDULE UNDERCUT DESCRIPTION (1) (2) STATION STATION 2238+50 CUT 5.5' BELOW PR AGG. SUB. IMPROVE. (4) 2236+00 2263+45 CUT 1.0' BELOW PR AGG. SUB. IMPROVE. 2260+93 2270+98 CUT 3.5' BELOW PR AGG. SUB. IMPROVE. 2268+50 504+48 507+46 CUT 4.2' BELOW PR AGG. SUB. IMPROVE. 508+50 CUT 1.5' BELOW PR AGG. SUB. IMPROVE. 510+00 513+50 CUT 0.5' BELOW PR AGG. SUB. IMPROVE. 515+00 516+00 CUT 0.75' BELOW PR AGG. SUB. IMPROVE. 532+50 CUT 3.0' BELOW EX GRADE (3) 529+92

(1) AT A MINIMUM, THE BASE OF THE UNDERCUTS SHOULD EXTEND AWAY FROM THE PAVEMENT AT A 1:1 SLOPE

532+50 CUT 1.5' BELOW PR AGG. SUB. IMPROVE.

- (2) REMOVAL DEPTH IS BELOW THE PROPOSED AGGREGATE SUBGRADE IMPROVEMENT (ASI) BASE EXCEPT AS NOTED.
- (3) REMOVAL BELOW EXISTING GRADE IS SPECIFIED BECAUSE THE PROPOSED GRADE IS HIGHER THAN THE EXISTING GRADE.

515+00

(4) AS AN ALTERNATIVE, 12 INCHES OF UNDERCUT BELOW ASI BASE WITH GEOTECHNICAL FABRIC FOR GROUND STABILIZATION AT THE EXCAVATED BASE CAN BE USED.

- INCLUDED IS 56 CU YD OF SUITABLE MATERIAL EXCAVATION FROM IL-25

SCHEDULE OF EARTHWORK (DERIVED QUANTITIES)

EARTH EXCAVATION

- EARTH EXCAVATION ASSOCIATED WITH REGULATED SUBSTANCES (SEE NEXT SHEET FOR DETAILS)
 HAZARDOUS WASTE DISPOSAL = 38,695
- REGULATED SUBSTANCES = 38,695 + 6,191
 REGULATED SUBSTANCES = 44,886
- EARTH EXCAVATION USED IN FILLS = (F1 + F2) / 0.85 EARTH EXCAVATION USED IN FILLS = (23,129 + 93,429) / 0.85 EARTH EXCAVATION USED IN FILLS = 137,127 CU YD

SCALE: NTS

- SUITABLE EX ON SITE AVAILABILITY CHECK:
 F1 < (C1 REGULATED SUBSTANCES) 0.85
 137,127 < (363,237 44,886) 0.85
 137,127 < 270,598 -----CRITERIA MET----• EARTH EXCAVATION = REOUIRED FOR FILLS + REGULATED SUBSTANCES
 EARTH EXCAVATION = 137,127 + 44,886

 EARTH EXCAVATION = 182,013

REMOVAL AND DISPOSAL OF UNSUITABLE MATERIAL (20201200)

- TOTAL EXCAVATED MATERIAL = C1 + C2
 TOTAL EXCAVATED MATERIAL = 363,237 + 91,326
 TOTAL EXCAVATED MATERIAL = 454,563 CU YD
 TOTAL EXC. MAT. USED ON SITE = PI 20200100
 TOTAL EXC. MAT. USED ON SITE = 182,013 CU YD
- SURPLUS = 454,563 182,013 SURPLUS = 272,640 CU YD REMOVAL AND DISPOSAL OF UNSUITABLE MATERIAL = 272,640 CU YD

GEOTECHNICAL FABRIC FOR GROUND STABILIZATION (21001000) AGGREGATE SUBGRADE IMPROVEMENT (30300001)

- FOR ESTIMATING PURPOSES, IT IS ASSUMED 10% OF THE PROPOSED ROADWAY SUBGRADE WILL REQUIRE AN UNDERCUT OF 12%. THESE AREAS SHALL REQUIRE THE INSTALLATION OF GEOTECHNICAL FABRIC FOR GROUND STABILIZATION AND AGGREGATE SUBGRADE

- OF GEOTECHNICAL FABRIC FOR GROUND STABILIZATION AND AGGREGATE SUBGRADE
 IMPROVEMENT (CU YD).

 ROADWAY SUBGRADE AREA = 50,794 SO YD

 10%. OF ROADWAY SUBGRADE AREA = 5,079 SO YD

 GEOTECHNICAL FABRIC FOR GROUND STABILIZATION = 5,079 SO YD

 VOLUME OF ASSUMED UNDERCUTS = 5,079 SO YD (1 FOOT (1 FOOT/3 YARD))

 VOLUME OF ASSUMED UNDERCUTS = 1,693 CU YD

 AGGREGATE SUBGRADE IMPROVEMENT = 1,693 CU YD



USER NAME = Jeff Sedig	DESIGNED - PFR	REVISED -
	DRAWN - PFR	REVISED -
PLOT SCALE = 2.0000 '/ in.	CHECKED - KDF	REVISED -
PLOT DATE = 3/2/2020	DATE - 01/13/2020	REVISED -

STATE OF ILLINOIS **DEPARTMENT OF TRANSPORTATION**

FARTHMORK CONFRINCE							SECTION
EARTHWORK SCHEDULES						2298	18-00215-21-B
SHEET 1	OF	2	SHEETS	STA.	TO STA.		TI I INOI

COUNTY KANE 415 25 CONTRACT NO. 61GO2


EARTHWORK NOTES:

- I. THIS PROJECT HAS A LARGE NET EXCESS OF EXCAVATED MATERIALS. THE CONTRACTOR SHALL BE PAID FOR THE HANDLING OF EARTHWORK ONLY ONCE, REGARDLESS OF STAGING OPERATIONS. THE CONTRACOR SHALL BE RESPONSIBLE FOR HIS EARTHWORK OPERATIONS INCLUDING EXCAVATING AND STOCKPILING OF EXCAVATED MATERIALS FOR RE-HANDLING AT A LATER DATE (IF NECESSARY). THIS APPLIES TO ALL EXCAVATED MATERIALS TO BE USED ON SITE OR SURPLUS MATERIAL REMOVED FROM THE SITE.
- 2. A 15% SHRINKAGE FACTOR HAS BEEN APPLIED FOR EARTH EXCAVATION AND TOPSOIL EXCAVATION AND PLACEMENT.
- . AN ENVIRONMENTAL INVESTIGATION HAS BEEN CONDUCTED TO TEST FOR CLEAN CONSTRUCTION AND DEMOLITION DEBRIS (CCDD) COMPATIBILITY. THE INVESTIGATION CONCLUDED THAT ALL SOILS WITHIN THE PROJECT (WITH THE EXCEPTION OF MATERIALS WITHIN THE SOIL MANAGEMENT ZONES SEE MORE INFORMATION ON THIS SHEET) LIKELY MEETS THE PH REQUIREMENTS AS ENFORCED BY THE ILLINOIS ENVIRONMENTAL PROTECTION AGENCIES AND CCDD RECEIVING FACILITIES.
- I. THE EARTHWORK CALCULATIONS INCLUDE AREA MEASUREMENTS PER CROSS SECTION. EACH MEASUREMENT IS CATEGORIZED BY AN ABBREVIATION IN PARENTHESIS STARTING WITH "C" FOR A CUT MEASUREMENT AND "F" FOR A FILL MEASUREMENT. EACH IS DESCRIBED BELOW:

SUITABLE MATERIAL EXCAVATION VOLUME (C1)	ALL EXCAVATION SUITABLE FOR USE AS ROADWAY EMBANKMENT. A GEOTECHNICAL STUDY INDICATES THAT ALL SOILS THAT ARE NEITHER TOPSOIL, NOR WITHIN UNDERCUT LIMITS ARE ANTICIPATED TO BE SUITABLE.
UNSUITABLE MATERIAL EXCAVATION VOLUME (C2)	EXCAVATION WITHIN UNDERCUT LIMITS. FOR INFORMATION ON THE FILL WITHIN UNDERCUT LIMITS, REFER TO NOTE 5.
ROADWAY EMBANKMENT VOLUME (F1)	EMBANKMENT SUITABLE FOR SUPPORTING THE ROADWAY AND MULTI-USE PATH.
ROADSIDE EMBANKMENT VOLUME (F2)	EMBANKMENT LIMITED TO AREAS NOT APPLICABLE TO ROADWAY EMBANKMENT. ROADSIDE EMBANKMENT MUST NOT BE USED FOR SUPPORTING THE ROADWAY OR MULTI-USE PATH.
ROCK FILL – FOUNDATION VOLUME (F4)	USED BENEATH MECHANICALLY STABILIZED EARTH RETAINING WALLS IN AREAS SPECIFIED IN THE PLANS.

5. EARTHWORK PAY ITEM QUANTITIES ARE DERIVED FROM THE MEASUREMENTS DESCRIBED IN NOTE 4 AND SHOWN IN THE SCHEDULE OF EARTHWORK.

EARTH EXCAVATION	INCLUDES ALL MATERIAL THAT IS EXCAVATED FROM ONSITE AND USED ONSITE AS ROADWAY EMBANKMENT OR ROADSIDE EMBANKMENT. EARTH EXCAVATION SHALL BE IN ACCORDANCE WITH SECTION 202 OF THE I.D.O.T. STANDARD SPECIFICATIONS.
FURNISHED EXCAVATION	NOT REQUIRED FOR THIS CONTRACT AS SUFFICIENT QUANTITY OF FILL CAN BE FOUND ONSITE.
REMOVAL AND DISPOSAL OF UNSUITABLE MATERIAL	INCLUDES ALL SURPLUS MATERIAL THAT IS EXCAVATED FROM ONSITE AND IS NOT USED AS ONSITE FILL. THIS MATERIAL SHALL BE REMOVED AND DISPOSED OF OFF-SITE IN ACCORDANCE WITH SECTION 202 OF THE I.D.O.T. STANDARD SPECIFICATIONS. THE PLAN QUANTITY IS CALCULATED UNDER THE ASSUMPTION THAT SURPLUS EXCAVATED MATERIAL SHALL BE HANDLED ONE TIME BY THE CONTRACTOR.
AGGREGATE SUBGRADE IMPROVEMENT	APPLICABLE TO UNDERCUT LOCATIONS, EITHER AS SHOWN ON THE CROSS SECTIONS OR AS IDENTIFIED IN THE FIELD. UNDERCUT REPRESENTS LOCATIONS WHERE THE SOILS BELOW THE PROPOSED ROADWAY ARE UNSUITABLE TO SUPPORT THE ROADWAY. UNSUITABLE MATERIALS SHALL BE REMOVED UNTIL SUITABLE MATERIALS ARE ENCOUNTERED. EARTH EXCAVATION (ROADWAY EMBANKMENT) MAY BE SUBSTITUTED AS FILL WITHIN UNDERCUT AREAS WHERE APPROVED BY THE ENGINEER. THE RESIDENT ENGINEER SHALL APPROVE THE UNDERCUT AREAS AND DEPTH TO REMEDY THE UNSUITABLE MATERIALS.
TOPSOIL FURNISH AND PLACE	ALL TOPSOIL FOR THIS PROJECT SHALL BE FURNISHED AND PLACED AT THE DEPTHS INDICATED IN THE PLANS.

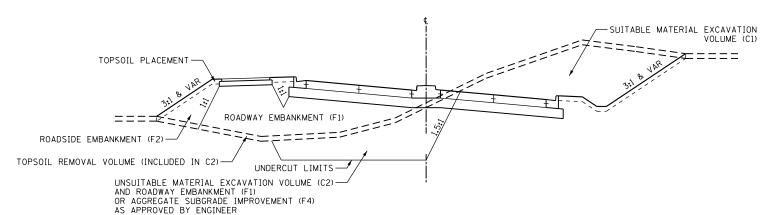


EXAMPLE TYPICAL SECTION FOR EARTHWORK DEFINITIONS



USER NAME = Jeff Sedig	DESIGNED	-	PFR	REVISED	=
	DRAWN	-	PFR	REVISED	=
PLOT SCALE = 2.0000 '/ in.	CHECKED	-	KDF	REVISED	=
PLOT DATE = 3/2/2020	DATE	-	01/13/2020	REVISED	=

STATE OF ILLINOIS DEPARTMENT OF TRANSPORTATION

					F.A.U. RTE.	SECTION		COUNTY	TOTAL SHEETS	SHEE'		
EARTHWORK SCHEDULES				2298	18-00215-21-BR		KANE	415	26			
										CONTRACT	NO.	61G02
SHEET	2	OF	2	SHEETS	STA.	TO STA.		ILLINOIS	FED. AI	D PROJECT		

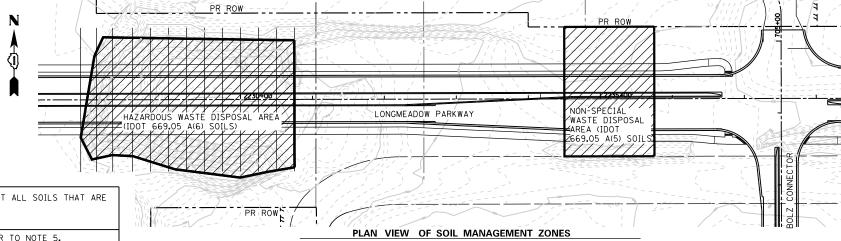

HAZARDOUS WASTE DISPOSAL AREA - IDOT 669.05 A(6) SOILS

LONGMEADOW	OFFSET 1		OFFSET 2		OFFSET 3		OFFSET 4		OFFSET 5		OFFSET 6	
STATION	OFFSET	BOTTOM ELEV.	OFFSET	BOTTOM ELEV.	OFFSET	BOTTOM ELEV.	OFFSET	BOTTOM ELEV.	OFFSET	BOTTOM ELEV.	OFFSET	BOTTOM ELEV.
2227+77.98	52.44' RT	813.47										
2228+00.00	66.73' LT	807.92	31.43' LT	808.00	37.26' RT	810.00	65.93' RT	811.00	81.50' RT	815.21		
2228+22.39	85.58' LT	807.97	50.00' LT	807.90	1.87' LT	808.00	42.11' RT	811.00	70.56' RT	814.00	76.80' RT	814.00
2228+50.00	86.09' LT	808.00	37.52' RT	808.00	78.43' RT	814.87						
2228+75.00	85.65' LT	808.00	51.80' RT	808.00	80.25' RT	810.00	86.12' RT	811.97				
2229+00.00	85.21' LT	808.00	54.62' RT	808.00	75.38' RT	809.00	94.04' RT	810.00				
2229+25.00	84.77' LT	808.00	51.97' RT	808.00	98.92' RT	810.00						
2229+50.00	84.33' LT	808.00	48.62' LT	808.00	29.36' RT	809.00	95.23' RT	809.00	102.11' RT	812.69		
2229+75.00	83.89' LT	808.00	54.45' LT	808.00	27.91' RT	809.00	80.75' RT	809.00	96.63' RT	810.00	105.30' RT	814.34
2230+00.00	83.45' LT	807.14	34.36' LT	808.00	7.25' RT	809.00	21.67' RT	810.00	57.53' RT	816.50	96.93' RT	816.50
2230+25.00	83.01' LT	808.00	75.47' LT	808.00	50.01' LT	812.50	103.14' RT	812.50				
2230+50.00	82.57' LT	814.36	22.97' LT	820.00	24.13' RT	826.00	66.42' RT	825.00	98.50' RT	830.10		
2230+75.00	82.14' LT	825.60	46.83' LT	828.74	11.52' LT	837.23	23.78' RT	839.76	59.09' RT	839.31	94.39' LT	838.43

NOTE: ALL SOIL WITHIN THE HORIZONTAL LIMITS AND ABOVE THE BOTTOM SURFACE ELEVATION LISTED IN THE TABLE SHALL BE PROCESSED AS HAZARDOUS WASTE DISPOSAL, AND IT IS QUANTIFIED AS SUCH. TOTAL PLAN QUANTITY WITHIN THIS LIMIT IS 38,695 CU YD. THIS VOLUME IS ALSO QUANTIFIED IN THIS CONTRACT AS EARTH EXCAVATION.

HAZARDOUS WASTE DISPOSAL AREA (IDOT 669.05 A(6) SOILS) - NOTES

- 1. A SIGNIFICANT NUMBER OF SAMPLES HAVE BEEN COLLECTED FROM WITHIN THE HAZARDOUS WASTE AREA TO CHARACTERIZE THE MATERIAL FOR PROPER DISPOSAL CONSIDERATIONS, CONSISTENT WITH CHARACTERIZATION REQUIREMENTS PROVIDED BY A FIRM THAT CAN HANDLE THE TREATMENT AND DISPOSAL. THIS INFORMATION IS INCLUDED IN TWO WASTE CHARACTERIZATION DOCUMENTS AVAILABLE TO BIDDERS ON FILE WITH KANE COUNTY DIVISION OF TRANSPORTATION.
- THE DESIGN TEAM IDENTIFIED HAZARDOUS LEVELS OF LEAD-IMPACTED SOIL WITHIN THE HAZARDOUS WASTE DISPOSAL AREA. THE ASSUMED OPTION FOR HANDLING AND DISPOSAL OF SPOILS WITHIN THE HAZARDOUS WASTE DISPOSAL AREA INCLUDES EXCAVATION AND TRANSPORT TO AN OFF-SITE FACILITY FOR BATCH TREATMENT TO RENDER THE SPOILS NON-HAZARDOUS AND ULTIMATE DISPOSAL IN A FACILITY THAT ACCEPTS SUCH POST-TREATED SOILS.
- 3. THE ABOVE NOTES ARE FOR THE CONTRACTOR'S INFORMATION, AND THEY ARE NOT INTENDED TO DICTATE THE CONTRACTOR'S MEANS AND METHODS. ALL INFORMATION PROVIDED IN THESE NOTES AND REPORTS ARE TO PROVIDE INSIGHT INTO FINDINGS DISCOVERED DURING DESIGN AND PROVIDE POTENTIAL METHODS THE CONTRACTOR MAY EMPLOY TO MITIGATE THE HAZARDOUS WASTE.
- 4. THE COUNTY AND COUNTY ENVIRONMENTAL REPRESENTATIVES WILL BE ON SITE TO MANAGE AND MONITOR OPERATIONS ASSOCIATED WITH THE REMOVAL OF THE HAZARDOUS WASTE TO ENSURE COMPLIANCE WITH AND APPROVAL BY THE IEPA. THE CONTRACTOR IS EXPECTED TO WORK IN COOPERATION WITH THESE INDIVIDUALS. TEMPORARY WELLS MAY BE INSTALLED (BY OTHERS) TO FACILITATE THE MONITORING OF GROUNDWATER QUALITY PRIOR TO AND/OR AFTER THE REMOVAL OF THE HAZARDOUS WASTE. CONTRACTOR SHALL BE AWARE OF AND PROTECT EXISITING GROUNDWATER MONITORING WELLS UNTIL THEY ARE NO LONGER NEEDED, AT WHICH POINT THE CONTRACTOR SHALL REMOVE THE WELLS IF NECESSARY.


NON-SPECIAL WASTE DISPOSAL AREA - IDOT 669.05 A(5) SOILS

SCALE: NTS

THE NON-SPECIAL WASTE DISPOSAL AREA IS FROM STATION 2234+50 TO STATION 2235+75 AND IS BOUND BY THE PROPOSED RIGHT-OF-WAY TO THE NORTH AND THE FORMER EXISTING BOLZ ROAD RIGHT-OF-WAY TO THE SOUTH. ALL EXCAVATED SOIL WITHIN THIS AREA SHALL BE PROCESSED AS NON-SPECIAL WASTE DISPOSAL, AND IT IS OUANTIFIED AS SUCH. TOTAL PLAN QUANTITY WITHIN THIS LIMIT IS 6,191 CU YD. THIS VOLUME IS ALSO QUANTIFIED IN THIS CONTRACT AS EARTH EXCAVATION.

REFER TO THE PROJECT SPECIFICATION FOR REMOVAL AND DISPOSAL OF REGULATED SUBSTANCES FOR MORE INFORMATION INCLUDING WITH REPORTS AVAILABLE TO THE CONTRACTOR PERTAINING TO MATERIALS WITHIN THE HAZARDOUS WASTE DISPOSAL AREA AND THE NON-SPECIAL WASTE DISPOSAL AREA SOIL MANAGEMENT ZONES.

1. STRUCTURAL OMMISSION 2217+58.21 TO 2221+10.00

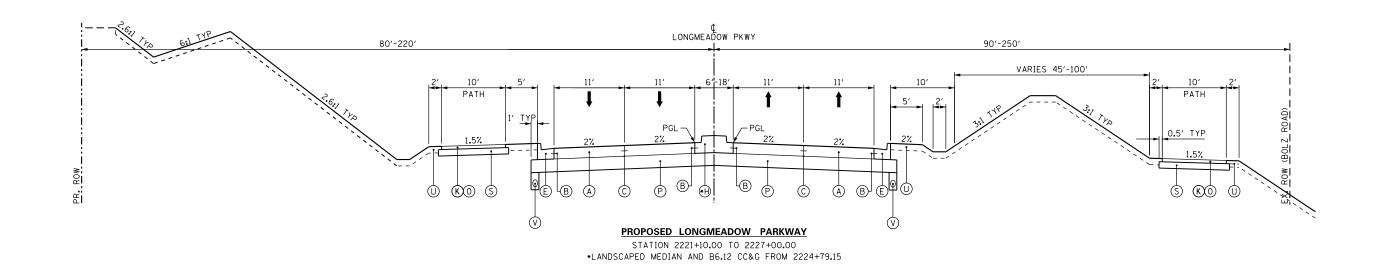

LONGMEADOW PARKWAY — PCC

STRUCTURAL DESIGN TRAFFIC	DESIGN YR	2025
	PV	16,192 VPD
	SU	1,694 VPD
	MU	941 VPD
ROAD/STREET CLASSIFICATION	CLASS I	
PERCENT OF STRUCTURE TRAFFIC	R	32%
IN DESIGN LANE	U	45%
	M	45%
TRAFFIC FACTOR	ACTUAL	8.11
	MINIMUM	5.02
PCC THICKNESS		10.0"
SUBGRADE SUPPORT RATING (SSR)		POOR

LEGEND

- PCC PAVEMENT

 (A) PORTLAND CEMENT CONCRETE PAVEMENT 10" (JOINTED)
- $\ensuremath{\textcircled{\sc B}}$ Longitudinal construction joint with tie bars according to idot std. 420001
- © SAWED LONGITUDINAL JOINT WITH TIE BARS ACCORDING TO IDOT STD. 420001
- ① COMBINATION CONCRETE CURB & GUTTER, TYPE B-6.12
- © COMBINATION CONCRETE CURB & GUTTER, TYPE B-6.24
- F COMBINATION CONCRETE CURB & GUTTER, TYPE M-4.12
- © NOT USED
- (H) CONCRETE MEDIAN, TYPE SB-6.12
- I PCC SIDEWALK 5"

HMA PAVEMENT


- ① HOT-MIX ASPHALT SURFACE COURSE, MIX "D", IL-9.5, N70 2"
- (K) HOT-MIX ASPHALT SURFACE COURSE, MIX "D", IL-9.5, N50 3"
- L HOT-MIX ASPHALT SURFACE REMOVAL, 2"
- M HOT-MIX ASPHALT BINDER COURSE, IL-19.0, N70 10"
- N NOT USED
- ① BITUMINOUS MATERIALS, PRIME COAT


AGGREGATES & ROADSIDE

- P AGGREGATE SUBGRADE IMPROVEMENT 12"
- O NOT USED
- R NOT USED
- S AGGREGATE BASE COURSE, TYPE B 6"
- T NOT USED
- U TOPSOIL FURNISH & PLACE 6", SEEDING & EROSION CONTROL 24" ON LONGMEADOW PARKWAY MEDIUMS (SEE PLAN SHEETS)
- V PIPE UNDERDRAINS, TYPE 2, 4"
- W SUBBASE GRANULAR MATERIAL, TYPE B 4"

Т	M	C		
Complete CHT I		184-000813	Heanea No.	

USER NAME = Jeff Sedig	DESIGNED - JMS/PFR	REVISED -			TYPICAL SECTIONS		F.A.U.	SECTION	COUNTY	TOTAL SHEET SHEETS NO.
	DRAWN - PFR	REVISED -	STATE OF ILLINOIS				2298	18-00215-21-BR	KANE	415 27
PLOT SCALE = 15.0000 '/ in.	CHECKED - KDF	REVISED -	DEPARTMENT OF TRANSPORTATION	LONGMEADOW PARKWAY					CONTRACT	
PLOT DATE = 3/2/2020	DATE - 01/13/2020	REVISED -		SCALE: NTS	SHEET 1 OF 4 SHEETS STA.	TO STA.		ILLINOIS FED. A	ID PROJECT	

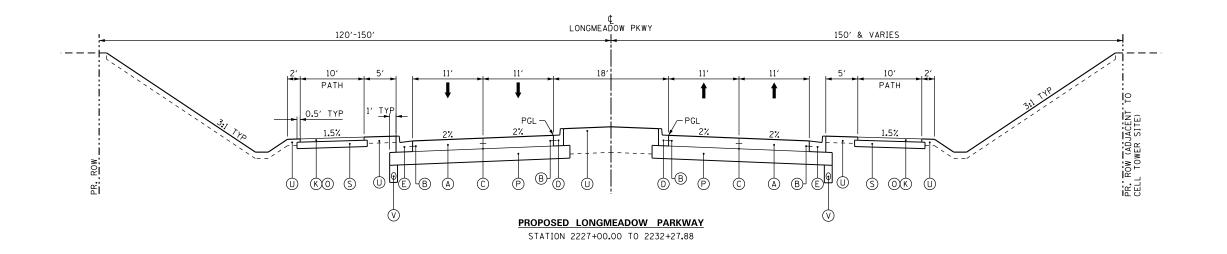

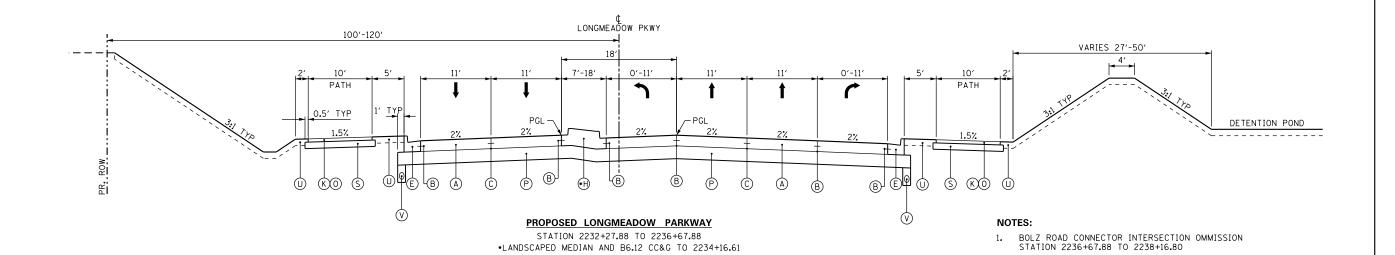

LEGEND

- PCC PAVEMENT

 (A) PORTLAND CEMENT CONCRETE PAVEMENT 10" (JOINTED)
- $\ensuremath{\textcircled{\sc B}}$ Longitudinal construction joint with tie bars according to idot std. 420001
- © SAWED LONGITUDINAL JOINT WITH TIE BARS ACCORDING TO IDOT STD. 420001
- ① COMBINATION CONCRETE CURB & GUTTER, TYPE B-6.12
- © COMBINATION CONCRETE CURB & GUTTER, TYPE B-6.24
- F COMBINATION CONCRETE CURB & GUTTER, TYPE M-4.12
- © NOT USED
- H CONCRETE MEDIAN, TYPE SB-6.12
- I PCC SIDEWALK 5"

HMA PAVEMENT


- J HOT-MIX ASPHALT SURFACE COURSE, MIX "D", IL-9.5, N70 2"
- (K) HOT-MIX ASPHALT SURFACE COURSE, MIX "D", IL-9.5, N50 3"
- L HOT-MIX ASPHALT SURFACE REMOVAL, 2"
- M HOT-MIX ASPHALT BINDER COURSE, IL-19.0, N70 10"
- N NOT USED
- ① BITUMINOUS MATERIALS, PRIME COAT


AGGREGATES & ROADSIDE

- P AGGREGATE SUBGRADE IMPROVEMENT 12"
- ① NOT USED
- R NOT USED
- S AGGREGATE BASE COURSE, TYPE B 6"
- T NOT USED
- U TOPSOIL FURNISH & PLACE 6", SEEDING & EROSION CONTROL 24" ON LONGMEADOW PARKWAY MEDIUMS (SEE PLAN SHEETS)
- V PIPE UNDERDRAINS, TYPE 2, 4"
- W SUBBASE GRANULAR MATERIAL, TYPE B 4"

EXCMT

USER NAME = Jeff Sedig	DESIGNED - JMS/PFR	REVISED -			TYPICAL SECTIONS	F.A.U.	SECTION	COUNTY	TOTAL	SHEET
	DRAWN - PFR	REVISED -	STATE OF ILLINOIS			2298	18-00215-21-BR	KANE	415	28
PLOT SCALE = 15.0000 '/ in.	CHECKED - KDF	REVISED -	DEPARTMENT OF TRANSPORTATION		LONGMEADOW PARKWAY			CONTRACT	NO. 6	51G02
PLOT DATE = 3/2/2020	DATE - 01/13/2020	REVISED -		SCALE: NTS	SHEET 2 OF 4 SHEETS STA. TO STA.		ILLINOIS FED.	ID PROJECT		

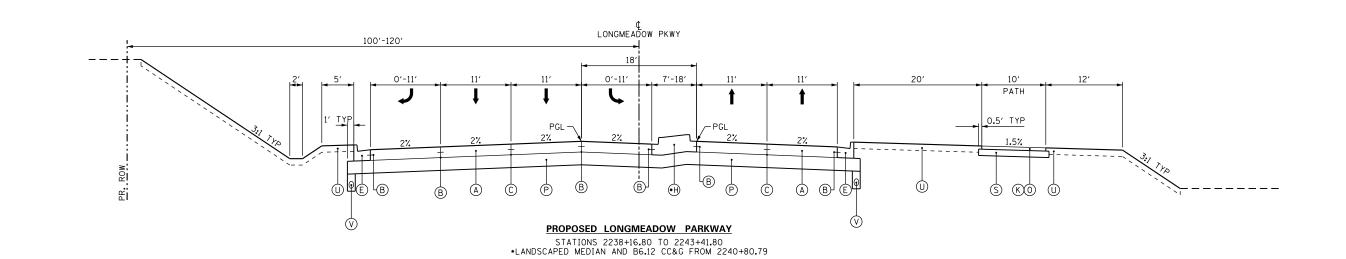

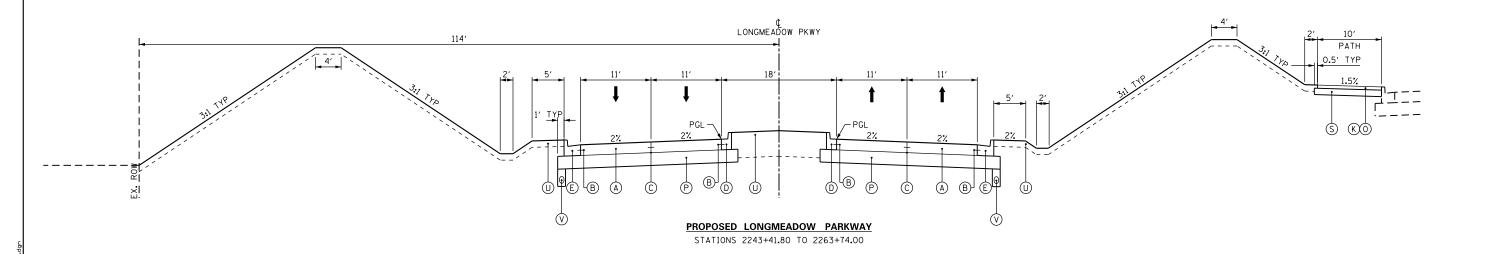

LEGEND

- PCC PAVEMENT

 (A) PORTLAND CEMENT CONCRETE PAVEMENT 10" (JOINTED)
- $\ensuremath{\textcircled{\sc B}}$ Longitudinal construction joint with tie bars according to idot std. 420001
- © SAWED LONGITUDINAL JOINT WITH TIE BARS ACCORDING TO IDOT STD. 420001
- ① COMBINATION CONCRETE CURB & GUTTER, TYPE B-6.12
- © COMBINATION CONCRETE CURB & GUTTER, TYPE B-6.24
- F COMBINATION CONCRETE CURB & GUTTER, TYPE M-4.12
- © NOT USED
- H CONCRETE MEDIAN, TYPE SB-6.12
- I PCC SIDEWALK 5"

HMA PAVEMENT


- ① HOT-MIX ASPHALT SURFACE COURSE, MIX "D", IL-9.5, N70 2"
- (K) HOT-MIX ASPHALT SURFACE COURSE, MIX "D", IL-9.5, N50 3"
- L HOT-MIX ASPHALT SURFACE REMOVAL, 2"
- M HOT-MIX ASPHALT BINDER COURSE, IL-19.0, N70 10"
- N NOT USED
- BITUMINOUS MATERIALS, PRIME COAT


AGGREGATES & ROADSIDE

- P AGGREGATE SUBGRADE IMPROVEMENT 12"
- O NOT USED
- R NOT USED
- S AGGREGATE BASE COURSE, TYPE B 6"
- T NOT USED
- U TOPSOIL FURNISH & PLACE 6", SEEDING & EROSION CONTROL 24" ON LONGMEADOW PARKWAY MEDIUMS (SEE PLAN SHEETS)
- V PIPE UNDERDRAINS, TYPE 2, 4"
- W SUBBASE GRANULAR MATERIAL, TYPE B 4"

SCMT

USER NAME = Jeff Sedig	DESIGNED - JMS/PFR	REVISED -			TYPICAL SECTIONS	F.A.U.	SECTION	COUNTY	TOTAL	SHEET
	DRAWN - PFR	REVISED -	STATE OF ILLINOIS			2298	18-00215-21-BR	KANE	415	29
PLOT SCALE = 15.0000 '/ in.	CHECKED - KDF	REVISED -	DEPARTMENT OF TRANSPORTATION		LONGMEADOW PARKWAY			CONTRACT	NO. 6	1G02
PLOT DATE = 3/2/2020	DATE - 01/13/2020	REVISED -		SCALE: NTS	SHEET 3 OF 4 SHEETS STA. TO STA.		ILLINOIS FED. A	ID PROJECT		

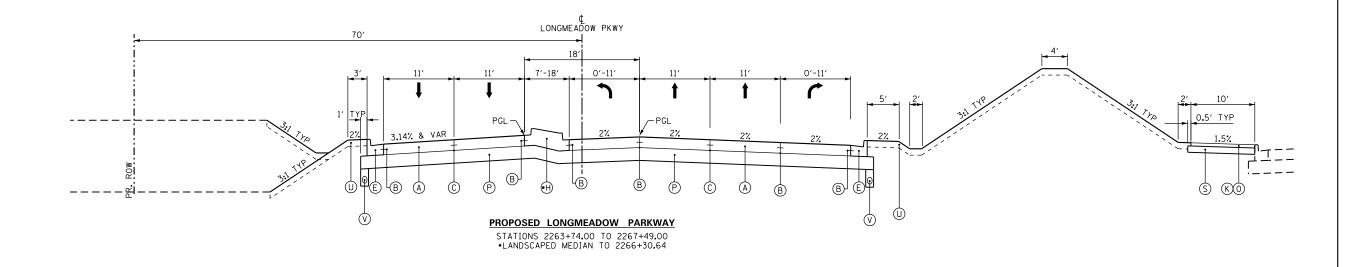

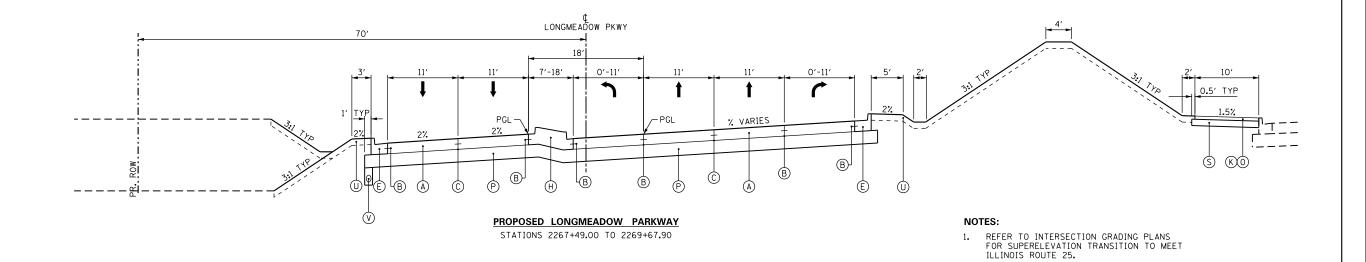

LEGEND

- PCC PAVEMENT

 (A) PORTLAND CEMENT CONCRETE PAVEMENT 10" (JOINTED)
- $\ensuremath{\textcircled{\sc B}}$ Longitudinal construction joint with tie bars according to idot std. 420001
- © SAWED LONGITUDINAL JOINT WITH TIE BARS ACCORDING TO IDOT STD. 420001
- ① COMBINATION CONCRETE CURB & GUTTER, TYPE B-6.12
- © COMBINATION CONCRETE CURB & GUTTER, TYPE B-6.24
- F COMBINATION CONCRETE CURB & GUTTER, TYPE M-4.12
- © NOT USED
- H CONCRETE MEDIAN, TYPE SB-6.12
- I PCC SIDEWALK 5"

HMA PAVEMENT

- J HOT-MIX ASPHALT SURFACE COURSE, MIX "D", IL-9.5, N70 2"
- (K) HOT-MIX ASPHALT SURFACE COURSE, MIX "D", IL-9.5, N50 3"
- L HOT-MIX ASPHALT SURFACE REMOVAL, 2"
- M HOT-MIX ASPHALT BINDER COURSE, IL-19.0, N70 10"
- N NOT USED
- ① BITUMINOUS MATERIALS, PRIME COAT

AGGREGATES & ROADSIDE

- P AGGREGATE SUBGRADE IMPROVEMENT 12"
- O NOT USED
- R NOT USED
- S AGGREGATE BASE COURSE, TYPE B 6"
- T NOT USED
- U TOPSOIL FURNISH & PLACE 6", SEEDING & EROSION CONTROL 24" ON LONGMEADOW PARKWAY MEDIUMS (SEE PLAN SHEETS)
- V PIPE UNDERDRAINS, TYPE 2, 4"
- W SUBBASE GRANULAR MATERIAL, TYPE B 4"

SCMT


USER NAME = Jeff Sedig	DESIGNED - JMS/PFR	REVISED -	TYPICAL SECTIONS			F.A.U. RTF	SECTION	COUNTY	TOTAL					
	DRAWN - PFR	REVISED -	STATE OF ILLINOIS						•	2298	18-00215-21-BR	KANE	415	30
PLOT SCALE = 15.0000 '/ in.	CHECKED - KDF	REVISED -	DEPARTMENT OF TRANSPORTATION LONGMEADOW			V PARKWAY	•			CONTRACT	NO.	61G02		
PLOT DATE = 3/2/2020	DATE - 01/13/2020	REVISED -		SCALE: NTS	SHEET 4	OF 4	SH	HEETS STA.	TO STA.		ILLINOIS FED. A	ID PROJECT		

HOT-MIX ASPHALT MIXTURE REQUIREMENTS

MIXTURE TYPE	AIR VOIDS @ Ndes	THICKNESS
HOT-MIX ASPHALT PAVEMENT (BOLZ RD. / BOLZ RD. CONNECTOR)		
HOT-MIX ASPHALT SURFACE COURSE, MIX "D", N70 (IL 9.5 mm)	4% @ 70 Gyr.	2''
HOT-MIX ASPHALT BINDER COURSE, IL-19.0, N70	4% @ 70 Gyr.	10''
HOT-MIX ASPHALT PAVEMENT (SANDBLOOM / ANGELINA PLACE)		
HOT-MIX ASPHALT SURFACE COURSE, MIX "D", N70 (IL 9.5 mm)	4% @ 70 Gyr.	2''
TEMPORARY PAVEMENT & CLASS D PATCHES, TYPE II, 10 INCH		
HOT-MIX ASPHALT SURFACE COURSE, MIX "D", N70 (IL 9.5 mm)	4% @ 70 Gyr.	2''
HOT-MIX ASPHALT BINDER COURSE, IL-19.0, N70	4% @ 70 Gyr.	8′′
MULTI-USE PATH		
HOT-MIX ASPHALT SURFACE COURSE, "MIX D", N50 (IL 9.5 mm)	4% @ 50 Gyr.	3′′
STABILIZED DRIVEWAYS 10"		
HOT-MIX ASPHALT SURFACE COURSE, MIX "D", N50 (IL 9.5 mm)	4% @ 50 Gyr.	2''
HMA BASE COURSE (HMA BINDER IL-19 mm)	4% @ 50 Gyr.	8′′
HOT-MIX ASPHALT SHOULDERS, 6"		
HOT-MIX ASPHALT SURFACE COURSE, MIX "D", N50 (IL 9.5 mm)	4% @ 50 Gyr.	2''
HMA SHOULDER (HMA BINDER IL-19.0 mm)	4% © 50 Gyr.	4′′

NOTES:


- 1. THE UNIT WEIGHT USED TO CALCULATE ALL HMA SURFACE AND HMA BINDER MIXTURE QUANTITIES IN 112 LBS/SQ YD/IN.
- 2. THE "AC TYPE" FOR POLYMERIZED HMA MIXES SHALL BE "SBS/SBR PG 76-22" AND FOR NON-POLYMERIZED HMA THE "AC TYPE" SHALL BE "PG 64-22" UNLESS MODIFIED BY DISTRICT ONE SPECIAL PROVISIONS. FOR USE OF RECYCLED MATERIALS SEE SPECIAL PROVISIONS.
- 3. PC CONCRETE TEMPORARY PAVEMENT SHALL CONSIST OF CLASS PV CONCRETE MEETING THE REQUIREMENTS OF ARTICLE 1020 OF THE STANDARD SPECIFICATIONS, PCC PAVEMENT 10". TEMPORARY PCC PAVEMENT DOES NOT REQUIRE DOWEL BARS.

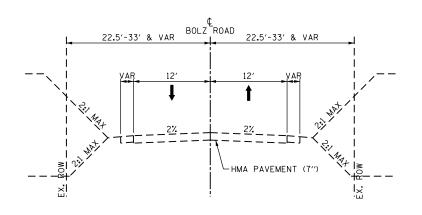

EXISTING BOLZ ROADSANDBLOOM ROAD TO WEST OF AMARILLO DRIVE

NOTES

1. EXISTING PAVEMENT COMPOSITION AND DEPTHS BASED ON PAVEMENT CORE PCC-01

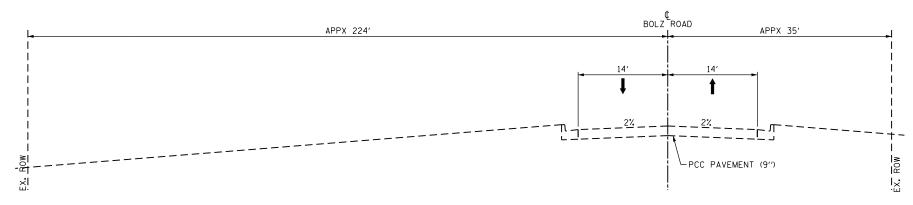

EXISTING BOLZ ROAD

WEST OF AMARILLO DRIVE TO ILLINOIS ROUTE 25

NOTES:

1. EXISTING PAVEMENT COMPOSITION AND DEPTHS BASED ON PAVEMENT CORE PCC-02

BOLZ ROAD — HMA

STRUCTURAL DESIGN TRAFFIC	DESIGN YR	2025					
	PV	6,536 VPD					
	SU	676 VPD					
	MU	301 VPD					
ROAD/STREET CLASSIFICATION	ROAD/STREET CLASSIFICATION						
PERCENT OF STRUCTURE TRAFFIC	R	100%					
IN DESIGN LANE	U	100%					
	M	100%					
TRAFFIC FACTOR	ACTUAL	1.93					
HMA GRADE THICKNESSES	SURFACE	2.0"					
	BINDER	10.0"					
SUBGRADE SUPPORT RATING (SSR)		POOR					

LEGEND

PCC PAVEMEN

- A PORTLAND CEMENT CONCRETE PAVEMENT 10" (JOINTED)
- $\ensuremath{\textcircled{\sc B}}$ Longitudinal construction joint with tie bars according to idot std. 420001
- © SAWED LONGITUDINAL JOINT WITH TIE BARS ACCORDING TO IDOT STD. 420001
- ① COMBINATION CONCRETE CURB & GUTTER, TYPE B-6.12
- (E) COMBINATION CONCRETE CURB & GUTTER, TYPE B-6.24
- F COMBINATION CONCRETE CURB & GUTTER, TYPE M-4.12
- © NOT USED
- H CONCRETE MEDIAN, TYPE SB-6.12
- 1 PCC SIDEWALK 5"

HMA PAVEMENT

- J HOT-MIX ASPHALT SURFACE COURSE, MIX "D", IL-9.5, N70 2"
- (K) HOT-MIX ASPHALT SURFACE COURSE, MIX "D", IL-9.5, N50 3"
- M HOT-MIX ASPHALT BINDER COURSE, IL-19.0, N70 10"
- N NOT USED
- BITUMINOUS MATERIALS, PRIME COAT

AGGREGATES & ROADSIDE

- P AGGREGATE SUBGRADE IMPROVEMENT 12"
- O NOT USED
- R NOT USED
- S AGGREGATE BASE COURSE, TYPE B 6"
- (T) NOT USED
- U TOPSOIL FURNISH & PLACE 6", SEEDING & EROSION CONTROL 24" ON LONGMEADOW PARKWAY MEDIUMS (SEE PLAN SHEETS)

COUNTY SHEETS NO.

KANE 415 31

CONTRACT NO. 61G02


- V PIPE UNDERDRAINS, TYPE 2, 4"
- (W) SUBBASE GRANULAR MATERIAL, TYPE B 4"


EXCMT

USER NAME = Jeff Sedig	DESIGNED -	JMS/PFR	REVISED -
	DRAWN -	PFR	REVISED -
PLOT SCALE = 15.0000 ' / in.	CHECKED -	KDF	REVISED -
PLOT DATE = 3/2/2020	DATE -	01/13/2020	REVISED -

STATE OF ILLINOIS	
DEPARTMENT OF TRANSPORTATION	

TYPICAL SECTIONS	F.A.U. RTE.	SECTI
BOLZ ROAD	2298	18-00215-
SCALE: NTS SHEET 1 OF 5 SHEETS STA. TO STA.		IL

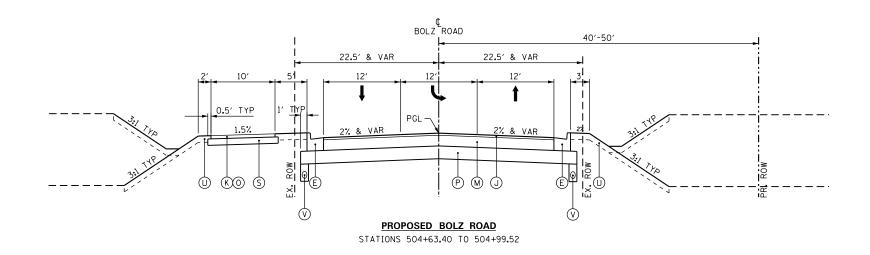

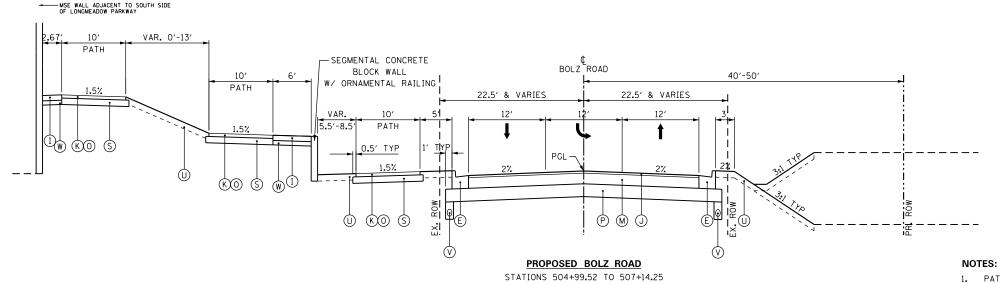

PATH TRANSITIONS FROM SWITCHBACK CONFIGURATION TO BOLZ ROAD ADJACENT CONFIGURATION BETWEEN STATIONS 505+86.85 LT TO 507+14.25 LT.

LEGEND

- A PORTLAND CEMENT CONCRETE PAVEMENT 10" (JOINTED)
- $\ensuremath{\textcircled{\sc B}}$ Longitudinal construction joint with tie bars according to idot std. 420001
- © SAWED LONGITUDINAL JOINT WITH TIE BARS ACCORDING TO IDOT STD. 420001
- ① COMBINATION CONCRETE CURB & GUTTER, TYPE B-6.12
- © COMBINATION CONCRETE CURB & GUTTER, TYPE B-6.24
- F COMBINATION CONCRETE CURB & GUTTER, TYPE M-4.12
- © NOT USED
- H CONCRETE MEDIAN, TYPE SB-6.12
- I PCC SIDEWALK 5"

HMA PAVEMENT


- J HOT-MIX ASPHALT SURFACE COURSE, MIX "D", IL-9.5, N70 2"
- (K) HOT-MIX ASPHALT SURFACE COURSE, MIX "D", IL-9.5, N50 3"
- L HOT-MIX ASPHALT SURFACE REMOVAL, 2"
- M HOT-MIX ASPHALT BINDER COURSE, IL-19.0, N70 10"
- N NOT USED
- ① BITUMINOUS MATERIALS, PRIME COAT

AGGREGATES & ROADSIDE

- P AGGREGATE SUBGRADE IMPROVEMENT 12"
- O NOT USED
- R NOT USED
- S AGGREGATE BASE COURSE, TYPE B 6"
- T NOT USED
- U TOPSOIL FURNISH & PLACE 6", SEEDING & EROSION CONTROL 24" ON LONGMEADOW PARKWAY MEDIUMS (SEE PLAN SHEETS)
- V PIPE UNDERDRAINS, TYPE 2, 4"
- W SUBBASE GRANULAR MATERIAL, TYPE B 4"

SCMT


USER NAME = Jeff Sedig	DESIGNED - JMS/PFR	REVISED -			TYPICAL	. SECTIONS		F.A.U. RTF.	SECTION	COUNTY	TOTAL	SHEET NO.
	DRAWN - PFR	REVISED -	STATE OF ILLINOIS			Z ROAD		2298	18-00215-21-BR	KANE	415	32
PLOT SCALE = 15.0000 '/ in.	CHECKED - KDF	REVISED -	DEPARTMENT OF TRANSPORTATION		DUL	Z RUAD				CONTRACT	NO. F	51G02
PLOT DATE = 3/2/2020	DATE - 01/13/2020	REVISED -		SCALE: NTS	SHEET 2 OF 5	SHEETS STA.	TO STA.		ILLINOIS FED. A	ID PROJECT		

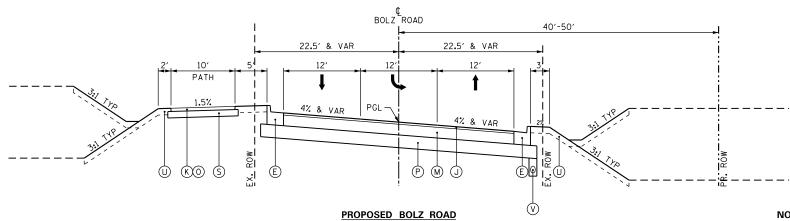

STATIONS 507+14.25 TO 510+40.43

NOTES

1. SUPERELEVATION FOR CURVE BOLZ-2 LOCATED BETWEEN STATIONS 507+94.70 TO 511+24.98. SEE TABLE ON SHEET 39

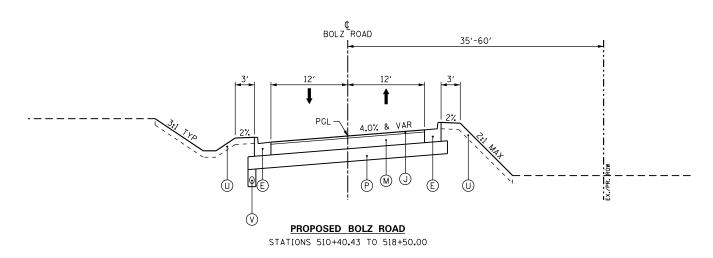

NOTES:

1. SUPERELEVATION FOR CURVE BOLZ-3 LOCATED BETWEEN STATIONS 514+00.45 TO 517+30.73. SEE TABLE ON SHEET 39

LEGEND

PCC PAVEMEN

- A PORTLAND CEMENT CONCRETE PAVEMENT 10" (JOINTED)
- $\ensuremath{\textcircled{\sc B}}$ Longitudinal construction joint with tie bars according to idot std. 420001
- © SAWED LONGITUDINAL JOINT WITH TIE BARS ACCORDING TO IDOT STD. 420001
- ① COMBINATION CONCRETE CURB & GUTTER, TYPE B-6.12
- E COMBINATION CONCRETE CURB & GUTTER, TYPE B-6.24
- F COMBINATION CONCRETE CURB & GUTTER, TYPE M-4.12
- © NOT USED
- (H) CONCRETE MEDIAN, TYPE SB-6.12
- ① PCC SIDEWALK 5"

HMA PAVEMENT


- J HOT-MIX ASPHALT SURFACE COURSE, MIX "D", IL-9.5, N70 2"
- (K) HOT-MIX ASPHALT SURFACE COURSE, MIX "D", IL-9.5, N50 3"
- L HOT-MIX ASPHALT SURFACE REMOVAL, 2"
- M HOT-MIX ASPHALT BINDER COURSE, IL-19.0, N70 10"
- N NOT USED
- ① BITUMINOUS MATERIALS, PRIME COAT

AGGREGATES & ROADSIDE

- P AGGREGATE SUBGRADE IMPROVEMENT 12"
- O NOT USED
- R NOT USED
- S AGGREGATE BASE COURSE, TYPE B 6"
- T NOT USED
- U TOPSOIL FURNISH & PLACE 6", SEEDING & EROSION CONTROL 24" ON LONGMEADOW PARKWAY MEDIUMS (SEE PLAN SHEETS)
- V PIPE UNDERDRAINS, TYPE 2, 4"
- W SUBBASE GRANULAR MATERIAL, TYPE B 4"


N CM	1T
Hoense No. 184-000613	Committee CMT Inc.

USER NAME = Jeff Sedig	DESIGNED - JMS/PFR	REVISED -				TVPI	CAL SE	CTIONS		F.A.U.	SECTION	COUNTY	TOTAL S	HEET
	DRAWN - PFR	REVISED -	STATE OF ILLINOIS	BOLZ ROAD					2298	18-00215-21-BR	KANE	415	33	
PLOT SCALE = 15.0000 '/ in.	CHECKED - KDF	REVISED -	DEPARTMENT OF TRANSPORTATION				OLZ K	UAD				CONTRACT	NO. 61	G02
PLOT DATE = 3/2/2020	DATE - 01/13/2020	REVISED -		SCALE: NTS	SHEET 3	0F 5	SHEE	TS STA.	TO STA.		ILLINOIS FED. A	ID PROJECT		

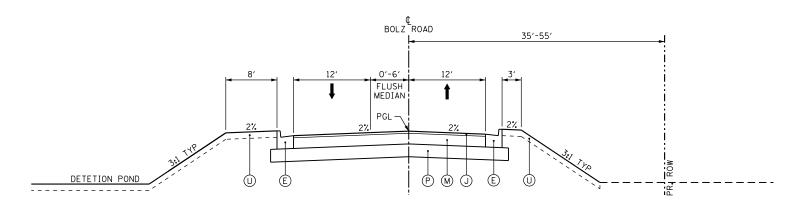

PROPOSED BOLZ ROAD

STATIONS 518+50.00 TO 521+86.32

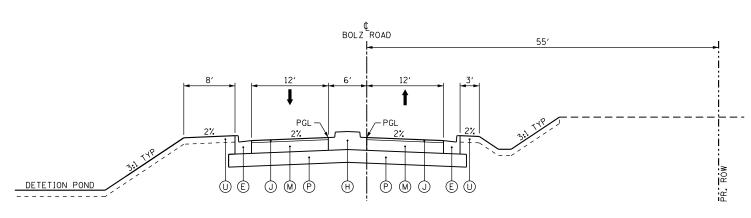

PROPOSED BOLZ ROAD

STATIONS 521+86.32 TO 522+81.19

NOTES:

1. ROUNDABOUT OMMISSION FROM STATION 522+81.19 TO 525+62.17

LEGEND

- PCC PAVEMENT

 (A) PORTLAND CEMENT CONCRETE PAVEMENT 10" (JOINTED)
- $\ensuremath{\textcircled{\sc B}}$ Longitudinal construction joint with tie bars according to idot std. 420001
- © SAWED LONGITUDINAL JOINT WITH TIE BARS ACCORDING TO IDOT STD. 420001
- ① COMBINATION CONCRETE CURB & GUTTER, TYPE B-6.12
- © COMBINATION CONCRETE CURB & GUTTER, TYPE B-6.24
- F COMBINATION CONCRETE CURB & GUTTER, TYPE M-4.12
- © NOT USED
- (H) CONCRETE MEDIAN, TYPE SB-6.12
- I PCC SIDEWALK 5"

HMA PAVEMENT

- J HOT-MIX ASPHALT SURFACE COURSE, MIX "D", IL-9.5, N70 2"
- (K) HOT-MIX ASPHALT SURFACE COURSE, MIX "D", IL-9.5, N50 3"
- L HOT-MIX ASPHALT SURFACE REMOVAL, 2"
- M HOT-MIX ASPHALT BINDER COURSE, IL-19.0, N70 10"
- N NOT USED
- ① BITUMINOUS MATERIALS, PRIME COAT

AGGREGATES & ROADSIDE


- P AGGREGATE SUBGRADE IMPROVEMENT 12"
- ① NOT USED
- R NOT USED
- S AGGREGATE BASE COURSE, TYPE B 6"
- T NOT USED
- U TOPSOIL FURNISH & PLACE 6", SEEDING & EROSION CONTROL 24" ON LONGMEADOW PARKWAY MEDIUMS (SEE PLAN SHEETS)
- V PIPE UNDERDRAINS, TYPE 2, 4"
- W SUBBASE GRANULAR MATERIAL, TYPE B 4"

EXCMT

USER NAME = Jeff Sedig	DESIGNED	-	JMS/PFR	REVISED -
	DRAWN	-	PFR	REVISED -
PLOT SCALE = 15.0000 '/ in.	CHECKED	-	KDF	REVISED -
PLOT DATE = 3/2/2020	DATE	-	01/13/2020	REVISED -

STATE OF ILLINOIS	
DEPARTMENT OF TRANSPORTATION	


TYPICAL SECTIONS											
BOLZ ROAD											
BULZ NUAD											
SCALE: NTS	SHEET 4	0F 5	SHEETS	STA.	TO STA.						

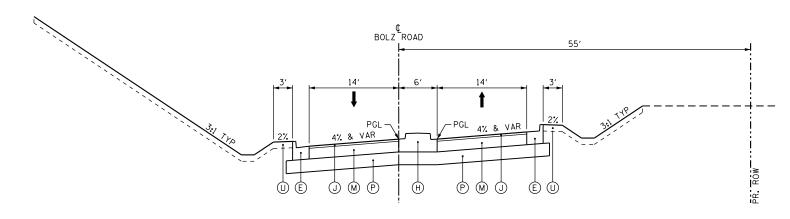

PROPOSED BOLZ ROAD

STATIONS 525+62.17 TO 526+67.89

1. SUPERELEVATION FOR CURVE BOLZ-4 LOCATED BETWEEN STATIONS 524+32.36 TO 528+03.47. SEE TABLE ON SHEET 39

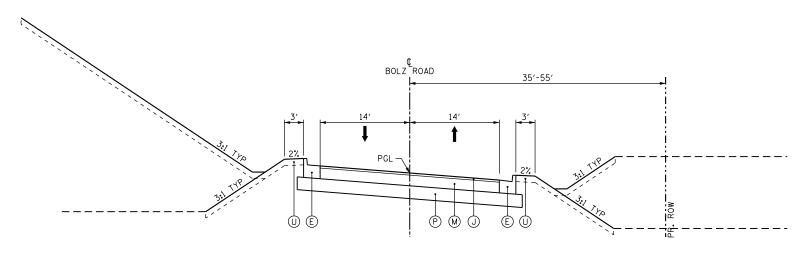

PROPOSED BOLZ ROAD

STATIONS 526+67.89 TO 532+50.00

SUPERELEVATION FOR CURVE BOLZ-5 LOCATED BETWEEN STATIONS 529+06.25 TO 532+75.28. SEE TABLE ON SHEET 39

LEGEND

- A PORTLAND CEMENT CONCRETE PAVEMENT 10" (JOINTED)
- $\ensuremath{\textcircled{\sc B}}$ Longitudinal construction joint with tie bars according to idot std. 420001
- © SAWED LONGITUDINAL JOINT WITH TIE BARS ACCORDING TO IDOT STD. 420001
- ① COMBINATION CONCRETE CURB & GUTTER, TYPE B-6.12
- © COMBINATION CONCRETE CURB & GUTTER, TYPE B-6.24
- F COMBINATION CONCRETE CURB & GUTTER, TYPE M-4.12
- © NOT USED
- H CONCRETE MEDIAN, TYPE SB-6.12
- I PCC SIDEWALK 5"

HMA PAVEMENT

- ① HOT-MIX ASPHALT SURFACE COURSE, MIX "D", IL-9.5, N70 2"
- (K) HOT-MIX ASPHALT SURFACE COURSE, MIX "D", IL-9.5, N50 3"
- L HOT-MIX ASPHALT SURFACE REMOVAL, 2"
- M HOT-MIX ASPHALT BINDER COURSE, IL-19.0, N70 10"
- N NOT USED
- ① BITUMINOUS MATERIALS, PRIME COAT

AGGREGATES & ROADSIDE

- P AGGREGATE SUBGRADE IMPROVEMENT 12"
- O NOT USED
- R NOT USED
- S AGGREGATE BASE COURSE, TYPE B 6"
- T NOT USED
- U TOPSOIL FURNISH & PLACE 6", SEEDING & EROSION CONTROL 24" ON LONGMEADOW PARKWAY MEDIUMS (SEE PLAN SHEETS)
- V PIPE UNDERDRAINS, TYPE 2, 4"
- W SUBBASE GRANULAR MATERIAL, TYPE B 4"


EXCMT


USER NAME = Jeff Sedig	DESIGNED	=	JMS/PFR	REVISED -		
	DRAWN	-	PFR	REVISED -		STATE OF ILLIN
PLOT SCALE = 15.0000 '/ in.	CHECKED	-	KDF	REVISED -		DEPARTMENT OF TRANS
PLOT DATE = 3/2/2020	DATE	-	01/13/2020	REVISED -		
	PLOT SCALE = 15.0000 '/ in.	DRAWN PLOT SCALE = 15.0000 '/ in. CHECKED	DRAWN - PLOT SCALE = 15.0000 '/ in. CHECKED -	DRAWN - PFR PLOT SCALE = 15.0000 '/ in. CHECKED - KDF	DRAWN - PFR REVISED - PLOT SCALE = 15,0000 '/ in. CHECKED - KDF REVISED -	DRAWN - PFR

STATE OI	F ILLINOIS
DEPARTMENT OF	TRANSPORTATION

TYPICAL SECTIONS BOLZ ROAD										
SHEET 5 OF 5 SHEETS STA. TO STA.										

F.A.U. RTE.	SECTION	COUNTY	TOTAL SHEETS	SHEET NO.
2298	18-00215-21-BR	KANE	415	35
		CONTRACT	NO. 6	31G02

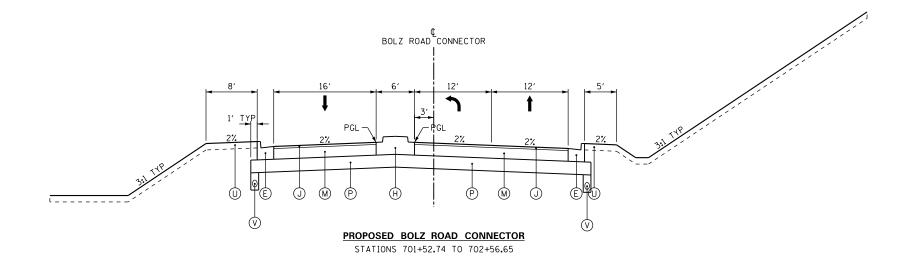

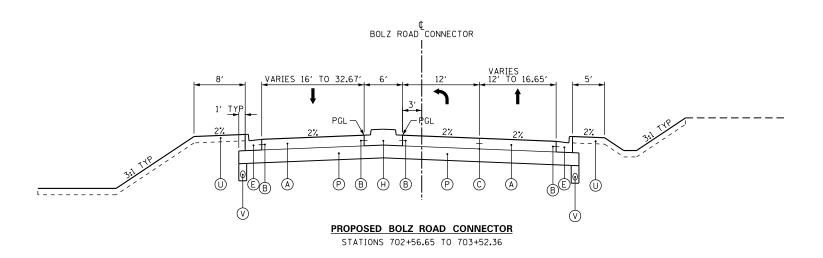

BOLZ ROAD CONNECTOR — PCC AND HMA

GIVEN THE RELATIVE SHORT DISTANCE OF BOLZ ROAD CONNECTOR, THE PAVEMENT DESIGN IS EXTENDED FROM ADJACENT ROADWAYS. FOR PCC DESIGN, SEE THE LONGMEADOW PARKWAY PAVEMENT DESIGN. FOR HMA DESIGN, SEE THE BOLZ ROAD PAVEMENT DESIGN

LEGEND

PCC PAVEMENT

- A PORTLAND CEMENT CONCRETE PAVEMENT 10" (JOINTED)
- (B) LONGITUDINAL CONSTRUCTION JOINT WITH TIE BARS ACCORDING TO IDOT STD. 420001
- © SAWED LONGITUDINAL JOINT WITH TIE BARS ACCORDING TO IDOT STD. 420001
- ① COMBINATION CONCRETE CURB & GUTTER, TYPE B-6.12
- © COMBINATION CONCRETE CURB & GUTTER, TYPE B-6.24
- F COMBINATION CONCRETE CURB & GUTTER, TYPE M-4.12
- © NOT USED
- (H) CONCRETE MEDIAN, TYPE SB-6.12
- 1 PCC SIDEWALK 5"

HMA PAVEMENT

- J HOT-MIX ASPHALT SURFACE COURSE, MIX "D", IL-9.5, N70 2"
- (K) HOT-MIX ASPHALT SURFACE COURSE, MIX "D", IL-9.5, N50 3"

SCALE: NTS

- L HOT-MIX ASPHALT SURFACE REMOVAL, 2"
- M HOT-MIX ASPHALT BINDER COURSE, IL-19.0, N70 10"
- N NOT USED
- ① BITUMINOUS MATERIALS, PRIME COAT

AGGREGATES & ROADSIDE

- P AGGREGATE SUBGRADE IMPROVEMENT 12"
- O NOT USED
- R NOT USED
- S AGGREGATE BASE COURSE, TYPE B 6"
- T NOT USED
- U TOPSOIL FURNISH & PLACE 6", SEEDING & EROSION CONTROL 24" ON LONGMEADOW PARKWAY MEDIUMS (SEE PLAN SHEETS)
- V PIPE UNDERDRAINS, TYPE 2, 4"

TO STA.

W SUBBASE GRANULAR MATERIAL, TYPE B 4"

≥ CMT

USER NAME = Jeff Sedig	DESIGNED	-	JMS/PFR	REVISED -	
	DRAWN	-	PFR	REVISED -	
PLOT SCALE = 15.0000 '/ in.	CHECKED	-	KDF	REVISED -	
PLOT DATE = 3/2/2020	DATE	-	01/13/2020	REVISED -	


STATE OF ILLINOIS DEPARTMENT OF TRANSPORTATION TYPICAL SECTIONS
BOLZ ROAD CONNECTOR

SHEET 1 OF 2 SHEETS STA.

F.A.U. SECTION COUNTY TOTAL SHEETS NO.

2298 18-00215-21-BR KANE 415 36

CONTRACT NO. 61G02

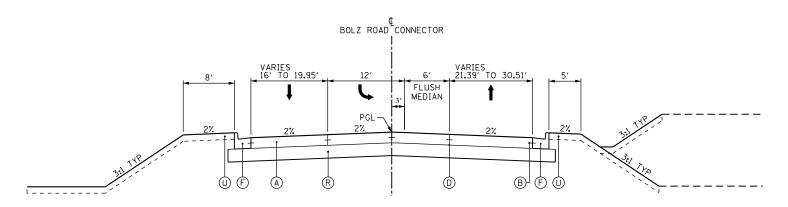

PROPOSED BOLZ ROAD CONNECTOR

STATIONS 704+89.77 TO 705+15.36

LEGEND

- PCC PAVEMENT

 (A) PORTLAND CEMENT CONCRETE PAVEMENT 10" (JOINTED)
- $\ensuremath{\textcircled{\sc B}}$ Longitudinal construction joint with tie bars according to idot std. 420001
- © SAWED LONGITUDINAL JOINT WITH TIE BARS ACCORDING TO IDOT STD. 420001
- ① COMBINATION CONCRETE CURB & GUTTER, TYPE B-6.12
- © COMBINATION CONCRETE CURB & GUTTER, TYPE B-6.24
- F COMBINATION CONCRETE CURB & GUTTER, TYPE M-4.12
- © NOT USED
- (H) CONCRETE MEDIAN, TYPE SB-6.12
- I PCC SIDEWALK 5"

HMA PAVEMENT


- ① HOT-MIX ASPHALT SURFACE COURSE, MIX "D", IL-9.5, N70 2"
- (K) HOT-MIX ASPHALT SURFACE COURSE, MIX "D", IL-9.5, N50 3"
- L HOT-MIX ASPHALT SURFACE REMOVAL, 2"
- M HOT-MIX ASPHALT BINDER COURSE, IL-19.0, N70 10"
- N NOT USED
- BITUMINOUS MATERIALS, PRIME COAT

AGGREGATES & ROADSIDE


- P AGGREGATE SUBGRADE IMPROVEMENT 12"
- O NOT USED
- R NOT USED
- S AGGREGATE BASE COURSE, TYPE B 6"
- T NOT USED
- U TOPSOIL FURNISH & PLACE 6", SEEDING & EROSION CONTROL 24" ON LONGMEADOW PARKWAY MEDIUMS (SEE PLAN SHEETS)
- V PIPE UNDERDRAINS, TYPE 2, 4"
- W SUBBASE GRANULAR MATERIAL, TYPE B 4"

2 CMT

USER NAME = Jeff Sedig	DESIGNED - JMS/PFR	REVISED -		TYPICAL SECTIONS	F.A.U. RTF.	SECTION	COUNTY	TOTAL SHEET
	DRAWN - PFR	REVISED -	STATE OF ILLINOIS	BOLZ ROAD CONNECTOR	 	00215-21-BR	KANE	415 37
PLOT SCALE = 15.0000 '/ in.	CHECKED - KDF	REVISED -	DEPARTMENT OF TRANSPORTATION	BULZ NUAD CUNNECTUR	<u> </u>		CONTRACT	NO. 61G02
PLOT DATE = 3/2/2020	DATE - 01/13/2020	REVISED -		SCALE: NTS SHEET 2 OF 2 SHEETS STA. TO STA.		ILLINOIS FED. A	AID PROJECT	

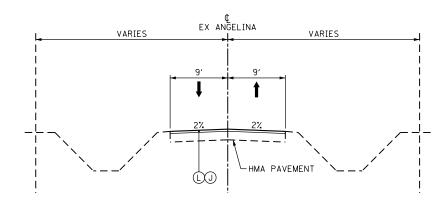

ANGELNA PLACE STATION 2215+07.32 (LONGMEADOW) TO SANDBLOOM WEST EOP

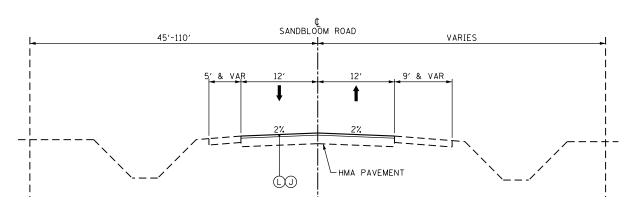

SANDBLOOM ROAD STATIONS 904+11.47 TO 906+79.93

LEGEND

- PCC PAVEMENT

 (A) PORTLAND CEMENT CONCRETE PAVEMENT 10" (JOINTED)
- $\ensuremath{\textcircled{\sc B}}$ Longitudinal construction joint with tie bars according to idot std. 420001
- © SAWED LONGITUDINAL JOINT WITH TIE BARS ACCORDING TO IDOT STD. 420001
- ① COMBINATION CONCRETE CURB & GUTTER, TYPE B-6.12
- © COMBINATION CONCRETE CURB & GUTTER, TYPE B-6.24
- F COMBINATION CONCRETE CURB & GUTTER, TYPE M-4.12
- © NOT USED
- (H) CONCRETE MEDIAN, TYPE SB-6.12
- I PCC SIDEWALK 5"

HMA PAVEMENT

- ① HOT-MIX ASPHALT SURFACE COURSE, MIX "D", IL-9.5, N70 2"
- (K) HOT-MIX ASPHALT SURFACE COURSE, MIX "D", IL-9.5, N50 3"
- L HOT-MIX ASPHALT SURFACE REMOVAL, 2"
- M HOT-MIX ASPHALT BINDER COURSE, IL-19.0, N70 10"
- N NOT USED
- ① BITUMINOUS MATERIALS, PRIME COAT

AGGREGATES & ROADSIDE

- P AGGREGATE SUBGRADE IMPROVEMENT 12"
- O NOT USED
- R NOT USED
- S AGGREGATE BASE COURSE, TYPE B 6"
- T NOT USED
- U TOPSOIL FURNISH & PLACE 6", SEEDING & EROSION CONTROL 24" ON LONGMEADOW PARKWAY MEDIUMS (SEE PLAN SHEETS)
- V PIPE UNDERDRAINS, TYPE 2, 4"
- W SUBBASE GRANULAR MATERIAL, TYPE B 4"

ZICMT

USER NAME = Jeff Sedig	DESIGNED -	JMS/PFR	REVISED -			
	DRAWN -	PFR	REVISED -	STATE OF ILLINOIS		
PLOT SCALE = 15.0000 '/ in.	CHECKED -	KDF	REVISED -	DEPARTMENT OF TRANSPORTATION		4
PLOT DATE = 3/2/2020	DATE -	01/13/2020	REVISED -		SCALE: NTS	SH

	TYPI	CAL SEC	TIONS		F.A.U. RTE.	SECTIO	N	COUNTY	TOTAL SHEETS	SHEET NO.
ANGELINA PLACE /SANDBLOOM ROAD						18-00215-2	21-BR	KANE	415	38
ANGLLINA	1 FL/-	IUL / JAI	DDLUUIN	NUAD			С	ONTRACT	NO. 6	51G02
SHEET 1	OF 1	SHEET:	STA.	TO STA.		ILLINOIS FED. AID PROJECT				


		W	ESTBOUND LANE	S		Е	ASTBOUND LANE	S
CURVE BOLZ-3		OUTER EOP ELEVATION	LANE WIDTH	CROSS SLOPE	CENTERLINE ELEVATION	CROSS SLOPE	LANE WIDTH	OUTER EOP ELEVATION
NORMAL CROWN	514+00.45	800.61	12.00′	-2.00%	800.85	-2.00%	12.00′	800.61
RUNOFF/RUNOUT	514+37.45	803.20	12.00′	-2.00%	803.44	0.00%	12.00′	803.44
	514+50.00	804.07	12.00′	-2.00%	804.31	0.69%	12.00′	804.39
REMOVE CROWN	514+73.95	805.75	12.00′	-2.00%	805.99	2.00%	12.00′	806.23
PC (BOLZ-3)	514+86.36	806.54	12.00′	-2.68%	806.86	2.68%	12.00′	807.18
	515+00.00	807.40	12.00′	-3.43%	807.81	3.43%	12.00′	808.22
FULL SUPER	515+10.45	808.06	12.00′	-4.00%	808.54	4.00%	12.00′	809.02
	515+50.00	810.59	12.00′	-4.00%	811.07	4.00%	12.00′	811.55
	516+00.00	813.36	12.00′	-4.00%	813.84	4.00%	12.00′	814.32
FULL SUPER	516+20.73	814.36	12.00′	-4.00%	814.84	4.00%	12.00′	815.32
PT (BOLZ-3)	516+44.82	815.58	12.00′	-2.68%	815.90	2.68%	12.00′	816.22
	516+50.00	815.82	12.00′	-2.40%	816.11	2.40%	12.00′	816.40
REMOVE CROWN	516+57.23	816.16	12.00′	-2.00%	816.40	2.00%	12.00′	816.64
RUNOFF/RUNOUT	516+93.73	817.13	12.00′	-2.00%	817.37	0.00%	12.00′	817.37
	517+00.00	817.66	12.00′	-2.00%	817.90	-0.34%	12.00′	817.86
NORMAL CROWN	517+30.73	818.52	12.00′	-2.00%	818.76	-2.00%	12.00′	818.52


		W	ESTBOUND LANE	S		E	ASTBOUND LANE	S
CURVES BOLZ-4 & B	OLZ-5	OUTER EOP ELEVATION	LANE WIDTH	CROSS SLOPE	CENTERLINE ELEVATION	CROSS SLOPE	LANE WIDTH	OUTER EOP ELEVATION
MATCH RAB GRADES	526+67.89	822.73	14.00′	-4.00%	823.29	4.00%	20.01′	824.09
	527+00.00	823.74	14.00′	-4.00%	824.30	4.00%	18.59′	825.04
	527+50.00	825.73	14.00′	-4.00%	826.29	4.00%	16.36′	826.94
FULL SUPER	527+69.86	826.66	14.00′	-4.00%	827.22	4.00%	15.48′	827.84
	528+00.00	828.30	14.00′	-3.36%	828.77	3.36%	14.16′	829.25
PT (BOLZ-4)	528+03.47	828.50	14.00′	-3.28%	828.96	3.28%	14.00′	829.42
	528+50.00	831.18	14.00′	-2.29%	831.50	2.29%	14.00′	831.82
REVERSE CURVATURE	528+54.86	831.76	14.00′	0.00%	831.76	0.00%	14.00'	831.76
	529+00.00	834.53	14.00′	2.12%	834.23	-2.12%	14.00′	833.93
PC (BOLZ-5)	529+06.25	834.91	14.00′	2.42%	834.57	-2.42%	14.00′	834.23
FULL SUPER	529+39.86	836.96	14.00′	4.00%	836.40	-4.00%	14.00′	835.84
	529+50.00	837.51	14.00′	4.00%	836.95	-4.00%	14.00′	836.39
	530+00.00	840.24	14.00′	4.00%	839.68	-4.00%	14.00'	839.12
	530+50.00	842.97	14.00′	4.00%	842.41	-4.00%	14.00′	841.85
	531+00.00	845.70	14.00′	4.00%	845.14	-4.00%	14.00′	844.58
FULL SUPER	531+47.28	848.28	14.00'	4.00%	847.72	-4.00%	14.00'	847.16
	531+50.00	848.40	14.00′	3.81%	847.87	-3.81%	14.00'	847.34
PT (BOLZ-5)	531+75.33	849.58	14.00′	2.00%	849.30	-2.00%	14.00'	849.02
REMOVE CROWN	531+89.78	850.42	14.00′	2.00%	850.14	-2.00%	14.00'	849.86
	532+00.00	850.96	14.00′	1.52%	850.75	-2.00%	14.00'	850.47
RUNOFF/RUNOUT	532+32.28	852.75	14.00′	0.00%	852.75	-2.00%	14.00'	852.47
	532+50.00	853.76	14.00′	-0.82%	853.88	-2.00%	14.00'	853.60
NORMAL CROWN	532+75.28	855.21	14.00′	-2.00%	855.49	-2.00%	14.00′	855.21


NC	MT
Hoense No. 184-000613	Committee CMT Inc


USER NAME = Jeff Sedig	DESIGNED	-	PFR	REVISED -
	DRAWN	-	PFR	REVISED -
PLOT SCALE = 2.0000 '/ in.	CHECKED	-	KDF	REVISED -
PLOT DATE = 3/2/2020	DATE	-	01/13/2020	REVISED -

I	SUPERELEVATION TABLES							SECTION	COUNTY	TOTAL SHEETS	SHEET NO.
I								2298 18-00215-21-BR KANE		415	39
ļ									CONTRACT	NO.	61G02
	SCALE: NTS SHEET 1 OF 1 SHEETS STA. TO STA.						ILLINOIS FED. AI	D PROJECT			

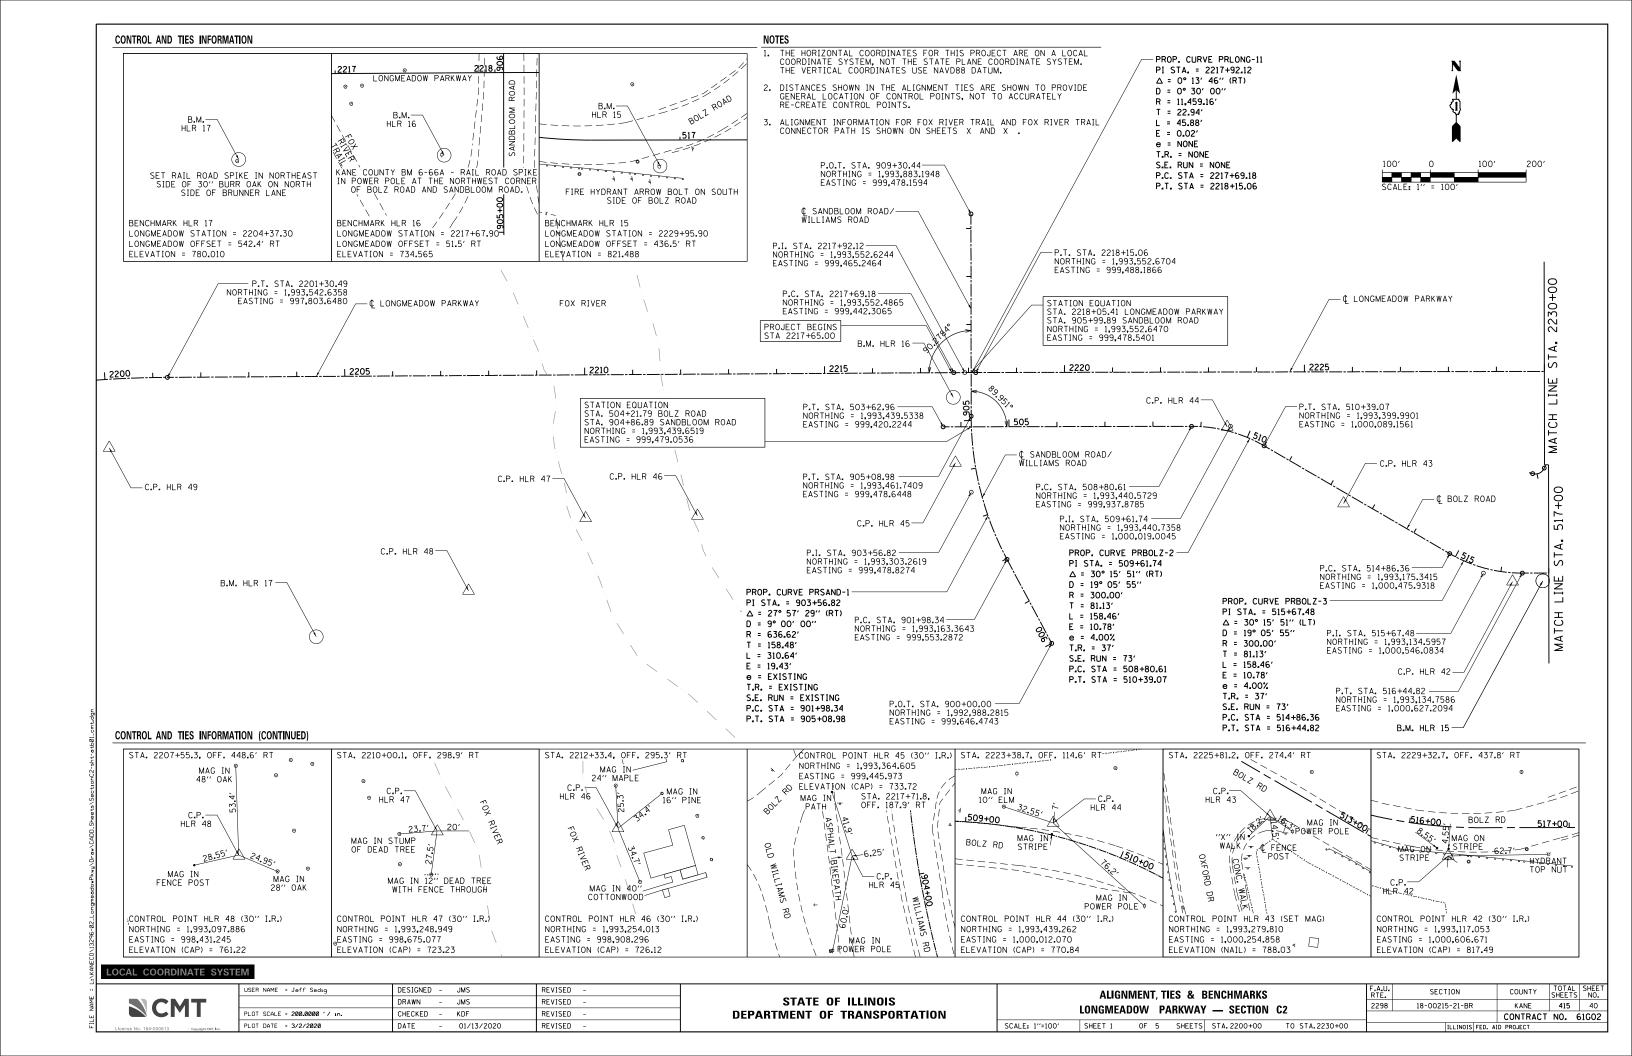


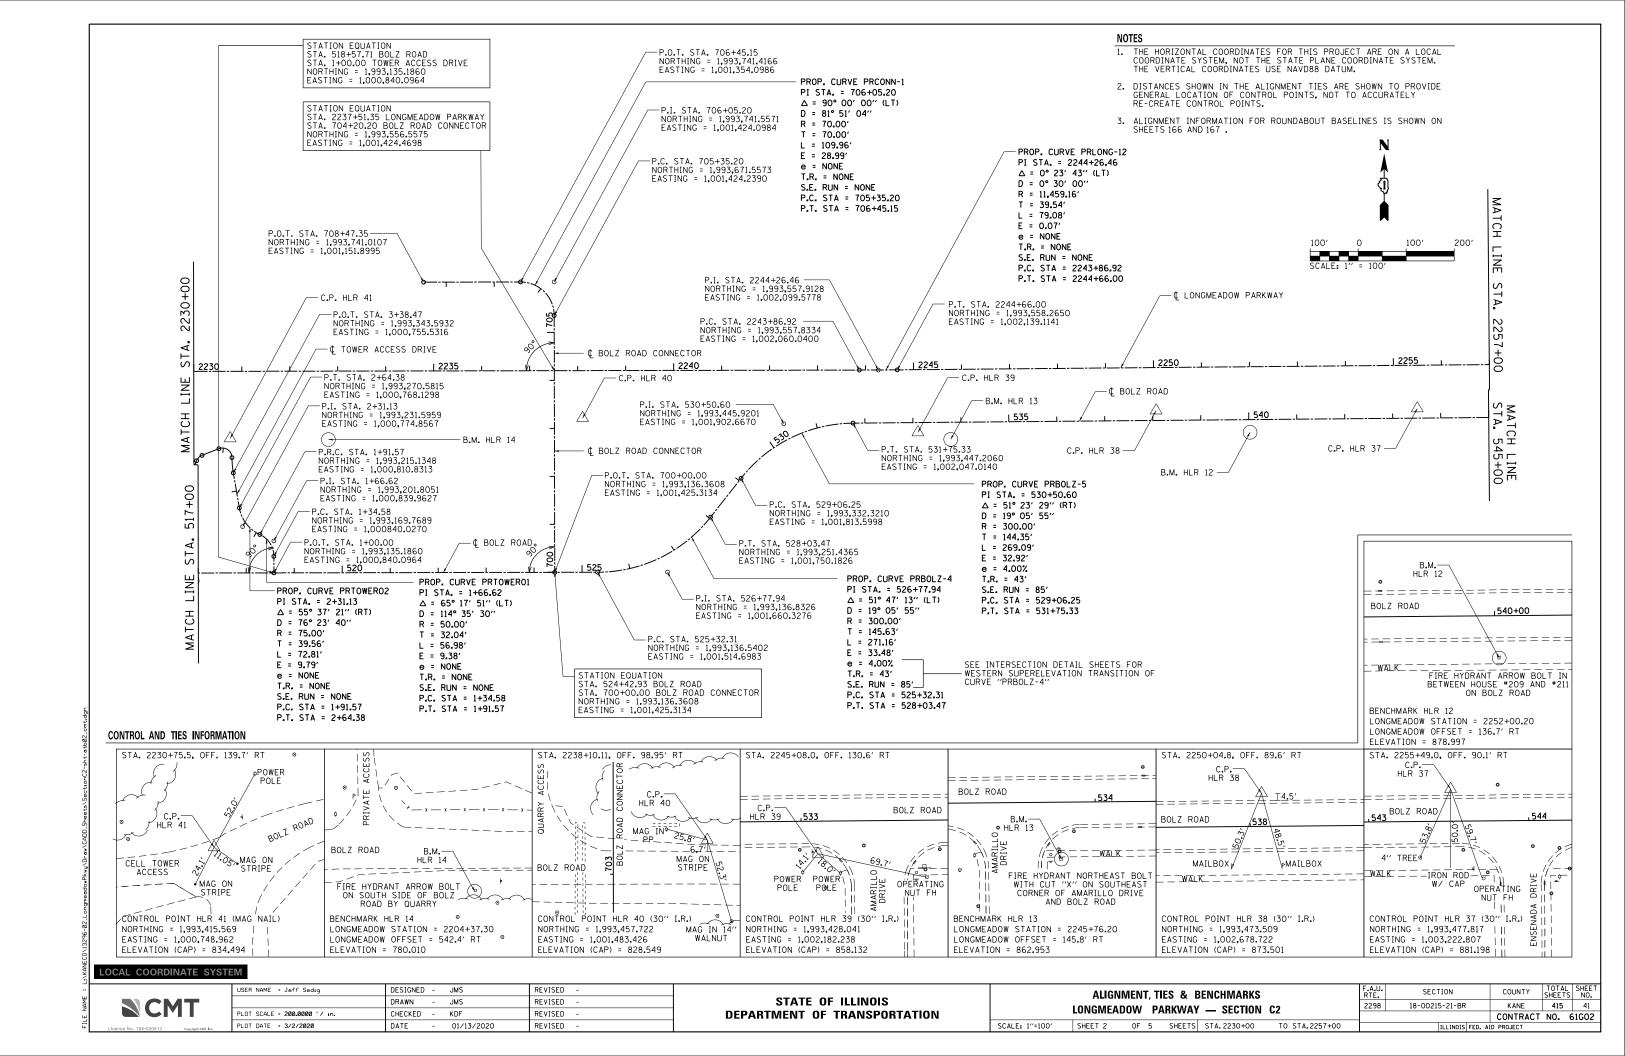


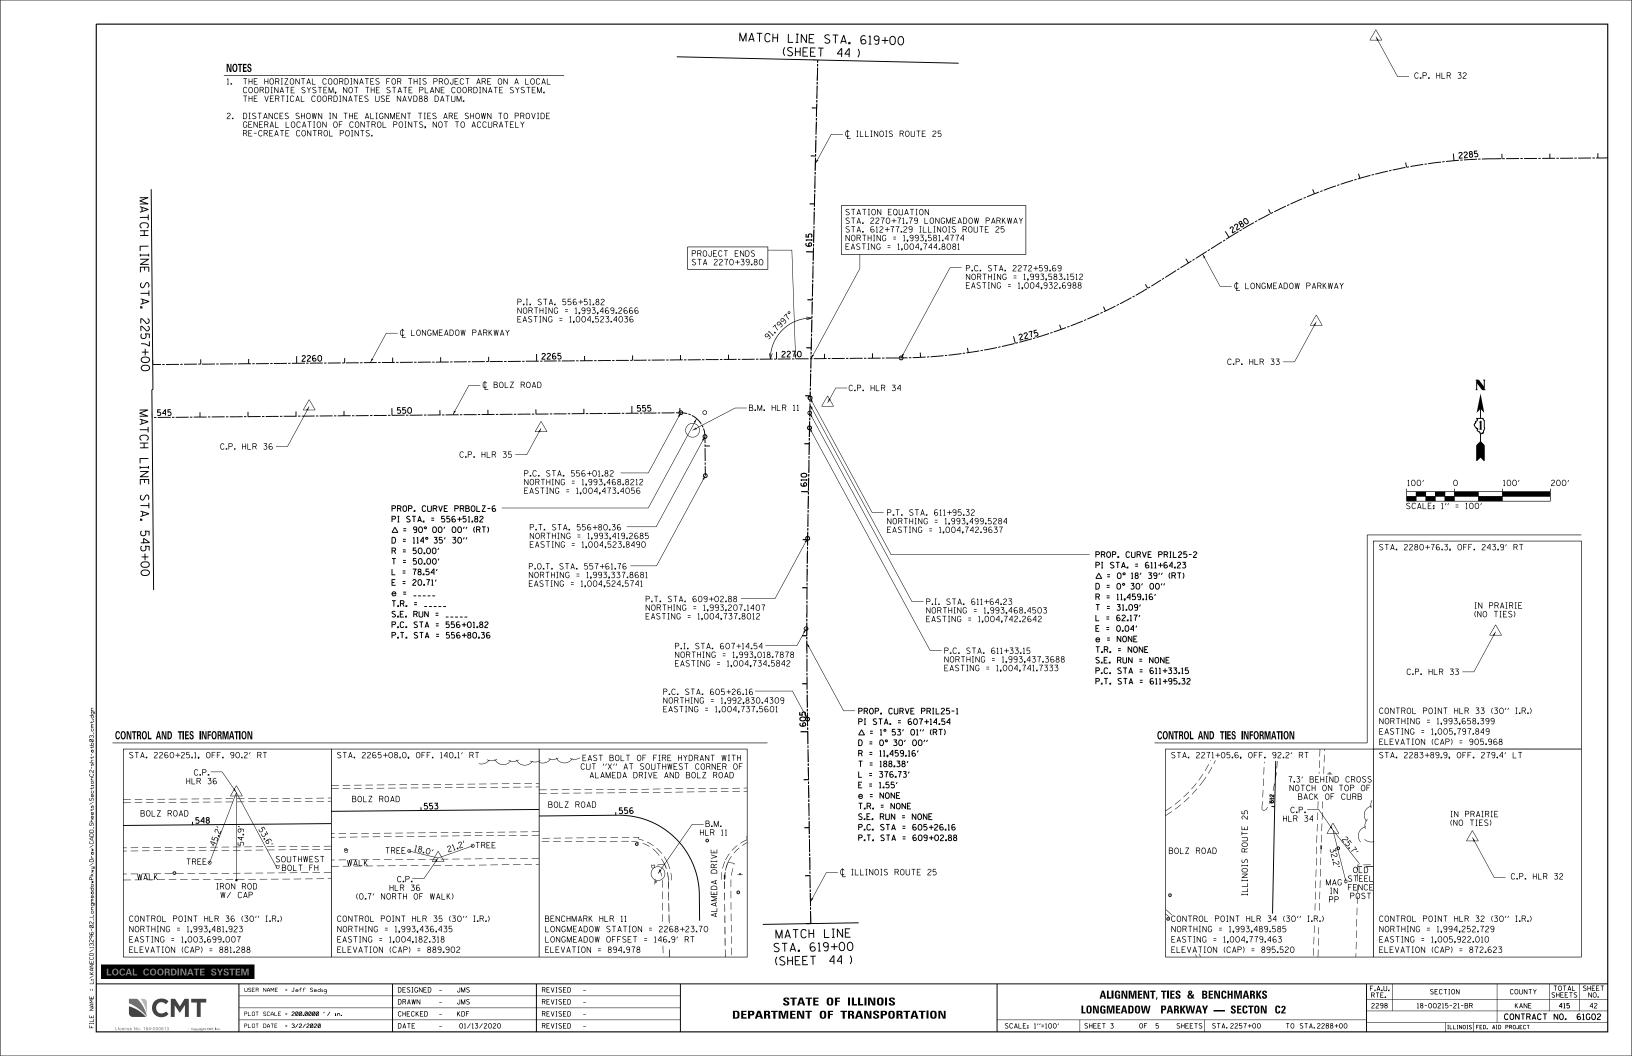

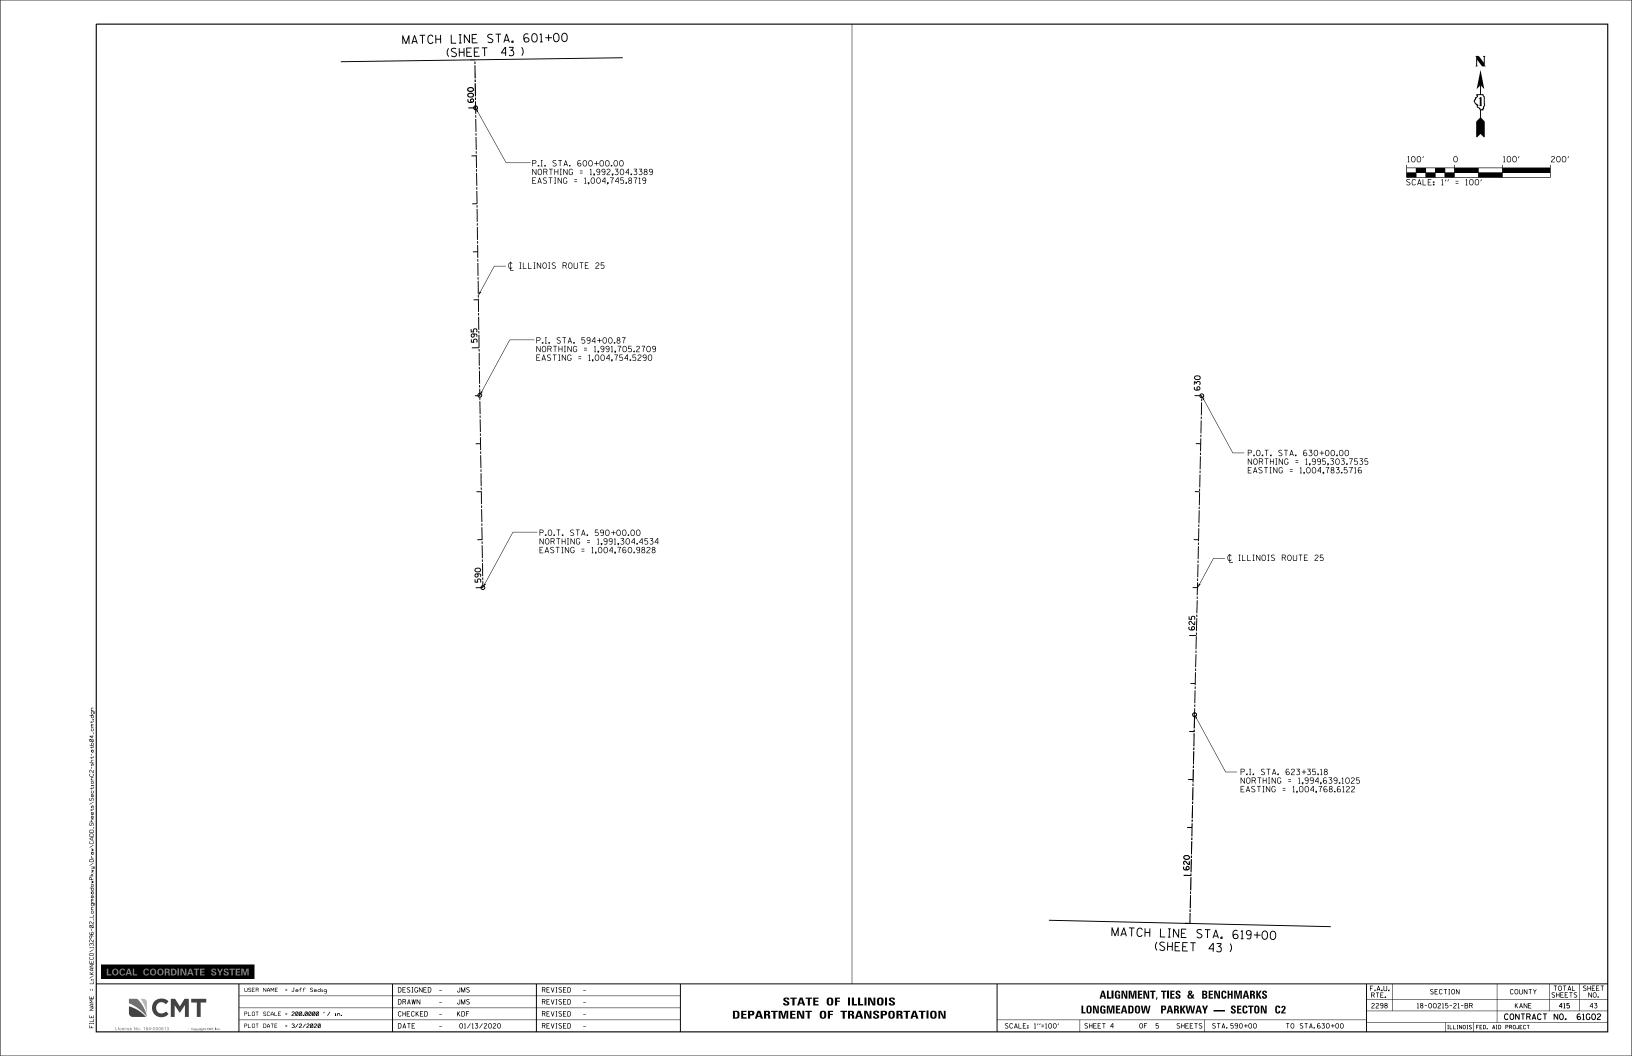

STATION EQUATION STA. 2230+83.45 DETENTION POND STA. 3+29.77 TOWER ACCESS DRIVE NORTHING = 1,993,335,0196 EASTING = 1,001,757,0110 STATION EQUATION STA. 2237+51.35 DETENTION POND STA. 702+00.00 BOLZ ROAD CONNECTOR NORTHING = 1,993,336.3604 EASTING = 1,001,424.9119 STATION EQUATION STA. 2237+51.35 EMBANKMENT HILL STA. 703+40.20 BOLZ ROAD CONNECTOR NORTHING = 1,993,476.5517 EASTING = 1,001,425.6304

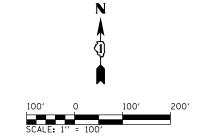

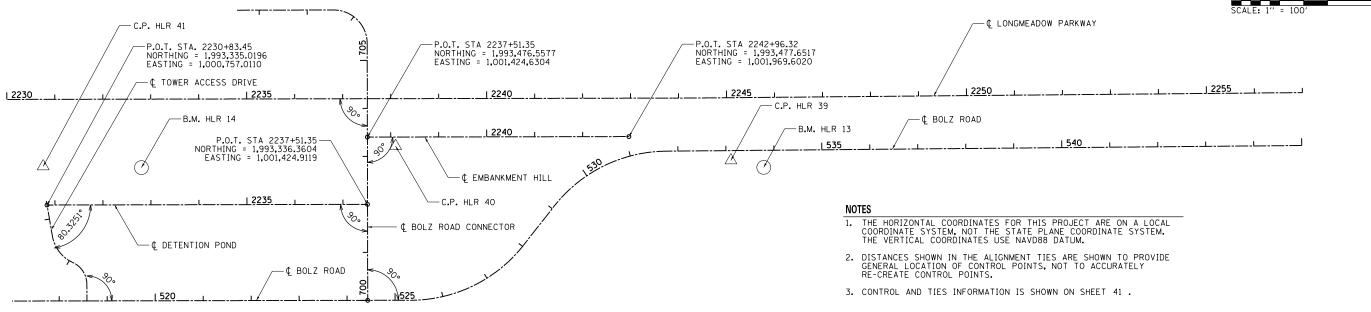

LOCAL COORDINATE SYSTEM





USER NAME = Jeff Sedig	DESIGNED	-	JMS	REVISED -
	DRAWN	-	JMS	REVISED -
PLOT SCALE = 200.0000 '/ in.	CHECKED	-	KDF	REVISED -
PLOT DATE = 3/2/2020	DATE	-	01/13/2020	REVISED -


STATE OF ILLINOIS
DEPARTMENT OF TRANSPORTATION


ALIGNMENT, TIES & BENCHMARKS										
LONGMEADOW PARKWAY — SECTION C2										
SCALE: 1"=100"	SHEET 5	OF	5	SHEETS	STA. 2230+00	TO STA.2288+00				


F.A.U. RTE.	SECTION	COUNTY	TOTAL SHEETS	SHEE NO.
2298	18-00215-21-BR	KANE	415	44
		CONTRACT	NO. 6	1G0
	ILLINOIS FED. A	D PROJECT		

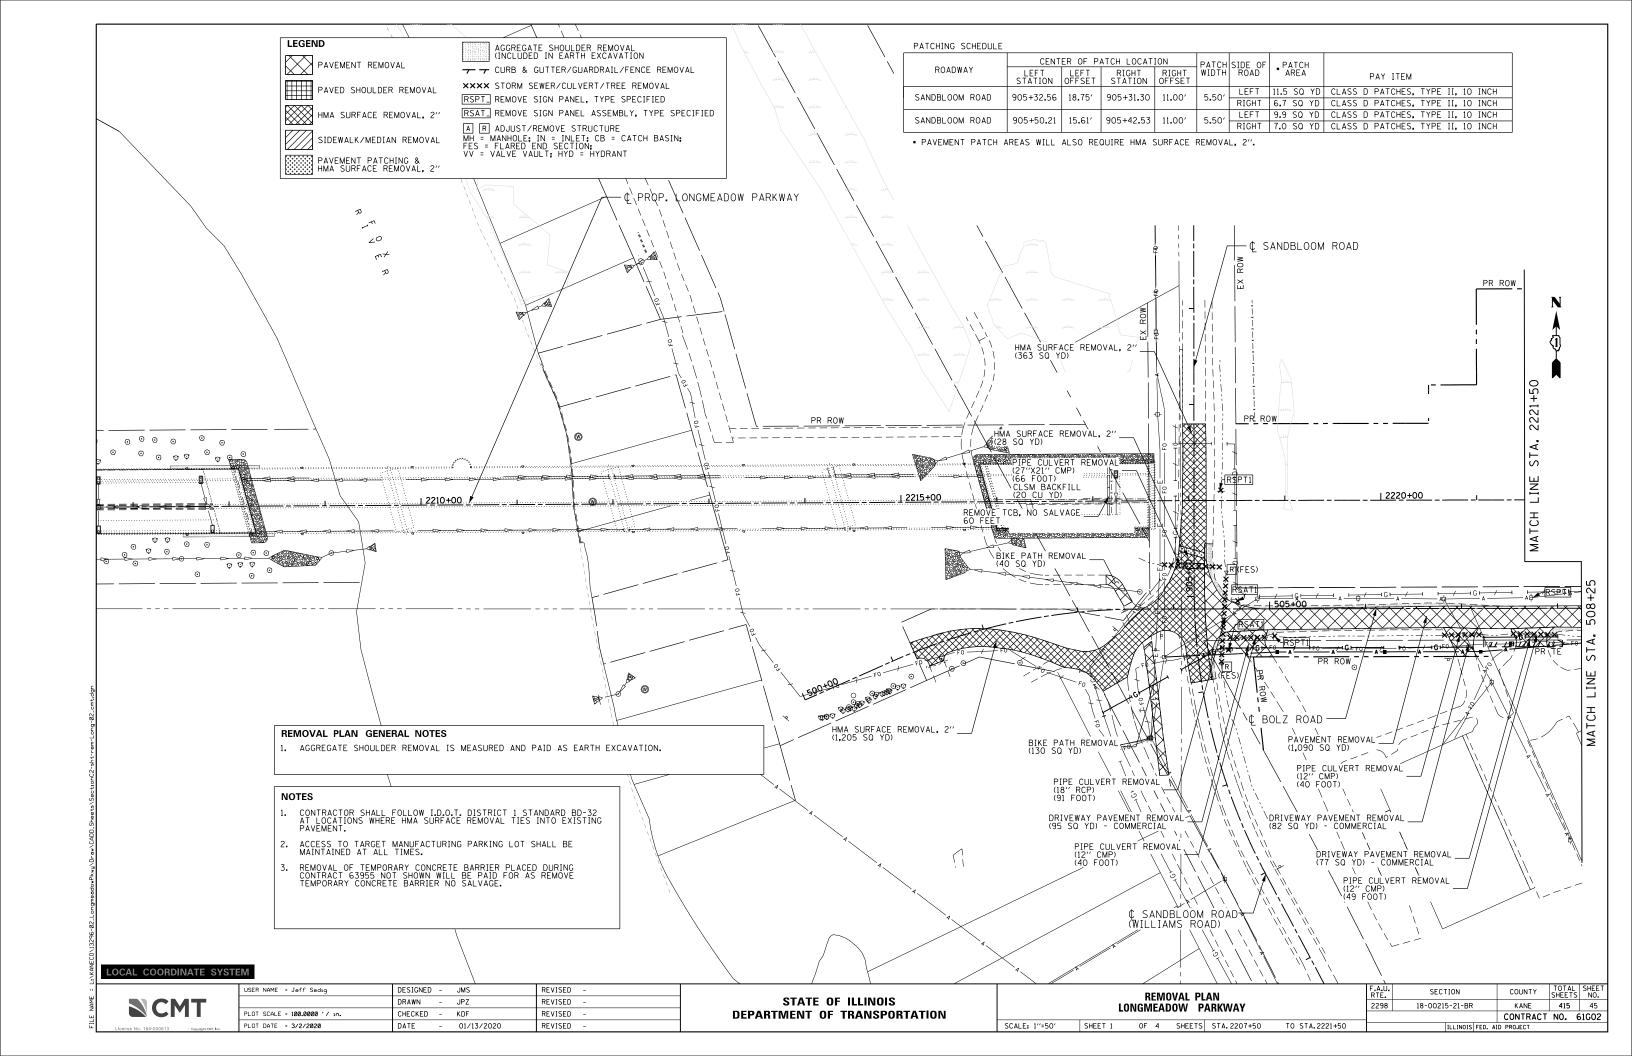


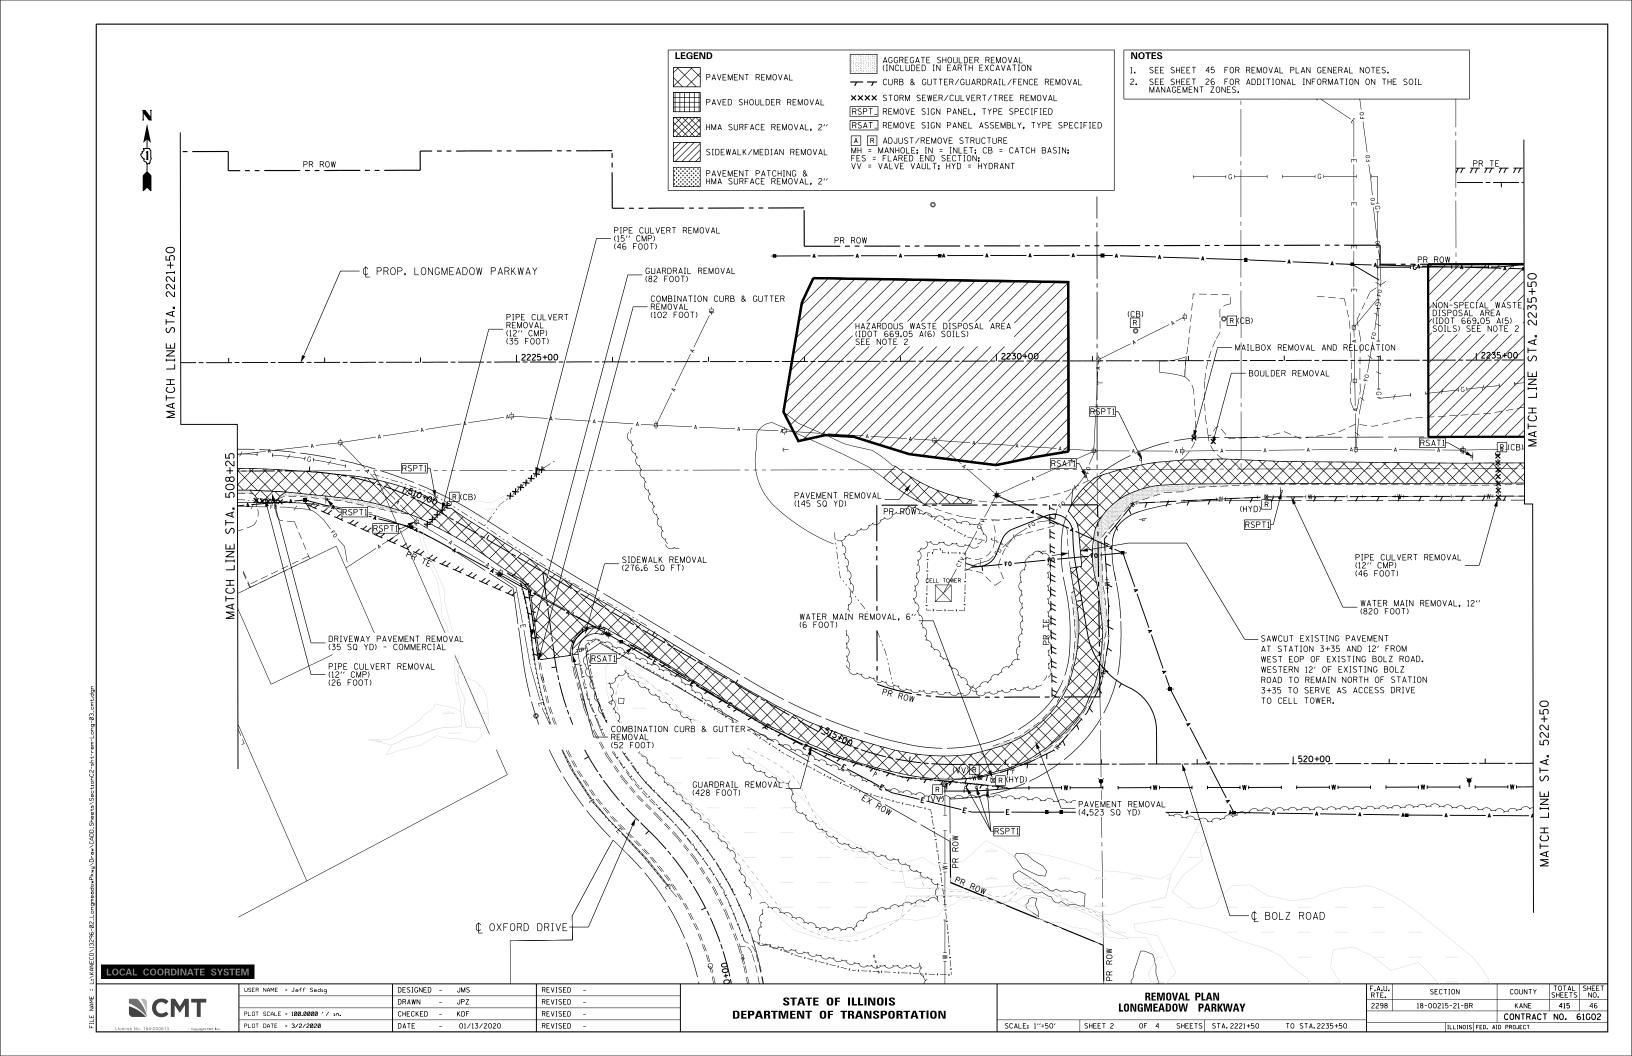


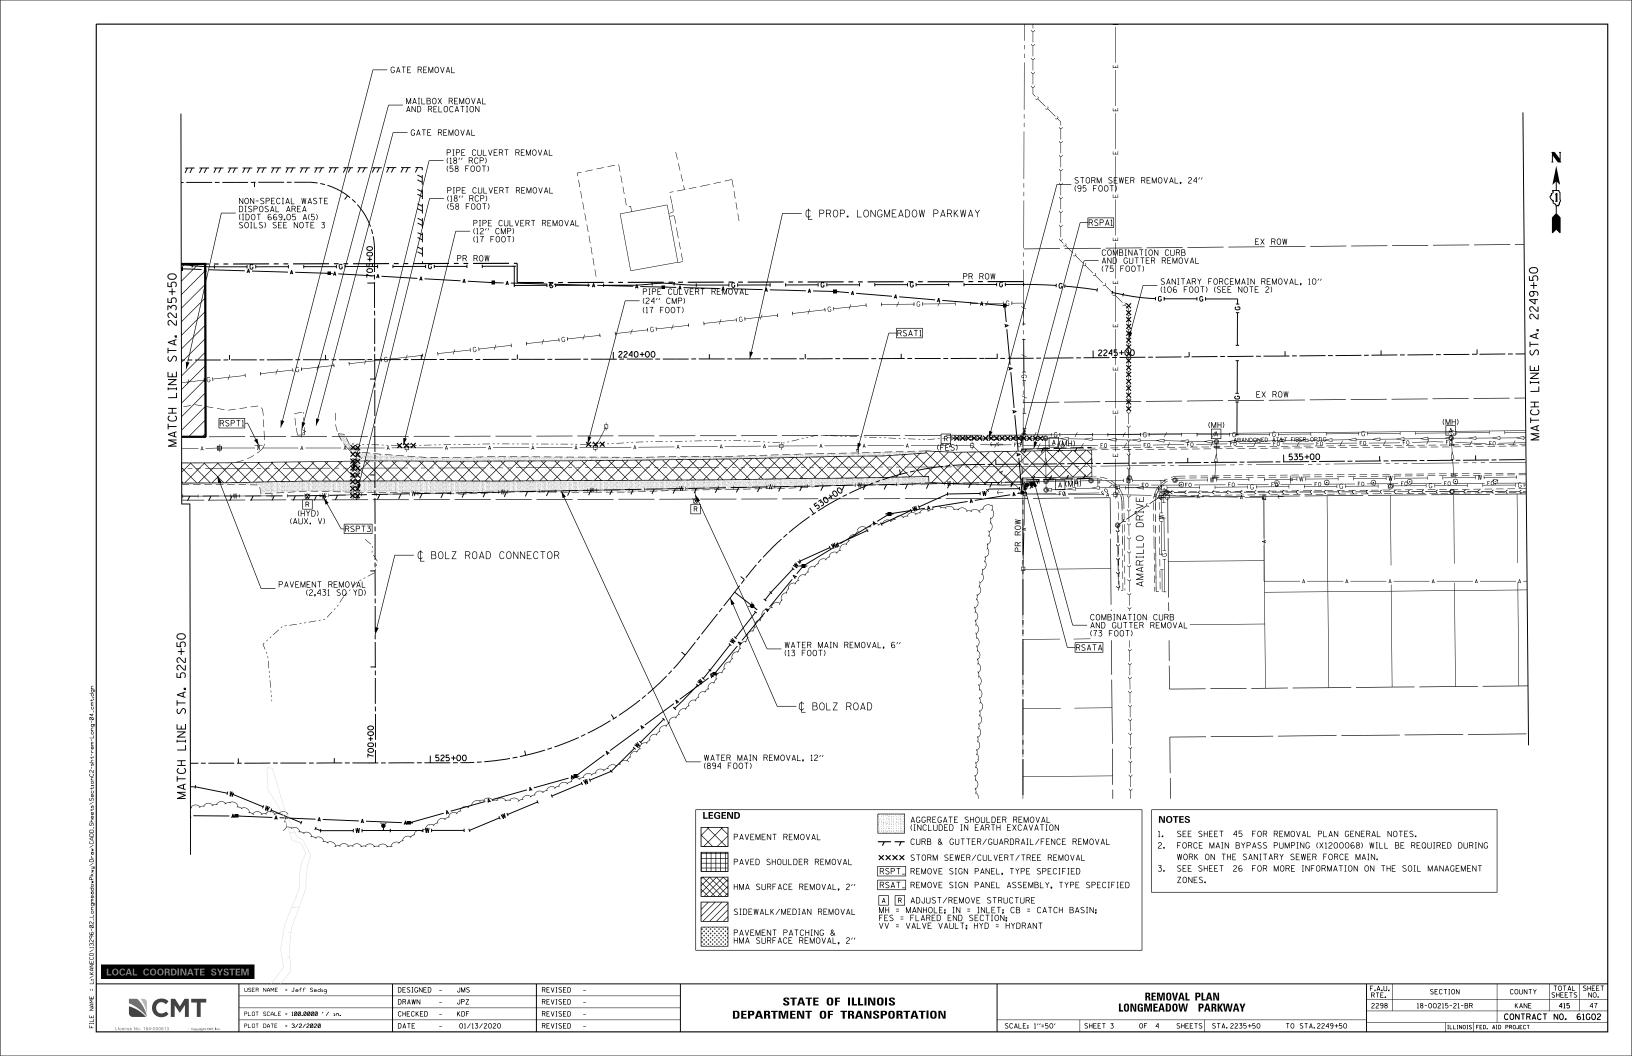


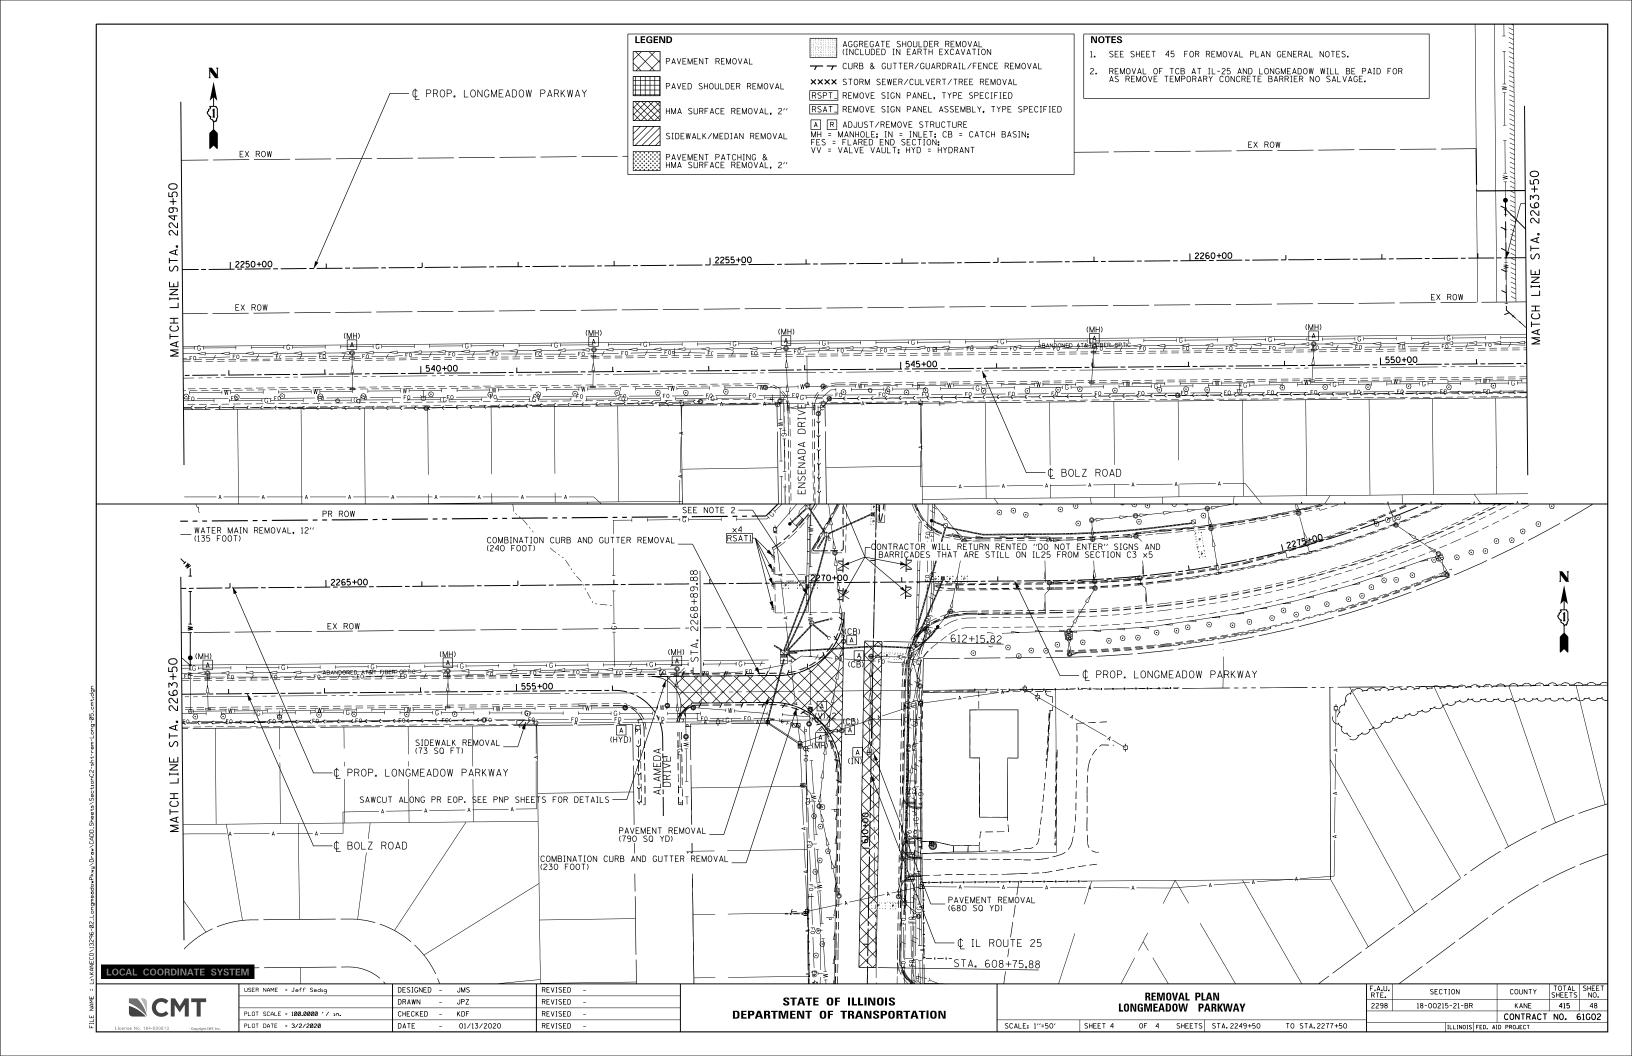


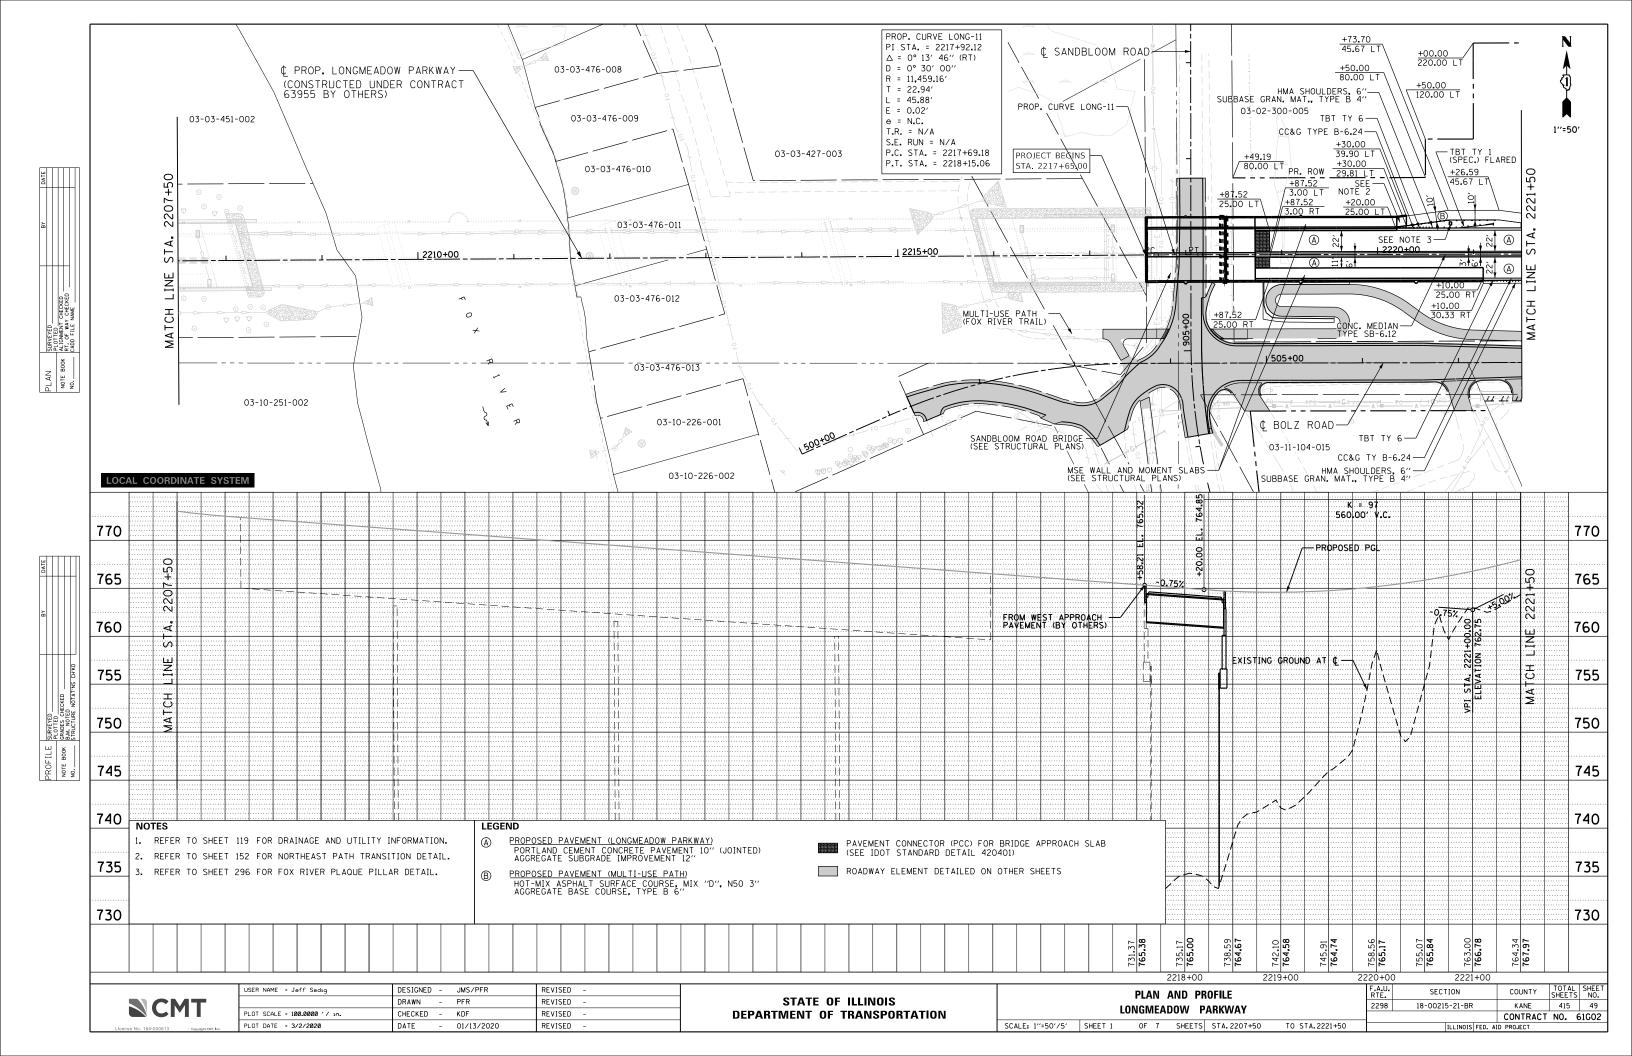


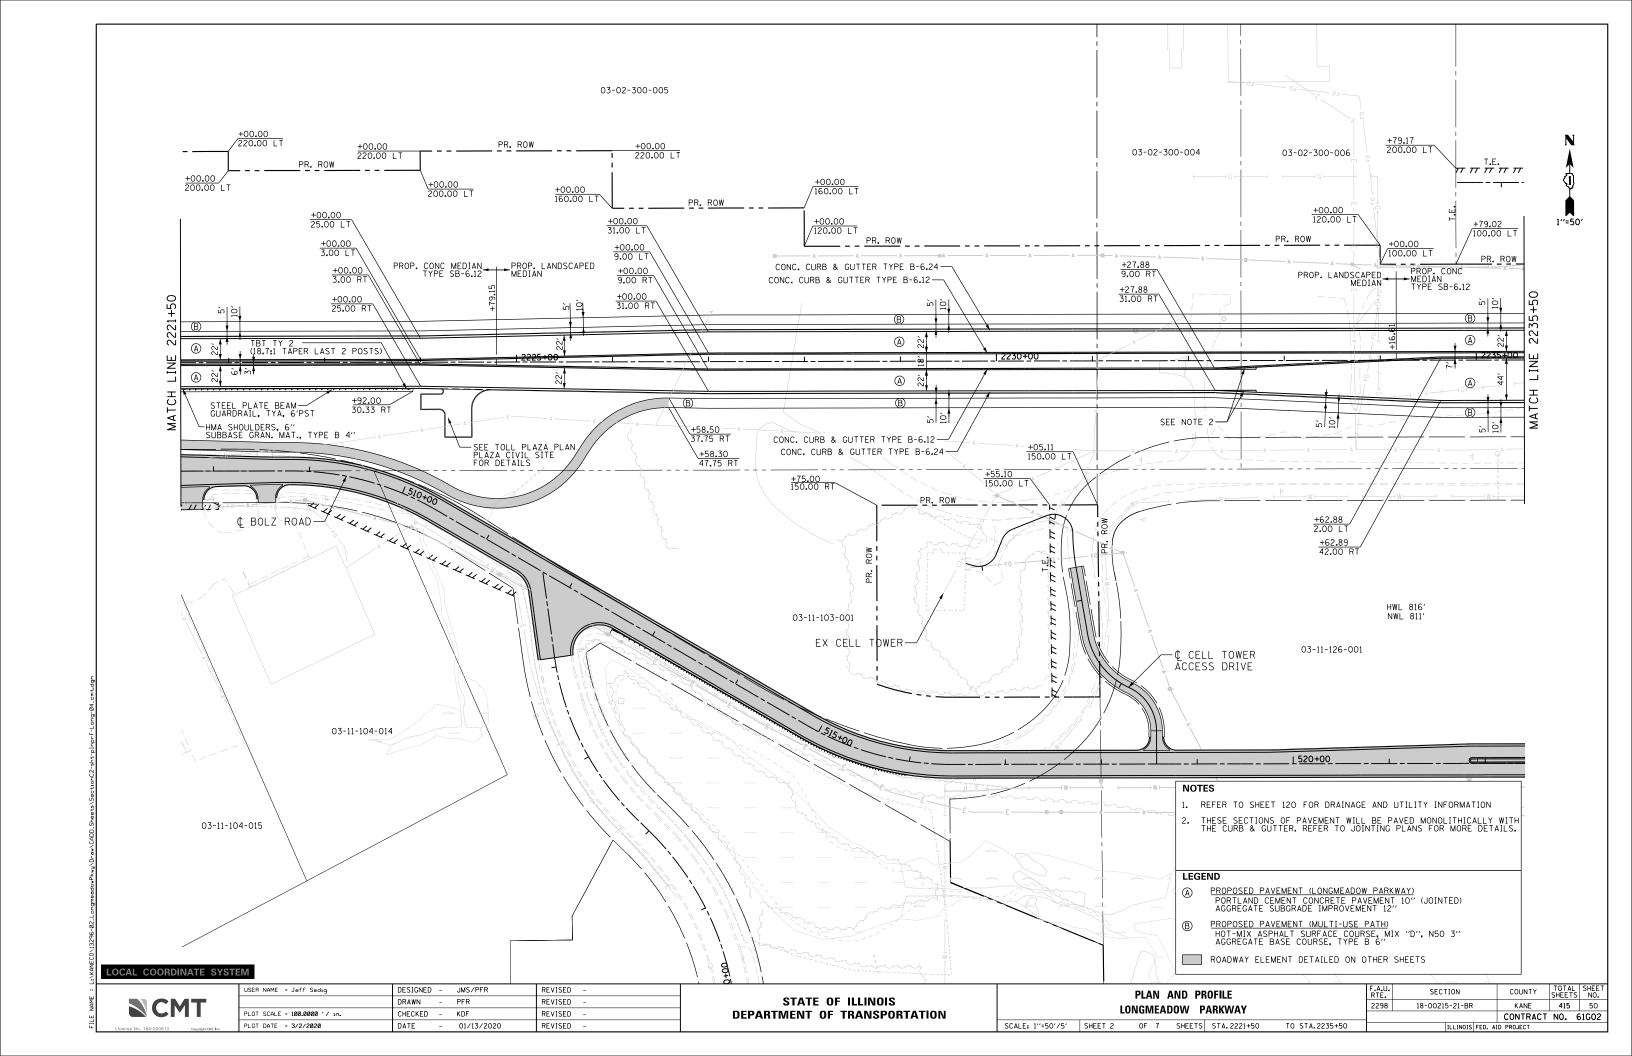


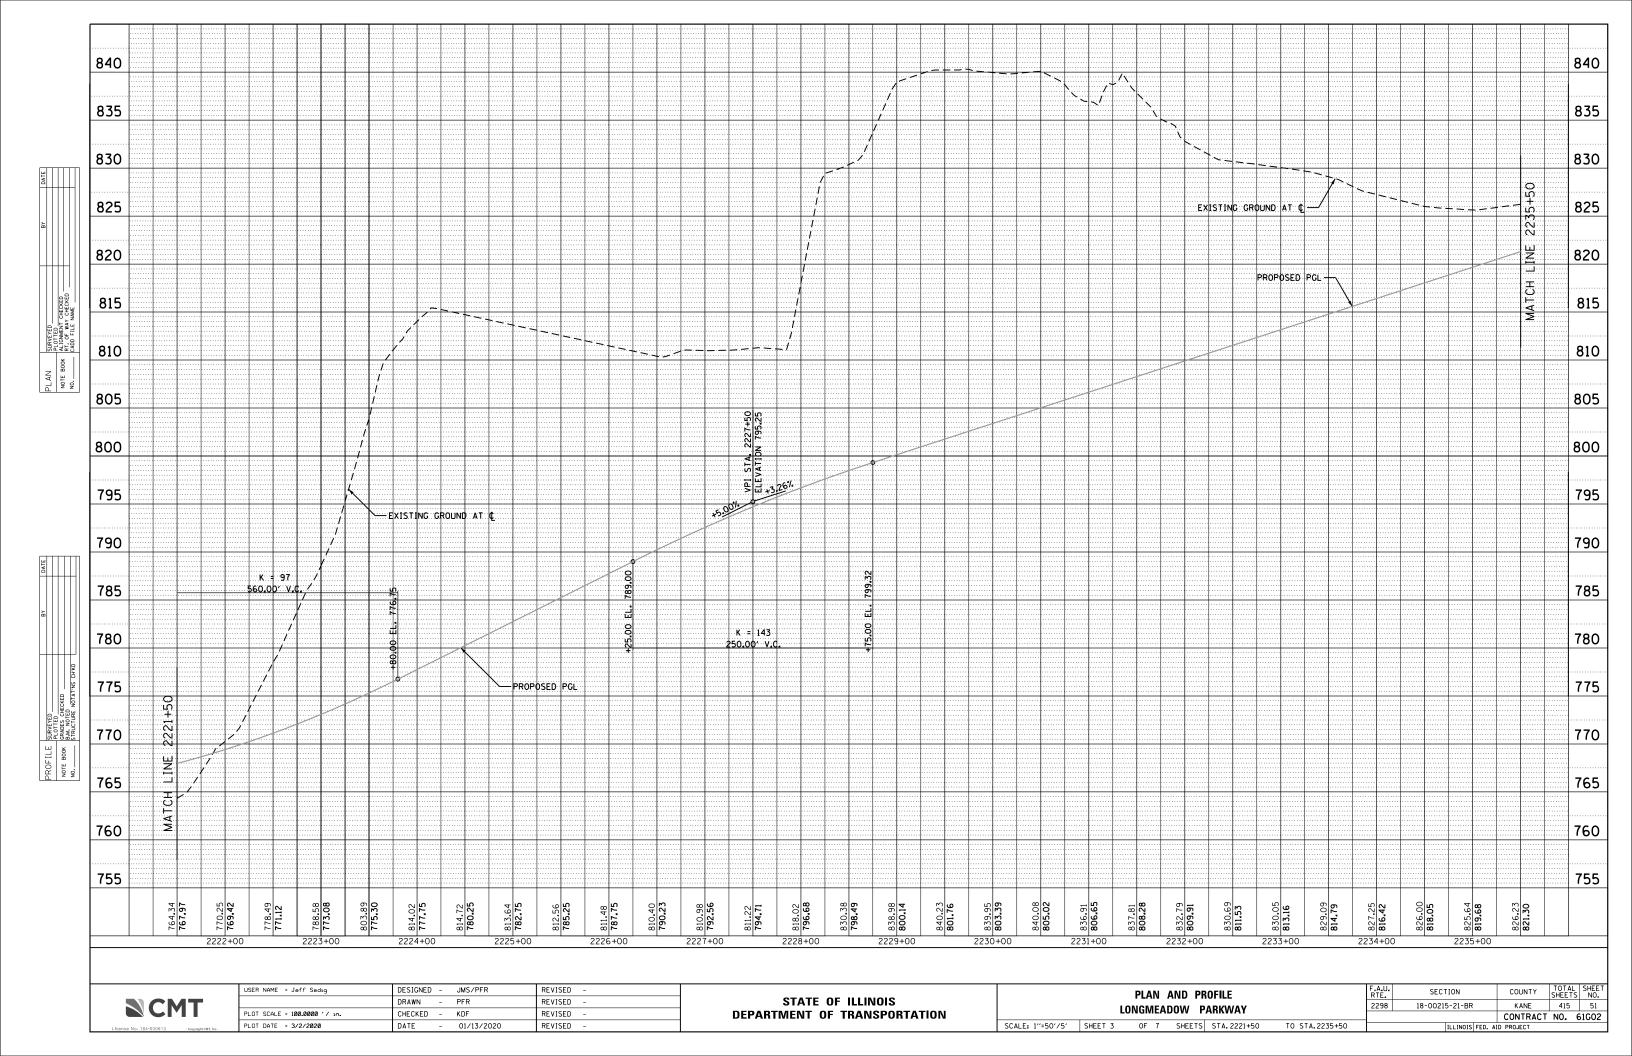


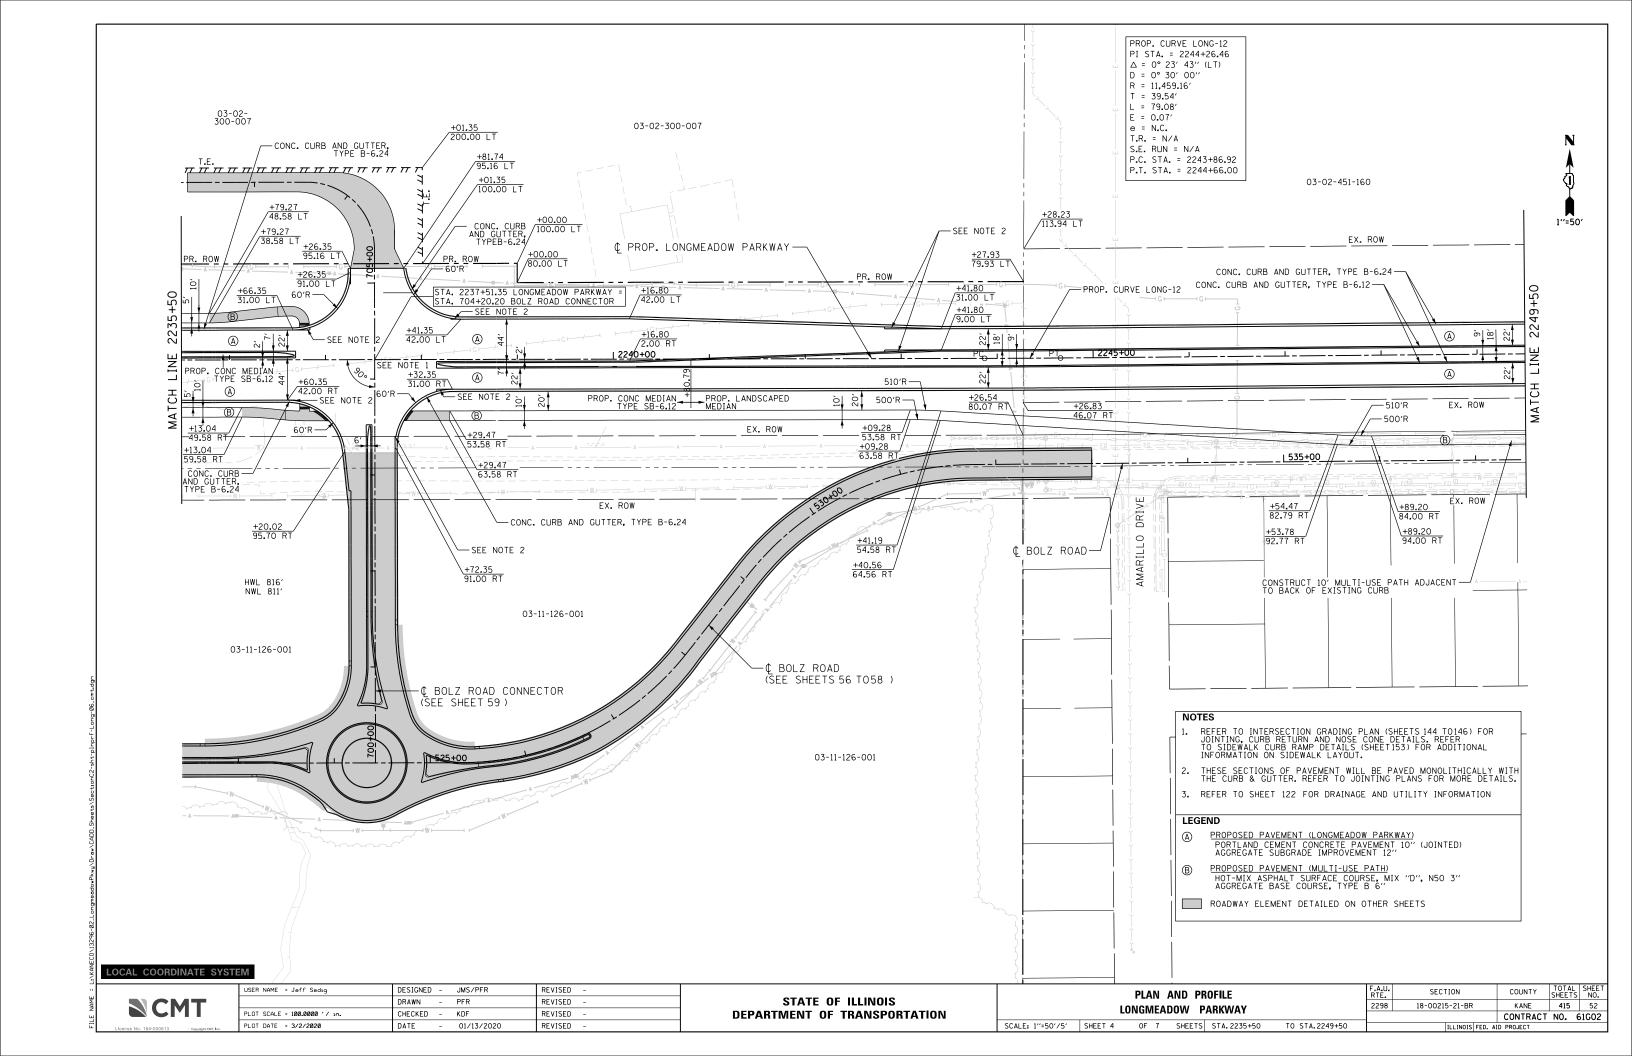


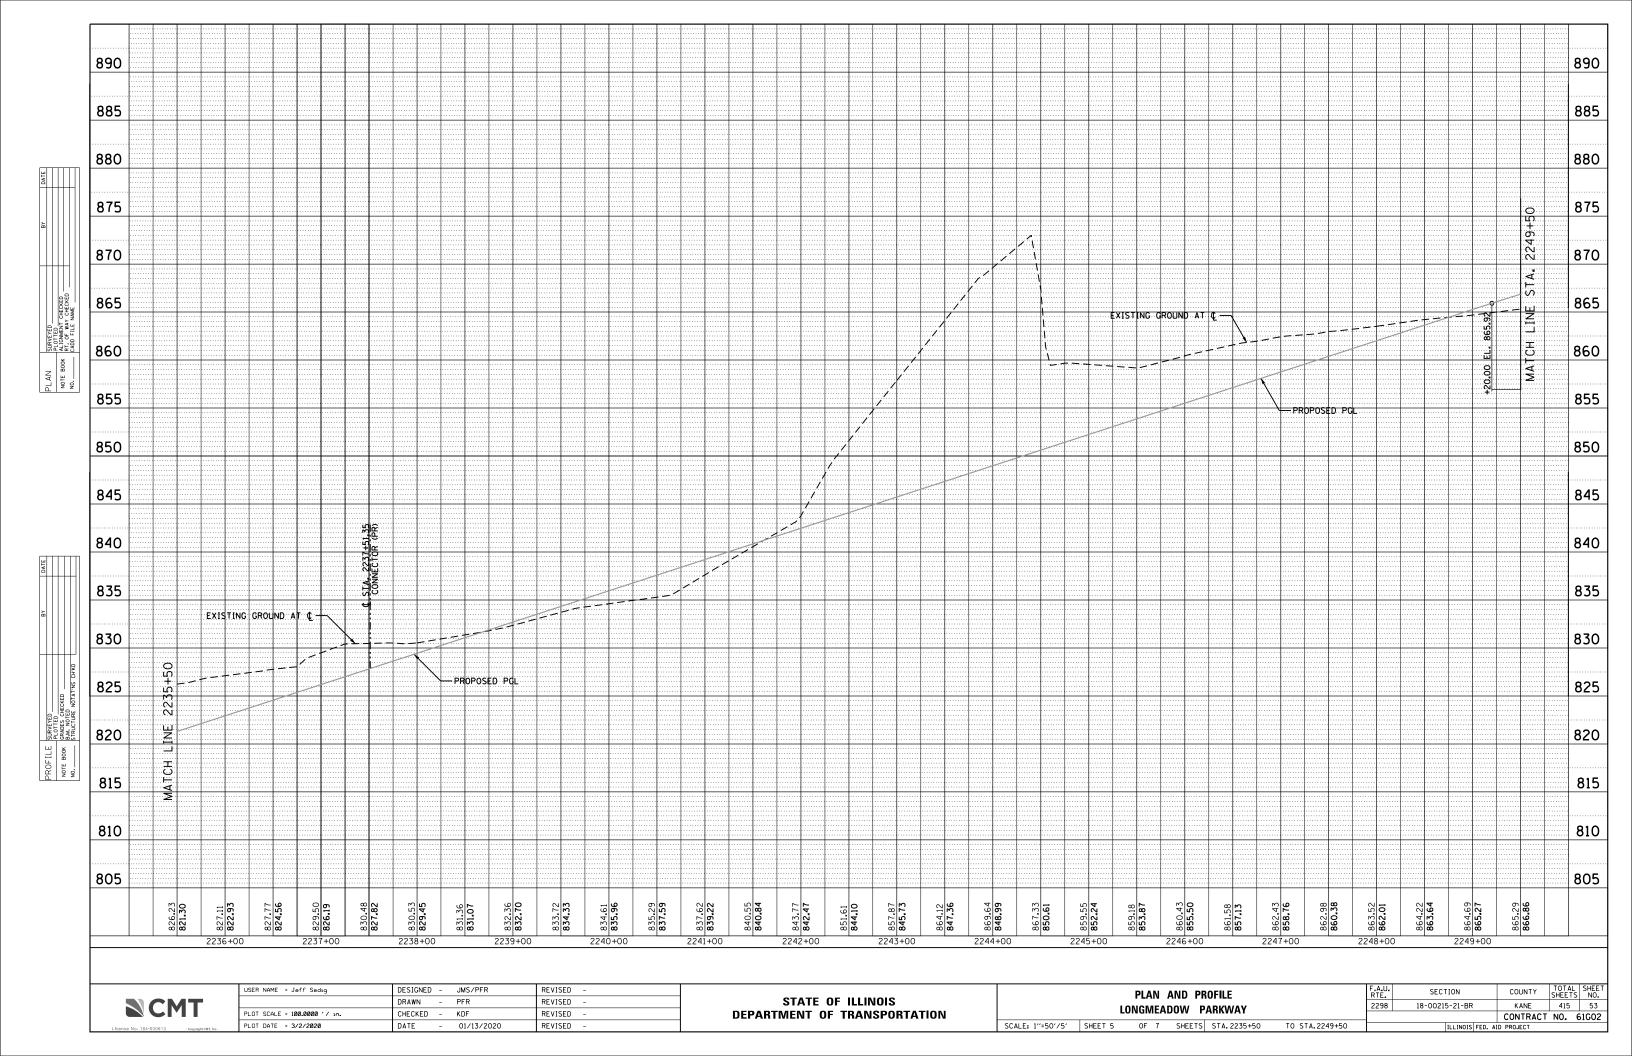


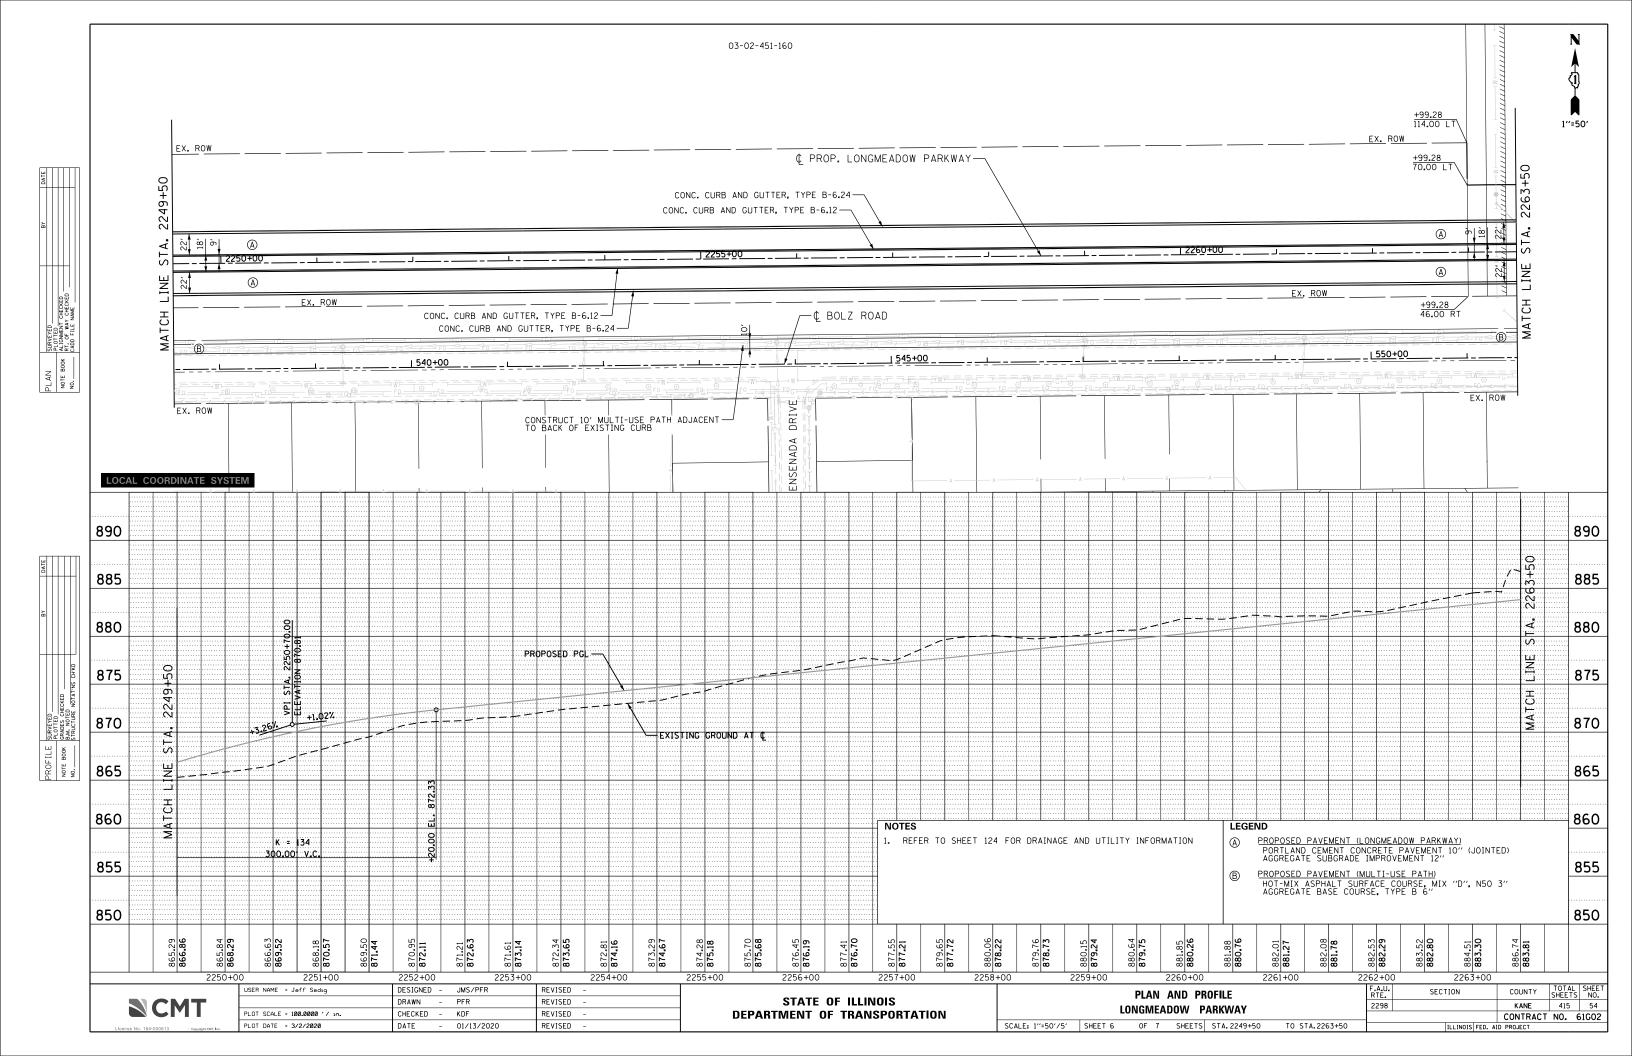


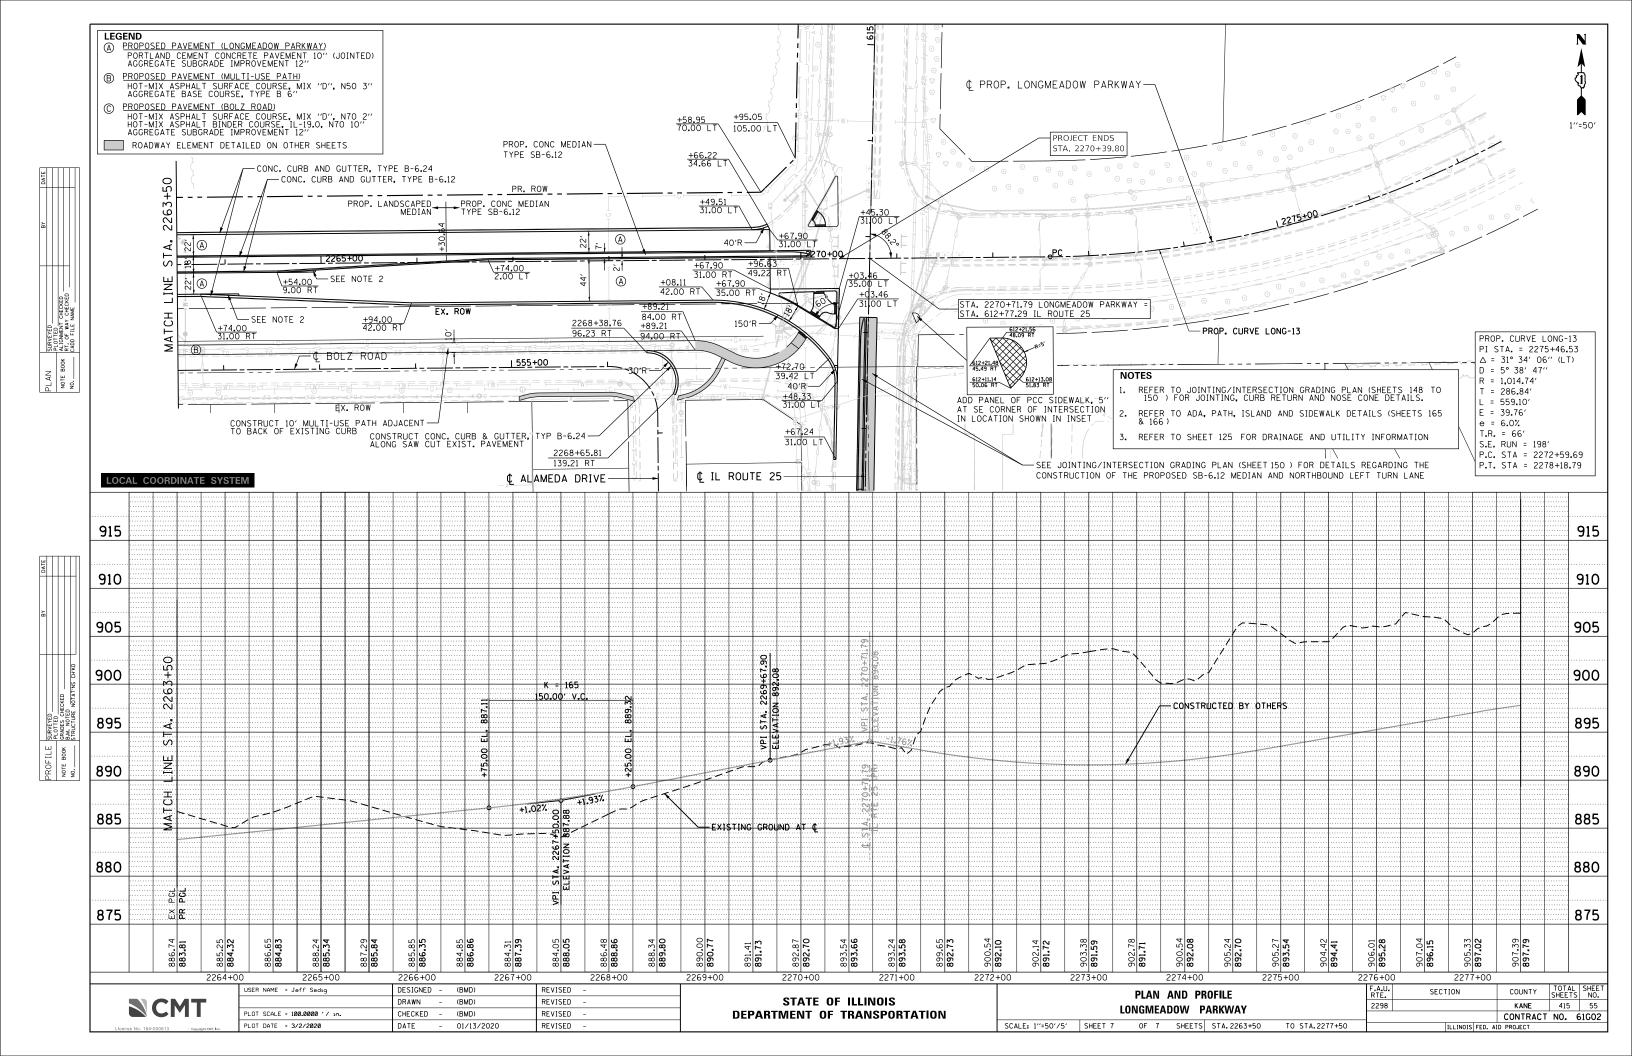

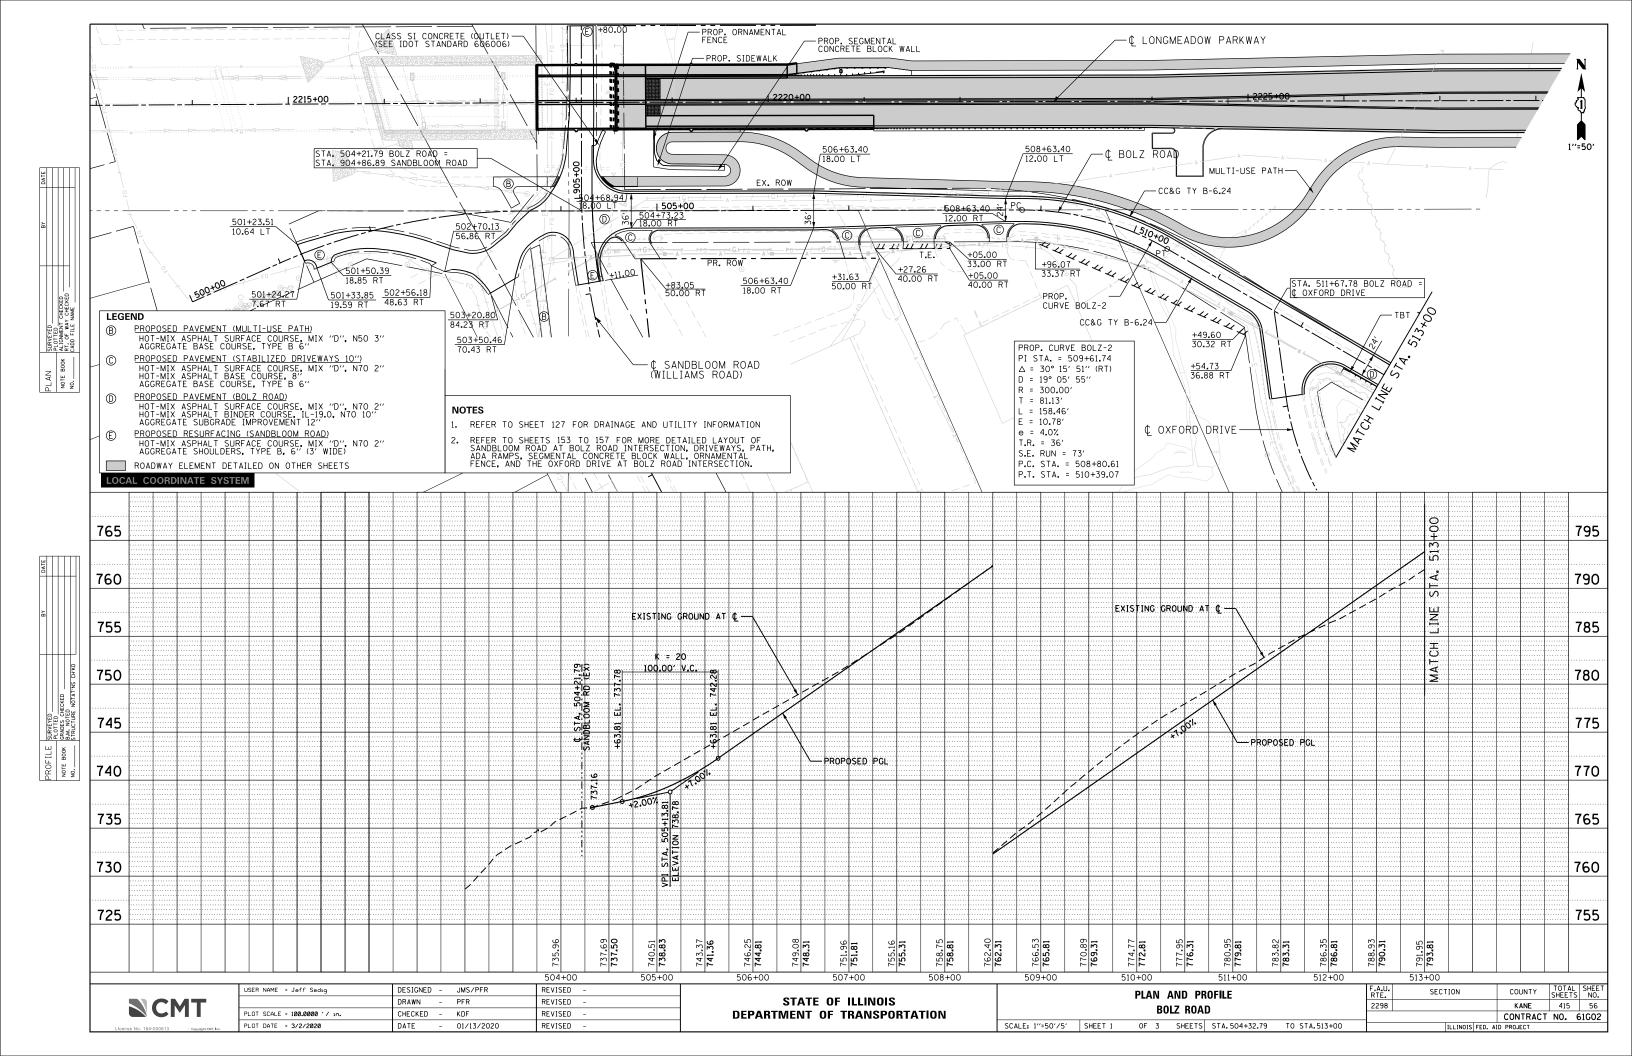

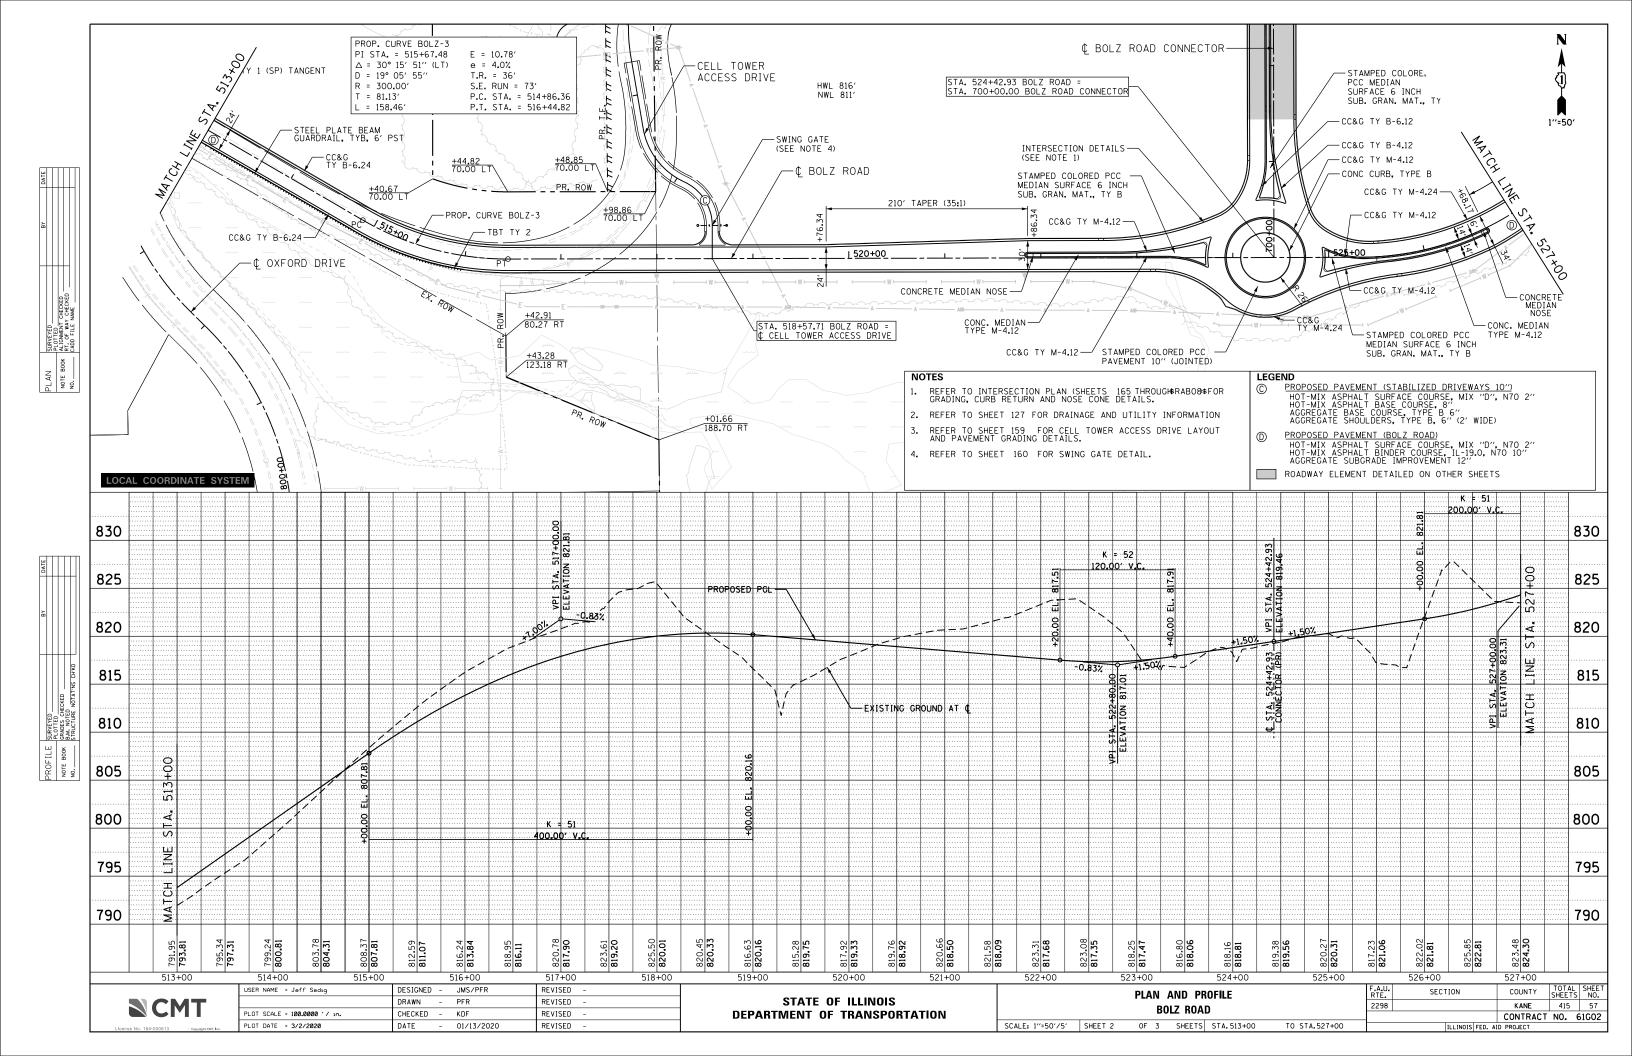

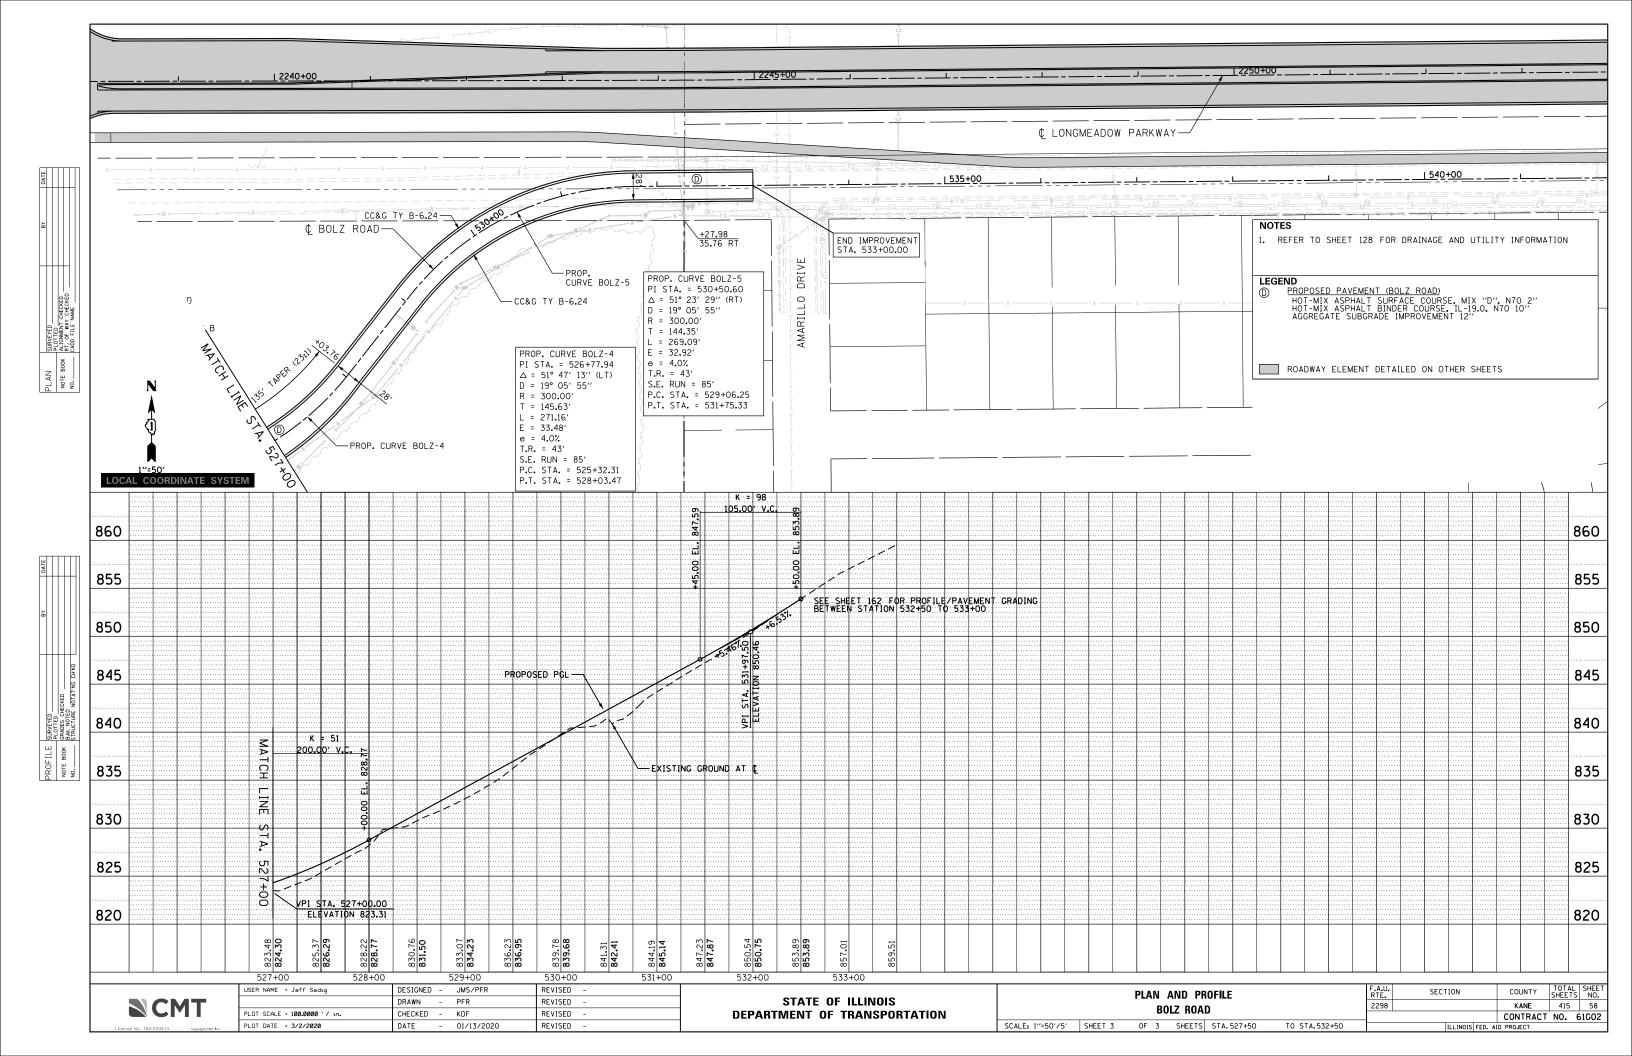


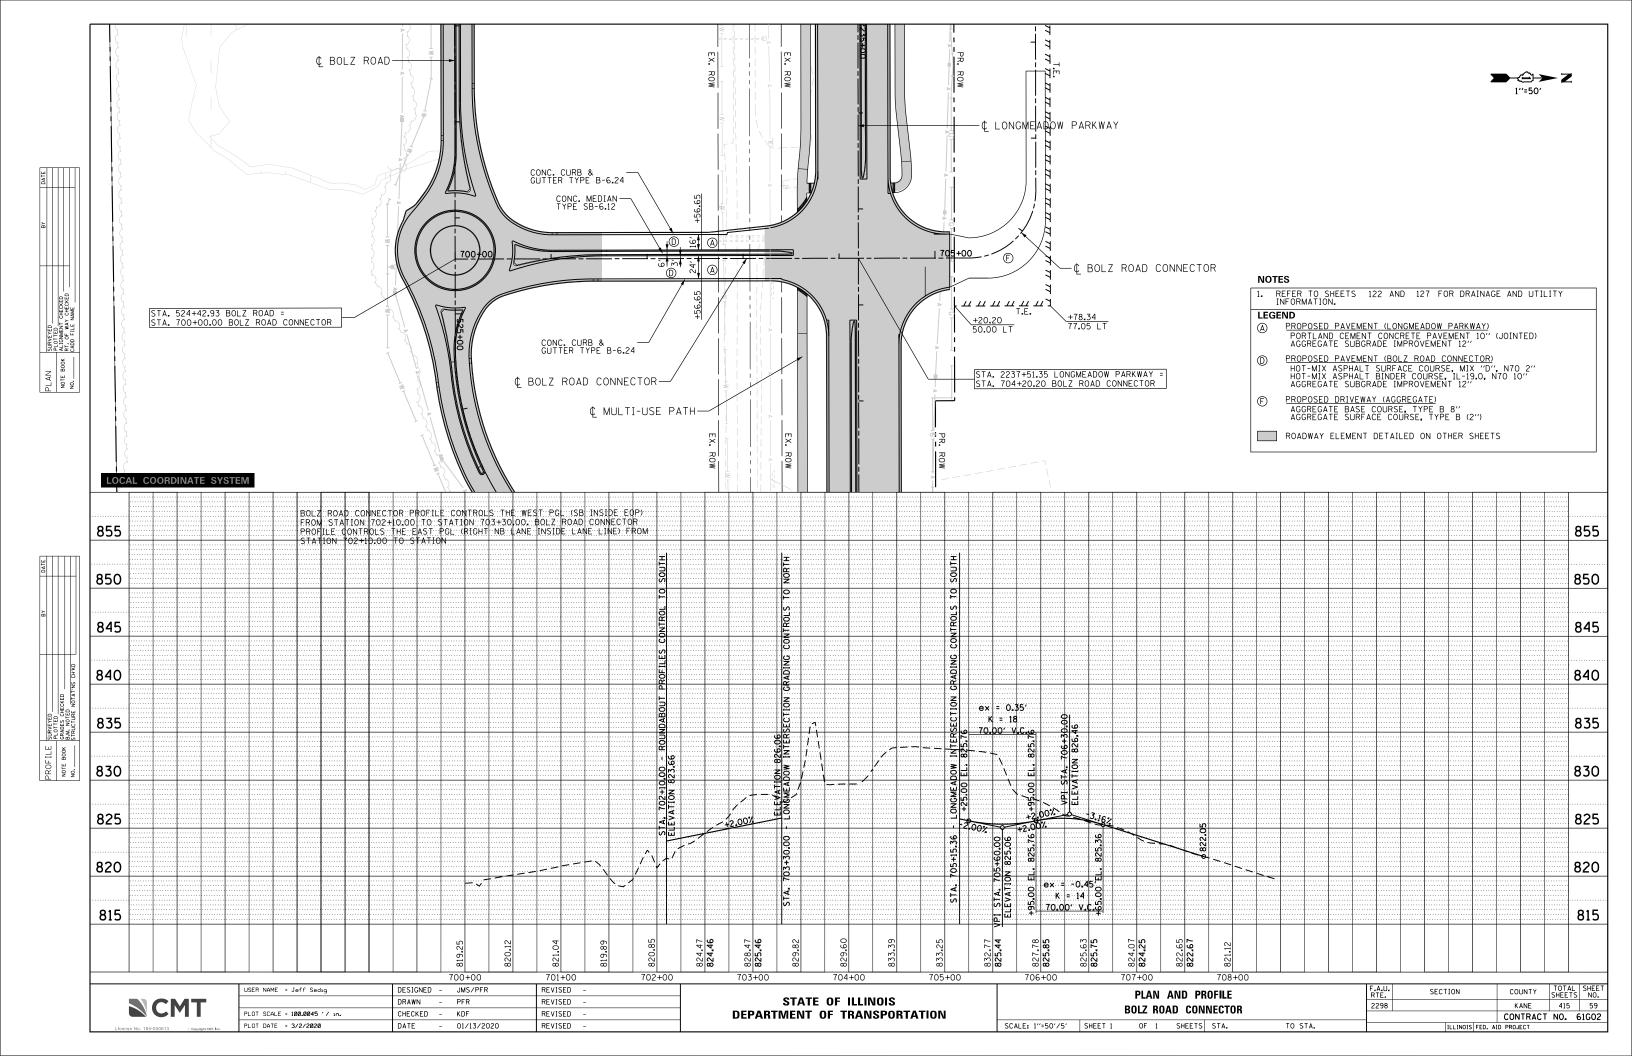

MAINTENANCE OF TRAFFIC GENERAL NOTES

- 1. THE SUGGESTED SEQUENCE OF OPERATIONS AND SUMMARY FOR CONSTRUCTION STAGING DOES NOT, NOR IS IT INTENDED TO, DEPICT ALL THE WORK THAT WILL BE REQUIRED BY THE CONTRACTOR STAGING OPERATIONS DURING THE CONTRACT. THE SEQUENCE OF OPERATIONS IS GIVEN AS AN AIDE AND GUIDE FOR THE CONTRACTOR'S USE TO ESTABLISH THE NECESSARY GUIDELINES FOR EFFICIENT TRAFFIC OPERATION DURING THE DURATION OF THE CONTRACT.
- 2. THE CONTRACTOR MAY WISH TO MAKE REVISIONS OR MODIFICATIONS TO THE SEQUENCE OF CONSTRUCTION OR THE MAINTENANCE OF TRAFFIC PLANS. ALL CHANGES MUST BE SUBMITTED IN WRITING TO THE ENGINEER FOR APPROVAL. THE CONTRACTOR SHALL INDICATE IN HIS SUBMITTAL, ANY INCREASES IN COSTS ASSOCIATED WITH THE SUGGESTED REVISIONS OF THE MAINTENANCE OF TRAFFIC PLANS. THESE COSTS INCLUDE BUT ARE NOT LIMITED TO ADDITIONAL SIGNS, FLAGGERS, BARRICADES, OR OTHER TRAFFIC CONTROL DEVICES REQUIRED ABOVE WHICH WAS ASSOCIATED WITH THE MAINTENANCE OF TRAFFIC PLAN INCLUDED IN THE CONTRACT DOCUMENTS.
- 3. TRAFFIC CONTROL AND PROTECTION SHALL BE PERFORMED IN ACCORDANCE WITH THE TRAFFIC CONTROL PLAN AND SECTION 701 OF THE STANDARD SPECIFICATIONS AS AMENDED BY THE SPECIAL PROVISION FOR CONSTRUCTION ZONE TRAFFIC CONTROL UNLESS PRIOR APPROVAL IS RECEIVED FROM THE ENGINEER.
- 4. THE TYPE III BARRICADES SHALL BE PLACED IN ACCORDANCE WITH STANDARD 701901 UNLESS AUTHORIZED BY THE ENGINEER TO USE AN ALTERNATE ARRANGEMENT.
- ANY DROP OFF GREATER THAN THREE (3) INCHES BUT LESS THAN EIGHTEEN (18) INCHES, WITHIN EIGHT (8) FEET OF THE PAVEMENT EDGE, SHALL BE PROTECTED BY TYPE II BARRICADES, DRUMS, OR VERTICAL PANELS WITH MONO DIRECTIONAL STEADY BURNING LIGHTS AT 50 FOOT CENTER TO CENTER SPACING.
- 6. IF THE DROP OFF WITHIN EIGHT (8) FEET OF THE PAVEMENT EDGE EXCEEDS EIGHTEEN (18) INCHES, TEMPORARY CONCRETE BARRIER SHALL BE UTILIZED TO PROTECT THE WORK ZONE. BARRICADES THAT MUST BE PLACED IN EXCAVATED AREAS SHALL HAVE LEG EXTENSIONS INSTALLED SUCH THAT THE TOP OF THE BARRICADE IS IN COMPLIANCE WITH THE HEIGHT REQUIREMENTS OF HIGHWAY STANDARD 701901.
- 7. TYPE II BARRICADES WITH TWO-WAY FLASHING LIGHTS SHALL BE REQUIRED AT ALL OPEN TRENCHES, EXCAVATIONS, OPEN OR EXPOSED SEWER STRUCTURE'S TRANSVERSE PAVEMENT JOINTS, MATERIALS OR EQUIPMENT WITHIN THE RIGHT-OF-WAY (NUMBER AND SPACING DEPENDS ON THE CONDITIONS); AND AT LOCATIONS DESIGNED BY THE ENGINEER.
- 8. THE CONTRACTOR SHALL MAINTAIN ACCESS TO ALL PROPERTIES DURING CONSTRUCTION OPERATIONS. THE CONTRACTOR SHALL CONSTRUCT AND MAINTAIN AGGREGATE DRIVEWAYS FOR TEMPORARY ACCESS AT ALL TIMES FOR ALL APPROACHES AND ENTRANCES ACCORDING TO SECTION 402 OF THE STANDARD SPECIFICATIONS. ALL ENTRANCES SHALL BE MAINTAINED 24 HOURS PER DAY, SEVEN DAYS PER WEEK. DRIVEWAY SIGNS SHALL BE PROVIDED AT ALL TEMPORARY ACCESS LOCATIONS AND EXISTING ACCESS LOCATIONS. THESE SIGNS SHALL BE DOUBLE SIDED AND PLACED AT A LOCATION DETERMINED BY THE ENGINEER. SIGNS SHALL BE CONSTRUCTED AND INSTALLED PER IDOT DISTRICT I STANDARD TC-26. SIGNS SHALL BE PAID FOR AS ITEM Z0030850 "TEMPORARY INFORMATION SIGNING."
- 9. THE CONTRACTOR IS REQUIRED TO MAINTAIN DRAINAGE IN THE ROADSIDE DITCHES WITHIN THE PROJECT LIMIS DURING CONSTRUCTION OPERATIONS IN ACCORDANCE WITH ARTICLE 202.05 OF THE STANDARD SPECIFICATIONS.
- 10. PROGRAMMABLE MESSAGE BOARDS SHALL BE PLACED AS SHOWN ON THE SUGGESTED STAGES OF CONSTRUCTION AND TRAFFIC CONTROL. THE PROGRAMMABLE MESSAGE BOARDS SHALL BE PLACED SEVEN (7) DAYS PRIOR TO ANY WORK THAT IS TO TAKE PLACE ON THE ASSOCIATED ROADWAY. ALL MESSAGES ARE TO BE AS PROVIDED BY THE ENGINEER, AND NO ADDITIONAL COMPENSATION WILL BE GRANTED FOR MAKING CHANGES TO THE MESSAGE THROUGHOUT THE DURATION OF CONSTRUCTION.
- 11. THE CONTRACTOR SHALL INFORM THE ENGINEER OF ANY STAGE CHANGE AT LEAST SEVEN (7) DAYS IN ADVANCE OF THE SCHEDULED TRAFFIC CHANGE.

- 12. THE CONTRACTOR SHALL MAINTAIN POSITIVE DRAINAGE AS REQUIRED OR AS DIRECTED BY THE ENGINEER THROUGHOUT THE CONSTRUCTION ZONE FOR THE PERIOD OF THE CONSTRUCTION. THE EXISTING AND PROPOSED DRAINAGE SYSTEM WILL BE USED THROUGHOUT CONSTRUCTION STAGING.
- 13. EXISTING PAVEMENT MARKINGS IN CONFLICT WITH MAINTENANCE OF TRAFFIC STRIPING SHALL BE REMOVED IN ACCORDANCE WITH THE SPECIAL PROVISION FOR PAVEMENT MARKING REMOVAL.
- 14. ALL DRUMS, VERTICAL PANELS AND BARRICADES PLACED IMMEDIATELY ADJACENT TO THE EDGE OF TRAVELED WAY SHALL BE EQUIPPED WITH STEADY BURN MONO-DIRECTIONAL LAMPS.
- 15. THE CONTRACTOR SHALL BE RESPONSIBLE FOR ESTABLISHING AND MAINTAINING CONSTRUCTION ACCESS POINTS. THE PROPOSED LOCATIONS SHALL BE SUBMITTED TO THE ENGINEER FOR APPROVAL BEFORE USE. A QUANTITY FOR SEDIMENT CONTROL, STABILIZED CONSTRUCTION ENTRANCE (ZOO13796) HAS BEEN PROVIDED.
- 16. THE CONTRACTOR SHALL REMOVE ALL TEMPORARY STRIPING WHICH CONFLICTS WITH THE NEXT STAGE OR FINAL STRIPING. REMOVAL OF TEMPORARY STRIPING SHALL BE PAID FOR AS TEMPORARY PAVEMENT MARKING REMOVAL (X7030005).
- 17. THE CONTRACTOR SHALL BE RESPONSIBLE FOR SNOW REMOVAL WITHIN THE CONTRUCTION WORK ZONE DURING CONSTRUCTION OPERATIONS FOR THOSE SECTIONS CLOSED TO TRAFFIC. NO ADDITIONAL PAYMENT WILL BE PROVIDED FOR THE REMOVAL OF SNOW WITHIN THE CONSTRUCTION WORK ZONF.
- 18. THE SIZES OF ALL SIGNS NOT SPECIFIED IN THESE PLANS SHALL BE IN ACCORDANCE WITH THE ILLINOIS MANUAL OF UNIFORM TRAFFIC CONTROL DEVICES.
- 19. THE CONTRACTOR SHALL BE RESPONSIBLE FOR COORDINATING WORK ON THIS CONTRACT WITH ADJACENT CONTRACTS ON THE LONGMEADOW PARKWAY CORRIDOR, AS WELL AS ANY OTHER CONTRACTS THAT MAY ABUT TO THIS CONTRACT DURING THE LIFESPAN OF THE PROJECT. ANY COSTS INCURRED BY THE CONTRACTOR FOR COORDINATION EFFORTS BETWEEN CONTRACTS SHALL BE BORNE BY THE CONTRACTOR AND NO COMPENSATION SHALL BE WARRENTED.
- 20. TEMPORARY PAVEMENT MARKINGS ON COMPLETED PAVEMENTS OR EXISTING PAVEMENTS THAT ARE TO REMAIN SHALL BE PAVEMENT MARKING TAPE, TYPE IV ONLY, UNLESS AUTHORIZED BY THE ENGINEER TO USE MODIFED URETHANE IF ADHESION BECOMES AN ISSUE IN LATE SEASON APPLICATIONS, TEMPORARY PAVEMENT MARKINGS ON PAVEMENTS THAT ARE TO BE REMOVED OR FINAL SURFACED SHALL BE PAVEMENT MARKING TAPE, TYPE IV OR MODIFED URETHANE.
- 21. ALL TYPE II BARRICADES WILL BE FURNISHED WITH A MINIMUM OF 2 SAND BAGS, ONE PER SIDE.

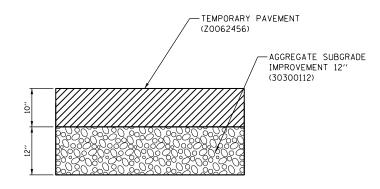

TEMPORARY PAVEMENT SECTION

TEMPORARY PAVEMENT MIX SHALL BE HOT-MIX ASPHALT SURFACE COURSE, "MIX D", N50 (IL 9.5MM) 2" HOT-MIX ASPHALT BINDER COURSE, IL-19.0, N70. 8"


REMOVAL OF THE TEMPORARY PAVEMENT NO LONGER IN USE SHALL BE PAID AS PAVEMENT REMOVAL (44000100).


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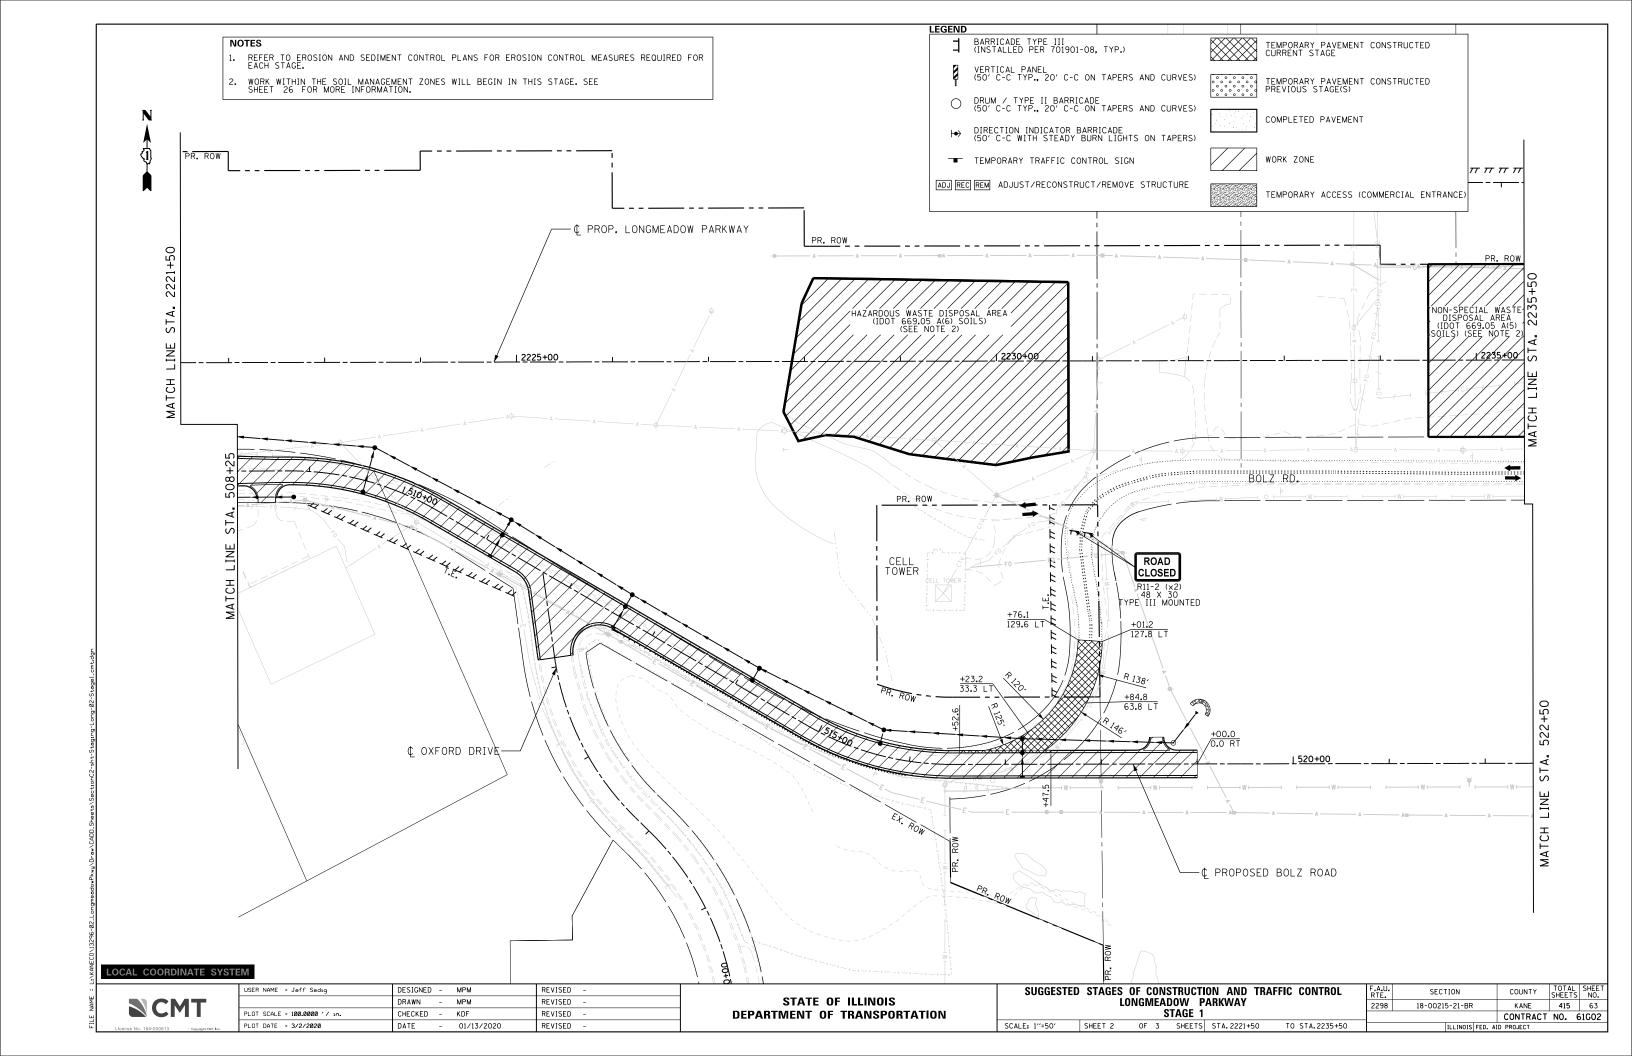
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	DRAWN	-	мРм	REVISED -	
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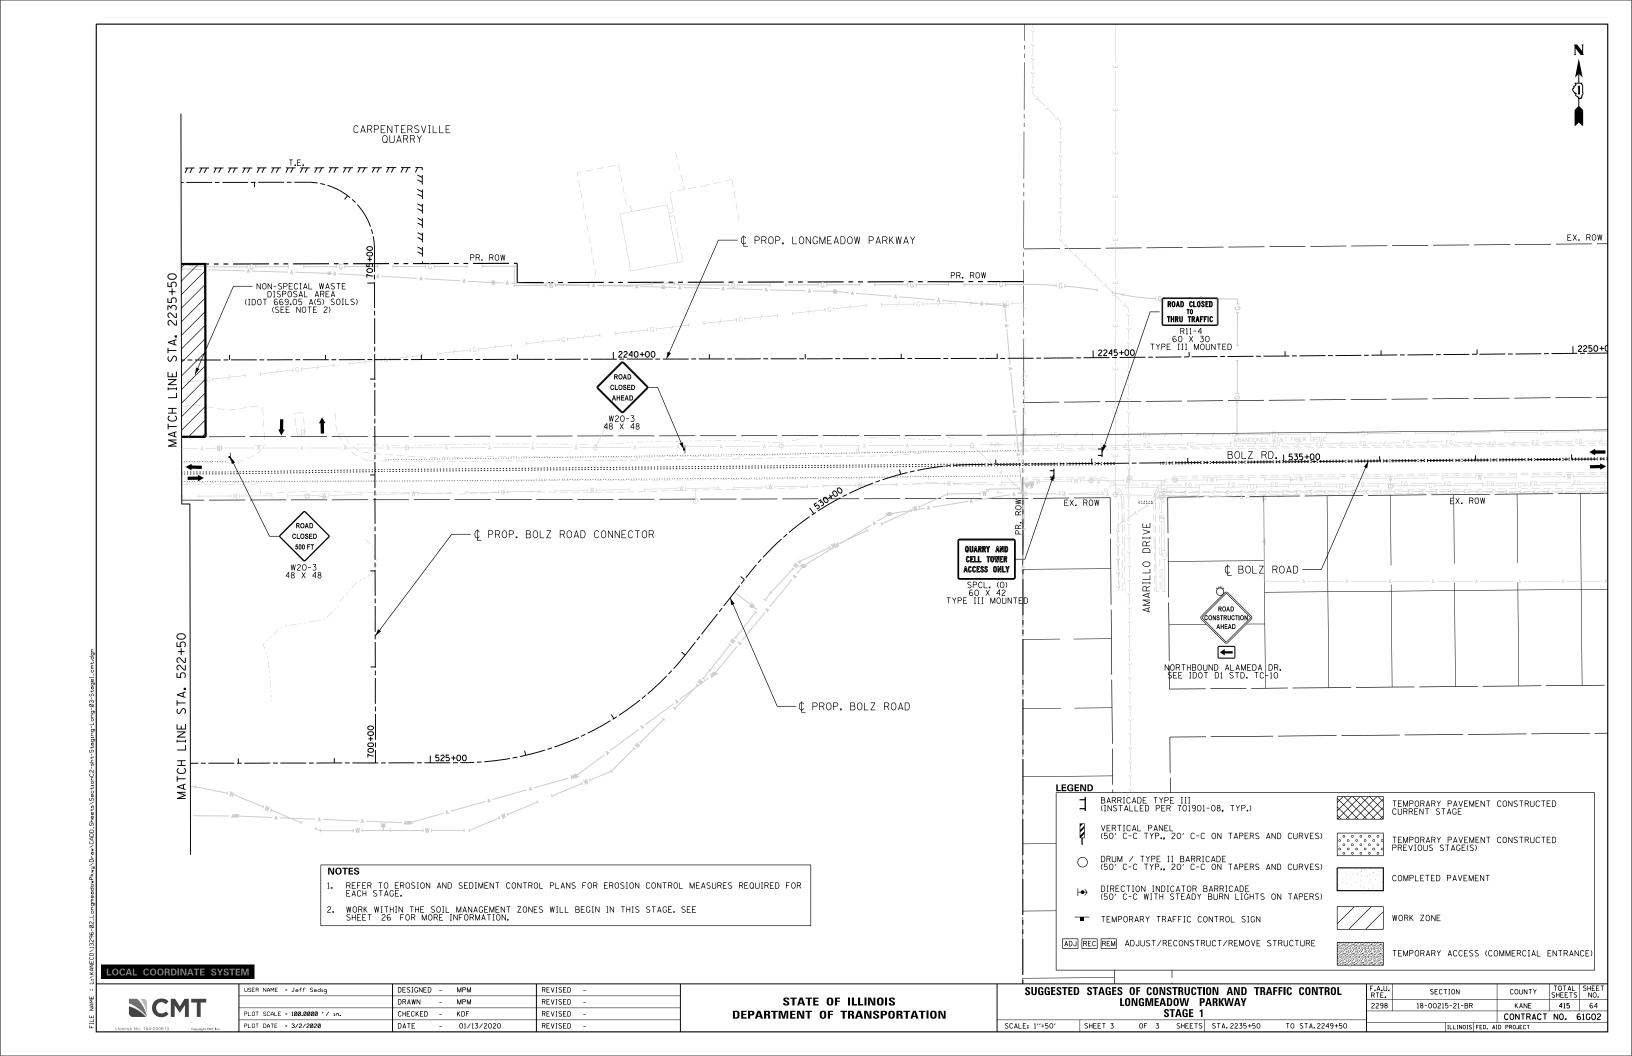
STATE OF ILLINOIS DEPARTMENT OF TRANSPORTATION


Ī	SUGGESTED	SUGGESTED STAGES OF CONSTRUCTION AND TRAFFIC CONTROL							SECTION COUN		TY	TOTAL SHEETS	SHEET NO.
GENERAL NOTES								2298	18-00215-21-BR	KANI	E	415	60
ļ	GLIVEIIAL NOTES									CONTR	RACT	NO. 6	31G02
ı	SCALE: NTS	SHEET 1	OF	1	SHEETS	STA.	TO STA.		ILLINOIS FED. AID PROJECT				







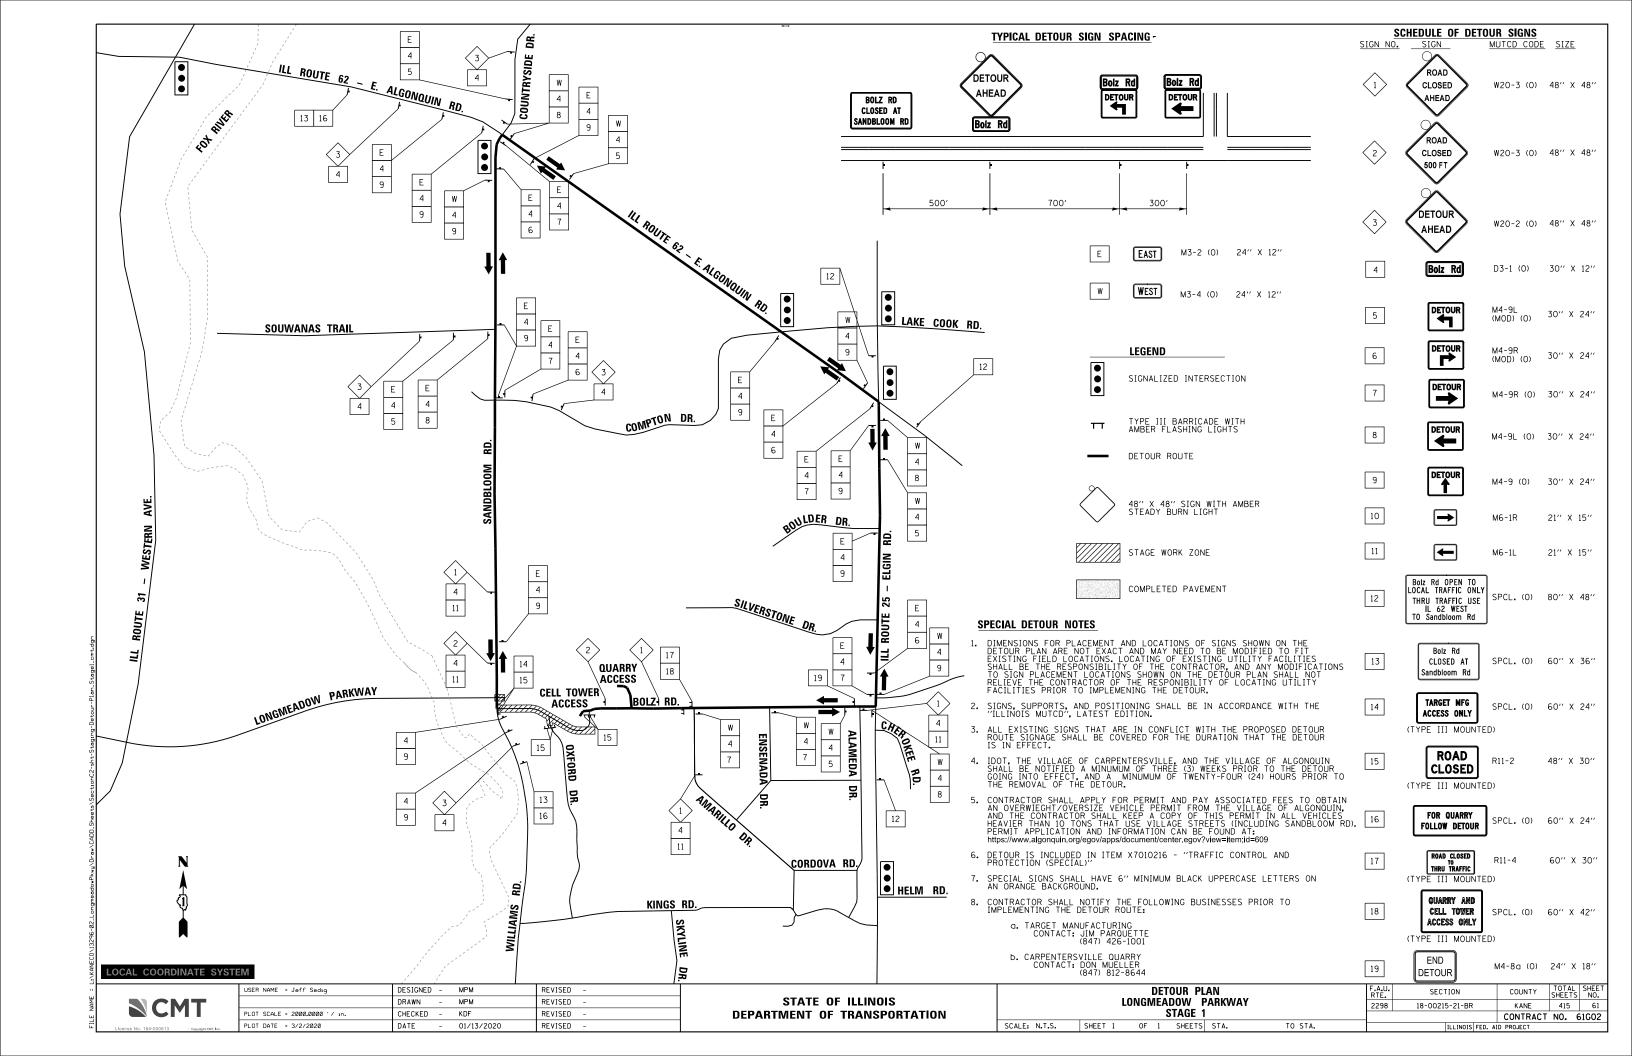


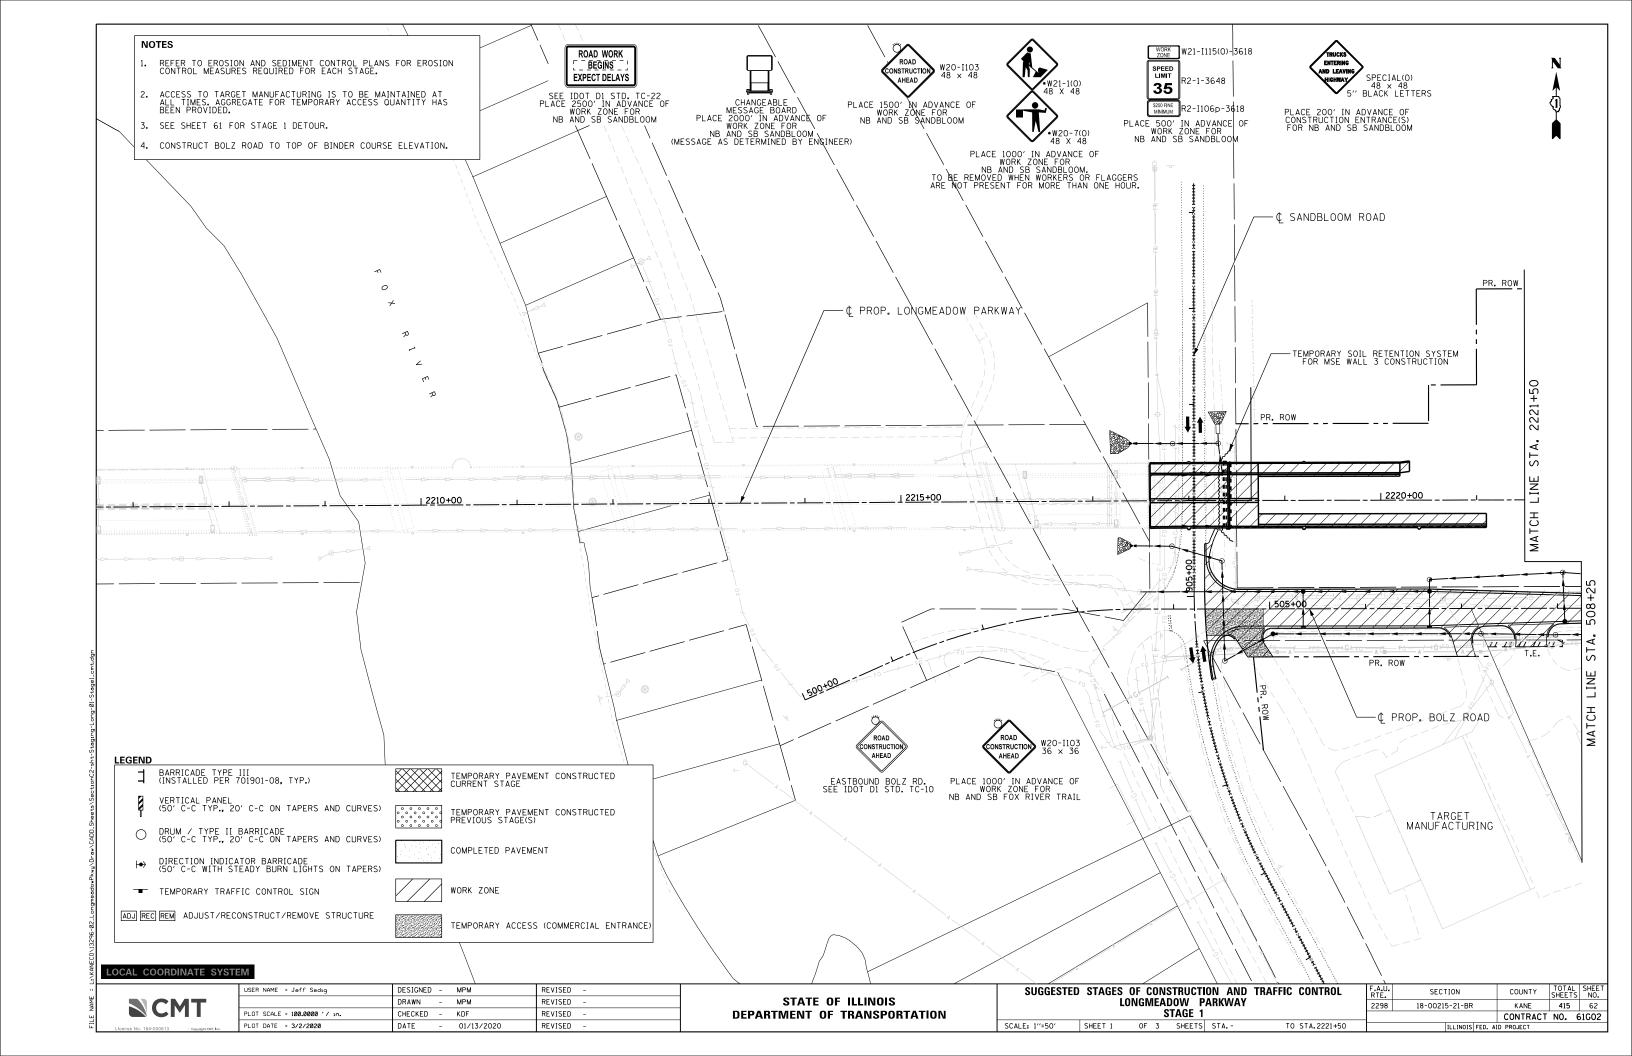


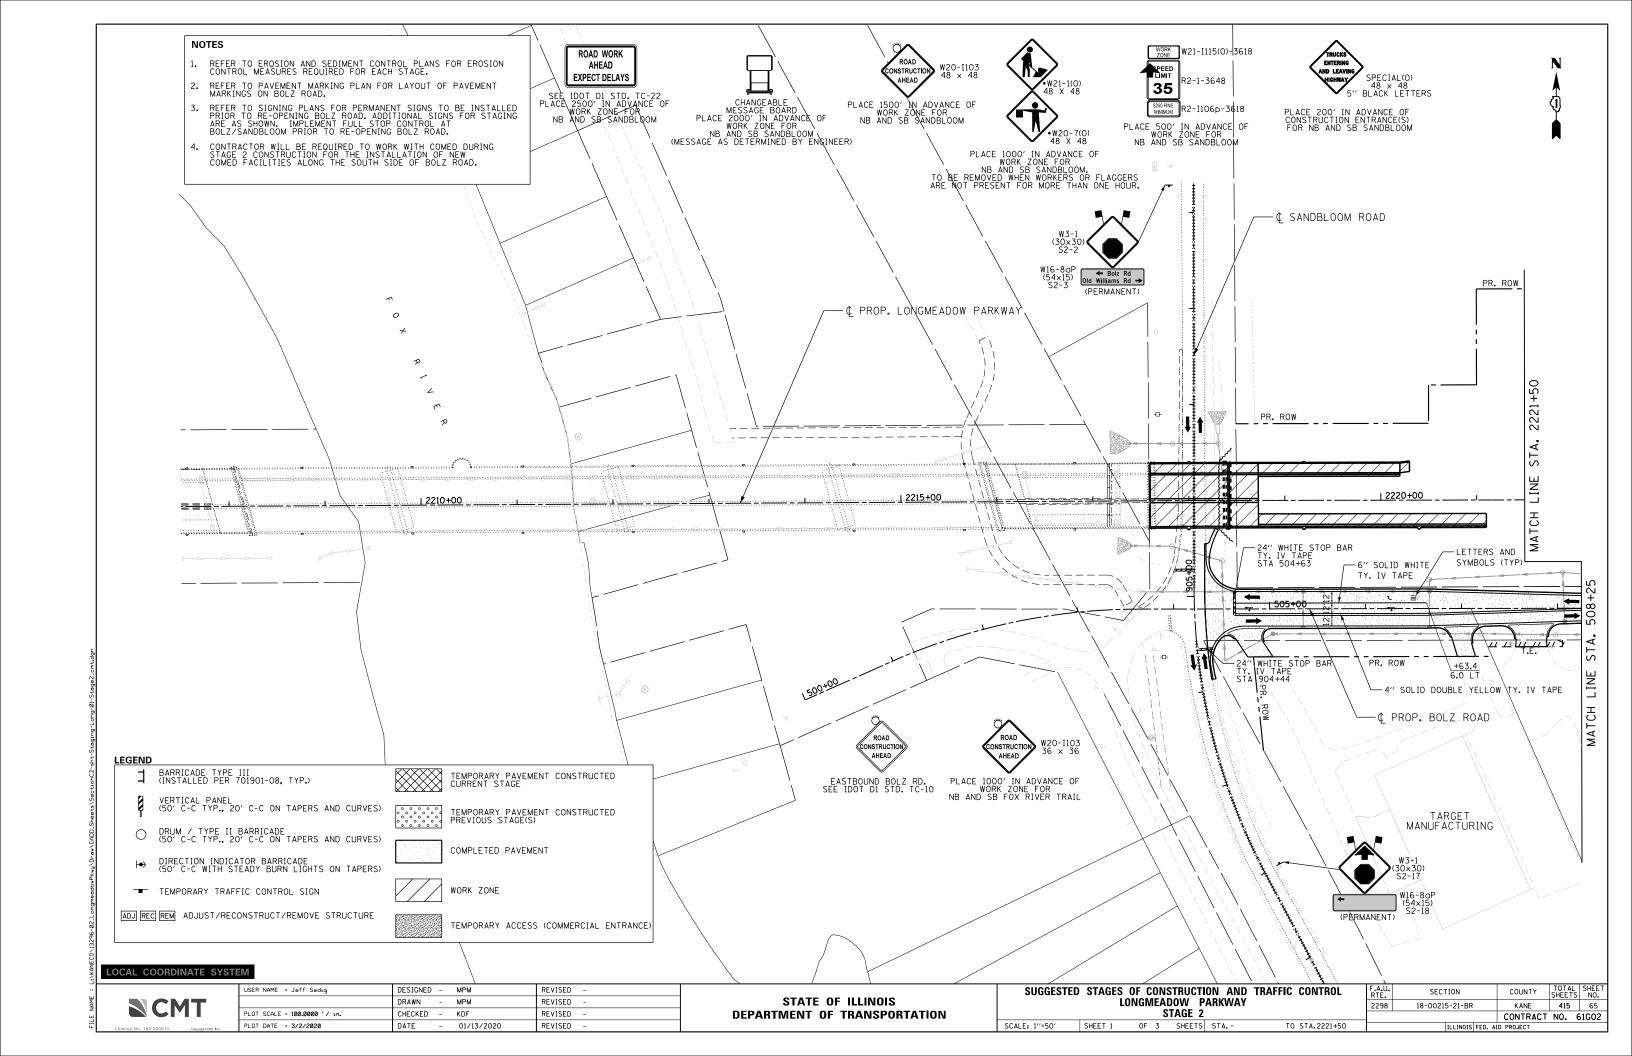


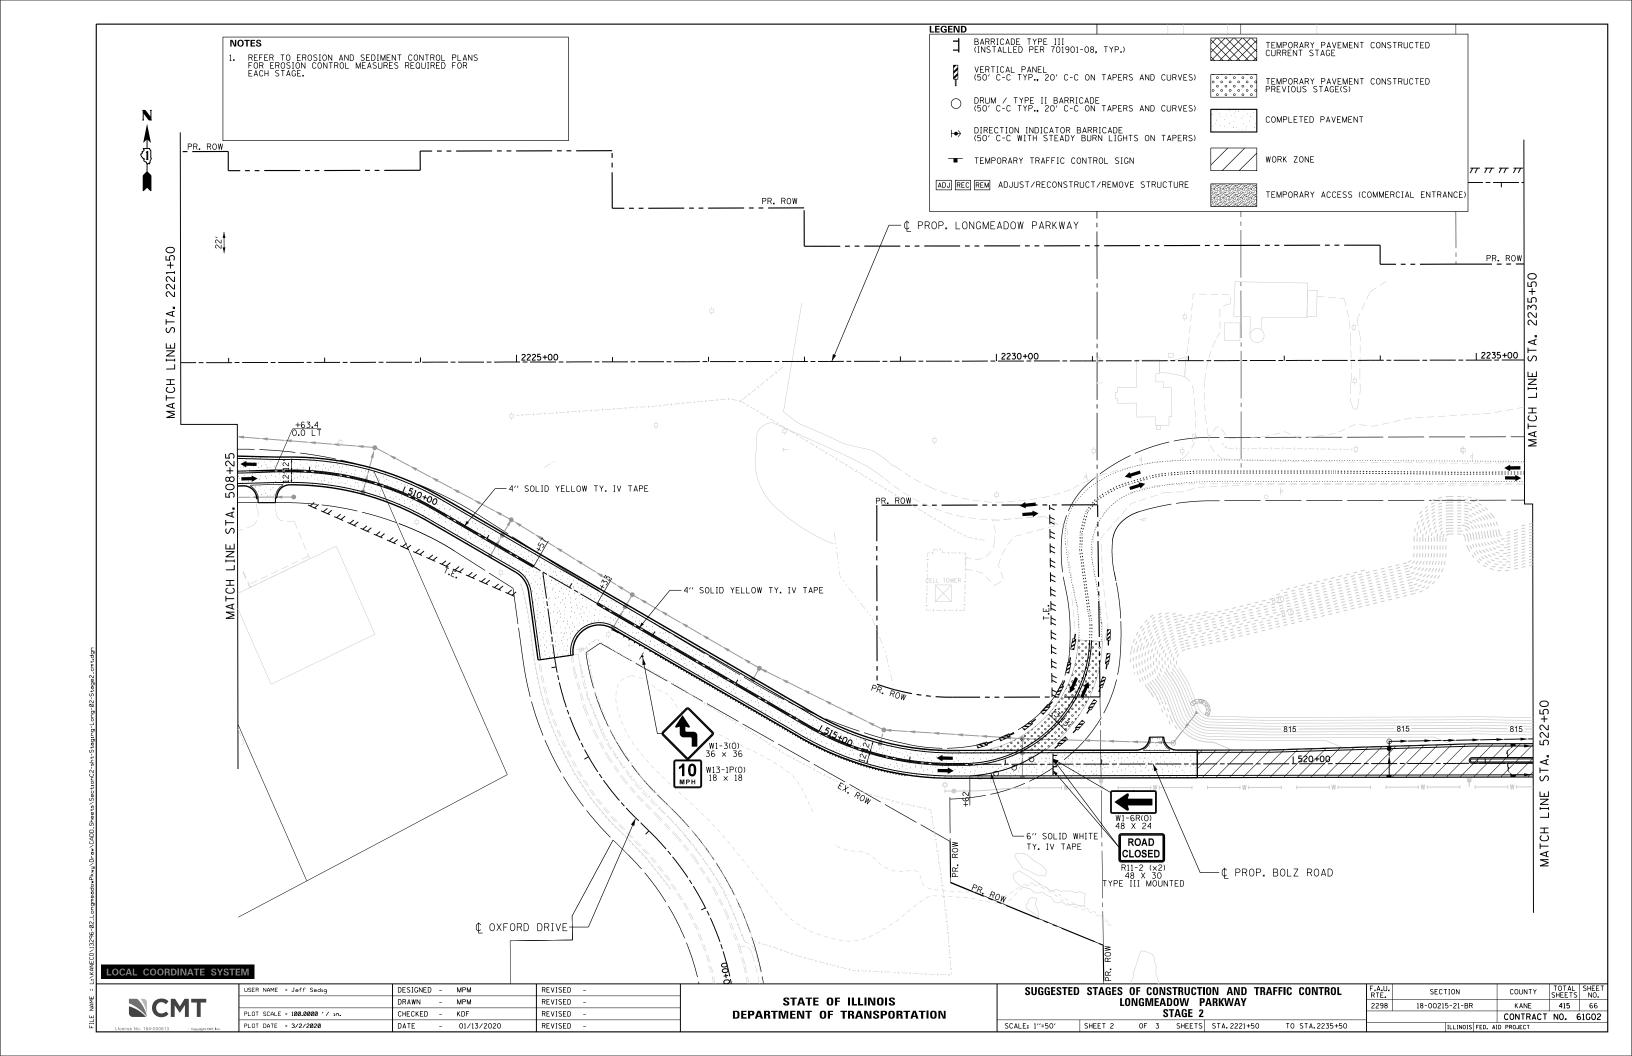


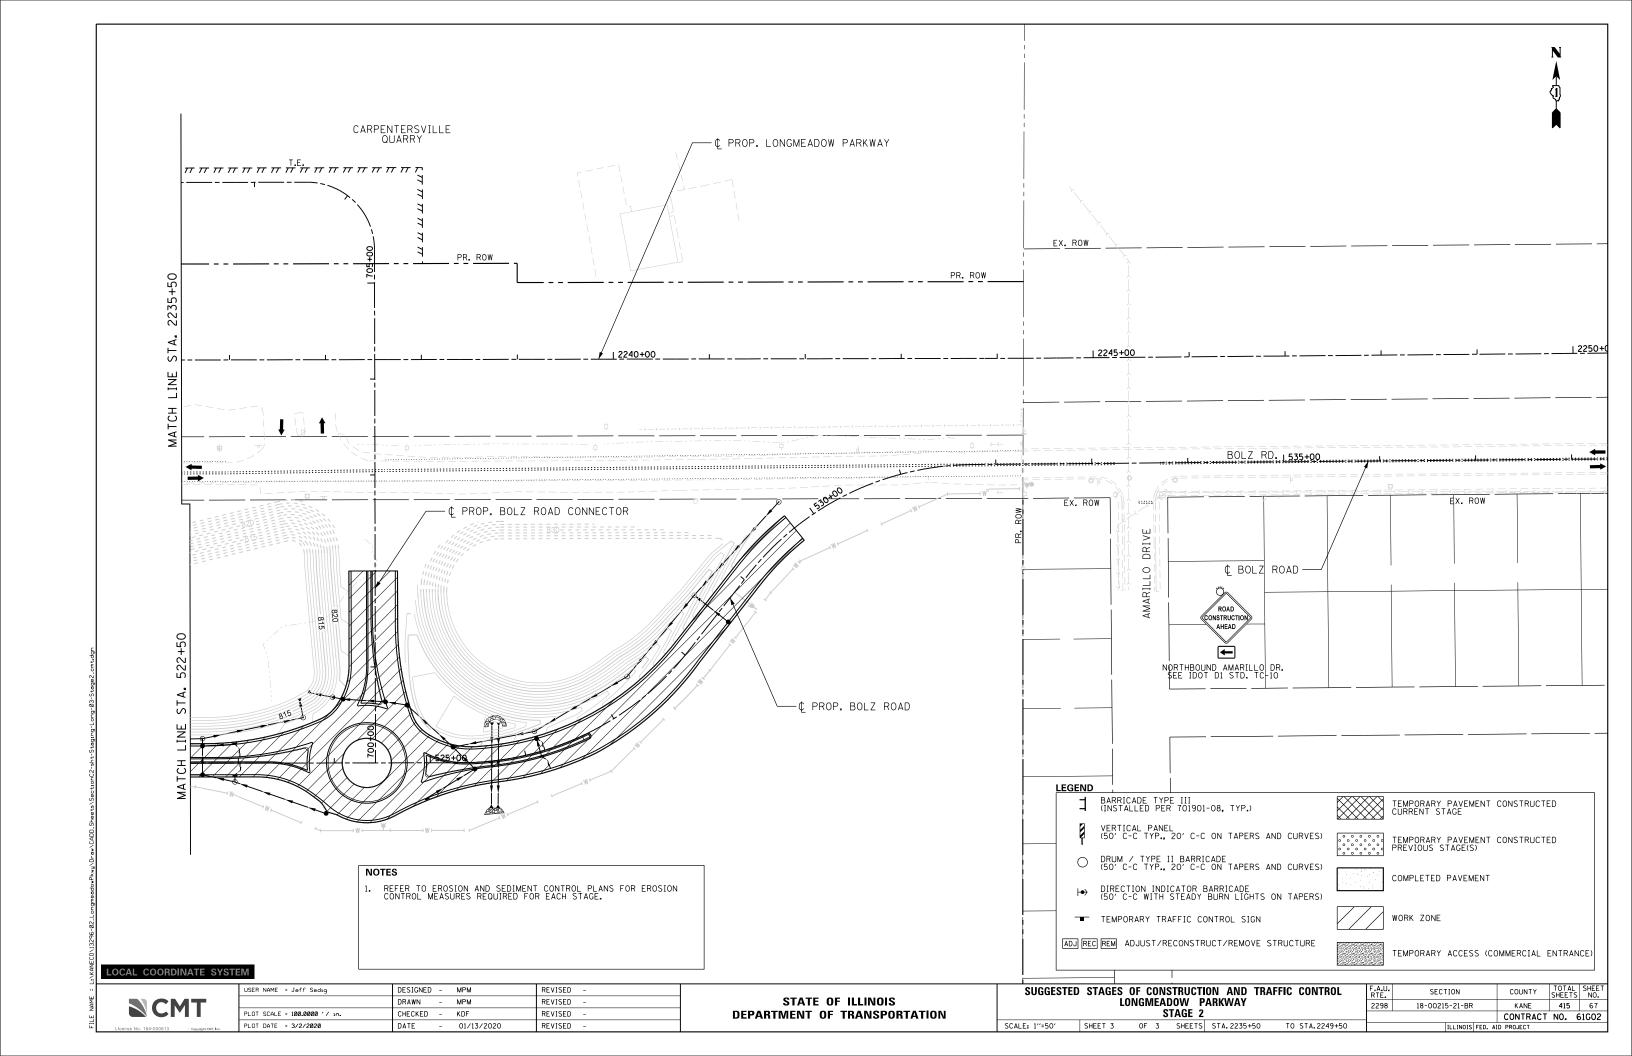


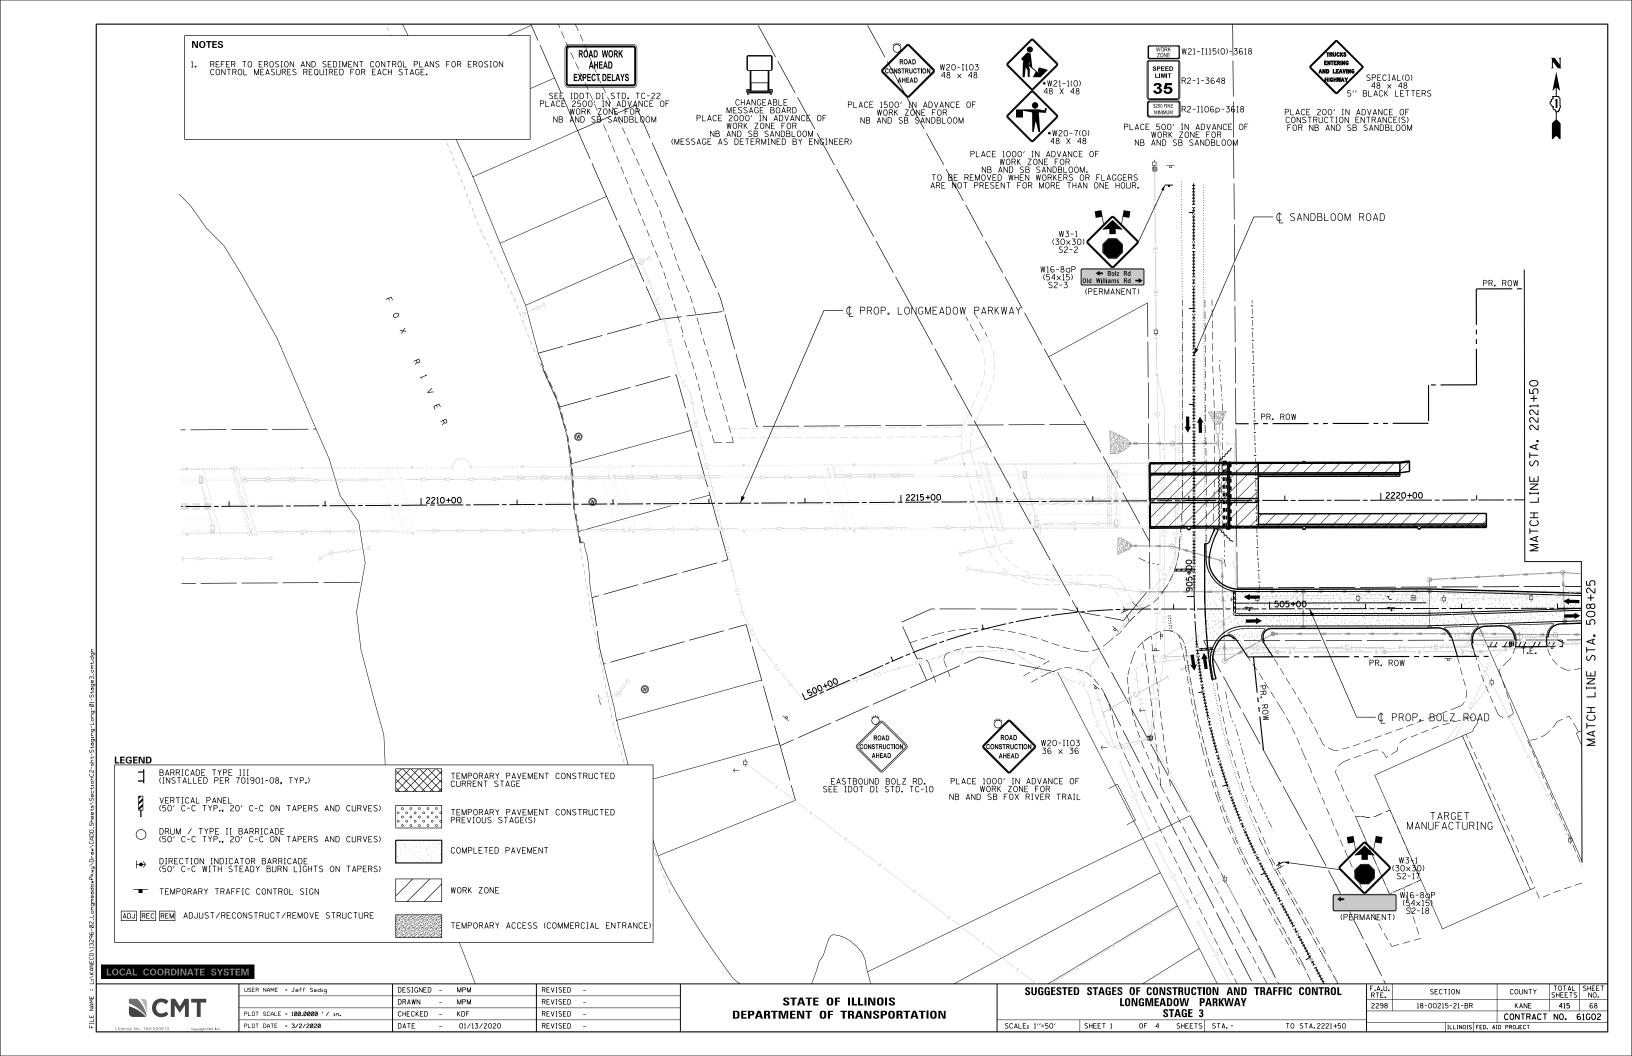


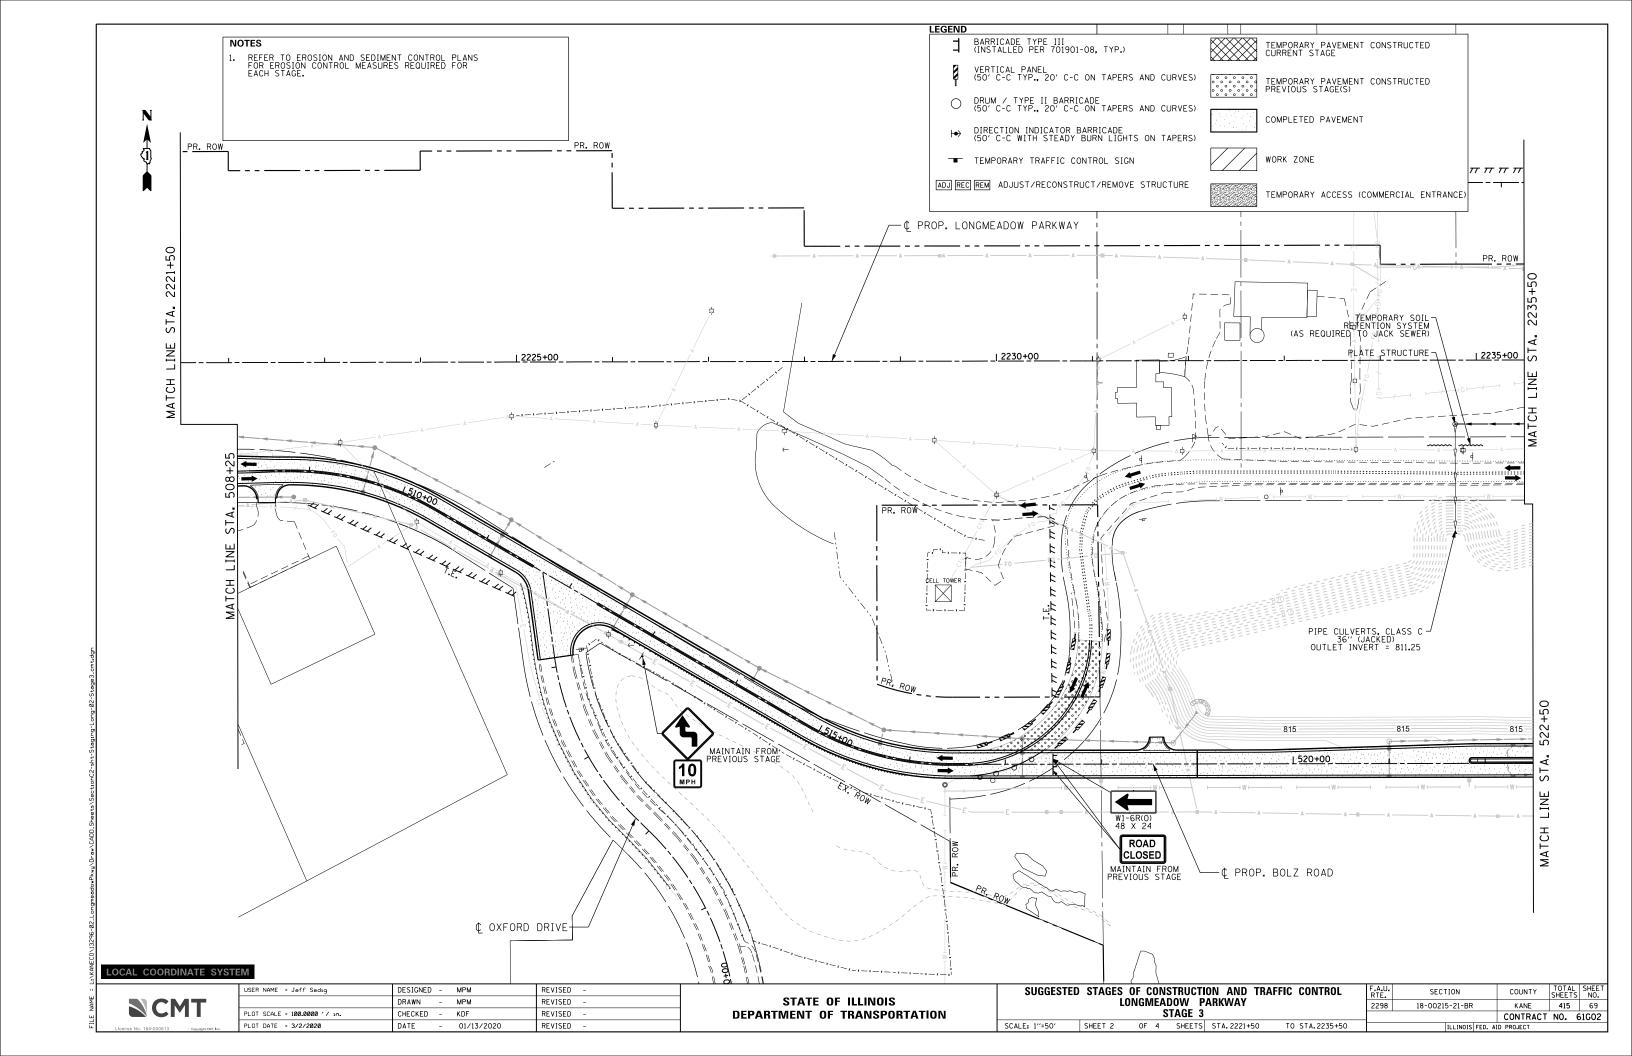


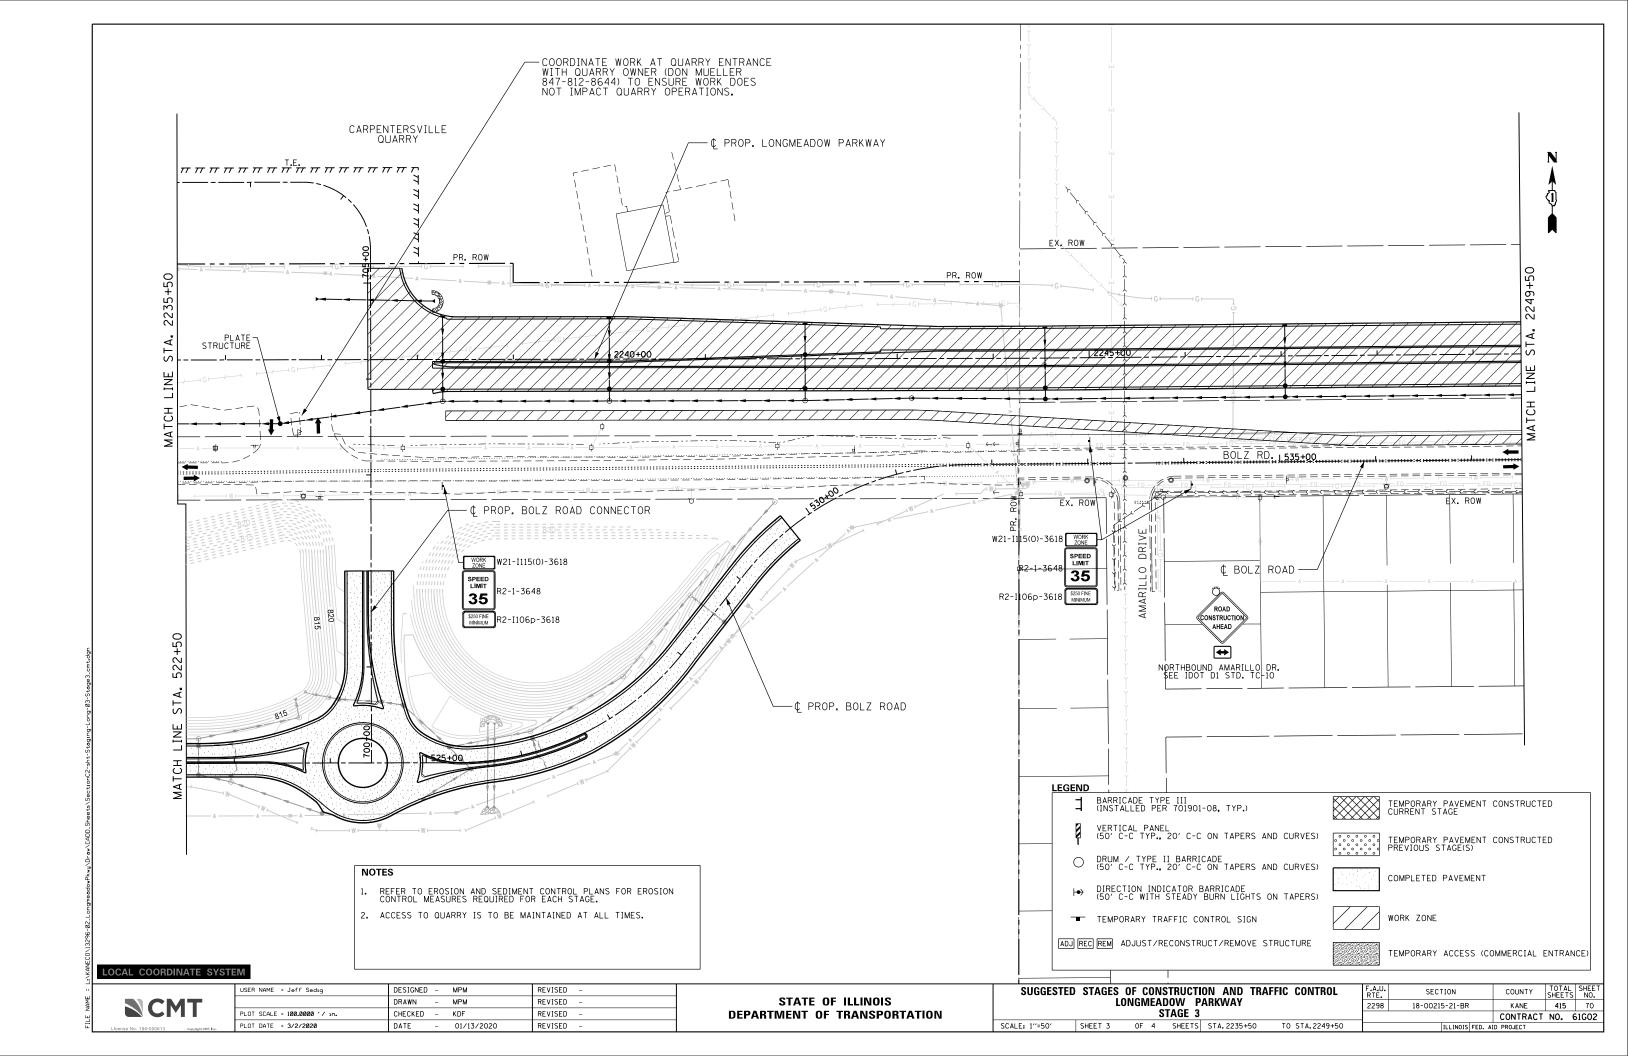


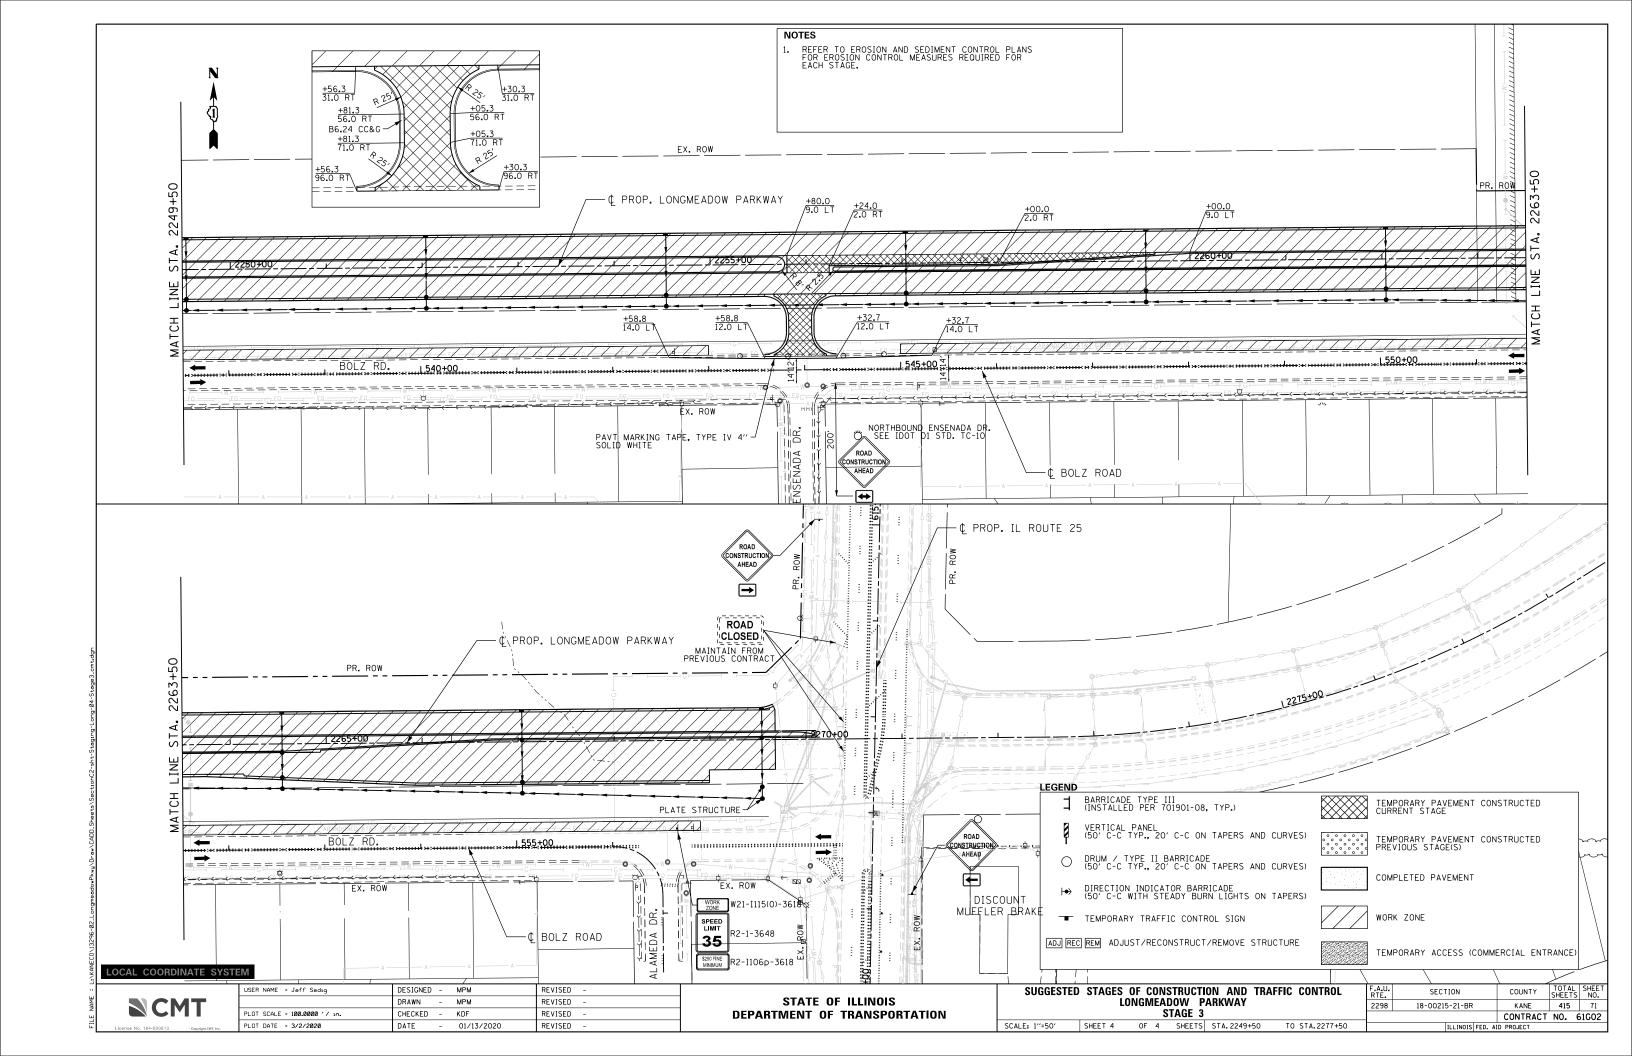


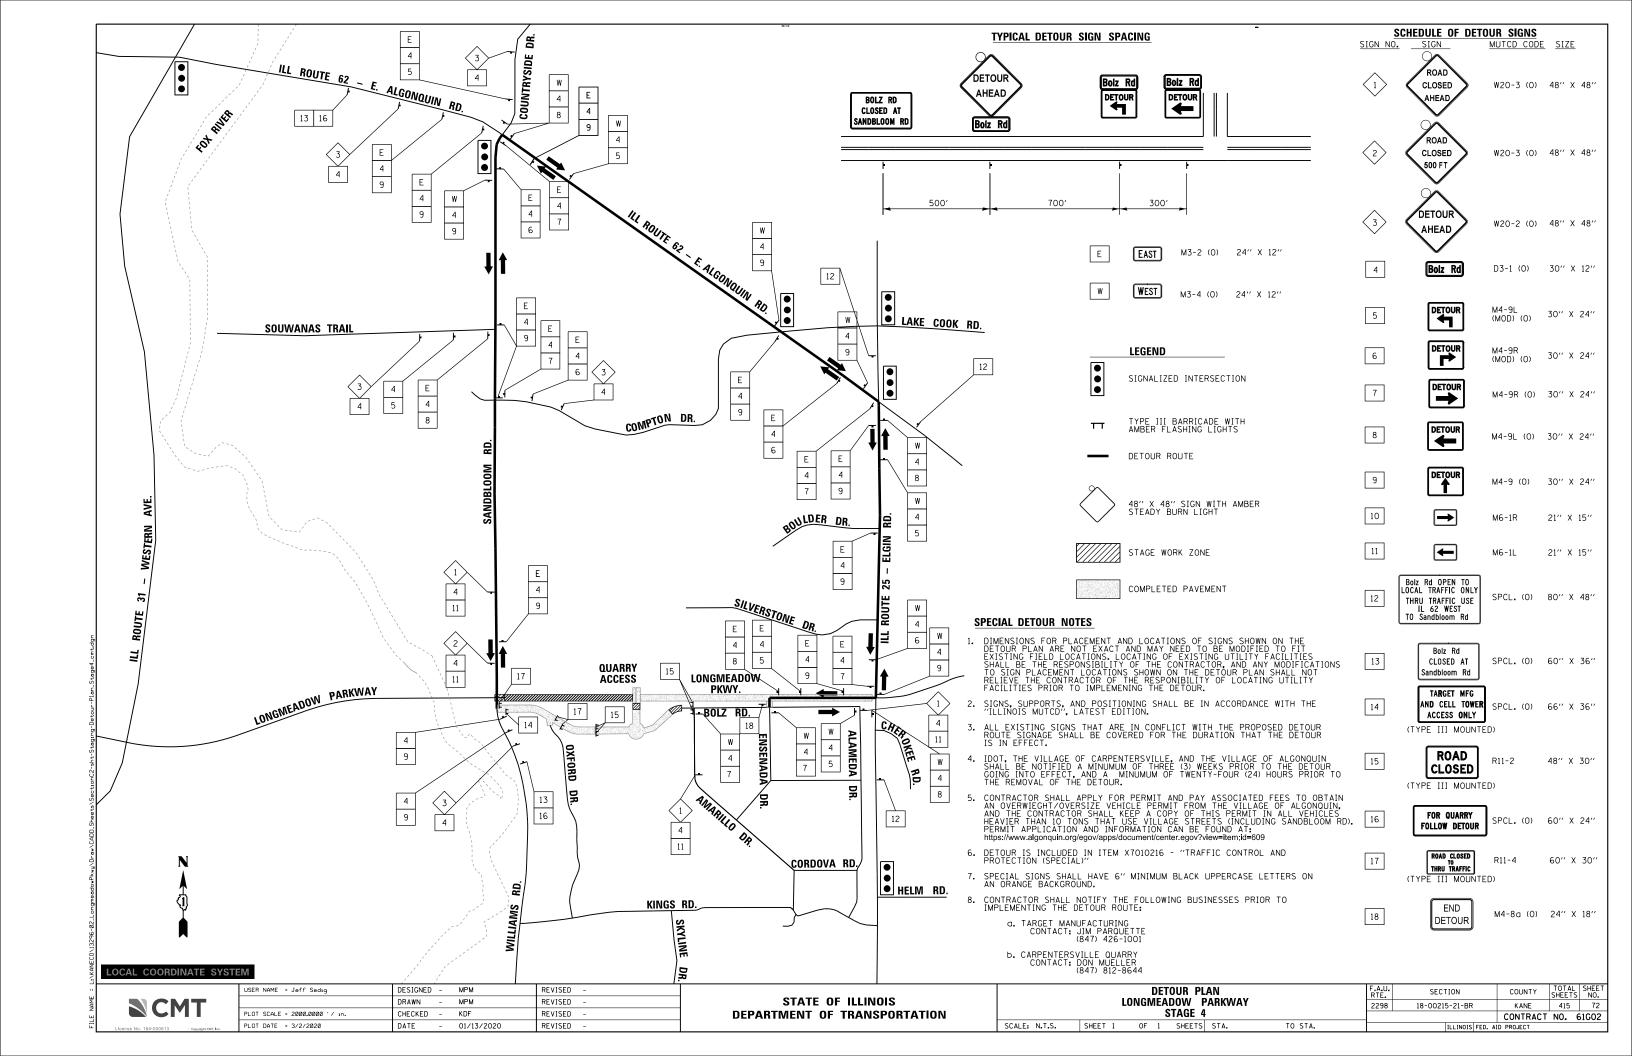


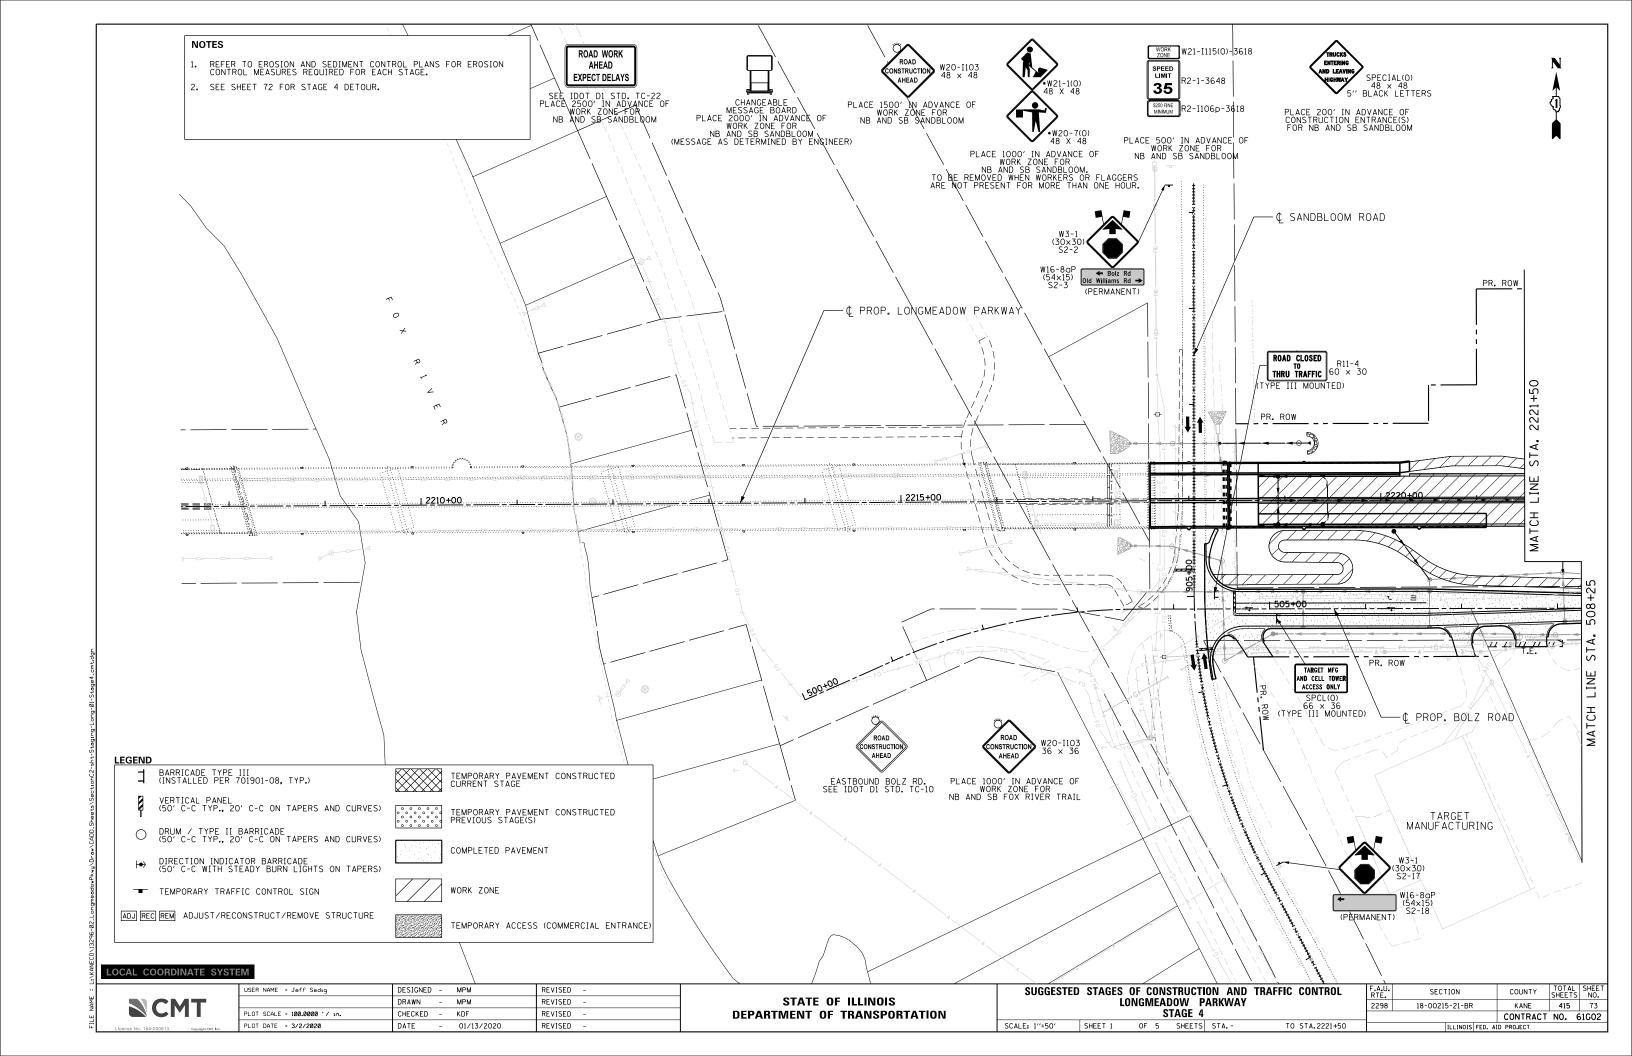


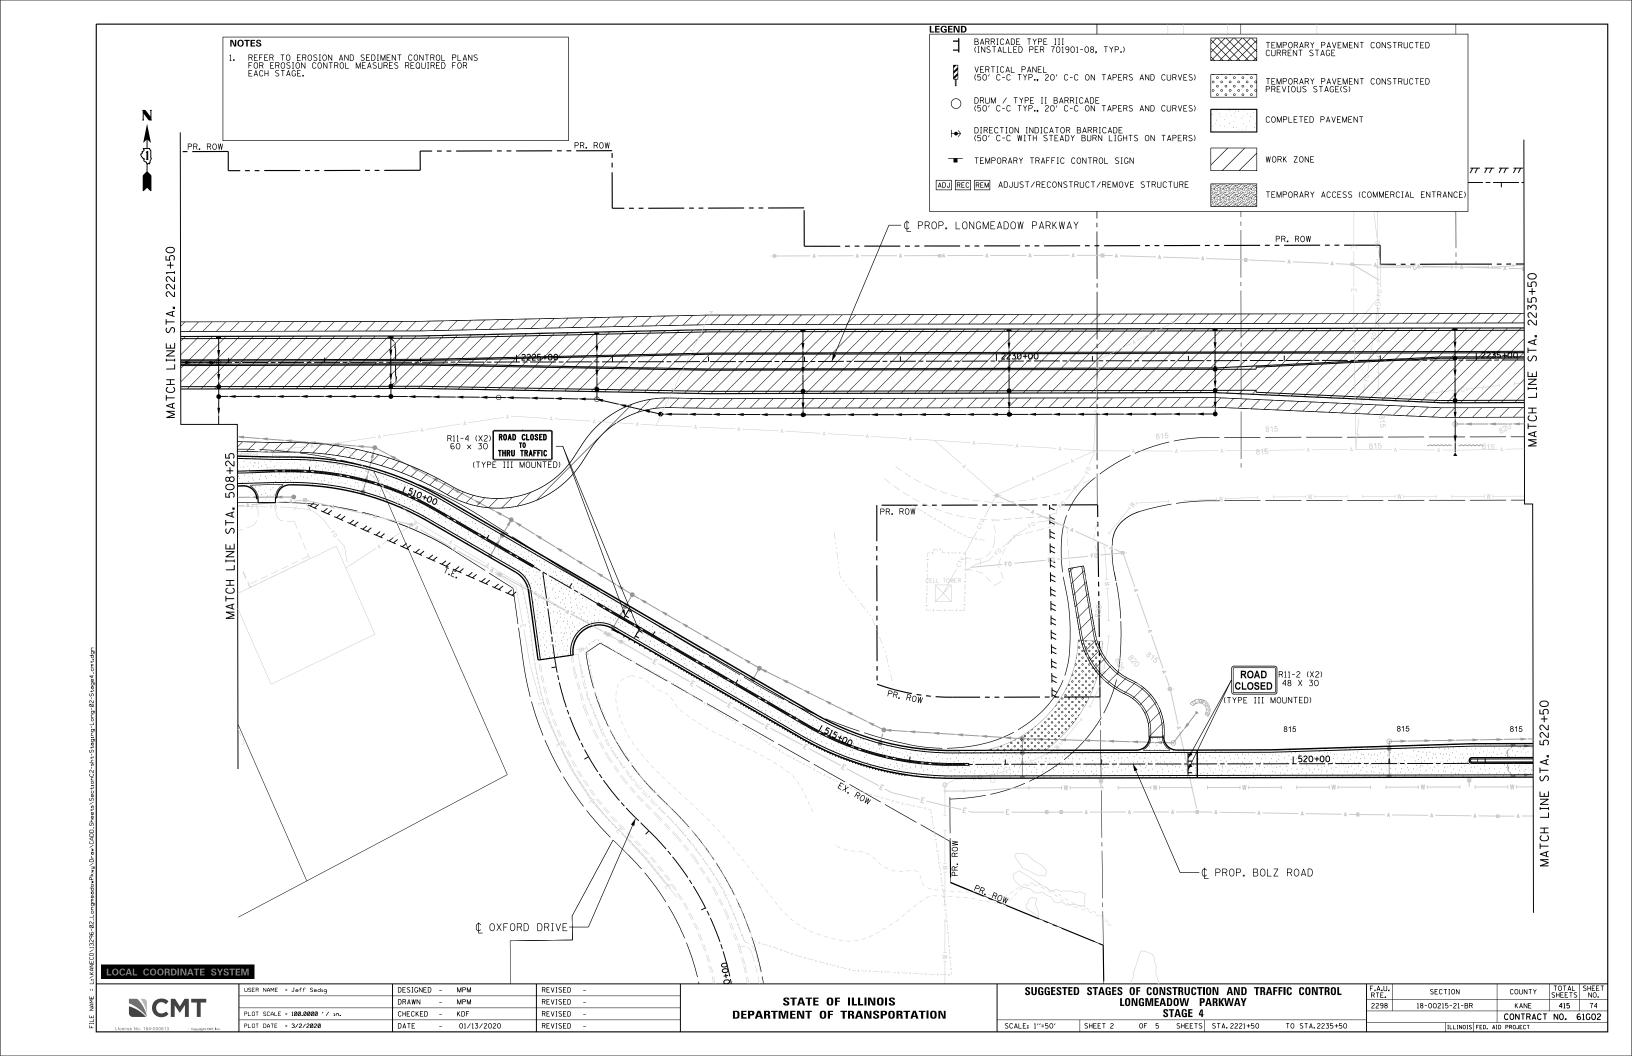


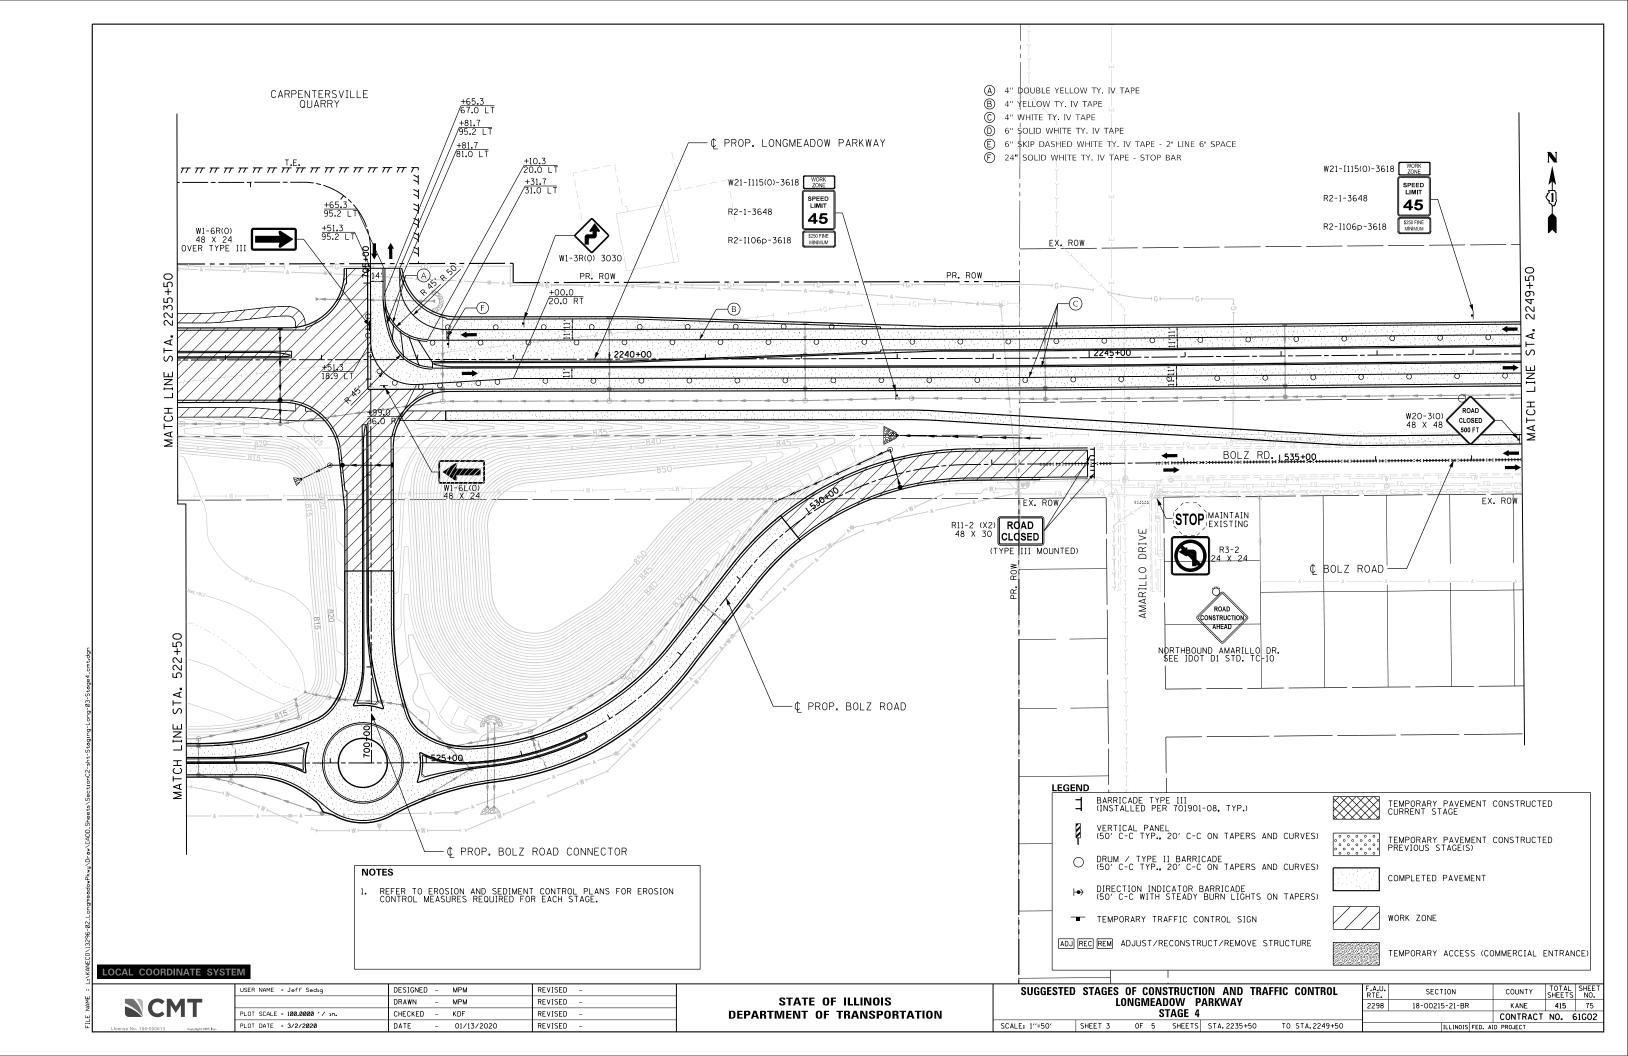


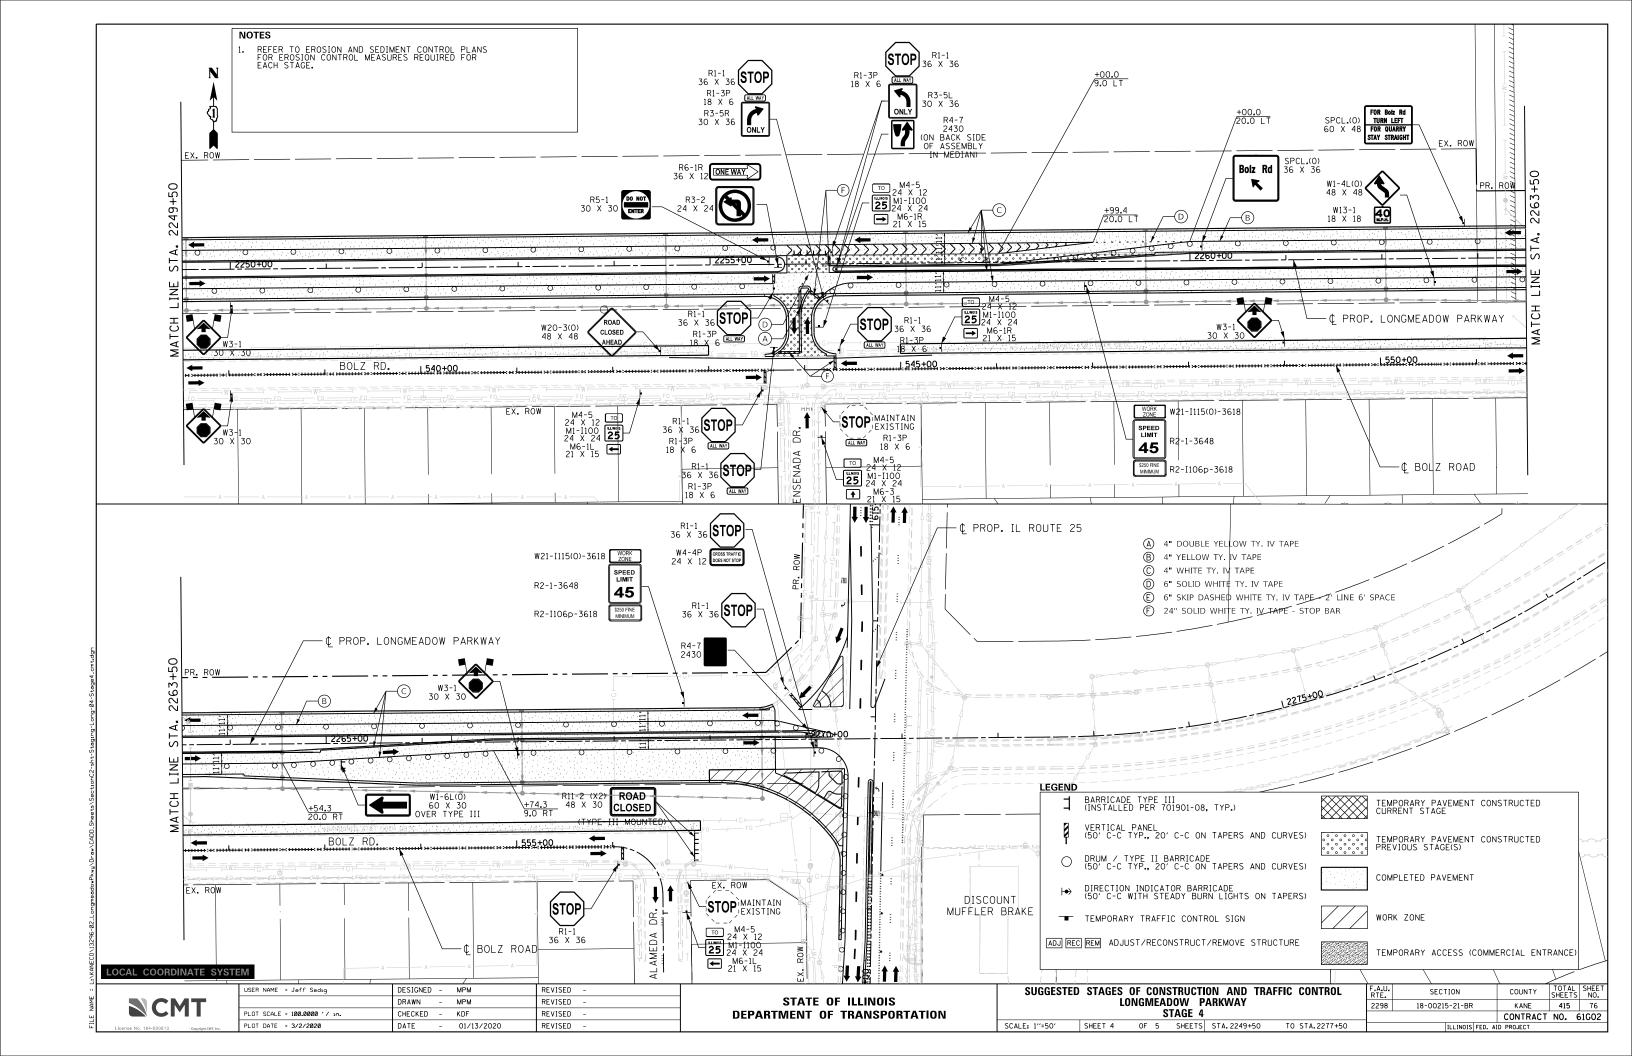


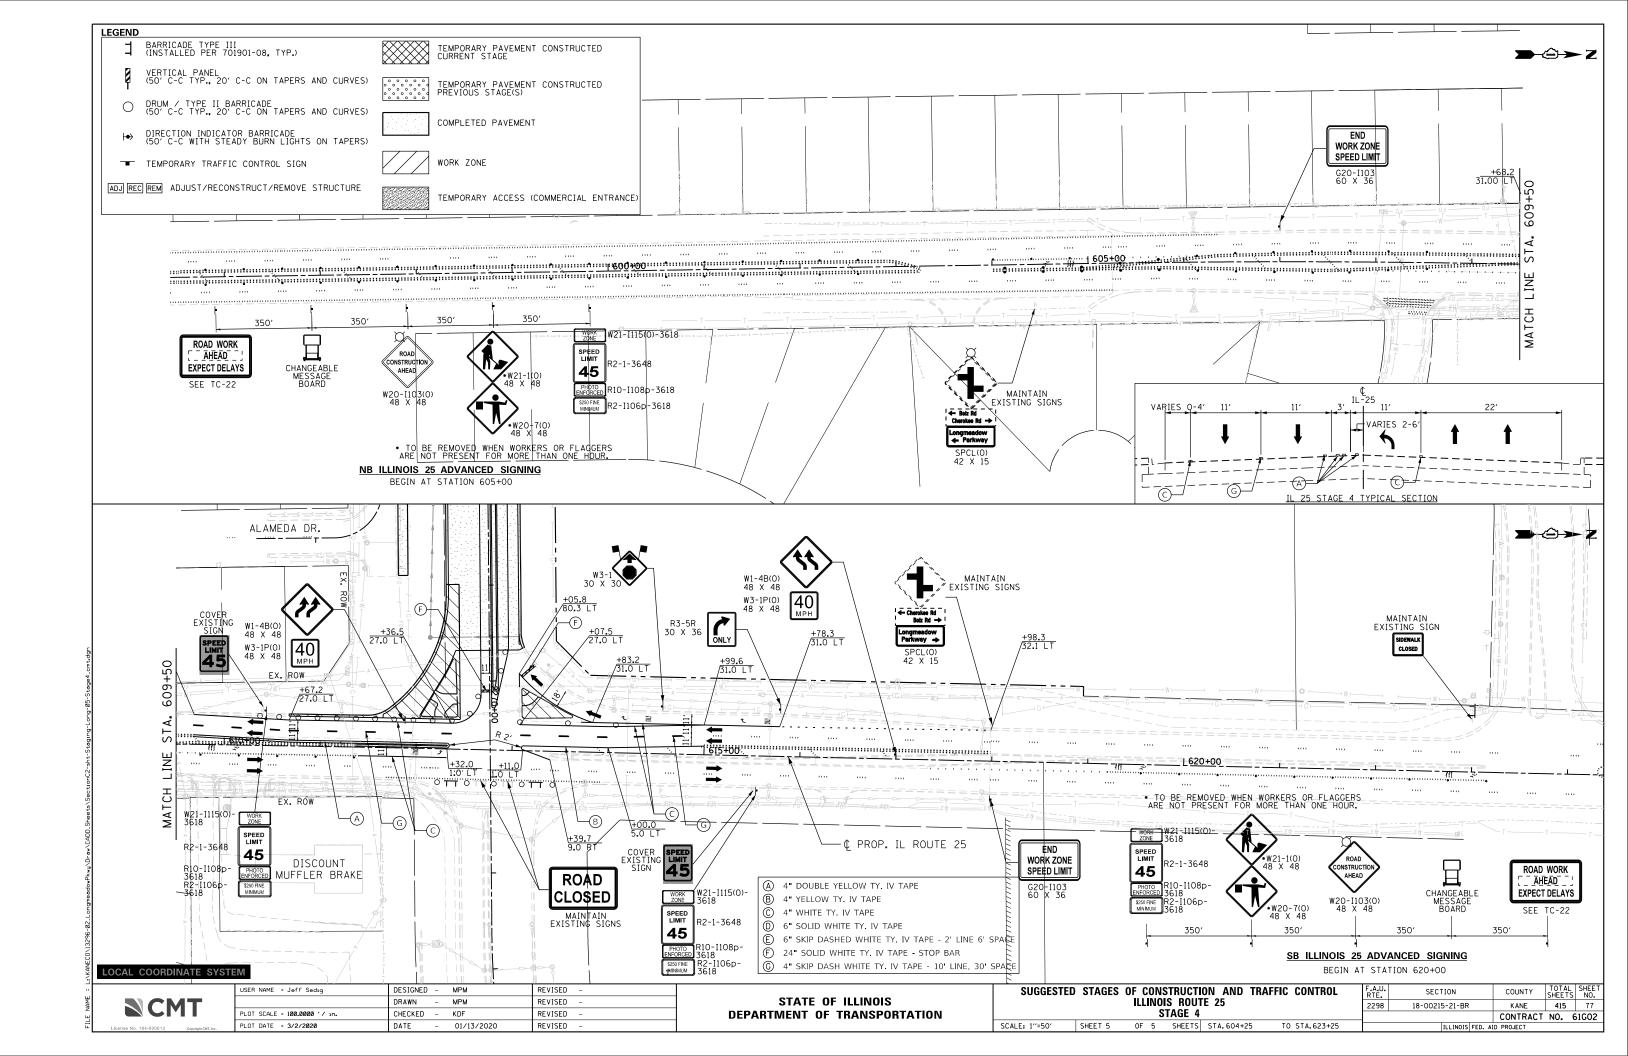


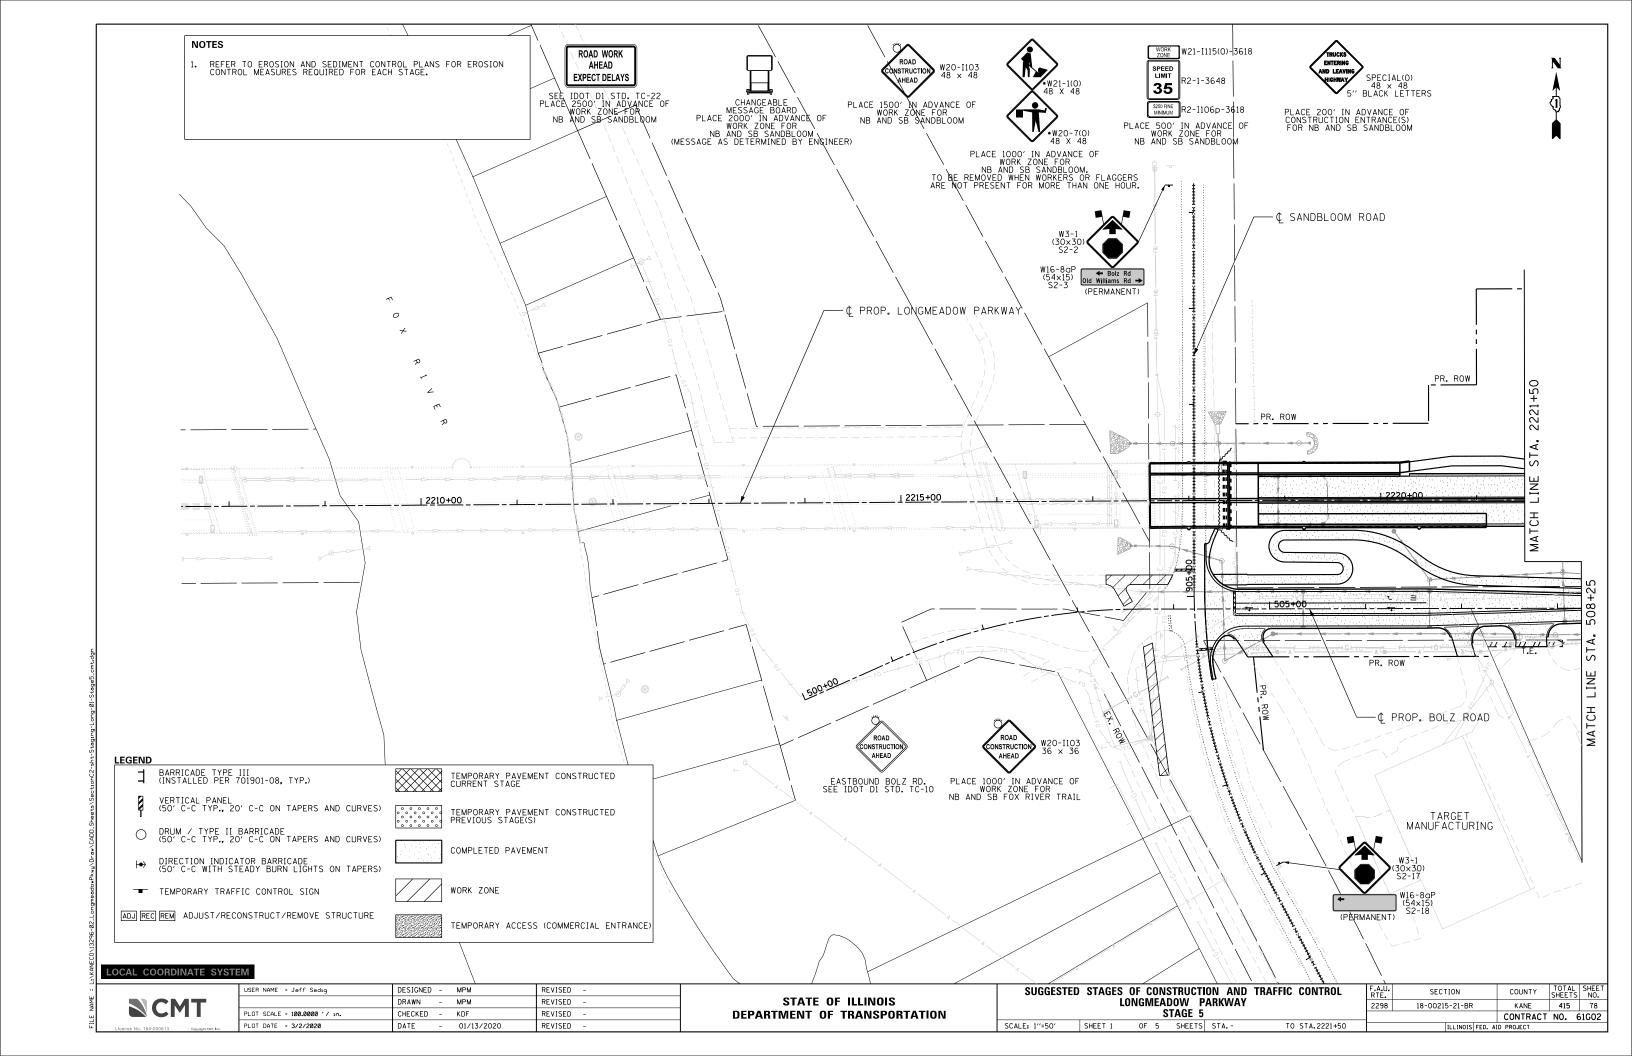

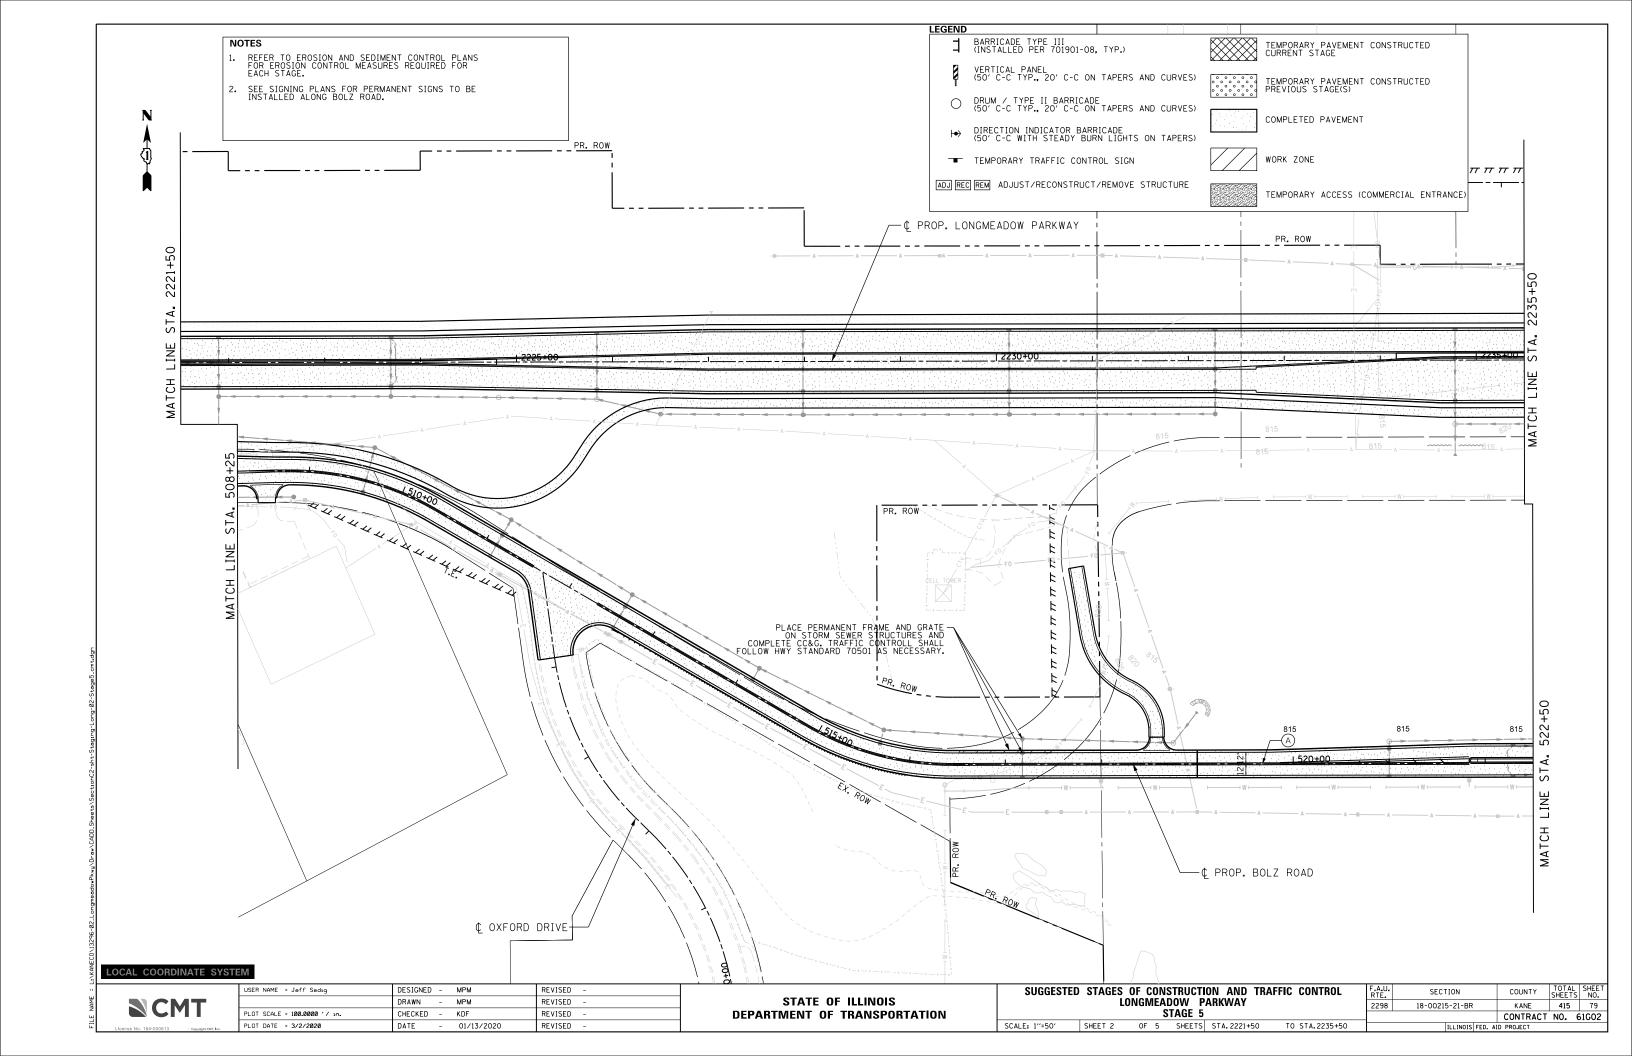

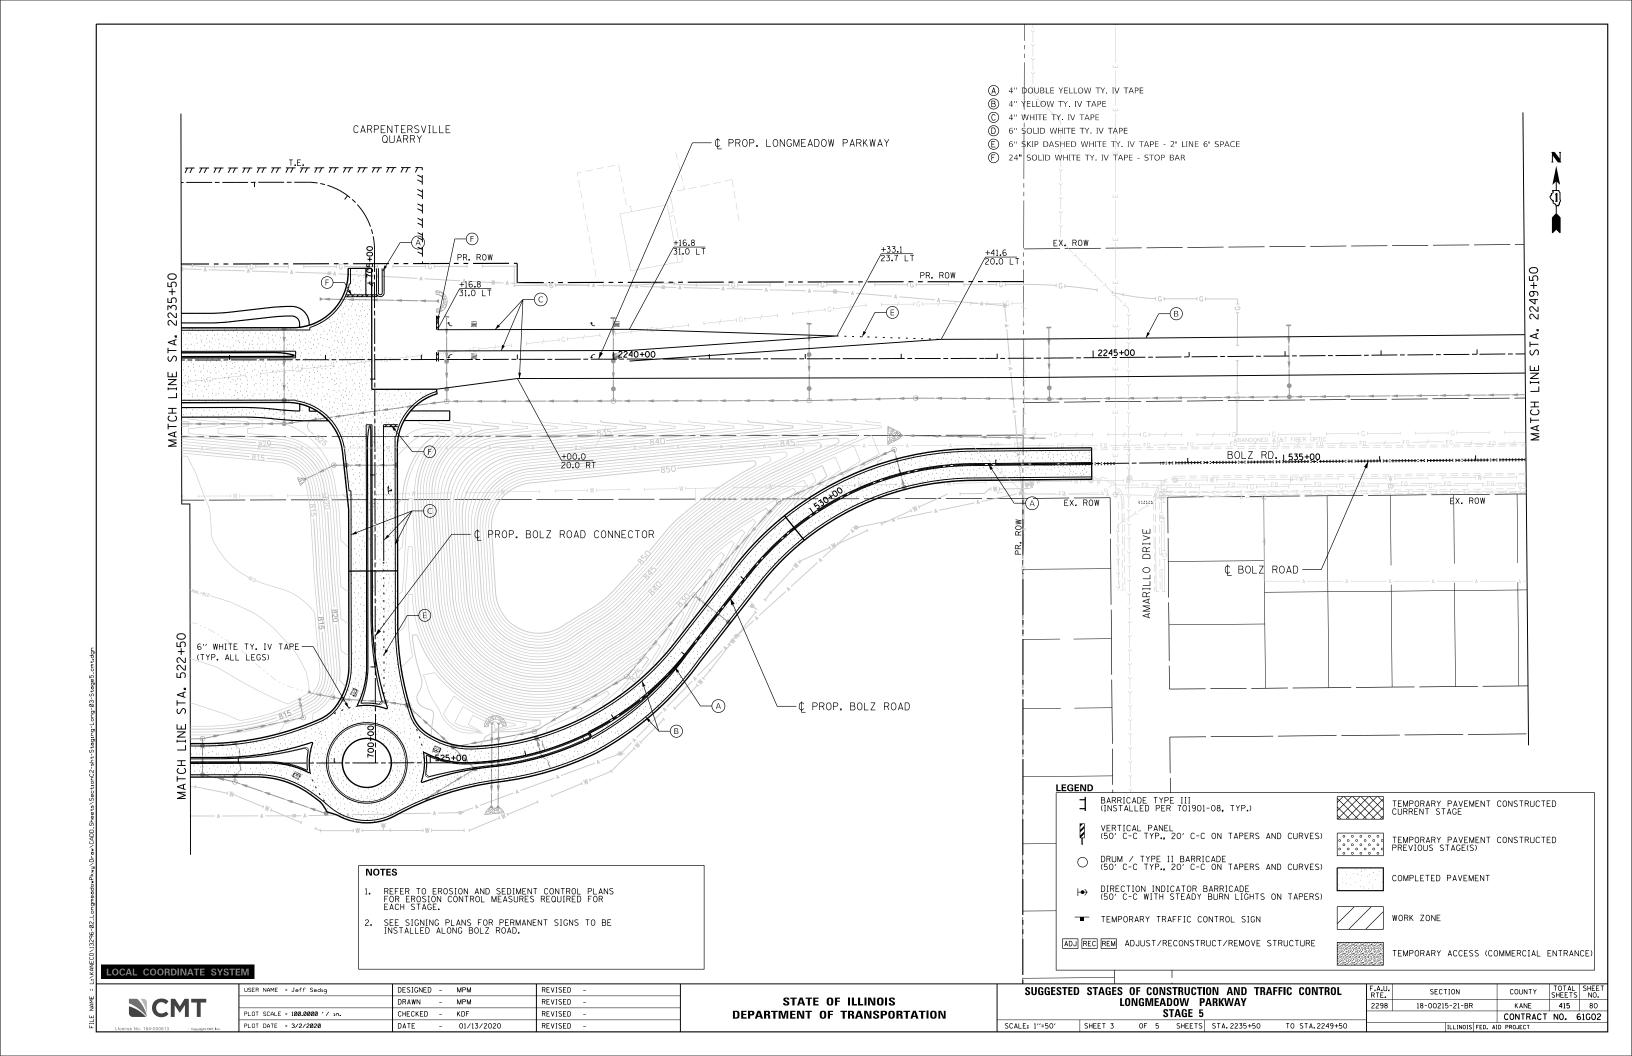


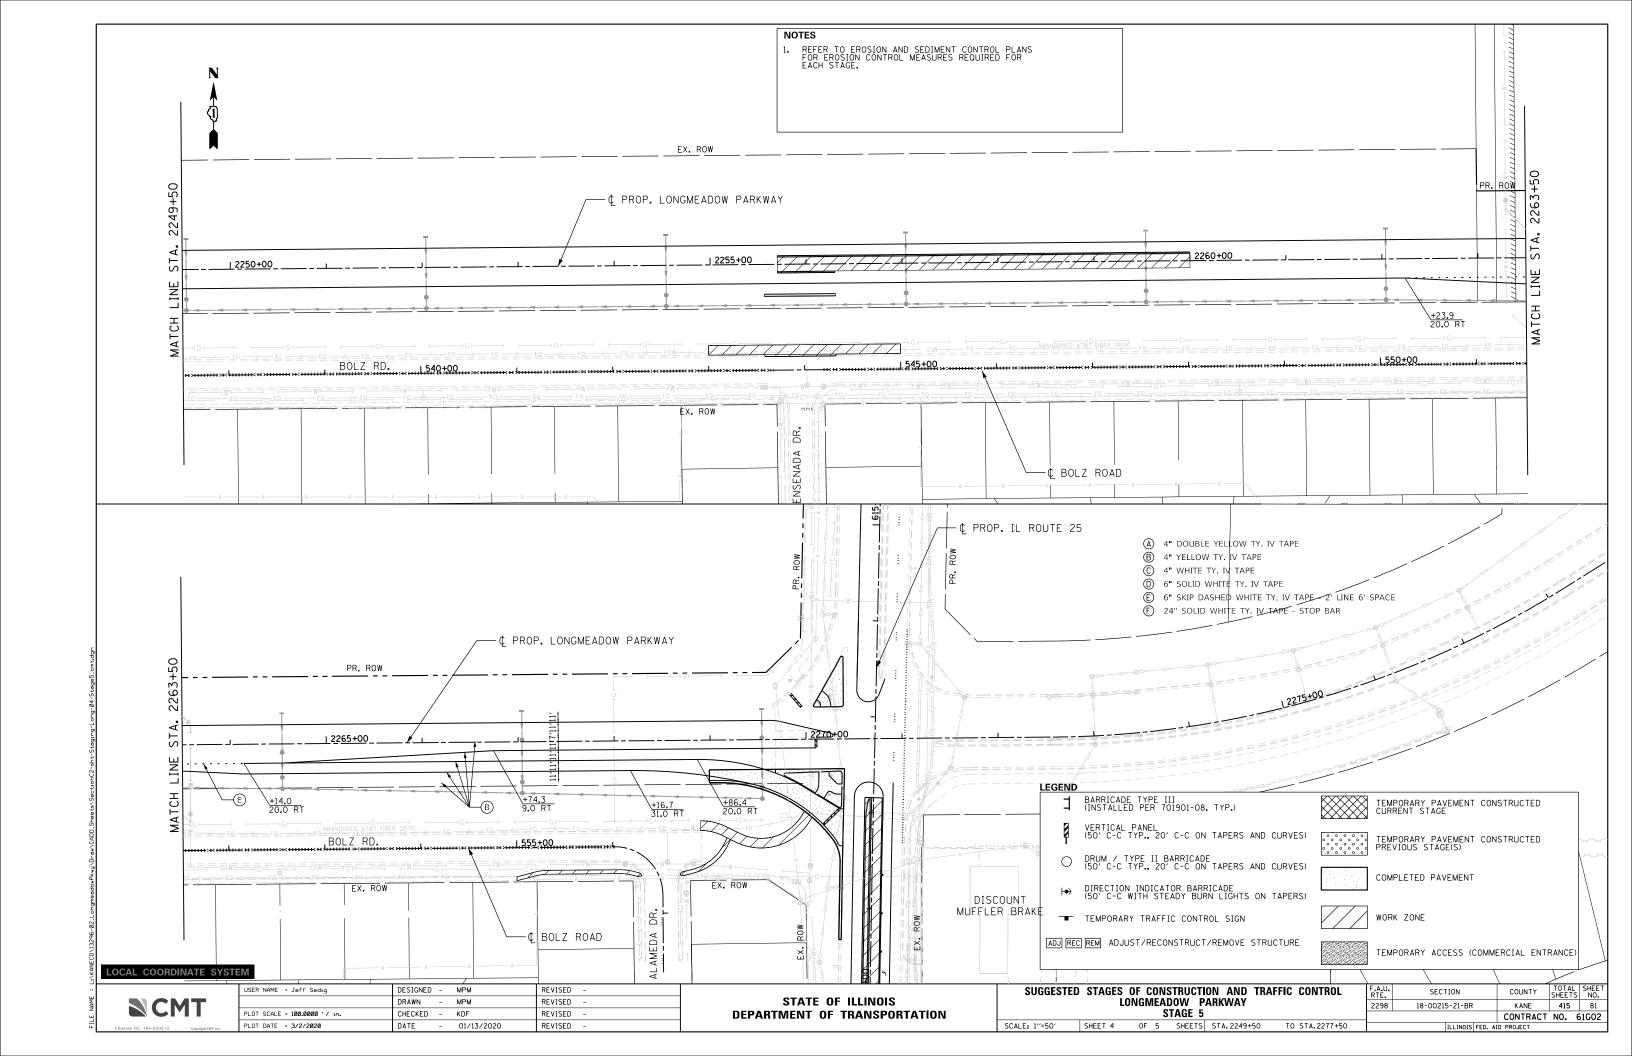

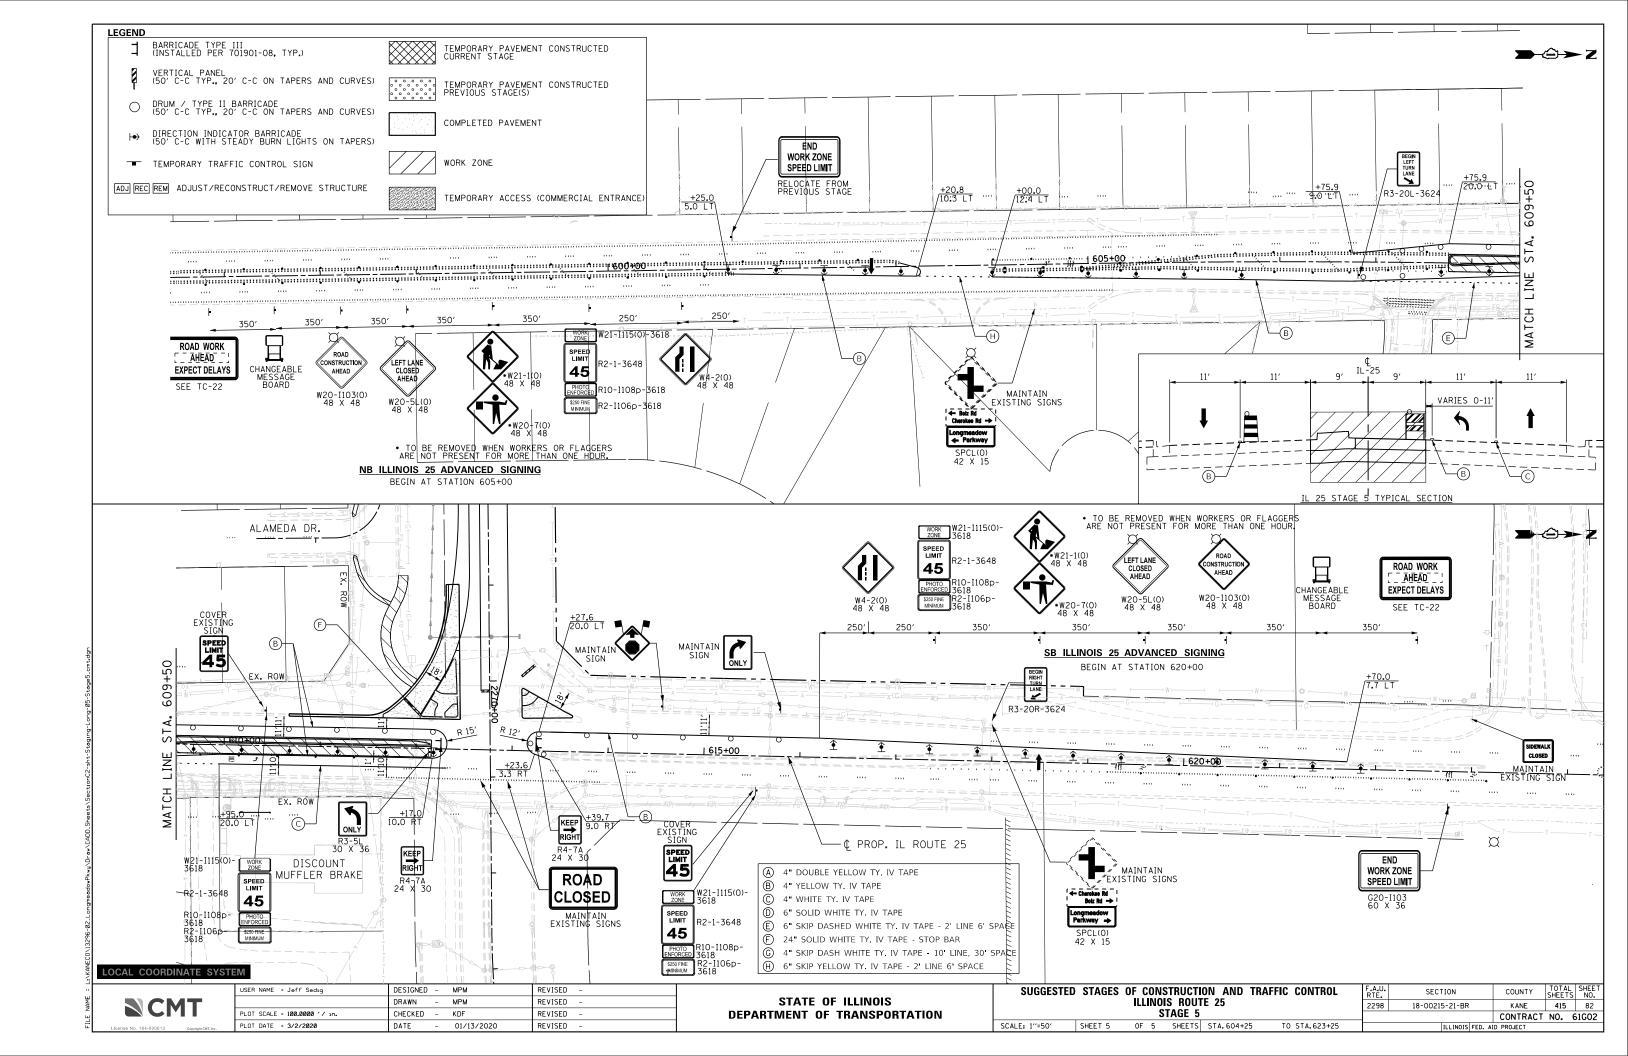

N CMT



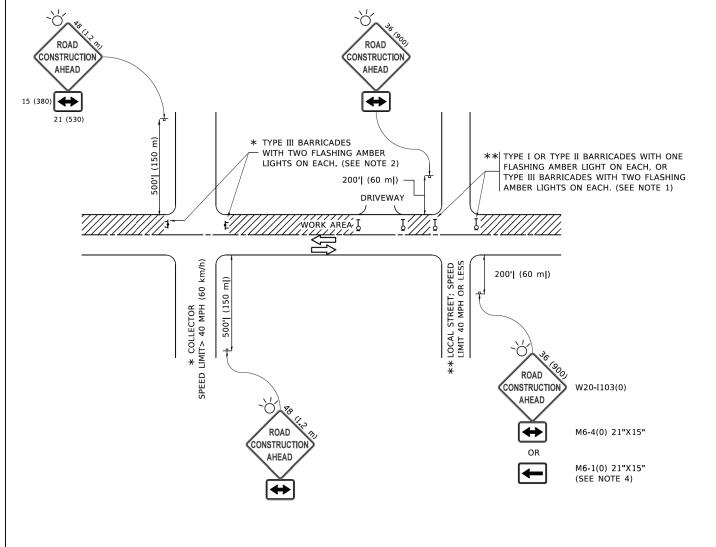

NOTES:

- 1. SIDE ROAD WITH A SPEED LIMIT OF 40 MPH (60 km/h) OR LESS AS SHOWN ON THE DRAWING AND AS DIRECTED BY THE ENGINEER:
- a) ONE "ROAD CONSTRUCTION AHEAD" SIGN 36 x 36 (900x900) WITH A FLASHER MOUNTED ON IT APPROXIMATELY 200' (60 m) IN ADVANCE OF THE MAIN ROUTE.
- b) THE CLOSED PORTION OF THE MAIN ROUTE SHALL BE PROTECTED BY BLOCKING WITH TYPE I, TYPE II OR TYPE III BARRICADES, 1/3 OF THE CROSS SECTION OF THE CLOSED PORTION.
- 2. SIDE ROAD WITH A SPEED LIMIT GREATER THAN 40 MPH (60 km/h) AS SHOWN ON THE DRAWING AND AS DIRECTED BY THE ENGINEER:
- a) ONE "ROAD CONSTRUCTION AHEAD" SIGN 48 x 48 (1.2 m x 1.2 m) WITH A FLASHER MOUNTED ON IT APPROXIMATELY 500' (150 m) IN ADVANCE OF THE MAIN POLITE
- THE CLOSED PORTION OF THE MAIN ROUTE SHALL BE PROTECTED BY
 b) BLOCKING WITH TYPE III BARRICADES, 1/2 OF THE CROSS SECTION
 OF THE CLOSED PORTION.
- 3. CONES MAY BE SUBSTITUTED FOR BARRICADES OR DRUMS AT HALF THE SPACING DURING DAY OPERATIONS. CONES SHALL BE A MINIMUM OF 28 (710)
- WHEN THE SIDE ROAD LIES BETWEEN THE BEGINNING OF THE MAINLINE
 4. SIGNING AND THE WORK ZONE, A SINGLE HEADED ARROW (M6-1) SHALL
 BE USED IN LIEU OF THE DOUBLE HEADED ARROW (M6-4).

- WHEN WORK IS BEING PERFORMED ON A SIDE ROAD OR DRIVEWAY, FOLLOW THE APPLICABLE STANDARD(S). THE DIRECTIONAL ARROW (M6-1 OR M6-4) SHALL BE COVERED OR REMOVED WHEN NO LONGER CONSISTENT WITH THE TRAFFIC CONTROL SET-UP.
- 6. ADVANCE WARNING SIGNS ARE TO BE OMITTED ON DRIVEWAYS UNLESS OTHERWISE SPECIFIED IN THE PLANS OR BY THE ENGINEER
- THE TRAFFIC CONTROL AND PROTECTION FOR SIDE ROADS, INTERSECTIONS, AND DRIVEWAYS SHALL BE INCLUDED IN THE COST OF SPECIFIED TRAFFIC CONTROL STANDARDS OR ITEMS.

All dimensions are in inches (millimeters) unless otherwise shown.

STATE OF ILLINOIS
DEPARTMENT OF TRANSPORTATION

TRAFFIC CONTROL AND PROTECTION
SIDE ROADS, INTERSECTIONS, AND DR


TRAFFIC CONTROL AND PROTECTION FOR RTE.

SIDE ROADS, INTERSECTIONS, AND DRIVEWAYS

SHEET 1 OF 1 SHEETS STA. TO STA.

ı		ILLINOIS FED.	ΑI	D PROJECT		
_		TC-10	CONTRACT	NO. 6	51G0	
ı	2298	18-00215-21-BR	KANE 415		83	
	F.A.U. RTE.	SECTION	COUNTY	TOTAL SHEETS	SHE	

TURN BAY ENTRANCE AT START OF LANE CLOSURE TAPER

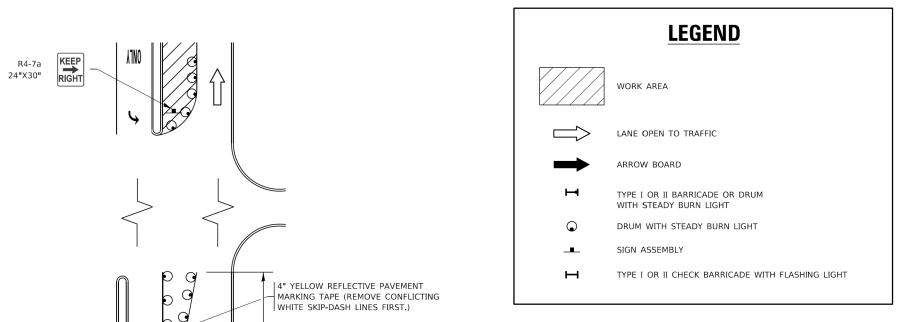


NOTES:

- A) WHEN "L" IS ≤ THE STORAGE LENGTH OF THE TURN LANE (AS SHOWN IN FIG. 1), USE FIGURE 1.
 - B) WHEN "L" IS > THE STORAGE LENGTH OF THE TURN LANE OR THE TURN LANE IS WITHIN THE LANE CLOSURE. USE FIGURE 2.
- 2. CONES MAY BE SUBSTITUTED FOR BARRICADES OR DRUMS AT HALF THE SPACING DURING DAY OPERATIONS. CONES SHALL BE A MINIMUM OF 28 (710) IN HEIGHT
- 3. LIGHTS WILL NOT BE REQUIRED ON BARRICADES OR DRUMS FOR DAY OPERATIONS. ALL LIGHTS SHALL BE MONODIRECTIONAL.
- 4. REFLECTIVE TEMPORARY PAVEMENT MARKINGS SHALL BE PLACED THROUGHOUT THE BARRICADED AREAS OF EACH TURN BAY AS SHOWN WHERE THE CLOSURE TIME IS GREATER THAN FOURTEEN (14) DAYS.
- 5. THIS APPLICATION ALSO APPLIES WHEN WORK IS BEING PERFORMED IN THE RIGHT LANE(S) AND THE RIGHT TURN BAY IS TO REMAIN OPEN. UNDER THIS CONDITION, "RIGHT TURN LANE" R3-I100R 24 x 24 (600 x 600) AND M6-2R 21 x 15 (530 x 380) SHALL BE USED.
- 6. THESE CONTROLS SHALL SUPPLEMENT MAINLINE TRAFFIC CONTROL FOR LANE CLOSURES.
- 7. THE SIGNS SHALL BE MOUNTED ABOVE THE BARRICADES/DRUMS ON SEPARATE SIGN SUPPORTS THAT MEET NCHRP 350 OR MASH PREQUIREMENTS.
- 8. TRAFFIC CONTROL AND PROTECTION AT TURN BAYS (TO REMAIN OPEN TO TRAFFIC) SHALL BE INCLUDED IN THE COST OF SPECIFIED TRAFFIC CONTROL STANDARDS OR ITEMS.

STATE OF ILLINOIS

TURN BAY ENTRANCE WITHIN A LANE CLOSURE

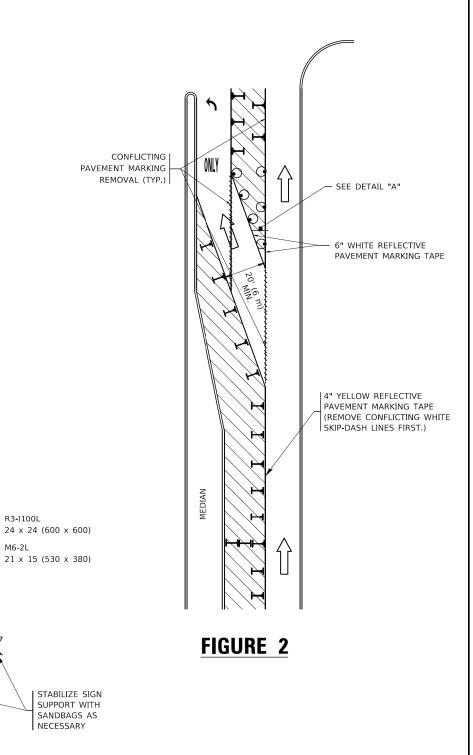

DETAIL A

TURN

LANE

All dimensions are in inches (millimeters) unless otherwise shown.

TRAFFIC CONTROL AND PROTECTION AT TURN BAYS (TO REMAIN OPEN TO TRAFFIC) **DEPARTMENT OF TRANSPORTATION** SCALE: NONE SHEET 1 OF 1 SHEETS STA.

SECTION KANE 415 84 2298 18-00215-21-BR CONTRACT NO. 61GO2 TC-14

FIGURE 1

ESERNAME ≈ Jeoft€nfjedig MODEL NAME = Default PLOT SECALE = 8.000000 1/ inc. PLOT (DATE = 3/42/2020


SEE DETAIL "A" -

DESIGNED = T. RAMMACHER 09-08-94 REVISED = R. BORO 09-14-09 DRAWN = A. HOUSEH 11-07-95 REVISED = A. SCHUETZE 07-01-13 CHECKED = A. HOUSEH 10-12-96 REVISED = A. SCHUETZE 09-15-16 DATE = T. RAMMACARROO1-06-00 REVISED =


- ARROW BOARD

QUANTITY

4 (100) LINE = 45.5 ft. (13.9 m) 15.2 sq. ft. (1.41 sq. m)

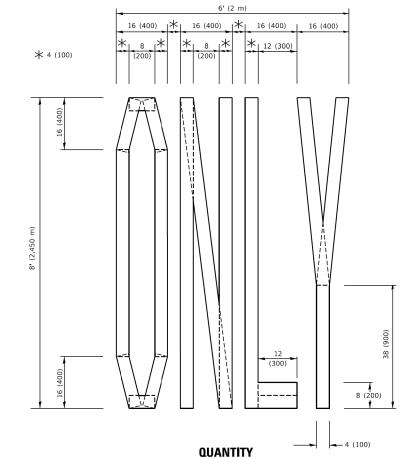

4 (100) LINE = 64.1 ft. (19.5 m) 21.4 sq. ft. (1.99 sq. m)

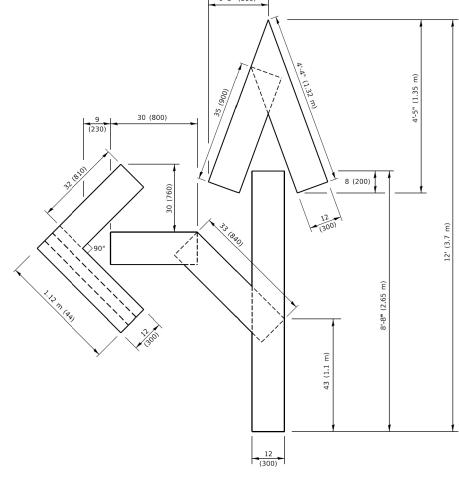


QUANTITY

4 (100) LINE = 82.5 ft. (25.1 m) 27.5 sq. ft. (2.53 sq. m)

NOTE:

ALL QUANTITIES OF PLACEMENT ARE REPRESENTED IN LINEAR FEET OF 4" LINES TO MATCH THE 4" TEMPORARY TAPE PAY ITEM AND REPRESENTS THE TOTAL QUANTITY OF 4" TAPE REQUIRED.

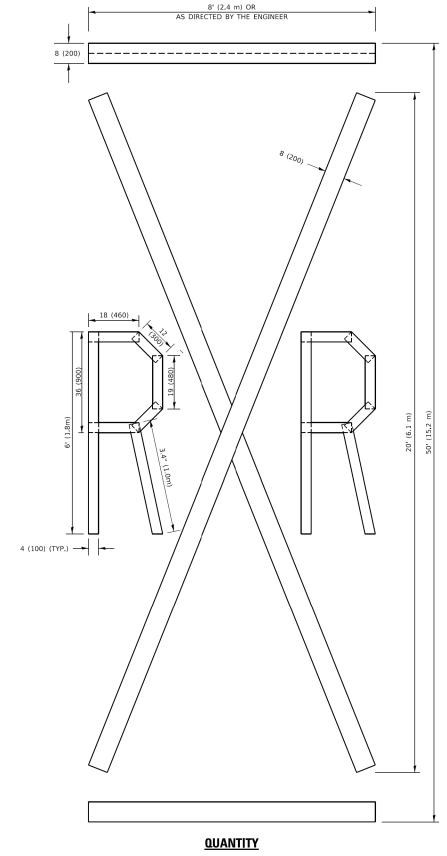

4 (100) LINE = 225.9 ft. (68.9 m)75.3 sq. ft. (6.99 sq. m)

> All dimensions are in inches (millimeters) unless otherwise shown.




BEEFNMAME = JedfenSedig	DESIGNED -	REVISED - T. RAMMACHER 03-02-98
MODEL NAME = Default	DIRAWIN =	REVISED - E. GOMEZ 08-28-00
PILOT SECALE = 3/00008" / im.	CHECKED -	REVISED - E. GOMEZ 08-28-00
PLOT DATE = 3/2/2020	DATE = 09/18/9/020	REVISED = A. SCHUETZE 09-15-16


STATE OF ILLINOIS **DEPARTMENT OF TRANSPORTATION**

SHORT TE	RM	PAVEI	MENT	MARKIN	G LETTER:	S AND	SYMBOLS	
SCALE: NONE	SHEET	1	OF :	1 SHEETS	STA.		TO STA.	

F.A.U. RTE.	SECT	ION	COUNTY	TOTAL SHEETS	SHEET NO.				
2298	18-0021	5-21-BR	KANE	415	85				
	TC-16		CONTRACT	NO. 6	51G02				
	ILLINOIS FED. AID PROJECT								

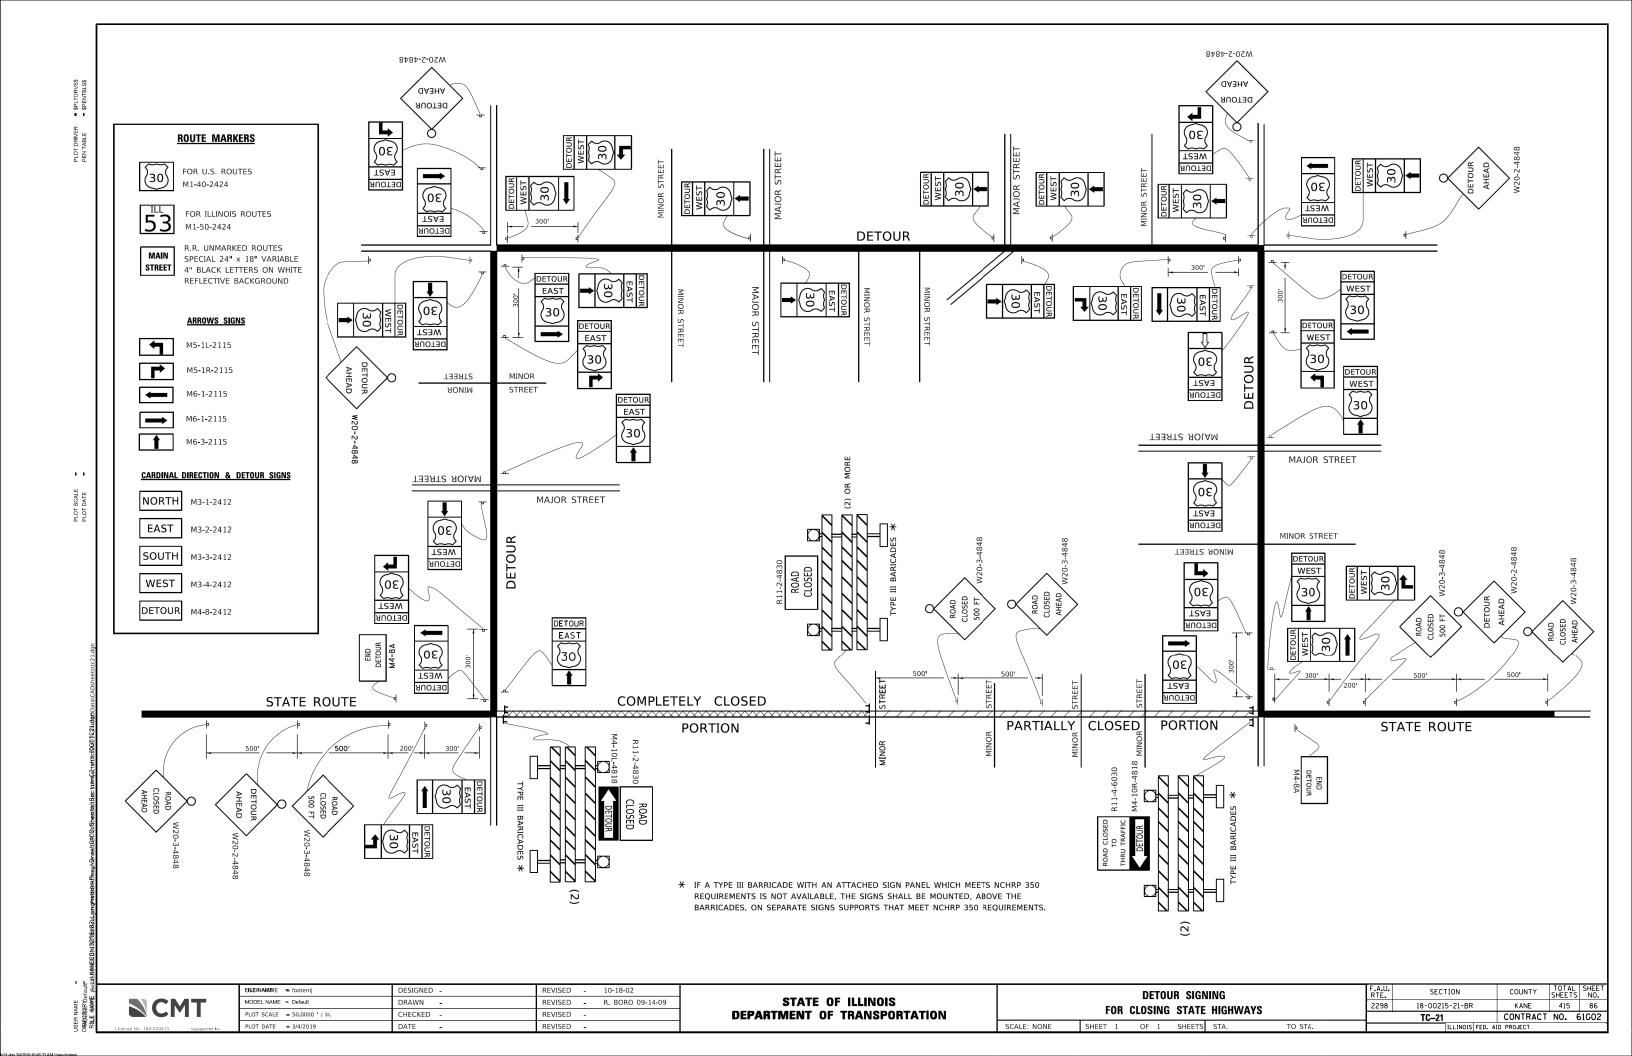

ESERNAME ≈ Jeoft€nfjedig DESIGNED = **REVISED** = R. MIRS 09-15-97 DRAWW = REVISED = R. MIRS 12-11-97 MODEL NAME = Default PILOT SICALE = 3.000000 1/ inc. CHECKEED = REVISED =T. RAMMACHER 02-02-99 DATE = 01/13/2020 PLOT (DATE = 3/42/2020 REVISED = C JUCIUS 01-31-07

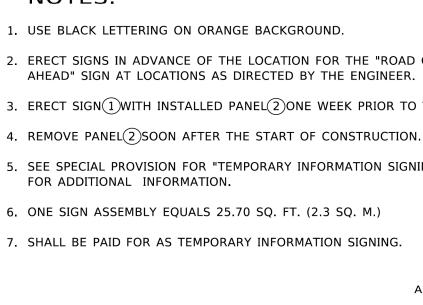

68 (1700) 54 (1350) (175)(175)ROAD WORK 45 (1125) (175) (175) (125) (175) (AHEAD ഥ] **EXPECT DELAYS** USE APPROPRIATE MONTH AND DATE FOR CONTRACT - 1 (25) BLACK **BORDER** MIN. **BEGINS** XXX XX (2.1 58 (1450)

NOTES:

- 1. USE BLACK LETTERING ON ORANGE BACKGROUND.
- 2. ERECT SIGNS IN ADVANCE OF THE LOCATION FOR THE "ROAD CONSTRUCTION AHEAD" SIGN AT LOCATIONS AS DIRECTED BY THE ENGINEER.
- 3. ERECT SIGN(1)WITH INSTALLED PANEL(2)ONE WEEK PRIOR TO THE START OF CONSTRUCTION.
- 5. SEE SPECIAL PROVISION FOR "TEMPORARY INFORMATION SIGNING"
- 6. ONE SIGN ASSEMBLY EQUALS 25.70 SQ. FT. (2.3 SQ. M.)
- 7. SHALL BE PAID FOR AS TEMPORARY INFORMATION SIGNING.

ALL DIMENSIONS ARE IN INCHES (MILLIMETERS) UNLESS OTHERWISE SHOWN.

07475 OF HIMOIO	ARTERIAL ROAD							SECTION	COUNTY	TOTAL SHEETS	SHEET NO.
STATE OF ILLINOIS	INFORMATION SIGN					2298	18-00215-21-BR	KANE	415	87	
DEPARTMENT OF TRANSPORTATION							TC-22	CONTRACT	NO. 6	1G02	
	SCALE: NONE	SHEET 1	OF 1	SHEETS	STA.	TO STA.		ILLINOIS FED. AI	D PROJECT		

3.0" RADIUS, 0.5" BORDER, WHITE ON GREEN; REFLECTORIZED "DRIVEWAY" D; "ENTRANCE" D; STANDARD ARROW CUSTOM 12.0" x 5.0"


NOTES:


- 1. HALF OF THE SIGNS WILL REQUIRE A LEFT HAND FACING ARROW.
- 2. TWO SIGNS SHALL BE USED AT EACH COMMERCIAL ENTRANCE PLACED BACK-TO-BACK: ONE WITH A RIGHT HAND ARROW (SHOWN) SHALL BE PLACED ON THE NEAR RIGHT SIDE THE DRIVEWAY AND ONE WITH A LEFT HAND ARROW SHALL BE PLACED ON THE FAR LEFT SIDE OF THE DRIVEWAY.
- 3. SIGNS TO BE PAID FOR AS ITEM "TEMPORARY INFORMATION SIGNING".


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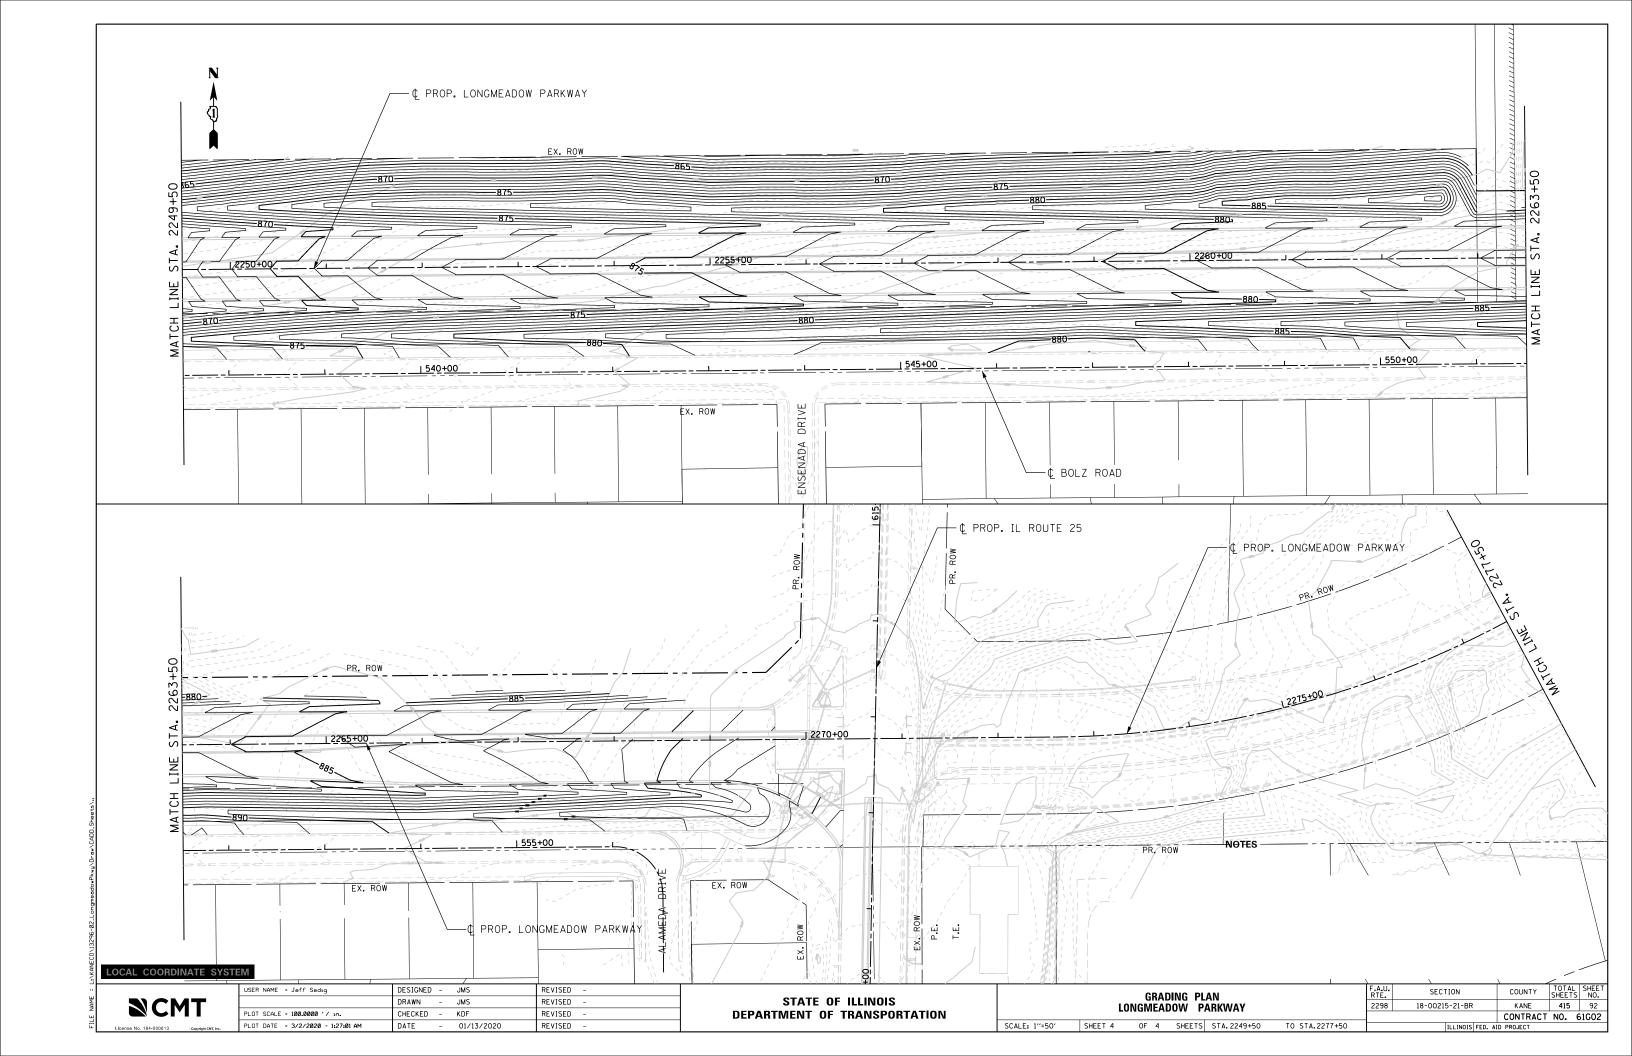
STATE OF ILLINOIS
DEPARTMENT OF TRANSPORTATION

SCALE: NONE



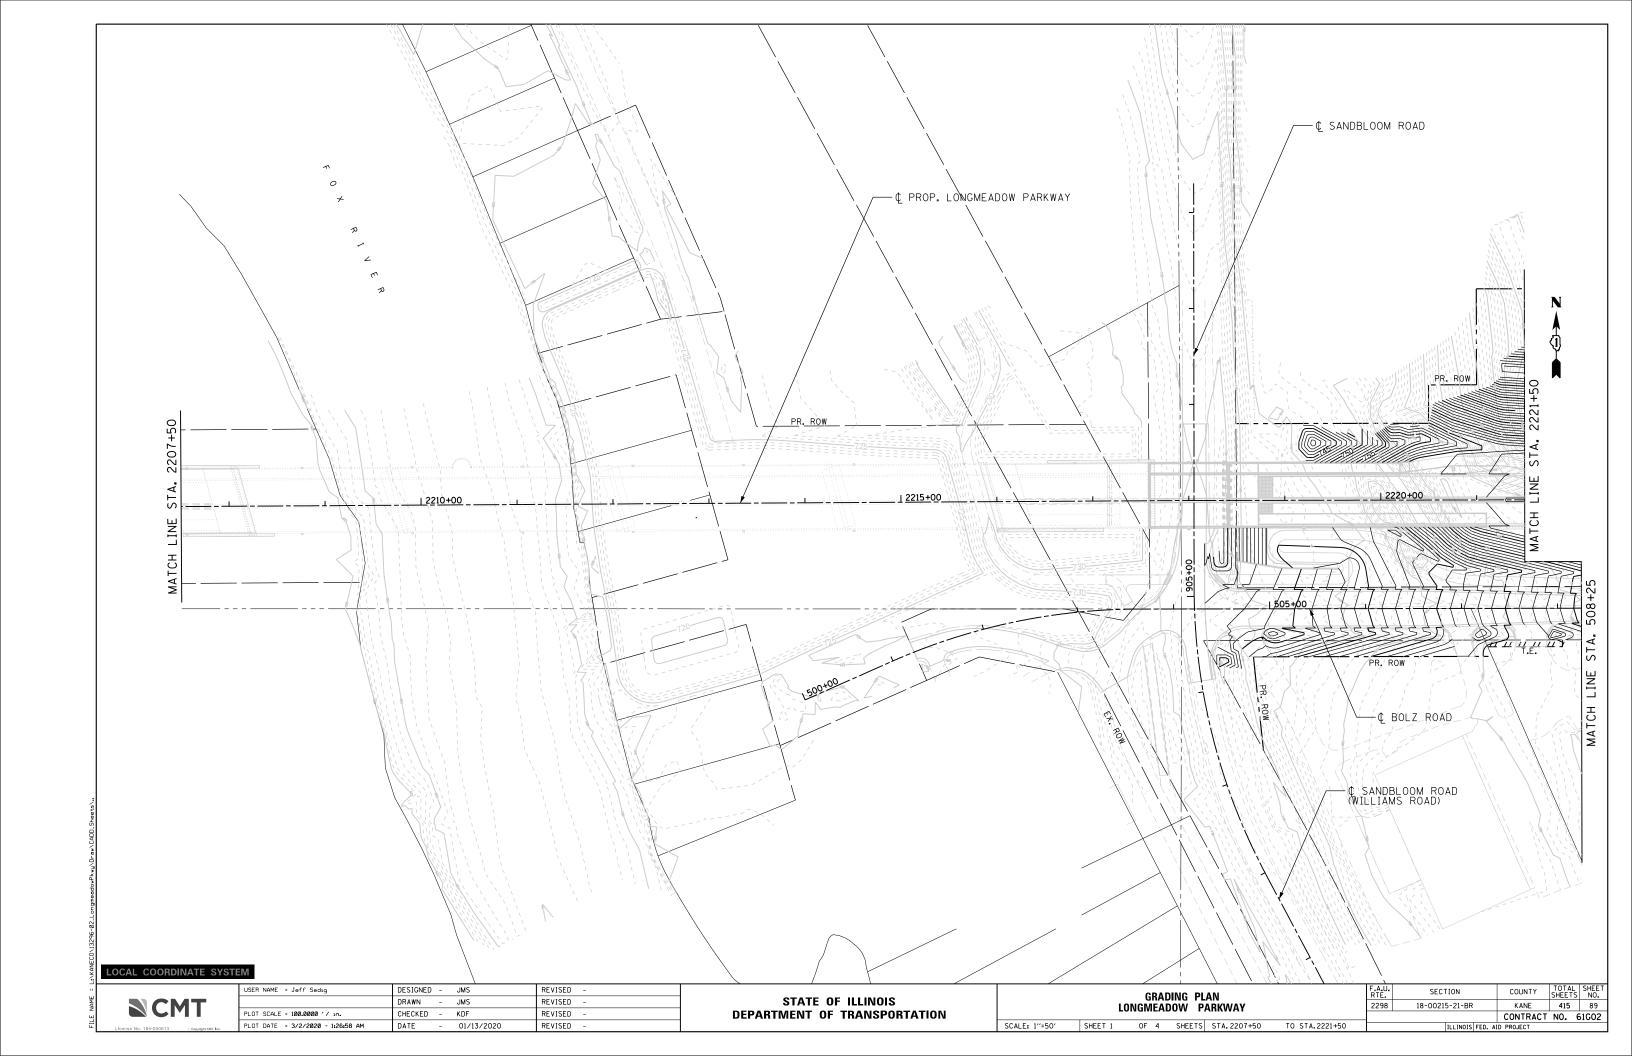

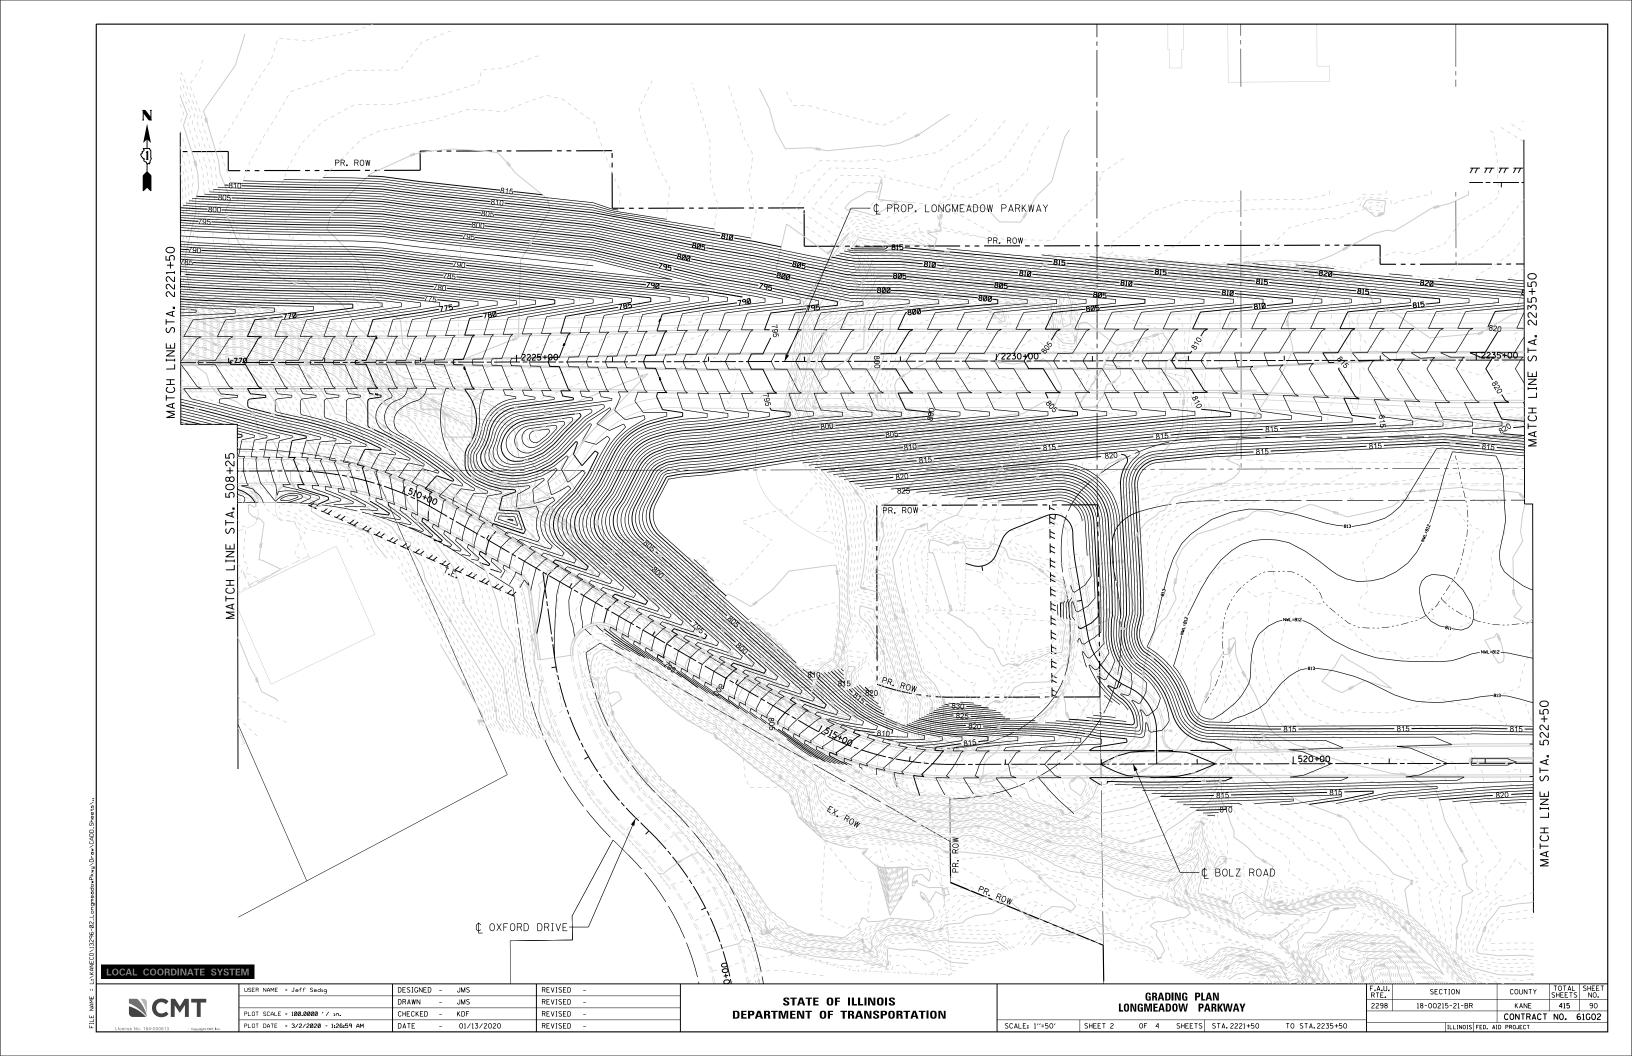

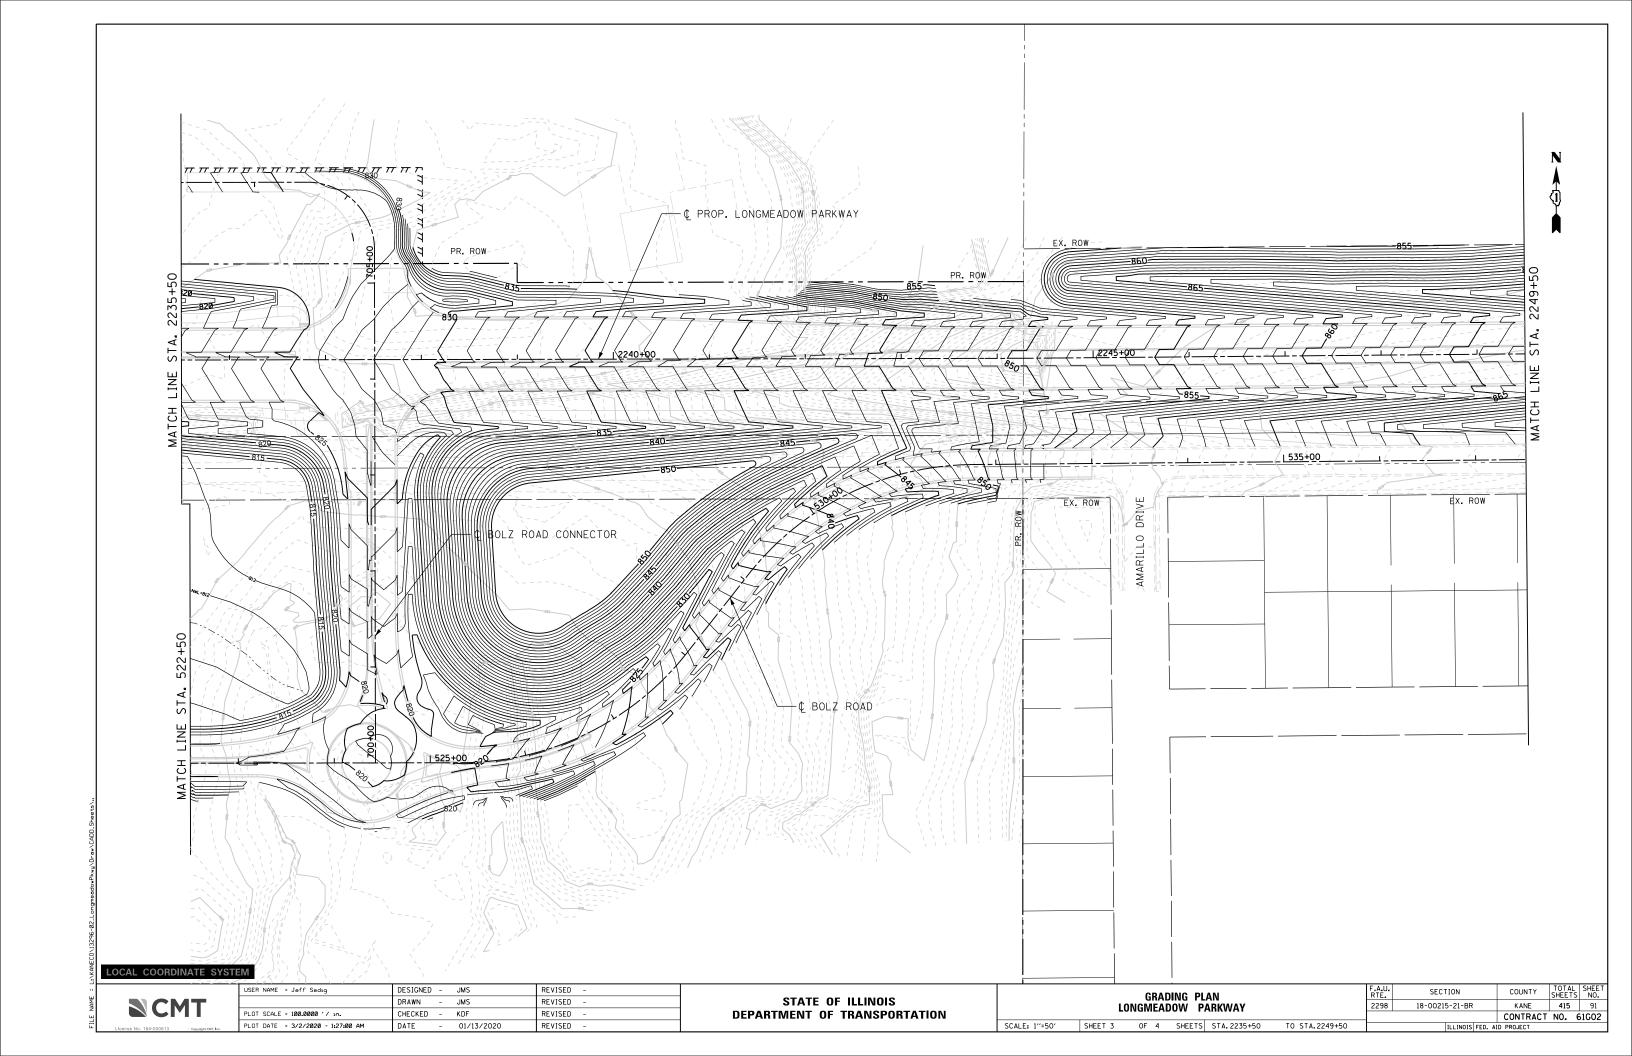

STORM WATER POLLUTION PREVENTION PLAN (SWPPP)/ EROSION CONTROL NOTES: LONGMEADOW PARKWAY - SECTION C2

THESE NOTES SUPPLEMENT THE EROSION CONTROL PLAN AND SWPPP TO COMPLY WITH THE PROVISIONS OF THE NPDES PERMIT ILR10 ISSUED BY THE ILLINOIS ENVIRONMENTAL PROTECTION AGENCY FOR STORM WATER DISCHARGES FROM CONSTRUCTION SITE ACTIVITIES.

A. SITE DESCRIPTION:

- THE WORK UNDER THIS CONTRACT IS TO BE COMPLETED ON PROPERTY LOCATED IN CARPENTERSVILLE, ILLINOIS ALONG THE NEW LONGMEADOW PARKWAY ROAD ALIGNMENT BETWEEN THE INTERSECTION OF SANDBLOOM ROAD AND BOLZ ROAD AT THE WEST AND ILLINOIS ROUTE 25 12. AND BOLZ ROAD AT THE EAST. THE PROJECT INCLUDES THE CLEARING OF THE SITE, NEW ALIGNMENT OF LONGMEADOW PARKWAY, A NEW BRIDGE OVER SANDBLOOM ROAD, A ROUNDABOUT FOR ACCESS, TRAFFIC SIGNALS AT ILLINOIS ROUTE 25, STORM SEWER AND STORMWATER FACILITY CONSTRUCTION.
- THE FOLLOWING IS A DESCRIPTION OF THE INTENDED SEQUENCE OF THE MAJOR ACTIVITIES WHICH WILL DISTURB SOIL FOR MAJOR PORTIONS OF THE CONSTRUCTION SITE; EXCAVATION AND GRADING SEQUENCE OF THE CONSTRUCTION ACTIVITIES MAY BE AS FOLLOWS:
 - INSTALLATION OF CONSTRUCTION FENCING, SEDIMENT CONTROL, PERIMETER EROSION BARRIER, AND TEMPORARY VEGETATION.
 - CLEARING OF THE PROJECT AS SHOWN IN THE REMOVAL PLANS. GRADING AND EARTHWORK AS SHOWN IN THE PLANS.
 - INSTALLATION OF STORM SEWERS AND DRAINAGE FACILITIES
 - CONSTRUCTION OF BRIDGE, ROADWAY, AND INFRASTRUCTURE.
 - INSTALLATION OF TRAFFIC SIGNAL EQUIPMENT. vii) TOPSOIL SPREADING WITH TEMPORARY OR PERMANENT SOIL
 - STABILIZATION MEASURES AND THE CONSTRUCTION OF PERMANENT SOIL EROSION AND SEDIMENT CONTROL MEASURES. viii) REMOVAL OF TEMPORARY SOIL EROSION AND SEDIMENT CONTROL
 - MEASURES.
- 3. THE TOTAL AREA OF THE CONSTRUCTION SITE IS ESTIMATED TO BE 40 ACRES. THE TOTAL AREA OF THE SITE THAT IS ESTIMATED TO BE DISTURBED BY EXCAVATION, GRADING OR OTHER ACTIVITIES IS 40 ACRES.
- 4. WATERS OF THE U.S. INCLUDED WITHIN OR ADJACENT TO THE PROJECT SITE ARE THE FOX RIVER AND SPRING CREEK. WATERS WEST OF ILLINOIS ROUTE 25 ARE IN THE FOX VALLEY WATERSHED. WATERS EAST OF ILLINOIS ROUTE 25 ARE IN THE SPRING CREEK WATERSHED. SPRING CREEK IS A TRIBUTARY OF THE FOX RIVER.
- B. SOIL EROSION AND SEDIMENT CONTROL NOTES:
- EACH CONTRACTOR MUST SIGN THE REQUIRED CERTIFICATION ON FORMS WHICH ARE A PART OF THE SWPPP.
- SOIL DISTURBANCE SHALL BE CONDUCTED IN SUCH A MANNER AS TO MINIMIZE EROSION. SOIL-STABILIZATION MEASURES SHALL CONSIDER THE TIME OF YEAR, SITE CONDITIONS, AND THE USE OF TEMPORARY OR PERMANENT MEASURES.
- CONTROL MEASURES SHALL MEET THE MINIMUM STANDARDS AND SPECIFICATIONS OF THE IDOT STANDARD SPECIFICATIONS FOR ROAD AND BRIDGE CONSTRUCTION, IDOT SUPPLEMENTAL SPECIFICATIONS AND RECURRING SPECIAL PROVISIONS (LATEST EDITION), ILLINOIS URBAN MANUAL (LATEST EDITION), THE SWPPP, AND THE DETAILS AND NOTES CONTAINED WITHIN THIS PLAN.
- 4. A COPY OF THE APPROVED SOIL EROSION AND SEDIMENT CONTROL PLANS AND THE SWPPP SHALL BE MAINTAINED ON THE PROJECT SITE AT ALL TIMES.
- THE KANE-DUPAGE SOIL AND WATER CONSERVATION DISTRICT (KDSWCD) MUST BE NOTIFIED ONE WEEK PRIOR TO THE PRE-CONSTRUCTION MEETING, ONE WEEK PRIOR TO THE COMMENCEMENT OF LAND DISTURBING ACTIVITIES, AND ONE WEEK PRIOR TO THE FINAL INSPECTION.
- SOIL EROSION AND SEDIMENT CONTROL MEASURES SHALL BE IN PLACE AND FUNCTIONAL PRIOR TO COMMENCING LAND DISTURBING ACTIVITIES.
- SOIL DISTURBANCE SHALL BE CONDUCTED IN A MANNER SUCH AS TO MINIMIZE EROSION. AREAS OF THE DEVELOPMENT SITE THAT ARE NOT TO BE DISTURBED SHALL BE PROTECTED FROM CONSTRUCTION TRAFFIC
- OFF SITE PROPERTY SHALL BE PROTECTED FROM EROSION AND SEDIMENTATION.
- PRIOR TO COMMENCING LAND DISTURBING ACTIVITIES OTHER THAN THOSE INDICATED ON THESE PLANS, A SUPPLEMENTARY SOIL EROSION AND SEDIMENT CONTROL PLAN SHALL BE SUBMITTED BY THE CONTRACTOR FOR CONDISDERATION AND REVIEW BY THE ENGINEER AND KDSWCD.

- 10. DEWATERING FOR ANY AND ALL PORTIONS OF WORK SHALL NOT BE MEASURED SEPARATELY FOR PAYMENT, BUT SHALL BE CONSIDERED INCLUDED IN THE CONTRACT UNIT PRICE FOR THE VARIOUS ITEMS AS BID.
- 11. DEWATERING DISCHARGES SHALL BE ROUTED THROUGH AN EFFECTIVE SEDIMENT CONTROL MEASURE (SEDIMENT/FILTER BAG PLACED ON A BED OF STONE) MEETING THE APPROVAL OF THE ENGINEER. FILTER BAGS SHOULD BE PLACED ON LEVEL GROUND AND HAVE SECONDARY CONTAINMENT DEVICES. DICHARGE DIRECTLY INTO ADJACENT PROPERTIES, STORM SEWER STRUCTURES, FIELD TILES, DRAINAGE WAYS, AND WATERWAYS IS PROHIBITED. FILTER BAGS SHALL NOT BE MEASURED SEPARATELY FOR PAYMENT, BUT SHALL BE CONSIDERED PART OF DEWATERING AND INCLUDED IN THE CONTRACT UNIT PRICE FOR THE VARIOUS ITEMS AS BID.
- CONCRETE WASHOUT LOCATIONS SHALL BE APPROVED BY THE ENGINEER PRIOR TO PLACEMENT OF THE CONCRETE. WASHOUTS SHALL NOT BE LOCATED IN WETLANDS, AREAS OF CONCENTRATED FLOW, AND NEAR AREAS OF CONCERN. WASHOUTS SHALL BE CONSTRUCTED ACCORDING TO THE DETAILS IN THE PLANS, OR IN A MANNER MEETING THE APPROVAL OF THE ENGINEER.
- 13. CLEANING OF VEHICLES AND EQUIPMENT, INCLUDING CONCRETE MIXERS, SHALL BE PERFORMED IN A MANNER TO REDUCE THE AMOUNT OF POLLUTANTS LEAVING THE PROJECT AREA, STORM SEWERS, AND OPEN WATERS TO THE MAXIMUM EXTENT PRACTICAL AND TO THE SATISFACTION
- 14. STABILIZED CONSTRUCTION ENTRANCES SHALL BE INSTALLED AS SHOWN IN THE PLANS OR AS DIRECTED BY THE ENGINEER. ALL ADJACENT STREETS SHALL BE MONITORED AND KEPT FREE OF DIRT AND DEBRIS. THE CONTRACTOR SHALL CLEAN THE ADJACENT PAVEMENT OF ALL DIRT AND DEBRIS AT THE END OF EACH DAY'S OPERATION AND AS DIRECTED BY THE ENGINEER (ART. 107.15).
- 15. NO WORK SHALL BE PERMITTED IN FLOWING WATER UNLESS PERMITTED BY A SECTION 404 PERMIT.
- 16. STOCKPILES THAT ARE TO REMAIN IN PLACE FOR MORE THAN THREE DAYS SHALL HAVE SOIL EROSION AND SEDIMENT CONTROL PROVIDED, AT A MINIMUM, PERIMETER EROSION BARRIER SHALL BE PLACED AROUND THE BOTTOM OF THE STOCKPILE. STOCKPILES TO REMAIN IN PLACE FOR MORE THAN 14 DAYS SHALL RECIEVE TEMPORARY SEEDING.
- 17. SOIL STOCKPILES SHALL NOT BE LOCATED IN FLOOD PRONE AREAS OR A DESIGNATED BUFFER PROTECTING WATERS OF THE UNITED STATES OR ISOLATED WATERS OF KANE COUNTY.
- 18. THE CONTRACTOR SHALL PROVIDE ADEQUATE CLOSED RECEPTACLES FOR THE DEPOSITION OF ALL CONSTRUCTION MATERIAL DEBRIS GENERATED DURING THE CONSTRUCTION PROJECT. THE CONTRACTOR SHALL NOT CAUSE OR PERMIT DUMPING, DEPOSITING, THROWING, DISCHARGING, DROPPING, OR LEAVING CONSTRUCTION MATERIAL DEBRIS UPON OR INTO ANY PRIVATE PROPERTY, CHANNEL, OR ISOLATED WATERS. THE SITE SHALL BE MAINTAINED FREE OF CONSTRUCTION MATERIAL DEBRIS.
- 19. THE CONTRACTOR SHALL BE RESPONSIBLE FOR INSTALLATION OF ANY ADDITIONAL EROSION AND SEDIMENT CONTROL MEASURES NECESSARY TO PREVENT EROSION AND/OR SEDIMENTATION AS DETERMINED BY THE ENGINEER OR KANE-DUPAGE SOIL AND WATER CONSERVATION DISTRICT. ANY WORK NOT INCLUDED IN THE PLANS SHALL BE PAID FOR PER ART. 109.04 OF THE IDOT STANDARD SPECIFICATIONS.
- 20. THE SOIL EROSION AND SEDIMENT CONTROL PLANS AND DETAILS DEFINE THE SIZE AND LOCATION OF THE MEASURES TO BE INSTALLED DURING THE CONSTRUCTION OF THIS PROJECT.
- 21. STABILIZATION OF DISTURBED AREAS SHALL, AT A MINIMUM, BE INITIATED IMMEDIATELY WHENEVER ANY CLEARING, GRADING, EXCAVATING, OR OTHER EARTH MOVING ACTIVITIES HAVE PERMANENTLY CEASED ON ANY PORTION OF THE SITE, OR TEMPORARILY CEASED ON ANY PORTION OF THE SITE AND WILL NOT RESUME FOR A PERIOD EXCEEDING 14 CALENDAR DAYS, STABILIZATION OF DISTURBED AREAS MUST BE INITIATED WITHIN ONE WORKING DAY OF CESSATION OF EARTH DISTURBING ACTIVITIES AND SHALL BE COMPLETED AS SOON AS POSSIBLE. BUT NOT LATER THAN 14 CALENDAR DAYS FROM THE INITIATION OF STABILIZATION WORK IN AN AREA.
- 22. COMPLETED AREAS SHALL BE PERMANENTLY STABILIZED AS THE WORK PROGRESSES TO THE EXTENT CONSIDERED PRACTICAL. UNDER NO CIRCUMSTANCE SHALL THE CONTRACTOR PROLONG FINAL GRADING AND SHAPING SUCH THAT THE ENTIRE PROJECT CAN BE PERMANENTLY STABILIZED AT ONE TIME.
- 23. THE CONDITION OF THE CONSTRUCTION SITE FOR WINTER SHUTDOWN SHALL BE ADDRESSED EARLY IN THE FALL GROWING SEASON TO THAT SLOPES AND OTHER BARE EARTH AREAS MAY BE STABILIZED WITH THE PROPER VEGETATIVE COVER. ALL OPEN AREAS THAT ARE TO REMAIN IDLE THROUGHOUT THE WINTER SHALL RECEIVE TEMPORARY EROSION CONTROL MEASURES PRIOR TO THE END OF THE FALL GROWING SEASON. AREAS TO BE WORKED AFTER THE GROWING SEASON MUST INCORPORATE STABILIZATION MEASURES THAT DO NOT RELY ON VEGETATIGVE COVER.

- 24. CRITICAL AREAS SHALL BE PERMANENTLY STABILIZED IMMEDIATELY UPON CONCLUSION OF WORK. CRITICAL AREAS SHALL BE DETERMINED BY THE ENGINEER INCLUDING, BUT NOT LIMITED TO THE FOLLOWING:
 - STREAMS
 - CREEKS
 - DRAINAGE SWALES STORM SEWER OUTFALLS
- THE GENERAL CONTRACTOR SHALL BE RESPONSIBLE FOR INFORMING ALL SUBCONTRACTORS WHO MAY PERFORM WORK ON THE PROJECT OF THE REQUIREMENTS IN IMPLEMENTING AND MAINTAINING THE SOIL EROSION AND SEDIMENT CONTROL PLANS AND THE NPDES REQUIREMENTS SET FORTH BY THE ILLINOIS ENVIRONMENTAL PROTECTION AGENCY.
- ALL DISTURBED AREAS SHALL BE STABILIZED WITH MULCH METHOD 3A OR EROSION CONTROL BLANKET (OF VARIOUS TYPES SPECIFIED) AS SHOWN ON THE PLANS.
- 27. EROSION CONTROL BLANKET SHALL BE REQUIRED ON ALL INTERIOR DETENTION BASIN SIDE SLOPES BETWEEN NORMAL WATER LEVEL AND HIGH-WATER LEVEL.
- ALL TEMPORARY EROSION AND SEDIMENT CONTROL MEASURES SHALL BE REMOVED WITHIN 30 DAYS AFTER FINAL SITE STABILIZATION IS ACHIEVED OR AFTER THE TEMPORARY MEASURES ARE NO LONGER NEEDED.
- 29. DUST CONTROL SHALL BE ACCOMPLISHED USING WATERING TRUCKS AS DIRECTED BY THE ENGINEER. SEE SPECIAL PROVISIONS.
- TEMPORARY STABILIZATION WITH EROSION CONTROL BLANKET SHALL BE USED TO STABILIZE CONSTRUCTION AREAS WHERE CONSTRUCTION ACTIVITY IS HALTED FOR MORE THAN 14 DAYS OR AREAS WHERE THE FINAL GRADE HAS BEEN REACHED BUT CANNOT BE PERMANENTLY STABILIZED DUE TO PLANTING SEASON RESTRICTIONS OF THE PERMANENT STABILIZATION. THIS SHALL BE EITHER BLOWN STRAW WITH A TACKIFIER OR CRIMPED IN ON STEEP SLOPES.
- 31. EROSION CONTROL BLANKET SHALL BE USED TO STABILIZE THE CONSTRUCTION AREAS WHERE THE FINAL GRADE HAS BEEN REACHED BUT CANNOT BE PERMANENTLY STABILIZED OR TREATED WITH TEMPORARY STABILIZATION WITH EROSION CONTROL BLANKET DUE TO THE PLANTING
- 32. TEMPORARY FENCING, AND PERIMETER EROSION BARRIER, ROLLED EXCELSIOR SHALL BE PLACED ALONG TREE STANDS TO BE PRESERVED AND TO PREVENT THE BUILD UP OF SEDIMENT ON TOP OF THE TREE ROOTS.
- 33. WATERS OF THE U.S. AND WETLANDS WITHIN OR ADJACENT TO THE PROJECT SHALL BE PROTECTED WITH TEMPORARY FENCE AND HEAVY DUTY PERIMETER EROSION BARRIER, ROLLED EXCELSIOR.
- 34. SHEET FLOWS EXITING THE SITE SHALL ENCOUNTER PERIMETER EROSION BARRIER.
- 35. PUMPING BASINS AND SUMP PITS SHALL BE CONSTRUCTED AT ALL LOCATIONS WHERE WATER IS PUMPED, PUMPED WATER SHALL FILTER THROUGH A TREATMENT TRAIN INCLUSIVE OF A SILT BAG AND TEMPORARY AGGREGATE DITCH CHECKS LINED WITH JUTE NET PRIOR TO DISCHARGE. PUMPING WILL ONLY BE PERMITTED AT THESE LOCATIONS.
- TEMPORARY AGGREGATE BERMS OR DITCH CHECKS SHALL BE USED TO SLOW SHEET FLOWS AND CONTROL SOIL EROSION.
- 37. STABILIZED CONSTRUCTION ENTRANCES SHALL BE CONSTRUCTED AT ALL LOCATIONS WHERE CONSTRUCTION TRAFFIC ENTERS OR EXITS THE SITE AS NEEDED OR DETERMINED BY THE ENGINEER.
- 38. TEMPORARY STREAM CROSSINGS WILL NOT BE ALLOWED, EXCEPT AS PROVIDED FOR IN THE U.S. ARMY CORPS OF ENGINEERS 404 PERMIT.
- 39. ALL SESC MEASURES PROTECTING AQUATIC RESOURCES SHALL BE IN PLACE AND PROPERLY FUNCTIONAL AT THE END OF EACH WORK DAY.

SCALE: NTS

C. MAINTENANCE

THE FOLLOWING IS A DESCRIPTION OF PROCEDURES THAT SHALL BE USED TO MAINTAIN, IN GOOD AND EFFECTIVE OPERATING CONDITIONS, VEGETATION, SOIL EROSION AND SEDIMENT CONTROL MEASURES, AND OTHER PROTECTIVE MEASURES IDENTIFIED IN THIS PLAN AND STANDARD SPECIFICATIONS:

THE CONTRACTOR SHALL ASSIGN A SOIL EROSION AND SEDIMENT CONTROL MANAGER (SESCM) TO THE PROJECT. HIS DUTIES WILL BE TO SUPERVISE THE MAINTENANCE OF THE SOIL EROSION AND SEDIMENT CONTROL MEASURES AND IMPLEMENTATION OF THIS PLAN.

THE FOLLOWING SHALL BE THE MINIMUM MAINTENANCE REQUIRED:

- VEGETATION SOIL EROSION MEASURES THE VEGETATIVE GROWTH OF TEMPORARY AND PERMANENT SEEDING, VEGETATIVE FILTERS, ETC. SHALL BE MAINTAINED PERIODICALLY AND SUPPLIED ADEQUATE WATERING AND FERTILIZER. THE VEGETATIVE COVER SHALL BE REMOVED AND RESERDED
- 2. PUMPING BASINS SHALL BE CLEANED OF SEDIMENT WHEN THE SEDIMENT HAS REACHED A DEPTH OF 50% OF THE HEIGHT OF THE AGGREGATE BERM.
- PERIMETER EROSION BARRIER (SILT FENCE) MAINTAIN AND REPAIR TEARS, GAPS, UNDERMINING, REPLACE BROKEN OR MISPLACED STAKES, SEDIMENT ACCUMULATION SHALL BE REMOVED WHEN IT HAS REACHED 1/3 THE HEIGHT OF THE BARRIER.
- TEMPORARY SEEDING FOR EROSION CONTROL SHALL BE REPAIRED WHEN BARE SPOTS AND WASHOUT OCCUR.
- STABILIZED CONSTRUCTION ENTRANCES SHALL HAVE SEDIMENT BUILD UP REMOVED AS NECESSARY.
- EROSION CONTROL BLANKET MAINTAIN AND REPAIR DAMAGE DUE TO WATER, SOIL DISPLACEMENT, AND/OR IMPROPER INSTALLATION.
- CONCRETE WASHOUT ALL CONTAINED MATERIALS SHALL BE REMOVED AND DISPOSED OF AT LEGAL OFF-SITE LOCATION WHEN THE WASHOUT HAS REACHED 50% CAPACITY.
- DITCH CHECKS SEDIMENT ACCUMULATION SHALL BE REMOVED WHEN IT HAS REACHED 50% OF THE HEIGHT OF THE STRUCTURE OR AS RECOMMENDED BY THE MANUFACTURER, WHICHEVER IS LESS.
- MAINTENANCE, REPAIR, REPLACEMENT OF EROSION AND SEDIMENT CONTROL MEASURES, AND DISPOSAL OF SEDIMENT SHALL NOT BE MEASURED SEPARATELY FOR PAYMENT, BUT SHALL BE CONSIDERED INCLUDED IN THE CONTRACT UNIT PRICE OF THE VARIOUS ITEMS AS BID.
- D. INSPECTIONS
- ALL EROSION AND SEDIMENT CONTROL MEASURES SHALL BE INSPECTED BY A QUALIFIED PERSON, A QUALIFIED PERSON SHALL BE IDENTIFIED AS A PERSON KNOWLEDGABLE IN THE PRINCIPLES AND PRACTICES OF EROSION AND SEDIMENT CONTROL MEASURES, SUCH AS A LICENSED PROFESSIONAL ENGINEER (P.E.), A CERTIFIED PROFESSIONAL IN EROSION AND SEDIMENT CONTROL (CPESC), A CERTIFIED EROSION SEDIMENT AND STORM WATER INSPECTOR (CESSWI), OR OTHER KNOWLEDGABLE PERSON.
- ALL SESC MEASURES AND AQUATIC RESOURCES WITHING THE SITE SHALL BE INSPECTED A MINIMUM OF ONCE EVERY SEVEN (7) CALENDAR DAYS AND WITHIN 24 HOURS (OR BY THE FOLLOWING WORKING DAY) OF THE END OF A RAIN EVENT OF 0.5 INCHES OR GREATER.
- THE CONTRACTOR SHALL PERMIT SITE ACCESS TO REPRESENTATIVE OF THE ENGINEER, OWNER, SOIL AND WATER CONSERVATION DISTRICT, ENVIRONMNETAL PROTECTION AGENCY, U.S. ARMY CORPS OF ENGINEERS.
- 4. THE PROJECT WILL BE ELIGIBLE FOR A NOTICE OF TERMINATION WITH THE IEPA ONCE FULL SITE STABILIZATION IS MET. THE PROJECT WILL BE ELIGIBLE FOR KDSWCD CLOSEOUT ONCE 70% UNIFORM PERENNIAL VEGETATION COVERAGE IS ESTABLISHED.

SEEDING AND STABILIZATION SCHEDULE

STABILIZATION TYPE	JAN.	FEB.	MAR.	APR.	MAY	JUNE	JULY	AUG.	SEPT.	OCT.	NOV.	DEC.
PERMANENT				Α				А				
SEEDING												
TEMPORARY			В									
SEEDING												
TEMPORARY	С											
STABILIZATION												

- PERMANENT SEEDING (PER PLANTING PLAN) APRIL 1 TO JUNE 15 & AUGUST 1 TO NOVEMBER 1
- TEMPORARY SEEDING PERENNIAL RYE GRASS, SPRING OATS (50 LB/ACRE MIN.)
- EROSION CONTROL BLANKET/MULCH

SCMT

USER NAME = Jeff Sedig	DESIGNED	-	JMS/PVH	REVISED -
	DRAWN	-	PVH	REVISED -
PLOT SCALE = 2.0000 '/ in.	CHECKED	-	KDF	REVISED -
PLOT DATE = 3/2/2020	DATE	-	01/13/2020	REVISED -

STATE OF ILLINOIS **DEPARTMENT OF TRANSPORTATION**

SWPPP/	EROSI	ION	CONTI	ROL PLAN	NOTES
SHEET 1	OF	1	SHEETS	STA.	TO STA.

F.A.U. RTE.	SECTION	COUNTY	TOTAL SHEETS	SHEE NO.
2298	18-00215-21-BR	KANE	415	93
		CONTRACT	NO. 6	31G02
	TI - THOSE FED. 41	ID DDO IECT		

