- 3. ACI 318-08 BUILDING CODE REQUIREMENTS FOR REINFORCED CONCRETE (ACI)
- 4. ASCE/SEI 7-05, "MINIMUM DESIGN LOADS FOR BUILDINGS AND OTHER STRUCTURES" (ASCE 7
- 5. AASHTO LRFD SPECIFICATIONS FOR STATE HIGHWAY BRIDGES", 6TH EDITION (AASHTO LRFD)
- 3. AASHTO STANDARD SPECIFICATIONS FOR HIGHWAY BRIDGES". 17TH EDITION. 2002 (AASHTO)
- 7. AMERICAN RAILWAY ENGINEERING AND MAINTENANCE-OF-WAY ASSOCIATION MANUAL FOR RAILWAY ENGINEERING, 2012 (AREMA)
- B. AISC "MANUAL OF STEEL CONSTRUCTION" 14TH EDITION (AISC)
- 9. AWS D1.1/D1.1M "STRUCTURAL WELDING CODE", 2010 (AWS)
- 10. AASHTO/AWS D1.5/D1/5M BRIDGE WELDING CODE, LATEST EDITION

<u>DESIGN CRITERIA FOR CANOPY, PLATFORM, SOUTH TERMINAL, NORTH TERMINAL, PEDESTRIAN BRIDGE, AND MAIN ROOF:</u> (DESIGN LOADS FOR VEHICULAR BRIDGES ARE INDICATED ON THE BRIDGE DRAWINGS)

1. SNOW LOAD

2.	FLAT ROOF SNOW LOAD SNOW DRIFT UNBALANCED SNOW LOAD ON CANOPY WIND LOAD	Pf = 30 PSF ADDITIONAL (TBD) 15 PSF (AT ENDS) 60 PSF (AT VALLE)
	MAIN BUILDING STRUCTURE MAIN WIND FORCE RESISTING SYSTEM	±20 PSF
	COMPONENTS AND CLADDING CORNER OTHER THAN CORNER	±30 PSF ±25 PSF
	ROOF WIND LOADS  FLAT ROOF (ENCLOSED BUILDINGS)  BUS CANOPY ROOF	±15 PSF ±30 PSF

SOUTH TERMINAL, NORTH TERMINAL LIVE LOAD:

CORRIDORS ABOVE CONCOURSE OFFICES PEDESTRIAN AREAS VENDING MACHINES TURNSTILES MED FOLLIDMENT/STORAGE BOOMS	100 PSF 50 PSF 100 PSF 250 PSF 125 PSF
MEP EQUIPMENT/STORAGE ROOMS	200 PSF OR PER SPECIFIED WT OF EQUIPMENT, WHICHEVER IS GREATER

- 4. RAILING AND GUARDRAIL SHALL BE DESIGNED WITH A HORIZONTAL 75 PLF FORCE CONCURRENT WITH A VERTICAL 50 PLF APPLIED TO THE TOP RAIL OR A CONCENTRATED FORCE OF 200 LBS WHICHEVER IS GREATER APPLIED IN ANY DIRECTION SHALL BE CONSIDERED.
- 5. LIVE LOAD REDUCTION SHALL BE IN ACCORDANCE WITH IDCM, CBC, AND ASCE 7.

GENERAL CONSTRUCTION NOTES:

- 1. ELEVATIONS ARE BASED ON THE CHICAGO CITY DATUM (CCD). ELEVATIONS ARE SHOWN IN FEET.
- 2. SPECIAL INSPECTIONS AS DEFINED BY THE CHICAGO BUILDING CODE ARE REQUIRED FOR THE FOLLOWING ITEMS, REFER TO DIVISION 1 SPECIFICATIONS FOR ALL OTHER INFORMATION RELATED TO TESTING AND INSPECTION SERVICES. REFER TO DIVISION 03 AND 05 SPECIFICATIONS FOR ALL TESTING AND INSPECTION REQUIREMENTS.
- A. CONCRETE ELEMENTS WITH A MINIMUM 28 DAY COMPRESSIVE STRENGTH (fc) OF 4000 PSI OR GREATER.
- B. STRUCTURAL FIELD WELDING, INCLUDING FULL PENETRATION FIELD WELDS.
- C. STRUCTURAL HIGH STRENGTH BOLTING & BLIND BOLTS.
- 3. CONTRACTOR SHALL PROVIDE INDEPENDENT TESTING AND INSPECTION AGENCY, SPECIAL INSPECTORS SHALL:
- A. OBSERVE THE WORK ASSIGNED FOR CONFORMANCE WITH APPROVED DRAWINGS AND SPECIFICATIONS.
- B. FURNISH INSPECTION REPORTS TO THE AUTHORITY. DISCREPANCIES SHALL BE BROUGHT TO THE IMMEDIATE ATTENTION OF THE CONTRACTOR FOR CORRECTION THEN, IF NOT CORRECTED, TO THE ATTENTION OF THE ENGINEER.
- C. SUBMIT TO THE AUTHORITY A FINAL REPORT STATING THAT THE WORK WAS IN CONFORMANCE WITH APPROVED SHOP DRAWINGS, CONTRACT DOCUMENTS, AND SPECIFICATIONS AND THE APPLICABLE WORKMANSHIP PROVISIONS OF THE BUILDING CODE.

GENERAL CONSTRUCTION NOTES: (CONTINUED)

- 4. SPECIAL INSPECTION IS NOT A SUBSTITUTE FOR INSPECTION BY THE DESIGNER OF THE RECORD (DOR). SPECIFICALLY INSPECTED WORK WHICH IS INSTALLED OR COVERED WITHOUT THE APPROVAL OF THE AUTHORITY IS SUBJECT TO REMOVAL OR EXPOSURE.
- 5. SPECIAL INSPECTORS MUST BE APPROVED BY THE AUTHORITY TO PERFORM THE TYPES OF INSPECTIONS SPECIFIED.
- 6. IT IS THE RESPONSIBILITY OF THE CONTRACTOR TO INFORM THE SPECIAL INSPECTOR OR INSPECTION AGENCY AT LEAST 5 WORKING DAYS BEFORE PERFORMING ANY WORK THAT REQUIRES SPECIAL INSPECTION. ALL WORK PERFORMED WITHOUT SPECIAL INSPECTION IS SUBJECT TO REMOVAL.
- 7. THE CONTRACTORS ARE REQUIRED TO EXAMINE THE DRAWINGS AND SPECIFICATIONS CAREFULLY AND FULLY INFORM THEMSELVES AS TO ALL EXISTING CONDITIONS AND LIMITATIONS PRIOR TO SUBMITTING THEIR BID. FAILURE TO VISIT THE SITE AND FAMILIARIZE THEMSELVES WITH EXISTING CONDITIONS AND LIMITATIONS WILL IN NO WAY RELIEVE THE CONTRACTORS FROM FURNISHING ANY MATERIALS OR PERFORMING ANY WORK IN ACCORDANCE WITH THE DRAWINGS AND SPECIFICATIONS WITHOUT ADDITIONAL COST TO THE OWNER.
- 8. THE INTENT OF THE STRUCTURAL DRAWINGS IS TO SHOW THE MAIN STRUCTURAL FEATURES AND DESIGN FOR THE COMPLETE PROJECT UPON COMPLETION OF ALL PHASES OF CONSTRUCTION. ALL OTHER DETAILS RELATED TO OTHER TRADES ARE SHOWN DIAGRAMMATICALLY ONLY AND NOT COMPLETELY. THEREFORE, THE STRUCTURAL DRAWINGS SHALL BE USED IN CONJUNCTION WITH SHOP DRAWINGS, PROJECT SPECIFICATIONS, ARCHITECTURAL, MEP, CIVIL, UTILITY, RAIL, AND OTHER DRAWINGS.
- 9. PLAN DIMENSIONS AND DETAILS RELATIVE TO THE EXISTING STRUCTURE HAVE BEEN TAKEN FROM EXISTING PLANS AND ARE SUBJECT TO AS-BUILT CONSTRUCTION VARIATIONS. THE CONTRACTOR SHALL VERIFY ALL DIMENSIONS AND CONDITIONS AT THE SITE AND REPORT ANY DISCREPANCIES TO THE DOR FOR CLARIFICATION BEFORE PROCEEDING WITH CONSTRUCTION OR ORDERING OF MATERIALS. SUCH VARIATIONS SHALL NOT BE CAUSE OF ADDITIONAL COMPENSATION OR A CHANGE IN THE SCOPE OF WORK.
- 10.THE CONTRACTOR IS RESPONSIBLE FOR VERIFYING AND COORDINATING ALL DIMENSIONS SHOWN ON THE DRAWINGS. REPORT ANY DISCREPANCIES BETWEEN THE STRUCTURAL DRAWINGS AND DRAWINGS OF DIFFERENT TRADES TO THE DOR BEFORE PROCEEDING WITH THE AFFECTED PART OF THE WORK.
- 11.WORK NOT INDICATED ON A PART OF THE DRAWINGS, BUT REASONABLY IMPLIED TO BE SIMILAR TO THAT SHOWN AT SIMILAR LOCATIONS, SHALL BE INCLUDED. DETAILS SHOWN AS TYPICAL ARE APPLICABLE TO ALL SIMILAR CONDITIONS.
- 12. SHORE, SHEET AND BRACE EXCAVATIONS AS REQUIRED TO ASSURE COMPLETE SAFETY AGAINST COLLAPSE OF EARTH AND DAMAGE TO ADJACENT PROPERTY INCLUDING BUT NOT LIMITED TO EXISTING STREETS, BUILDING, UTILITY LINES, TRACKS, AND CTA INFRASTRUCTURE.
- 13.THE CONTRACTOR SHALL RETAIN A LICENSED STRUCTURAL ENGINEER IN STATE OF ILLINOIS TO DESIGN ANY EARTH RETENTION SYSTEM REQUIRED. SEE SPECIFICATION SECTION 31 15 00 SHORING.
- 14.THE CONTRACTOR SHALL BE COMPLETELY RESPONSIBLE FOR THE SAFETY OF ADJACENT STRUCTURES, INCLUDING PORTIONS OF STRUCTURES REMAINING AND TEMPORARY STRUCTURES, PROPERTY, AND THE PUBLIC WAY. IN AREAS OF PUBLIC ACCESS, THE PUBLIC WAY SHALL BE PROTECTED FROM CONSTRUCTION AND DEMOLITION WORK AT ALL TIMES.
- 15.DESIGN LOADS ARE RESISTED BY THE COMPLETED STRUCTURE ACTING AS A UNIT. THE CONTRACTOR SHALL PROVIDE TEMPORARY BRACING, SHORING, OR ADDITIONAL SUPPORT DEVICES NECESSARY TO RESIST LOADS IMPOSED ON THE PARTIALLY COMPLETED STRUCTURE THROUGHOUT ALL STAGES OF CONSTRUCTION.
- 16.DEMOLITION WORK SHALL BE DONE WITH CAUTION. PROVIDE ALL SHORING AND ENCLOSURES NECESSARY PRIOR TO COMMENCEMENT OF WORK.
- 17.THE CONTRACTOR SHALL NOTIFY THE AUTHORITY WHEN, IN THE COURSE OF CONSTRUCTION OR DEMOLITION, CONDITIONS ARE UNCOVERED WHICH ARE UNANTICIPATED OR OTHERWISE APPEAR TO PRESENT A DANGEROUS CONDITION.
- 18.PRIOR TO ANY DEMOLITION OR FORMWORK REMOVAL, THE CONTRACTOR SHALL SUBMIT SHOP DRAWINGS AND CALCULATIONS TO THE DOR FOR REVIEW AND APPROVAL, IDENTIFYING ALL TEMPORARY SHORING AND BRACING SYSTEMS, DEMOLITION, AND CONSTRUCTION SEQUENCE. ALL TEMPORARY SHORING DURING DEMOLITION SHALL BE CAPABLE OF SAFELY SUPPORTING ALL LOADS PRESENTLY CARRIED BY THE EXISTING STRUCTURAL WORK BEING DEMOLISHED AND REINFORCED, INCLUDING CONSTRUCTION LIVE LOADS. TEMPORARY SHORING AND FORMWORK DESIGN SHALL BE SIGNED AND SEALED BY THE CONTRACTOR'S LICENSED STRUCTURAL ENGINEER IN THE STATE OF ILLINOIS IN ACCORDANCE WITH THE CHICAGO BUILDING CODE, AND THE PROJECT SPECIFICATIONS.
- 19.IT SHOULD BE NOTED THAT THE INSTALLATION OF SHEET PILING MAY ENCOUNTER HARD DRIVING. THE CONTRACTOR SHOULD MAKE HIMSELF AWARE OF THE BORING LOGS AND SUBSURFACE CONDITIONS AND DESIGN A SHORING METHOD WHICH CAN ACHIEVE THE MINIMUM REQUIRED EMBEDMENT.
- 20.STD. SPECIFICATION REFERENCES THE 2012 IDOT STANDARD SPECIFICATIONS AND ANY SUPPLEMENTAL SPECIFICATIONS AND RECURRING SPECIAL PROVISIONS.

21. THESE NOTES APPLY TO ALL SHEETS UNLESS NOTED OTHERWISE ON S-003A

**FOUNDATIONS:** 

- 1. DESIGN IS BASED UPON A GEOTECHNICAL DESIGN MEMORANDUM PREPARED BY WANG ENGINEERING DATED 03/03/2016 AND ALL SUBSEQUENT ADDENDUMS. RECOMMENDATIONS PREPARED THEREIN MUST BE READ THROUGH AND THOROUGHLY STUDIED BY THE CONTRACTOR BEFORE PROCEEDING WITH ANY FOUNDATION WORK INCLUDING SITE PREPARATION, EXCAVATION, AND MINIMUM EXTERIOR FOOTING DEPTH. BOTTOM OF ALL FOUNDATIONS SHALL BE INSPECTED BY A REGISTERED SOILS ENGINEER AND DESIGN BEARING CAPACITY VERIFIED BEFORE PLACING ANY CONCRETE.
- 2. REFER TO SPECIFICATION SECTION 31 64 00 DRILLED SHAFTS AND DRAWING FOR DRILLED SHAFT DESIGN CRITERIA AND DETAILS FOR TERMINAL BUILDING DRILLED SHAFTS.
- 3. APPROVED BACKFILL MATERIAL UNDER SLABS ON GROUND SHALL BE PLACED IN LAYERS NOT EXCEEDING 8 INCHES IN LOOSE THICKNESS AND COMPACTED TO A MINIMUM OF 95% OF THE MAXIMUM DENSITY OBTAINED IN ACCORDANCE WITH ASTM D 1557, MODIFIED PROCTOR METHOD.
- 4. THE CONTRACTOR SHALL BE RESPONSIBLE TO ADEQUATELY PROTECT ALL EXCAVATION. WHERE NECESSARY, SHEET AND SHORE THE EXCAVATION WITH ALL REQUIRED TIEBACKS AND BRACING AS DETERMINED BY CONTRACTOR'S ENGINEER.
- 5. CONTRACTOR SHALL TAKE ALL STEPS NECESSARY TO ENSURE THAT EXCAVATION SHALL NOT UNDERMINE ADJACENT EXISTING BUILDING FOUNDATIONS TO REMAIN, AND THAT EXISTING FOUNDATIONS ARE PROTECTED FROM SETTLEMENT ASSOCIATED WITH CONSTRUCTION ACTIVITIES.
- 6. PROVIDE WATERSTOPS IN ALL EXPANSION JOINTS WHERE INDICATED ON THE DRAWINGS AND IN ACCORDANCE WITH SPECIFICATION SECTION 03 30 00.
- 7. ALL REQUIRED INSERTS SLEEVES, CONDUITS, EMBEDMENTS AND PENETRATIONS MUST BE VERIFIED WITH RESPECTIVE TRADES BEFORE CASTING CONCRETE.
- 8. NO FOUNDATION ELEMENT, BEAM OR SLABS SHALL BE PLACED ON FROZEN SOIL, WET SOIL, OR IN WATER.
- 9. OLD FOUNDATIONS OR OTHER OBSTRUCTIONS MAY BE ENCOUNTERED DURING EXCAVATION. SUCH FOUNDATIONS AND OBSTRUCTIONS SHALL BE REMOVED TO A MINIMUM OF 2' BELOW LOWEST POINT OF OBSTRUCTION OR AS DIRECTED BY THE AUTHORITY.
- 10.THE DOR ASSUMES NO RESPONSIBILITY FOR THE VALIDITY OF THE SUBSURFACE CONDITIONS DESCRIBED ON THE DRAWINGS, SPECIFICATIONS, OR BORING LOGS. THIS DATA IS INCLUDED ONLY TO ASSIST THE CONTRACTOR DURING CONSTRUCTION AND REPRESENT CONDITIONS ONLY OF THESE SPECIFIED LOCATIONS AT THE PARTICULAR TIME THEY WERE MADE.
- 11.ALL DRILLED SHAFT WORK SHALL BE IN CONFORMANCE WITH CBC TITLE 13 BUILDINGS AND CONSTRUCTION, CHAPTER 13-132 FOUNDATIONS.

BUILDING CAST-IN-PLACE CONCRETE:

1. ALL CAST-IN-PLACE CONCRETE SHALL DEVELOP A STRENGTH OF f'c = 5,000 PSI AT 28 DAYS.

- 2. REFER TO SPEC SECTION 03 30 00, CAST-IN-PLACE CONCRETE BUILDING, FOR MIX DESIGNS AND INFORMATION NOT LISTED HEREIN. ALL CONCRETE SHALL BE NORMAL WEIGHT CONCRETE UNLESS NOTED OTHERWISE.
- 3. ALL SHORING/FORMWORK RELATED TO THE BUILDING STRUCTURE DESIGNATED AS SELF SUPPORTING ELEMENTS, INCLUDING, BUT NOT LIMITED TO: FORMED SLABS AND FOUNDATION WALLS, SHALL REMAIN IN PLACE UNTIL CONCRETE HAS ATTAINED 80% OF THE REQUIRED 28-DAY COMPRESSIVE STRENGTH. FOR ALL OTHER BUILDING FORMWORK REQUIREMENTS, REFER TO SPEC SECTION 03 30 00 BUILDING.
- 4. ALL CONSTRUCTION AND CONTROL JOINT LOCATIONS MUST BE SHOWN ON SHOP DRAWINGS AND APPROVED BY THE DOR.
- 5. CONTRACTOR SHALL SUBMIT DRAWINGS SHOWING INTENDED SEQUENCES AND LOCATIONS OF CONSTRUCTION AND CONTROL JOINTS IN ALL CONCRETE WORK TO THE DOR FOR APPROVAL. CONSTRUCTION JOINT LOCATIONS OTHER THAN SHOWN ON THE DRAWINGS ARE PERMITTED, SUBJECT TO PRIOR APPROVAL OF THE DOR. EXPANSION JOINT AND CONTROL JOINT LOCATIONS ARE MANDATORY AS SHOWN. FOUNDATION CONSTRUCTION JOINTS SHALL BE LOCATED AS TO PROVIDE 50'-0" MAXIMUM LENGTH OF CONCRETE PLACEMENT, UNLESS APPROVED BY DOR.
- 6. CONSTRUCTION JOINTS NOT SHOWN ON THE DRAWINGS SHALL BE LOCATED SO AS TO LEAST IMPAIR THE STRENGTH OF THE STRUCTURE AND SHOULD GENERALLY BE LOCATED AT POINTS OF MINIMUM SHEAR.
- 7. NO HORIZONTAL CONSTRUCTION JOINTS SHALL BE MADE IN BEAMS, UNLESS SHOWN SPECIFICALLY ON DRAWINGS. FOR VERTICAL CONSTRUCTION JOINTS, REFER TO ACI 318, SECTION 6.4.
- 8. ALL REINFORCING WILL BE CONTINUOUS THROUGH CONSTRUCTION JOINTS.
- 9. ALL EXPOSED EDGES SHALL BE CHAMFERED 3/4" UNLESS NOTED OTHERWISE.
- 10. WHEN CONCRETE IS PLACED AGAINST PREVIOUSLY HARDENED CONCRETE, THE INTERFACE SHALL BE CLEAN, FREE OF LAITANCE, AND ROUGHENED TO A FULL AMPLITUDE OF APPROXIMATELY 1/4 INCH, UNLESS NOTED OTHERWISE.
- 11.CONCRETE QUALITY IN ACCORDANCE WITH THE REQUIREMENTS OF THESE DRAWINGS AND SPECIFICATIONS IS ESSENTIAL TO THE STRUCTURAL PERFORMANCE OF THIS STRUCTURE. CONCRETE THAT IS NOT IN ACCORDANCE WITH THE DRAWINGS AND SPECIFICATIONS WILL NOT BE ACCEPTED.

12.ALL KEYS SHALL BE 2"x4" WITH BEVELED SIDES, UNLESS NOTED OTHERWISE.

- 13.PIPES OR CONDUITS PLACED IN WALLS SHALL NOT BE PLACED CLOSER THAN 3 DIAMETER ON CENTER AND SHALL HAVE AN OUTSIDE DIAMETER LESS THAN 1/3 OF THE WALL THICKNESS. ALUMINUM CONDUITS SHALL NOT BE PLACED IN CONCRETE.
- 14. CONCRETE WALLS SHALL BE CAST IN PANELS NOT EXCEEDING 60 FEET IN LENGTH, UNLESS NOTED OTHERWISE ON THE PLANS.

15.CAST BEAMS AND WALLS MONOLITHICALLY, UNLESS OTHERWISE INDICATED.

CAST IN PLACE CONCRETE: (CONTINUED)

- 16. BUILD ALL CONCRETE TO MINIMIZE THE EFFECTS OF SHRINKAGE BY CASTING ALTERNATE SECTIONS. ADJACENT SECTIONS MAY ONLY BE CAST WHEN THE PREVIOUSLY PLACED SECTION HAS CURED FOR A MINIMUM OF 48 HOURS AFTER ITS INITIAL SET. CURING REQUIREMENTS ARE SPECIFIED IN SPECIFICATION SECTION 03 30 00, CAST-IN-PLACE CONCRETE BUILDING.
- 17. NOT ALL OPENINGS THROUGH CONCRETE SLABS AND WALLS ARE SHOWN ON STRUCTURAL DRAWINGS. OPENINGS INDICATED, OR ANY ADDITIONAL OPENINGS OR INSERTS REQUIRED, MUS BE VERIFIED WITH RESPECTIVE TRADES BEFORE POURING OF CONCRETE. NO CONCRETE SHALL BE CAST PRIOR TO THE DOR'S REVIEW AND APPROVAL OF THE COORDINATED SUBMITTAL. WHICH SHALL INCLUDE REINFORCING. SLAB OPENINGS AND EMBEDDED ITEMS.
- SEE ARCHITECTURAL DRAWINGS FOR FINISHES, DEPRESSIONS, REGLETS, NOTCHES AND OTHER ARCHITECTURAL FEATURES.
- 19. PROVIDE SEALANT JOINTS FOR ALL EXPOSED TO VIEW CONSTRUCTION JOINTS, CONTROL JOINTS AND SHEAR KEYS.
- 20. ALL CONCRETE SHALL BE CONTROLLED CONCRETE, MIXED, AND PLACED UNDER THE SUPERVISION OF AN APPROVED CONCRETE TESTING AGENCY.
- 21. CONCRETE EXPOSED TO WEATHER SHALL BE AIR ENTRAINED WITH AIR CONTENT AS INDICATED IN TABLE 1.1 OF ACI 201.2 FOR SEVERE EXPOSURE. TOLERANCE OF AIR CONTENT AS DELIVERED SHALL BE +/-1.5%.
- 22. PROVIDE 3 GALLON OF CALCIUM NITRITE CORROSION INHIBITOR (DCI OR APPROVED EQUAL) PER CU. YD. OF CONCRETE FOR ALL CONCRETE EXCEPT FOR DRILLED SHAFT & GRADE BEAM CONCRETE.
- 23. SHRINKAGE-REDUCING ADMIXTURE (MASTERLIFE SRA 20 OR APPROVED EQUAL) SHALL BE ADMIXED WITH THE CONCRETE FOR CRASH BARRIER WALLS ONLY IN ACCORDANCE WITH THE LOW SHRINKAGE GUIDELINES OF ACI WITH A DOSAGE PER THE MANUFACTURER.
- 24. BUILDING CONCRETE FOR THE WALL, CAPS, GRADE BEAMS, AND DRILLED SHAFTS SHALL HAVE A SLUMP IN THE RANGE OF 7" +/-1".

**CONCRETE REINFORCING** 

- 1. ALL CONCRETE REINFORCING SHALL CONFORM TO ASTM A615, GRADE 60 AND BE EPOXY COATED. REFER TO SPECIFICATION SECTION 03 20 10, UNLESS NOTED OTHERWISE.
- 2. WELDED WIRE REINFORCEMENT (WWR) SHALL CONFORM TO ASTM A185, GRADE 65 AND SHALL BE SUPPLIED IN FLAT SHEETS ONLY. SPLICES OF WWR SHALL BE AT LEAST 12 INCHES, AND SHALL BE EPOXY COATED PER ASTM A884.
- 3. WELDED DEFORMED WIRE REINFORCEMENT SHEETS: ASTM A497, GRADE 65 AND SHALL BE EPOXY COATED PER ASTM A884.
- 4. SHOP DRAWINGS AND SCHEDULES OF REINFORCING STEEL SHALL BE PREPARED BY THE CONTRACTOR AND SUBMITTED TO THE DOR FOR APPROVAL PRIOR TO COMMENCEMENT OF THAT PORTION OF THE WORK.
- 5. MINIMUM CLEAR CONCRETE COVER SHALL FOLLOW SPECIFICATION 03 30 00 FOR NONPRESTRESSED CONCRETE, UNLESS NOTED OTHERWISE ON THE DRAWINGS.
- 6. UNLESS NOTED OTHERWISE, BARS SHALL BE CONTINUOUS AND SHALL RUN CONTINUOUSLY AROUND CORNERS. BARS SHALL HAVE STANDARD HOOKS AT DISCONTINUOUS ENDS.
- 7. SPLICES SHALL GENERALLY OCCUR AT MID-SPAN FOR TOP AND MIDDLE BARS AND AT SUPPORT FOR BOTTOM BARS AND SHALL BE STAGGERED.
- 8. MECHANICAL COUPLER CONNECTIONS SHALL CONFORM TO ACI 318 AND DEVELOP IN TENSION AND COMPRESSION AT LEAST 125% OF THE YIELD STRENGTH OF THE BAR.
- 9. BARS SHALL NOT BE CUT OR OMITTED FOR SLEEVE OR DUCT OPENINGS. BARS MAY BE MOVED LATERALLY WITHOUT CHANGING THE DISTANCE FROM THE FACE OF CONCRETE.
- 10. ALL REINFORCING SHALL BE DETAILED IN ACCORDANCE WITH THE LATEST EDITION OF THE ACI DETAILING MANUAL, PUBLICATION SP-66. ALL REINFORCEMENT DETAILING, LAP SPLICES, AND EMBEDMENTS SHALL CONFORM TO THIS MANUAL. ALL ACCESSORIES, SUCH AS SLAB BOLSTERS AND BEAM AND SLAB CHAIRS IN CONTACT WITH EXPOSED SURFACES, SHALL BE PLASTIC COATED.
- 11. SET AND TIE ALL REINFORCEMENT BEFORE PLACING CONCRETE. SETTING DOWELS AND REINFORCEMENT INTO WET CONCRETE IS PROHIBITED.
- 12. THE CONTRACTOR SHALL SUBMIT COMPLETE PLANS INDICATING LOCATIONS OF ALL REQUIRED DRILLING, CORING, AND PENETRATIONS THROUGH SLABS AND WALLS TO THE DOR FOR REVIEW PRIOR TO PROCEEDING WITH ANY DRILLING AND CORING.
- 13. DRILLING OR CORING THROUGH CONCRETE SHALL NOT DAMAGE REINFORCING BARS. THE DOR SHALL BE NOTIFIED PRIOR TO THE CONTRACTOR PROCEEDING WITH ANY DRILLING OR CORING UPON ENCOUNTERING EXISTING REINFORCING STEEL.
- 14. MINIMUM ANCHORAGE, SPLICE REQUIREMENTS FOR REINFORCING BARS, AND TEMPERATURE REINFORCEMENT IN ALL CONCRETE SLABS AND WALLS SHALL BE ACCORDING TO ACI 318, UNLESS OTHERWISE SHOWN ON DRAWINGS.
- 15. NO CONCRETE SHALL BE CAST BEFORE REVIEW AND APPROVAL OF THE REINFORCING AND EMBEDDED ITEMS HAVE BEEN OBTAINED FROM THE CONTRACTOR.
- 16. SET ANCHOR BOLTS AND EMBEDDED PLATES REQUIRED FOR CONNECTION OF WORK BY OTHERS.
- 17. WELDING OF REINFORCEMENT AND FIELD WELDING TO ANCHOR BOLTS IS PROHIBITED.
- 18. EXISTING REINFORCEMENT TO BE INCORPORATED INTO NEW CONSTRUCTION SHALL BE CLEANED AND EPOXY COATED AS PER SPECIFICATION UNLESS OTHERWISE NOTED.
- 19. ALL DOWEL BARS BEING ANCHORED TO CONCRETE USING AN ADHESIVE SHALL BE HOT-DIP GALVANIZED IN LIEU OF BEING EPOXY COATED.

SNN /







SENSITIVE SECURITY INFORMATION

WARNING: THIS RECORD CONTAINS SENSITIVE SECURITY INFORMATION THAT IS CONTROLLE UNDER 49 CFR PARTS 15 AND 1520. NO PART OF THIS RECORD MAY BE DISCLOSED TO PERSONS WITHOUT A "NEED TO KNOW" AS DEFINED IN CFR PARTS 15 AND 1520, EXCEPT WITH THE WRITTEN PERMISSION OF THE ADMINISTRATOR OF THE TRANSPORTATION SECURITY ADMINISTRATION OR THE SECRETARY OF TRANSPORTATION. UNAUTHORIZED RELEASE MAY RESULT IN CIVIL PENALTY OR OTHER ACTION. FOR U.S. GOVERNMENT AGENCIES, PUBLIC DISCLOSURE IS GOVERNED BY 5 U.S.C. 552 AND 49 CFR PARTS 15 AND 1520.

DRAWING SCALE IS NOT GUARANTEED. CTA ASSUMES NO RISK OF LIABILITY FOR ERRORS CAUSED, DIRECTLY OR INDIRECTLY, BY SCALING OF THIS DRAWING.

95th Terminal Improvement
15 West 95th Street (South Terminal)

Chicago, IL 60628

J. JAKALSKI

IN CHARGE

J. JAKALSKI APPROVED BY **CHECKED BY** R.S. NAIR **DESIGNED BY** G. FORKAN **DRAWN BY** J. PEARSON PROJECT NO. 2012-0021.02 **FILE NAME** DR095\_S-Terminal ISSUED FOR CONSTRUCTION MARK DATE DESCRIPTION LOCATION IDENTIFIER: **DR095** 

STRUCTURAL GENERAL NOTES

						TEN	ISION DI	EVELOP	MENT LE	ENGTH						
	CONCRETE COMPRESSIVE STRENGTH f'c (PSI)															
BAR		30	00			40	000			50	000		6000			
SIZE	TOP	BAR	OTHER	RBARS	TOP	BAR	OTHER	R BARS	TOP	BAR	OTHER	R BARS	TOP	BAR	OTHER BARS	
	CASE 1	CASE 2	CASE 1	CASE 2	CASE 1	CASE 2	CASE 1	CASE 2	CASE 1	CASE 2	CASE 1	CASE 2	CASE 1	CASE 2	CASE 1	CASE 2
#3	22	33	17	25	19	28	15	22	17	25	13	20	16	23	12	18
#4	29	43	22	33	25	37	19	29	23	34	17	26	21	31	16	24
#5	36	54	28	42	31	47	24	36	28	42	22	32	26	38	20	30
#6	43	65	33	50	37	56	29	43	34	50	26	39	31	46	24	35
#7	63	94	48	72	54	81	42	63	49	73	38	56	45	67	34	51
#8	72	107	55	83	62	93	48	72	56	83	43	64	51	76	39	59
#9	81	121	62	93	70	105	54	81	63	94	48	72	57	85	44	66
#10	90	134	69	103	78	116	60	89	69	104	54	80	63	95	49	73
#11	98	147	76	113	85	128	66	98	76	114	59	88	70	104	54	80
#14	131	187	96	144	113	162	84	125	101	145	75	112	93	133	68	102
#18	169	241	124	185	147	209	107	161	131	187	96	144	120	170	88	131

							TENS	SION LA	P SPLICE	E LENGT	H						
	LAP CLASS						(	CONCRETE (	COMPRESSI	VE STRENG	TH f'c (PSI)						
BAR		3000			4000			5000			6000						
SIZE		TOP	BAR	OTHER BARS		TOP BAR		OTHE	OTHER BARS		TOP BAR		OTHER BARS		TOP BAR		OTHER BARS
		CASE 1	CASE 2	CASE 1	CASE 2	CASE 1	CASE 2	CASE 1	CASE 2	CASE 1	CASE 2	CASE 1	CASE 2	CASE 1	CASE 2	CASE 1	CASE 2
#3	Α	22	33	17	25	19	28	15	22	17	25	13	20	16	23	12	18
#3	В	29	43	23	33	25	37	20	29	23	33	17	26	21	30	16	24
#4	Α	29	43	22	33	25	37	19	29	23	34	17	26	21	31	16	24
<del>π-1</del>	В	38	56	29	43	33	49	25	38	30	45	23	34	28	41	21	32
#5	Α	36	54	28	42	31	47	24	36	28	42	22	32	26	38	20	30
110	В	47	71	37	55	41	62	32	47	37	55	29	42	34	50	26	39
#6	Α	43	65	33	50	37	56	29	43	34	50	26	39	31	46	24	35
110	В	56	85	43	65	49	73	38	56	45	65	34	51	41	60	32	46
#7	Α	63	94	48	72	54	81	42	63	49	73	38	56	45	67	34	51
""	В	82	123	63	94	71	106	55	82	64	95	50	73	59	88	45	67
#8	Α	72	107	55	83	62	93	48	72	56	83	43	64	51	76	39	59
110	В	94	140	72	108	81	121	63	94	73	108	56	84	67	99	51	77
#9	Α	81	121	62	93	70	105	54	81	63	94	48	72	57	85	44	66
πο	В	106	158	81	121	91	137	71	106	82	123	63	94	75	111	58	86
#10	Α	90	134	69	103	78	116	60	89	69	104	54	80	63	95	49	73
11 10	В	117	175	90	134	102	151	78	116	90	136	71	104	82	124	64	95
#11	Α	98	147	76	113	85	128	66	98	76	114	59	88	70	104	54	80
πιι	В	128	192	99	147	111	167	86	128	99	149	77	115	91	136	71	104

COMPRESSION LAP SPLICE LENGTH AND COMPRESSION DEVELOPMENT LENGTH										
BAR	LAP	CONC	CONCRETE COMPRESSIVE STRENGTH f'c (PSI)							
SIZE	SPLICE	3000	4000	5000	6000					
			DEVELOPMENT	LENGTH (INCHES	S)					
#3	12	9	8	8	8					
#4	15	11	10	9	9					
#5	19	14	12	12	12					
#6	23	17	15	14	14					
#7	27	20	17	16	16					
#8	30	22	19	18	18					
#9	34	25	22	21	21					
#10	39	28	25	23	23					
#11	43	31	27	26	26					
#14	53	39	34	32	32					
#18	68	50	43	41	41					


- 1. DEVELOPMENT LENGTH ARE BASED ON ASTM A615 (60 KSI) REINFORCEMENT.
- 2. CASE 1 AND CASE 2 DEPEND ON THE CONCRETE COVER AND THE CENTER TO CENTER SPACING OF THE BARS.
  - CASE 1: CLEAR SPACING OF BARS AND CONCRETE CLEAR COVER NOT LESS THAN (1) BAR DIAMETER STIRRUPS OR TIES THROUGHOUT THE DEVELOPMENT LENGTH NOT LESS THAN THE CODE MINIMUM
  - OR CLEAR SPACING OF BARS AT LEAST (2) BAR DIAMETERS CONCRETE CLEAR COVER AT LEAST (1) BAR DIAMETER
  - CASE 2: ALL OTHER CASES
- 3. TOP BARS ARE DEFINED AS HORIZONTAL BARS WITH MORE THAN 12 INCHES OF CONCRETE CAST BELOW.
- 4. TABLE VALUES ARE BASED ON NORMAL WEIGHT CONCRETE. IF LIGHTWEIGHT CONCRETE IS REQUIRED,
- VALUES SHOULD BE MULTIPLIED BY 1.33 (SEE ACI 318-11 SECTION 12.5.2).
- 5. TABLE VALUES ARE FOR PLAIN, UNCOATED BARS. IF EPOXY COATED REINFORCEMENT IS REQUIRED, VALUES SHOULD BE MULTIPLIED BY 1.5 IF COVER IS LESS THAN (3) BAR DIAMETERS OR CLEAR SPACING IS LESS THAN (6) BAR DIAMETERS, VALUES SHOULD BE MULTIPLIED BY 1.2 OTHERWISE.


### STANDARD HOOK GEOMETRY AND TENSION DEVELOPMENT LENGTH

BAR		90 DEG	180	DEG	CONCRETE COMPRESSIVE STRENGTH f'c (PSI)					
SIZE	D				3000	4000	5000	6000		
		А	В	С		DEVELOPMENT	T LENGTH (INCHES)			
#3	2.25	6.00	3.00	2.50	9	8	7	6		
#4	3.00	8.00	4.00	2.50	11	10	9	8		
#5	3.75	10.00	5.00	2.50	14	12	11	10		
#6	4.50	12.00	6.00	3.00	17	15	13	12		
#7	5.25	14.00	7.00	3.50	20	17	15	14		
#8	6.00	16.00	8.00	4.00	22	19	17	16		
#9	9.00	19.25	11.25	4.50	25	22	20	18		
#10	10.25	21.50	12.75	5.00	28	25	22	20		
#11	11.25	24.00	14.00	5.75	31	27	24	22		
#14	17.00	31.50	20.25	7.00	39	34	30	28		
#18	23.00	40.75	27.00	9.00	50	43	39	35		

### **HOOK NOTES:**

- 1. DEVELOPMENT LENGTH ARE BASED ON ASTM A615 (60 KSI) REINFORCEMENT.
- 2. DIMENSION "D" INDICATES THE FINISHED STANDARD HOOK INSIDE BEND DIAMETER.
- 3. DIMENSIONS "A", "B", AND "C" INDICATE REMAINING DETAIL DIMENSIONS OF STANDARD HOOKS.
- 4. TABLE VALUES ARE BASED ON NORMAL WEIGHT CONCRETE. IF LIGHTWEIGHT CONCRETE IS REQUIRED, VALUES SHOULD BE MULTIPLIED BY 1.33 (SEE ACI 318-11 SECTION 12.5.2).
- 5. TABLE VALUES ARE FOR PLAIN, UNCOATED BARS. IF EPOXY COATED REINFORCEMENT IS REQUIRED, VALUES SHOULD BE MULTIPLIED BY 1.2 (SEE ACI 318-11 SECTION 12.5.2).

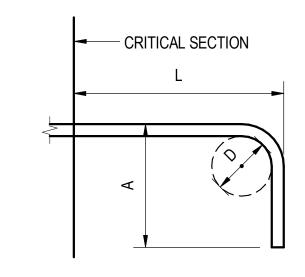

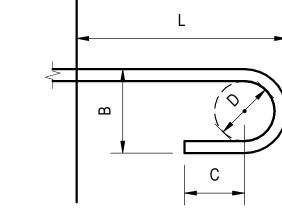

- CRITICAL SECTION

90° STANDARD HOOK

180° STANDARD HOOK







### **SENSITIVE SECURITY INFORMATION**

WARNING: THIS RECORD CONTAINS SENSITIVE SECURITY INFORMATION THAT IS CONTROLLED UNDER 49 CFR PARTS 15 AND 1520. NO PART OF THIS RECORD MAY BE DISCLOSED TO PERSONS WITHOUT A "NEED TO KNOW" AS DEFINED IN CFR PARTS 15 AND 1520, EXCEPT WITH THE WRITTEN PERMISSION OF THE ADMINISTRATOR OF THE TRANSPORTATION EAGET I WITH THE WRITTEN PERMISSION OF THE ADMINISTRATOR OF THE TRANSPORTAL SECURITY ADMINISTRATION OR THE SECRETARY OF TRANSPORTATION. UNAUTHORIZED RELEASE MAY RESULT IN CIVIL PENALTY OR OTHER ACTION. FOR U.S. GOVERNMENT AGENCIES, PUBLIC DISCLOSURE IS GOVERNED BY 5 U.S.C. 552 AND 49 CFR PARTS 15 AND 1520.

DRAWING SCALE IS NOT GUARANTEED. CTA ASSUMES NO RISK OF LIABILITY FOR ERRORS CAUSED, DIRECTLY OR INDIRECTLY, BY SCALING OF THIS DRAWING.

# 95th Terminal Improvement

15 West 95th Street (South Terminal) Chicago, IL 60628

IN CH	ARGE	J. JAKALSK	I
APPR	OVED BY	J. JAKALSK	I
CHEC	KED BY	R.S. NAIR	
DESIG	GNED BY	G. FORKAN	
DRAV	VN BY	J. PEARSON	I
PROJ	ECT NO.	2012-0021.0	2
FILE	NAME	DR095_S-Te	rminal
	10/6/16	ISSUED FOR C	ONSTRUCTION
MARK	DATE	DESCRIPTIO	N
		I	
	ATION IDE	NTIFIER:	DR095

LOCATION IDENTIFIEN. DRUSS

STRUCTURAL GENERAL NOTES -

- METAL ROOF DECK SHALL NOT BE USED FOR HANGING SUPPORTS FOR ANY TYPE OF BUILDING COMPONENTS INCLUDING, BUT NOT LIMITED TO: SUSPENDED CEILINGS, ELECTRICAL, LIGHT FIXTURES, SPRINKLER SYSTEMS, PLUMBING, HEATING, OR AIR CONDITIONING PIPED, DUCTS, OR ELECTRICAL CONDUITS.
- PROVIDE MINIMUM 16 GAGE EDGE ANGLES OR CLOSURE STRIPS AT PERIMETERS AND AROUND ALL OPENINGS, UNLESS NOTED OTHERWISE ON DRAWINGS.
- 4. FASTEN STEEL DECK TO ALL STRUCTURAL SUPPORTS WITH 3/4" DIAMETER (MIN). PUDDLE WELDS, AT A MINIMUM OF 12" O.C., UNLESS NOTED OTHERWISE. CONTRACTOR MAY CHOOSE TO UTILIZE TEK-SCREWS OR OTHER DECK FASTENING ATTACHMENTS, PROVIDED THAT A COMPLETE SUBMITTAL IS PROVIDED TO THE DOR FOR REVIEW. SUCH SUBMITTAL SHALL INDICATE THAT THE DIAPHRAGM SHEAR CAPACITY ACHIEVED THROUGH THE USE OF THE SUGGESTED ALTERNATIVE DECK FASTENERS IS GREATER THAN OR EQUAL TO THAT ACHIEVED THROUGH THE USE OF PUDDLE WELDS. FASTENERS SHALL BE ARRANGED TO PROVIDE SUFFICIENT DIAPHRAGM SHEAR CAPACITY. REFER TO TYPICAL DETAIL.

### PRECAST CONCRETE:

ALL CONCRETE UNLESS NOTED OTHERWISE, SHALL BE NORMAL WEIGHT CONCRETE WITH AN APPROXIMATE DENSITY OF 145 PCF AND DEVELOP THE FOLLOWING STRENGTH AT 28 DAYS:

DESCRIPTION f'c (28-DAYS) PRECAST CONCRETE 6,000 PSI

- REFER TO SPEC SECTION 03 40 00 AND 03 41 00 FOR PRECAST CONCRETE MIX DESIGNS AND INFORMATION NOT LISTED HEREIN.
- WELDABLE REINFORCEMENT, FOR PRECAST CONCRETE ONLY, SHALL MEET ASTM A706. LOW ALLOY GRADE 60.
- MINIMUM CLEAR CONCRETE COVER SHALL FOLLOW ACI 318-11 SECTION 7.7.3 FOR PRECAST CONCRETE, UNLESS NOTED OTHERWISE ON THE DRAWINGS.
- MECHANICAL SPLICES, COUPLER, AND TERMINATION DEVICES AS INDICATED ON DRAWINGS. SPLICE SLEEVES AND COUPLER CONNECTIONS SHALL CONFORM TO ACI 318 REQUIREMENTS AND DEVELOP AT LEAST 125 PERCENT OF THE YIELD STRENGTH OF THE BAR.
- SHOP DRAWINGS AND SCHEDULES OF ALL REINFORCING STEEL SHALL BE PREPARED BY THE CONTRACTOR AND SUBMITTED TO THE DOR FOR REVIEW PRIOR TO COMMENCEMENT OF THAT PORTION OF THE WORK. ACCESSORIES MUST BE SHOWN ON THE SHOP DRAWINGS.
- INSERTS, PLATES, STOPS, ANCHORS, ANGLES SHALL BE GALVANIZED. WELDED CONDITIONS SHALL BE REPAIRED AFTER CONNECTION HAS BEEN MADE PER ASTM A780. ALL MISC STEEL REQUIRED FOR CONNECTIONS OR BEARING SHALL BE PROVIDED WITH THE PRECAST ELEMENTS OR AS CALLED FOR ON THE DRAWINGS, ANY DEVIATION FROM THE DETAILS SHOWN ON THE DRAWINGS SHALL BE SUBMITTED FOR APPROVAL TO THE DOR PRIOR TO FABRICATION AND ERECTION.
- PRECAST CONCRETE MEMBERS SHALL BE LIFTED BY DEVICES LOCATED WITHIN TACTILE WARNING SURFACE AREA PROVIDED AND SHOWN ON THE SHOP DRAWINGS. ALL MEMBERS SHALL BE MAINTAINED IN AN UPRIGHT POSITION UNLESS DESIGNED FOR LOADS IMPOSED BY THE CONFIGURATION. ALL LIFTING DEVICES SHALL BE GALVANIZED
- THE CONTRACTOR SHALL COORDINATE ALL PENETRATIONS OF PRECAST MEMBERS, PRIOR TO FABRICATION.
- 10. ALL GROUT SHALL BE NON-SHRINK HIGH STRENGTH, GROUT AS INDICATED IN SPECIFICATIONS, UNLESS NOTED OTHERWISE ON THE DRAWINGS.

### CONCRETE MASONRY UNITS:

1. CMU SHALL MEET THE REQUIREMENT OF ASTM C90, GRADE N, TYPE 1, NORMAL WEIGHT. AND SHALL HAVE A MINIMUM COMPRESSIVE STRENGTH OF 2,500 PSI ON THE NET BEDDED AREA.

MORTAR SHALL MEET THE REQUIREMENTS OF ASTM C270, TYPE S.

GROUT SHALL MEET THE REQUIREMENTS OF ASTM C476.

- 2. HORIZONTAL JOINT REINFORCEMENT AND VERTICAL REINFORCEMENT SHALL BE PROVIDED IN ALL MASONRY CONSTRUCTION. HORIZONTAL REINFORCEMENT SHALL BE LAPPED A MINIMUM OF 6 INCHES AND SPACED 16" O.C. VERTICALLY AND PROVIDED NOT MORE THAN 16" AWAY FROM TOP AND BOTTOM OF WALL UNLESS NOTED OTHERWISE. ALL HORIZONTAL LADDER TYPE REINFORCEMENT SHALL BE GALVANIZED. ALL VERTICAL AND BOND BEAM REINFORCEMENT SHALL BE EPOXY COATED. REFER TO TYPICAL DETAILS FOR ALL OTHER INFORMATION, INCLUDING BOND BEAM SPACING REQUIREMENTS.
- 3. DOWEL ALL VERTICAL BARS TO FOUNDATIONS, BEAMS, OR SLABS, AND PROVIDE LAP 48 db OR 24 INCHES, WHICHEVER LARGER, OF 48 BAR DIAMETERS. PROVIDE STANDARD HOOKS INTO SLABS WHERE LAP CANNOT BE ACHIEVED DUE TO SLAB OR BEAM DEPTHS.
- 4. PREFABRICATED TEES AND/OR CORNER SECTIONS SHALL BE USED AT ALL WALL INTERSECTIONS.
- 5. ALL MASONRY WALLS SHALL BE BRACED UNTIL THEY ARE ATTACHED TO THE STRUCTURE OR OTHER PERMANENT BRACING HAS BEEN INSTALLED.
- 6. ALL REINFORCING SHALL BE GROUTED SOLID CONTINUOUSLY, IN CELLS OR BOND BEAMS. FILLING SUCH CORES AND BOND BEAMS WITH MORTAR IS STRICTLY PROHIBITED.
- 7. UNLESS OTHERWISE NOTED, HORIZONTAL REINFORCEMENT SHALL BE DUR-O-WALL W1.7 TRUSS OR LADDER TYPE REINFORCEMENT, OR APPROVED EQUAL, FINISH TO BE HOT DIPPED GALVANIZED.
- 8. SEE ARCHITECTURAL DRAWINGS FOR LOCATION AND CONFIGURATION OF MASONRY WALLS. THE PRESENCE OF FOLDS AND TURNS IN THE PLAN CONFIGURATION OF THE MASONRY WALL DOES NOT CHANGE THE REQUIREMENTS OF THE TYPICAL DETAILS.
- 9. WHERE SPLICES ARE REQUIRED, REBAR SHALL BE LAPPED A MINIMUM OF 48 TIMES THE DIAMETER OF THE BAR OR 24 INCHES. WHICHEVER LARGER.
- 10. FIRESTOPPING SHALL BE PROVIDED AT ALL OPEN JOINTS/GAPS THROUGH CMU WALLS. FIRESTOPPING ASSEMBLY RATINGS SHALL BE THE SAME AS THE FIRE RATING OF THE CMU WALL AT ALL JOINTS/GAPS AT THE HEAD OF NON-BEARING CMU WALLS, THE FIRESTOPPING SHALL BE COMPRESSIBLE. REFER TO ARCH DWGS FOR FIRE RATINGS OF CMU WALLS.

- 1. ALL WOOD CONSTRUCTION SHALL CONFORM TO THE "NATIONAL DESIGN SPECIFICATION" BY THE NATIONAL FOREST PRODUCT ASSOCIATION.
- 2. STRUCTURAL LUMBER SHALL HAVE THE FOLLOWING MINIMUM UNIT STRESSES:
  - FB = 875 PSI FV = 135 PSI
  - FC = 1000 PSI PARALLEL TO GRAIN
- FC = 335 PSI PERPENDICULAR TO GRAIN
- E = 1.100.000 PSI
- 3. PLYWOOD SHEATHING SHALL MEET THE REQUIREMENTS OF PRODUCT STANDARD PS-1 FOR STRUCTURAL 1 GRADE MATERIAL.
- 4. MOISTURE CONTENT SHALL NOT BE GREATER THAN 19%.
- 5. ADHESIVE BETWEEN PLYWOOD AND WOOD STRUCTURAL MEMBERS SHALL BE WEATHERPROOF AND SHALL HAVE A MINIMUM SHEAR STRENGTH OF 150 PSI, ASTM D-3498.
- 6. FOR BOLTED CONNECTIONS USE BOLTS CONFORMING TO ASTM A-307 WITH ASTM A563 NUTS. PROVIDE FLAT WASHERS.
- 7. NAILS SHALL BE COMMON NAILS, ASTM F-1667. MINIMUM NAILED CONNECTIONS FOR WOOD FRAMING MEMBERS SHALL BE IN ACCORDANCE WITH THE NAILING SCHEDULE GIVEN IN IBC TABLE 2304.9.1.
- 8. ALL EXTERIOR WOOD TO BE PRESSURE PRESERVATIVE TREATED.
- 9. GALVANIZED CONNECTORS SHALL BE USED FOR ALL OUTDOOR WOOD INSTALLATIONS.

### STRUCTURAL STEEL:

HIGH-STRENGTH BOLTS

(GALVANIZED AREAS)

1. ALL STRUCTURAL STEEL SHALL BE NEW STEEL CONFORMING TO ASTM STANDARD SPECIFICATIONS "STRUCTURAL STEEL" AS AMENDED TO DATE, UNLESS NOTED OTHERWISE ON THE CONTRACT DOCUMENTS.

2. DESCRIPTION TYPE WIDE FLANGES ASTM A992, GR 50 ASTM A36 CHANNELS AND ANGLES ASTM F1554, GR 55 **ANCHOR BOLTS** HSS TUBES ASTM A500, GR.C

HIGH-STRENGTH BOLTS ASTM A325. MECHANICALLY

PLATES ASTM A36 UNO

3. THE FOLLOWING BUILDING & CANOPY STRUCTURAL STEEL SHALL BE HOT-DIP GALVANIZED IN ACCORDANCE WITH ASTM A123. REFER TO SPECIFICATION SECTION 05 10 30.

- ALL STRUCTURAL STEEL EMBEDDED IN, AND PROTRUDING OUT OF THE FOUNDATION

ASTM A325

GALV BOLTS

- ALL NEW CONCOURSE LEVEL STEEL, FOR BOTH THE SOUTH AND NORTH TERMINALS. INCLUDING THE PEDESTRIAN WALKWAYS OVER THE DAN RYAN.
- ALL EXTERIOR STEEL AT SOFFITS AND OVERHANGS IN NON-CONDITIONED ENVIRONMENTS AT SECOND FLOOR AND ROOF LOCATIONS.
- PEDESTRIAN BRIDGE FLOOR FRAMING ONLY.
- ALL BUS CANOPY STEEL
- 4. WELDING ELECTRODES WILL BE E70XX. WELDERS, TACKERS, AND WELDING OPERATORS MUST BE AWS CERTIFIED WITHIN THE PAST SIX MONTHS.
- 5. SHOP CONNECTIONS MAY BE BOLTED OR WELDED, UNLESS THE CONNECTION METHOD IS SPECIFICALLY INDICATED ON THE STRUCTURAL DRAWINGS.
- 6. FIELD WELDING OF STRUCTURAL MEMBERS, NOT INDICATED ON THE STRUCTURAL DRAWINGS. IS NOT PERMITTED.
- 7. ALL ANCHOR BOLTS AND EMBEDDED PLATES SHALL BE GALVANIZED AND HAVE TWO HEAVY HEX NUTS (ONE TO FASTEN, ONE TO LEVEL) AND ONE WASHER UNLESS INDICATED ON THE DRAWINGS. PROVIDE ANCHOR BOLTS AND EMBEDDED PLATES TO BE SET BY OTHERS.
- 8. TOP-OF-STEEL ELEVATIONS INDICATED ON THE DRAWINGS REFER TO TOP OF TOP-BEAM FLANGE.
- THE CONTRACTOR SHALL PROVIDE ALL EMBEDDED PLATES, SLEEVES, BOX OUTS. CONDUITS, ETC, AS REQUIRED BY OTHER TRADES IN THE CONCRETE STRUCTURE.
- 10. THE CONTRACTOR SHALL PROVIDE ALL NECESSARY TEMPORARY GUYING AND BRACING REQUIRED TO ERECT AND HOLD THE STRUCTURAL STEEL FRAME DURING CONSTRUCTION.
- 11. MINIMUM SIZE OF FILLET WELDS SHALL BE 1/4" UNLESS NOTED OTHERWISE.
- 12. UNLESS OTHERWISE SHOWN PROVIDE MIN. 3/8" THICK STIFFENER PLATES ON EACH SIDE OF BEAM WHEN COLUMN OCCURS ABOVE OR BELOW BEAMS.
- 13. ALL COLUMN ENDS SHALL BE MILLED TO BEAR AND ANY MOMENT FRAME COLUMN SPLICES SHALL BE IN ACCORDANCE WITH THE TYPICAL DETAILS.
- 14. STRUCTURAL BEAM OVER COLUMN CONNECTIONS SHALL HAVE A MINIMUM 1/2" CAP PLATE WITH 4-3/4" DIAMETER HIGH STRENGTH BOLTS, UNLESS NOTED
- 15. CAMBER OF BEAMS AND GIRDERS SHALL BE AS DESIGNATED. C=X" INDICATES STEEL BEAM CAMBER VALUE AT MIDSPAN.
- 16. ALL LINTELS AND ACCESSORIES SHALL BE HOT-DIP GALVANIZED. LINTELS AND OTHER STEEL SECTIONS SHALL BEAR A MINIMUM OF 8" ON THE SUPPORTING
- 17. ALL MOMENT CONNECTIONS SHOWN AND OR NOTED ON THE DRAWINGS SHALL BE FULL PENETRATION WELDED MOMENT CONNECTIONS, UNLESS NOTED OTHERWISE

STRUCTURAL STEEL (CONTINUED):

- 18. UNLESS NOTED OTHERWISE, PROVIDE CAP PLATES ON ALL HSS MEMBERS
- DESIGN AND DETAIL ALL CONNECTIONS ACCORDING TO AISC FOR CONNECTION LOADS INDICATED ON PLANS.
- 20. FOR BUS CANOPY STEEL:
  - REMOVE ANY VISIBLE WELDING AIDS AND GRIND SMOOTH.
  - REMOVE MILL MARKS AND HIDE PIECE MARKS PRIOR TO HOT DIP GALVANIZING.
  - FOR FIELD WELDING OF COLUMN SPLICES IN GALVANIZED MATERIAL USE GALVA STOP OR SIMILAR MASKING TO PREVENT ZINC FROM ADHERING TO STEEL IMMEDIATELY ADJACENT TO FIELD WELD LOCATION.
  - FOR OTHER PREPARATION PRIOR TO HOT DIP GALVANIZING AND REPAIR AFTERWARDS REFER TO SPECIFICATION SECTION 05 10 30.









### SENSITIVE SECURITY INFORMATION

UNDER 49 CFR PARTS 15 AND 1520. NO PART OF THIS RECORD MAY BE DISCLOSED TO PERSONS WITHOUT A "NEED TO KNOW" AS DEFINED IN CFR PARTS 15 AND 1520, EXCEPT WITH THE WRITTEN PERMISSION OF THE ADMINISTRATOR OF THE TRANSPORTATION SECURITY ADMINISTRATION OR THE SECRETARY OF TRANSPORTATION. UNAUTHORIZ RELEASE MAY RESULT IN CIVIL PENALTY OR OTHER ACTION. FOR U.S. GOVERNMENT AGENCIES, PUBLIC DISCLOSURE IS GOVERNED BY 5 U.S.C. 552 AND 49 CFR PARTS 15 AND 1520.

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# 95th Terminal Improvement

15 West 95th Street (South Terminal) Chicago, IL 60628

IN CH	ARGE	J. JAKALSKI	
APPR	OVED BY	J. JAKALSKI	
CHEC	KED BY	R.S. NAIR	
DESIG	ENED BY	G. FORKAN	
DRAW	/N BY	J. PEARSON	
PROJ	ECT NO.	2012-0021.02	
FILE N	NAME	DR095_S-Terminal	
	2/9/17	ISSUED FOR CONSTRUCTION	1
MARK	DATE	DESCRIPTION	
LOC	ATION IDE	ENTIFIER: <b>DR095</b>	

STRUCTURAL GENERAL NOTES

- 2. NO FIELD WELDING IS PERMITTED EXCEPT AS SPECIFIED IN THE CONTRACT DOCUMENTS.
- 3. REINFORCEMENT BARS SHALL BE EPOXY COATED.
- 4. PRIOR TO POURING THE NEW CONCRETE DECK, ALL HEAVY OR LOOSE RUST, LOOSE MILL SCALE, AND OTHER LOOSE OR POTENTIALLY DETRIMENTAL FOREIGN MATERIAL SHALL BE REMOVED FROM THE SURFACES IN CONTACT WITH CONCRETE. TIGHTLY ADHERED PAINT MAY REMAIN UNLESS OTHERWISE NOTED. REMOVAL SHALL BE ACCOMPLISHED BY METHODS THAT WILL NOT DAMAGE THE STEEL AND THE COST WILL BE INCLUDED IN THE PAY ITEM COVERING REMOVAL OF THE EXISTING CONCRETE.

AS DIRECTED BY THE ENGINEER, EXISTING CONSTRUCTION ACCESSORIES WELDED TO THE TOP FLANGE OF BEAMS AND GIRDERS SHALL BE REMOVED. THE WELD AREAS SHALL BE GROUND FLUSH AND INSPECTED FOR CRACKS USING MAGNETIC PARTICLE TESTING (MT) OR DYE PENETRANT TESTING (PT) BY QUALIFIED PERSONNEL APPROVED BY THE ENGINEER.

ANY CRACKS THAT CANNOT BE REMOVED BY GRINDING 4 INCH DEEP SHALL BE IDENTIFIED AND REPORTED TO THE ENGINEER FOR FURTHER DISPOSITION.

- 5. IF THE CONTRACTOR ELECTS TO USE CANTILEVER FORMING BRACKETS ON THE EXTERIOR BEAMS OR GIRDERS, THE BRACKETS SHALL BE PLACED AT THE SAME LOCATIONS AS REQUIRED FOR THE HARDWOOD BLOCKS IN ARTICLE 503.06(B) OF THE STANDARD SPECIFICATIONS. IF ADDITIONAL CANTILEVER FORMING BRACKETS ARE REQUIRED, HARDWOOD BLOCKING SHALL BE WEDGED BETWEEN THE EXTERIOR AND FIRST INTERIOR BEAM AT EACH OF THESE ADDITIONAL BRACKET LOCATIONS.
- 6. PLAN DIMENSIONS AND DETAILS RELATIVE TO EXISTING PLANS ARE SUBJECT TO NOMINAL CONSTRUCTION VARIATIONS. THE CONTRACTOR SHALL FIELD VERIFY EXISTING DIMENSIONS AND DETAILS AFFECTING NEW CONSTRUCTION AND MAKE NECESSARY APPROVED ADJUSTMENTS PRIOR TO CONSTRUCTION OR ORDERING OF MATERIALS. SUCH VARIATIONS SHALL NOT BE CAUSE FOR ADDITIONAL COMPENSATION FOR A CHANGE IN SCOPE OF THE WORK.
- 7. BEARING SEAT SURFACES SHALL BE CONSTRUCTED OR ADJUSTED TO THE DESIGNATED ELEVATIONS WITHIN A TOLERANCE OF \( \begin{array}{c} & INCH (0.01 FT.). \\ ADJUSTMENT SHALL BE MADE EITHER BY GRINDING THE SURFACE OR BY SHIMMING THE BEARINGS.
- 8. CONCRETE SEALER SHALL BE APPLIED TO AREAS OF NEW CONCRETE LOCATED UNDER DECK JOINTS. THIS SHALL INCLUDE BACKWALLS, BRIDGE SEATS AND FRONT FACES OF ABUTMENT WALLS.
- 9. THE EXISTING STRUCTURAL STEEL COATING MAY CONTAIN LEAD. THE CONTRACTOR SHALL TAKE APPROPRIATE PRECAUTIONS TO DEAL WITH THE PRESENCE OF LEAD ON THIS PROJECT.
- 10. ALL CROSS FRAMES OR DIAPHRAGMS SHALL BE INSTALLED AS STEEL IS ERECTED AND SECURED WITH ERECTION PINS AND BOLTS EXCEPT AS OTHERWISE NOTED. INDIVIDUAL CROSS FRAMES OR DIAPHRAGMS AT SUPPORTS MAY BE TEMPORARILY DISCONNECTED TO INSTALL BEARING ANCHOR RODS.
- 11. LOAD CARRYING COMPONENTS DESIGNATED "NTR" SHALL CONFORM TO THE IMPACT TESTING REQUIREMENT, ZONE 2.
- 12. TWO 1#8 IN. ADJUSTING SHIMS SHALL BE PROVIDED FOR EACH BEARING IN ADDITION TO ALL OTHER PLATES OR SHIMS AND PLACED AS SHOWN ON BEARING DETAILS.
- 13. EXISTING REINFORCEMENT SHALL BE CLEANED AND INCORPORATED INTO THE NEW CONSTRUCTION IN ACCORDANCE WITH IDOT STD. SPECIFICATION SECTION 501.05. COST INCLUDED WITH CONCRETE REMOVAL.

- 14. ALL BEARING PLATES, SIDE RETAINERS, ANCHOR BOLTS, NUTS, WASHERS AND PINTLES SHALL BE GALVANIZED ACCORDING TO ASTM A153 OR A123 AS APPLICABLE.
- 15. TEMPORARY EARTH RETENTION (ERS) SHALL BE DESIGNED BY A STATE OF ILLINOIS LICENSED STRUCTURAL ENGINEER, ERS SHALL BE PROVIDED AT LOCATIONS SHOWN ON THE PLANS.
- 16. NEW BRIDGE STRUCTURAL STEEL BEAMS AND COMPONENTS SHALL BE HOT-DIP GALVANIZED IN ACCORDANCE WITH AASHTO M111. ALL ADDITIONAL STEEL ASSOCIATED WITH THE BRIDGE STRUCTURES SHALL BE IN ACCORDANCE WITH IDOT STD. SPEC SECTION 1006.
- 17. CARE SHALL BE TAKEN DURING THE DECK REMOVAL PROCESS TO AVOID DAMAGING THE EXISTING STEEL BEAMS TO REMAIN IN PLACE. THE CONTRACTOR SHALL MARK THE TOP SURFACE OF THE EXISTING DECK TO IDENTIFY THE LOCATION AND LIMITS OF THE TOP FLANGES PRIOR TO THE COMMENCEMENT OF DECK REMOVAL OPERATIONS.
- 18. IF A BEAM IS DAMAGED DURING CONSTRUCTION. IT IS THE CONTRACTORS'S RESPONSIBILITY TO REPAIR THE DAMAGE AT HIS/HER OWN EXPENSE. THE CONTRACTOR WILL BE RESPOSIBLE FOR RETAINING A LICENSED STRUCTURAL ENGINEER IN THE STATE OF ILLINOIS TO ANALYZE THE EFFECT OF THE DAMAGE, TO MAKE REPAIR RECOMMENDATIONS AND PREPARE REPAIR DETAILS. REPAIR DETAILS SHALL BE SUBMITTED TO THE ENGINEER FOR REVIEW AND CONCURRENCE PRIOR TO THE IMPLEMENTATION OF REPAIRS.
- 19. ALL EPOXY COATED REINFORCING BAR LAPS SHALL BE AS NOTED IN THE TABLE BELOW UNLESS OTHERWISE NOTED.

MINIMUM BA	AR LAPS
BARS	LAPS
#4	2'-11"
#5	3′-8"
#6	4′-5"
#7	5′- <i>1</i> 0"
#8	7′-8"
#9	9′-8"
#10	12′-4"

- 20. WHERE NEW STRUCTURAL STEEL ELEMENTS ARE CONNECTED TO AN EXISTING STEEL MEMBER, ALL NEW FASTENERS SHALL BE HIGH STRENGTH BOLTS. HOLES SHALL BE SUBPUNCHED OR SUBDRILLED  $^{II}_{16}$ " DIA. AND REAMED IN THE FIELD TO  $^{I3}_{16}$ " DIA. FOR  $^{3}_{4}$ " DIA. BOLTS, UNLESS OTHERWISE NOTED. HOLES SHALL BE SUBPUNCHED OR SUBDRILLED  $^{I3}_{16}$ " DIA. AND REAMED IN THE FIELD TO  $^{I5}_{16}$ " DIA. FOR  $^{7}_{8}$ " DIA. BOLTS, UNLESS NOTED OTHERWISE.
- 21. EXISTING STRUCTURAL STEEL SHALL ONLY BE CLEANED AND PAINTED AS REQUIRED BY THE SPECIAL PROVISION "CLEANING AND PAINTING ADJACENT AREAS OF EXISTING STEEL STRUCTURES".
- 22. ANY REINFORCEMENT BARS THAT ARE DAMAGED DURING CONCRETE REMOVAL OPERATIONS SHALL BE REPAIRED OR REPLACED USING AN APPROVED BAR SPLICER OR ANCHORAGE SYSTEM. COST INCIDENTAL TO "CONCRETE REMOVAL".
- 23. BEAMS HAVE CONNECTION PLATES AS REQUIRED BY DESIGN. ADDITIONAL STIFENERS MAY BE ADDED AT THE CONTRACTOR'S EXPENSE AS NECESSARY TO PREVENT DISTORTION OF THE GIRDERS DURING GALVANIZING. THE CONTRACTOR SHALL COORDINATE WITH THE FABRICATOR AND THE GALVANIZER TO DETERMINE IF ADDITIONAL STIFFENERS ARE NECESSARY, AND WHERE THESE SHOULD BE PLACED. ANY PROPOSED CHANGES SHOULD BE SUBMITTED TO THE ENGINEER FOR APPROVAL PRIOR TO MAKING ANY CHANGES.
- 24. TEMPORARY STIFFENER ANGLES SHALL BE BOLTED TO EACH SIDE OF THE SPLICE ENDS OF EACH BEAM SEGMENT TO PREVENT DISTORTION DURING GALVANIZING. TEMPORARY STIFFENER ANGLES SHALL BOLT OR FIT AGAINST THE TOP AND BOTTOM FLANGES AND SHALL INCLUDE SPACER TUBES TO MINIMIZE DAMAGE TO GALVANIZING DURING REMOVAL.
- 25. WORK DESIGNATED AS CONCRETE REMOVAL AND THE ASSOCIATED CLEANING AND REPAIR OF REINFORCEMENT BARS SHALL BE INCLUDED AS PART OF SITE DEMOLITION.
- 26. THESE NOTES APPLY TO SHEETS 95TH-S-101 THROUGH 95TH-S-150A, SBB-S-201 THROUGH SBB-S-235, NBB-S-301 THROUGH NBB-S-337, EXE-S-401 THROUGH EXE-S-410, EXW-S-501 THOUGH EXW-S-508. AND S-1400 THROUGH S-1408.

FFP SNN





### SENSITIVE SECURITY INFORMATION

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DRAWING SCALE IS NOT GUARANTEED.
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ERRORS CAUSED, DIRECTLY OR INDIRECTLY,
BY SCALING OF THIS DRAWING.

### 95th Terminal Improvement

14 West 95th Street (North Terminal) 15 West 95th Street (South Terminal) Chicago, IL 60628

IN CH	ARGE	S. KADERBEK
APPR	OVED BY	D.ZROKA
CHEC	KED BY	P.MAID
DESIG	GNED BY	L.SOMMER
DRAV	VN BY	T.SLEDGE
PROJ	ECT NO.	2012-0021
FILE	NAME	File Name
	10/06/16	ISSUED FOR CONSTRUCTION
MARK	DATE	DESCRIPTION

LOCATION IDENTIFIER: DR095

BRIDGE
GENERAL NOTES
(SHEET 1 OF 2)

GEN-S-003A

### BRIDGE GENERAL NOTES

- 1. The Contractor shall employ a State of Illinois Licensed Structural Engineer to review loads and design any required earth retention or other ground stabilization required to protect adjacent work.
- 2. All elevations are based upon the C.C.D. datum.
- 3. Temporary casings shall be used to maintain and prevent caving of adjacent ground and to support adjacent loadings. Temporary casings shall be used for all drilled shafts and extend to at least 10 feet below grade. The Contractor's Structural Engineer shall evaluate and determine whether the temporary casing is required to be deeper than 10 feet based on adjacent loads.
- 4. Rock socketed caissons shall use permanent casings or be drilled using the wet method to ensure that the shaft sides are maintained and to control water infiltration.
- 5. The interstitial space between the permanent casing and the temporary casing shall be filled with lean concrete with a minimum compressive strength of 3,000 psi. Grouting shall occur concurrent with the removal of the temporary casing.
- 6. The bearing elevation for the caissons has been estimated based on the soil borings provided with these Contract Documents. The actual elevation of bearing shall be determined by testing in the field. The Contractor should anticipate some variance in the actual elevation of bearing strata.
- 7. Protect the ends of all exposed reinforcing bars for follow on work with approved end protectors.
- 8. All construction work shall be arranged to avoid unscheduled interference with CTA operations.
- 9. These notes apply to sheets 95TH-S-101 through 95TH-S-150A, SBB-S-201 through SBB-S-235, NBB-S-301 through NBB-S-337, EXE-S-401 through EXE-S-410, EXW-S-501 though EXW-S-508, and S-1400 through S-1408.







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### 95th Terminal Improvement

14 West 95th Street (North Terminal) 15 West 95th Street (South Terminal) Chicago, IL 60628

S. KADERBEK

IN CHARGE


AFFROVED BT		D.ZNONA
CHEC	KED BY	P.MAID
DESIG	ENED BY	L.SOMMER
DRAW	VN BY	T.SLEDGE
PROJ	ECT NO.	2012-0021
FILE N	NAME	File Name
	10/06/16	ISSUED FOR CONSTRUCTION
IARK	DATE	DESCRIPTION
$\bigcap$	ATION IDE	NTIFIER DR095

LOCATION IDENTIFIER: DR095

BRIDGE
GENERAL NOTES
(SHEET 2 OF 2)

**GEN-S-003B** 

<u>ABBREVIATI</u>	ONS:						
ADDL	ADDITIONAL	GA	GAGE OR GAUGE	R OR RAD	RADIUS	<u>SYMBOLS:</u>	
ALT	ALTERNATE	GALV	HOT-DIP GALVANIZED	REF	REFERENCE		
ACI	AMERICAN CONCRETE INSTITUTE  AMERICAN INSTITUTE OF STEEL CONSTRUCTION	GEN	GENERAL	REINF	REINFORCE, REINFORCING, REINFORCEMENT	(GRID)	
AISC AISI	AMERICAN INSTITUTE OF STEEL CONSTRUCTION  AMERICAN IRON AND STEEL INSTITUTE	GR GB	GRADE GRADE BEAM	REM REQD	REMAINDER REQUIRED		GRID LINE MARK No.
ASTM	AMERICAN SOCIETY FOR TESTING AND MATERIALS	HMA	HOT-MIX ASPHALT	RETG	RETAINING		
AWS	AMERICAN WELDING SOCIETY	HVAC	HEATING, VENTILATING, AND AIR CONDITIONING	RET	RETURN	l	
AB APPROX	ANCHOR BOLT APPROXIMATELY	HGT HP	HEIGHT HIGH POINT	RE RD	RIGHT END ROOF DRAIN	$\wedge$	DRAWING BENICION NUMBER
ARCH	ARCHITECT OR ARCHITECTURAL	HS	HIGH STRENGTH	SCH	SCHEDULE		DRAWING REVISION NUMBER
BAL	BALANCE	H OR HORIZ	HORIZONTAL	SCHED	SCHEDULE		
BK BTW	BACK BETWEEN	IN	INCH	SECT	SECTION		
BM	BEAM	INFO INCL	INFORMATION INCLUDING OR INCLUSIVE	SC SHT	SHEAR CONNECTOR SHEET		NACHAENT CONNECTION
BRG	BEARING	ID	INSIDE DIAMETER	SLV	SHORT LEG VERTICAL		MOMENT CONNECTION
BLK	BLOCK	IF	INSIDE FACE	SIM	SIMILAR		
B OR BOT BEW	BOTTOM BOTTOM EACH WAY	INSUL INT	INSULATION INTERIOR	SOG SOE	SLAB ON GRADE SUPPORT OF EXCAVATION	FI VV VV	
BRKT	BRACKET	INV	INVERT	S	SOUTH	EL XX.XX	ELEVATION
BLDG	BUILDING	JT	JOINT	SPA	SPACING OR SPACES		
CIP CTR	CAST-IN-PLACE CENTERED OR CENTERED	KIP(S) KSI	1 KIP = 1,000 POUNDS KIPS PER SQUARE INCH	SPEC(S)	SPECIFICATIONS SPLICE LENGTH		
C	CENTERLINE	LBS	POUNDS	SPL SQ	SQUARE	X	
CG	CENTER OF GRAVITY	LE	LEFT END	SS	STAINLESS STEEL		STEPPED SLAB OR CONTOUR
Cسا	CONSTRUCTION OR CONTROL JOINT CENTER LINE	LW	LIGHT WEIGHT	STD	STANDARD		
CL	CLEAR	LWC LOC	LIGHT WEIGHT CONCRETE LOCATION	STD SPEC STL	IDOT STANDARD SPECIFICATION 2012 AND RECURING SPECIAL PROVISIONS STEEL		
CLSM	CONTROLLED LOW-STRENGTH MATERIAL	LG	LONG	SF	STEP FOOTING		SPAN DIRECTION
COL	COLUMN	LL	LOWER LEVEL	STIFF	STIFFENER		G. 7 a. C 2.1. (20 1.10.).
COMP CONC	COMPRESSION CONCRETE	LLV LP	LONG LEG VERTICAL LOW POINT	STRUCT SP	STRUCTURAL SUMP PIT		
CMU	CONCRETE MASONRY UNIT	MANUF	MANUFACTURER	SYM	SYMMETRICAL		
CONN	CONNECTION	MFR	MANUFACTURER	TEMP	TEMPERATURE OR TEMPORARY	<b>UD</b>	NORTH ARROW
CONST	CONSTRUCTION CONTINUOUS	MATL	MATERIAL	TENS	TENSION TETRACIONALENA	NORTH	
CONT DEP	DEPRESSION	MAX MECH	MAXIMUM MECHANICAL	TFE THK	TETRAFLUORETHYLENE THICK OR THICKNESS	NORTH	
DET	DETAIL	MEP	MECHANICAL, ELECTRICAL, & PLUMBING	THRD	THREADED		CDADUIC SCALE
Ld	DEVELOPMENT LENGTH	MEZZ	MEZZANINE	TB	TIE BEAM	0 2' 4' 8' 16'	GRAPHIC SCALE
D OR Ø	DIAMETER DIAMETER	MID MID-PT	MIDDLE	X	TIMES OR BY		
DIA DIM	DIMENSION	MIN	MID POINT MINIMUM	т Т&В	TOP TOP AND BOTTOM		
DIR	DIRECTION	MISC	MISCELLANEOUS	TOC	TOP OF CONCRETE	X D/C/D	
DOR	DESIGNER OF RECORD	NFPA	NATIONAL FOREST PRODUCTS ASSOCIATION	TOS	TOP OF STEEL	P/3/U	PLAN/SECTION/DETAIL
DWL(S) DN	DOWEL OR DOWELS DOWN	NF NOM	NEAR FACE NOMINAL	TOW TBG	TOP OF WALL TRANSFER GRADE BEAM	X-XX	
DWG	DRAWING	NW	NORMAL WEIGHT	TYP	TYPICAL		
EA	EACH	NWC	NORMAL WEIGHT CONCRETE	UNO	UNLESS NOTED OTHERWISE		
EE	EACH END EACH FACE	N	NORTH	UL	UPPER LAYER	( X )	
EF ES	EACH SIDE	NIC NTS	NOT IN CONTRACT NOT TO SCALE	V OR VERT VEF	VERTICAL VERTICAL EACH FACE	X-XX	
EW	EACH WAY	No. OR #	NUMBER	VEF	VERTICAL INSIDE FACE		SECTION/DETAIL REFERENCE
ELEC	ELECTRICAL	OC	ON CENTER	VIF	VERIFY IN FIELD		SECTION/DETAIL NEI ENENGE
EL OD ELEV	ELEVATOR ELEVATION	OPNG	OPENING	VOF	VERTICAL OUTSIDE FACE		
EL OR ELEV EMBED	EMBEDMENT	OPP OH	OPPOSITE OPPOSITE HAND	WCO	WEST WALL CLEAN OUT		
EQ	EQUAL	OD	OUTSIDE DIAMETER	WPG	WATERPROOFING	VIEW NUMBER	
EQUIP	EQUIPMENT	OF	OUTSIDE FACE	WWF	WELDED WIRE FABRIC		
ETC EXIST	ETCETERA EXISTING	PEN PC	PENETRATION DIJ E CAR	WWPA WWR	WESTERN WOOD PRODUCTS ASSOC	DWG NUMBER	ELEVATION (LOOKING - NORTH/WEST/EAST/SOUTH)
EXP BOLT	EXPANSION BOLT	PCC	PILE CAP PORTLAND CEMENT CONCRETE	W/	WELDED WIRE REINFORCEMENT WITH	•	
EXP JT	EXPANSION JOINT	PL	PLATE	W/O	WITHOUT	<b>-</b>	
EXT	EXTERIOR  EDACTURE CRITICAL MEMBER	PT	POINT	WP	WORK POINT		
FCM FF	FRACTURE CRITICAL MEMBER FAR FACE	PT PTB	POST-TENSIONED POST-TENSIONED BAR			VIEW NUMBER	
FL	FLOOR	PSF	POUNDS PER SQUARE FOOT				CUT SECTION/DETAIL (CROSSING REFER TO)
FT	FEET OR FOOT	PSI	POUNDS PER SQUARE INCH				oor old male (encoding the letter)
FIN	FINISH FINISHED FLOOR	PVC	POLYVINYL CHLORIDE			DWG NUMBER	
FIN FL FTG	FOOTING	PC OR P/C	PRECAST CONCRETE				
FNDN	FOUNDATION						
							REMOVAL
							I LEIVI VI LE
						<u> </u>	
							EVICTING
							EXISTING
							PROPOSED
							THOI GOLD

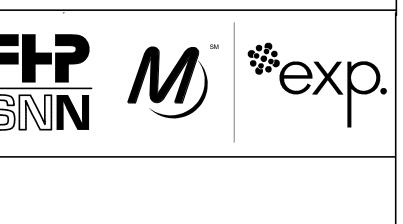



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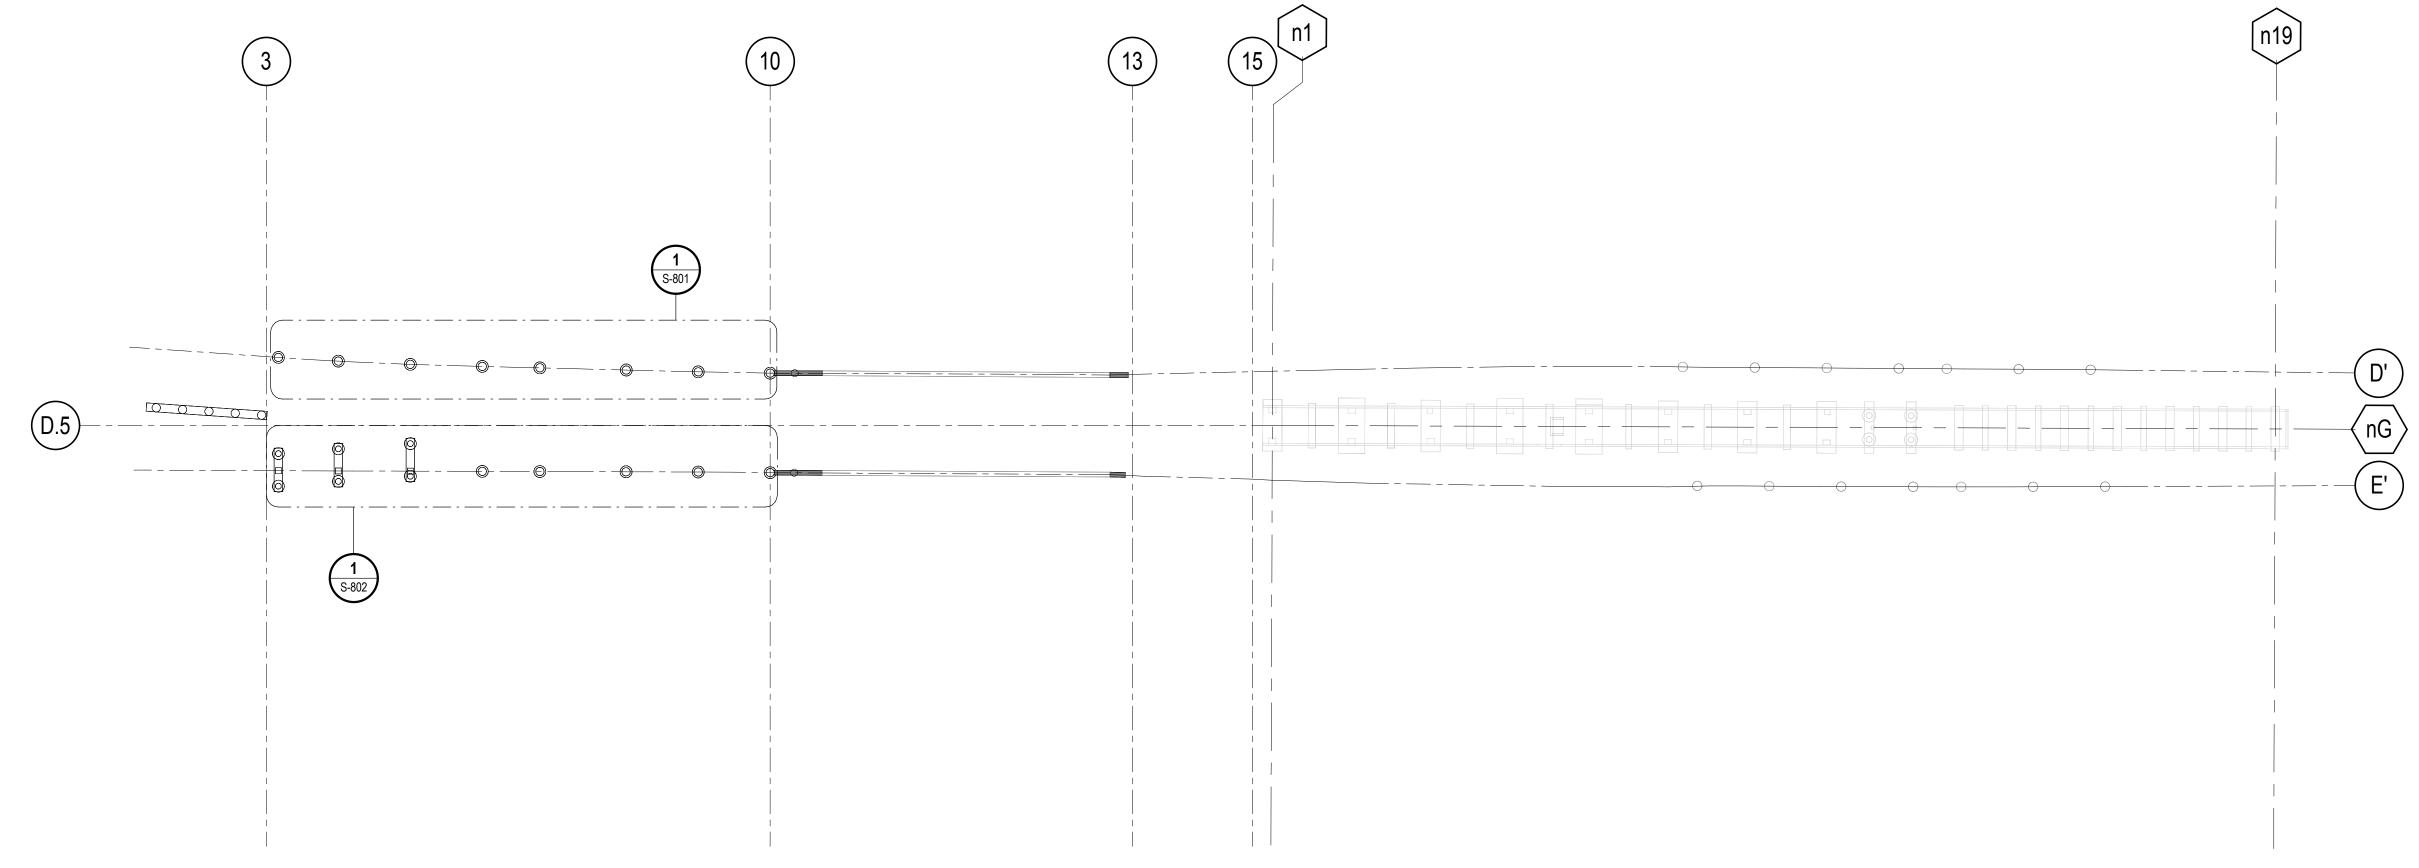
# 95th Terminal Improvement

15 West 95th Street (South Terminal) Chicago, IL 60628

IN CH	ARGE	J. JAKALSKI
APPR	OVED BY	J. JAKALSKI
CHEC	KED BY	R.S. NAIR
DESIG	ENED BY	G. FORKAN
DRAW	/N BY	M. DONAHUE
PROJ	ECT NO.	2012-0021.02
FILE N	IAME	DR095_S-Terminal
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	<u> </u>	
	2/9/17	ISSUED FOR CONSTRUCTION
MADK	_	
MARK	DATE	DESCRIPTION
LOCA	ATION IDE	NTIFIER: <b>DR095</b>

LOCATION IDENTIFIER.

STRUCTURAL ABBREVIATIONS AND SYMBOLS



NOTE: EXISTING STRUCTURE TO REMAIN.

REFERENCE KEY PLAN - FOUNDATION

S-005 SCALE: 1" = 40'-0"

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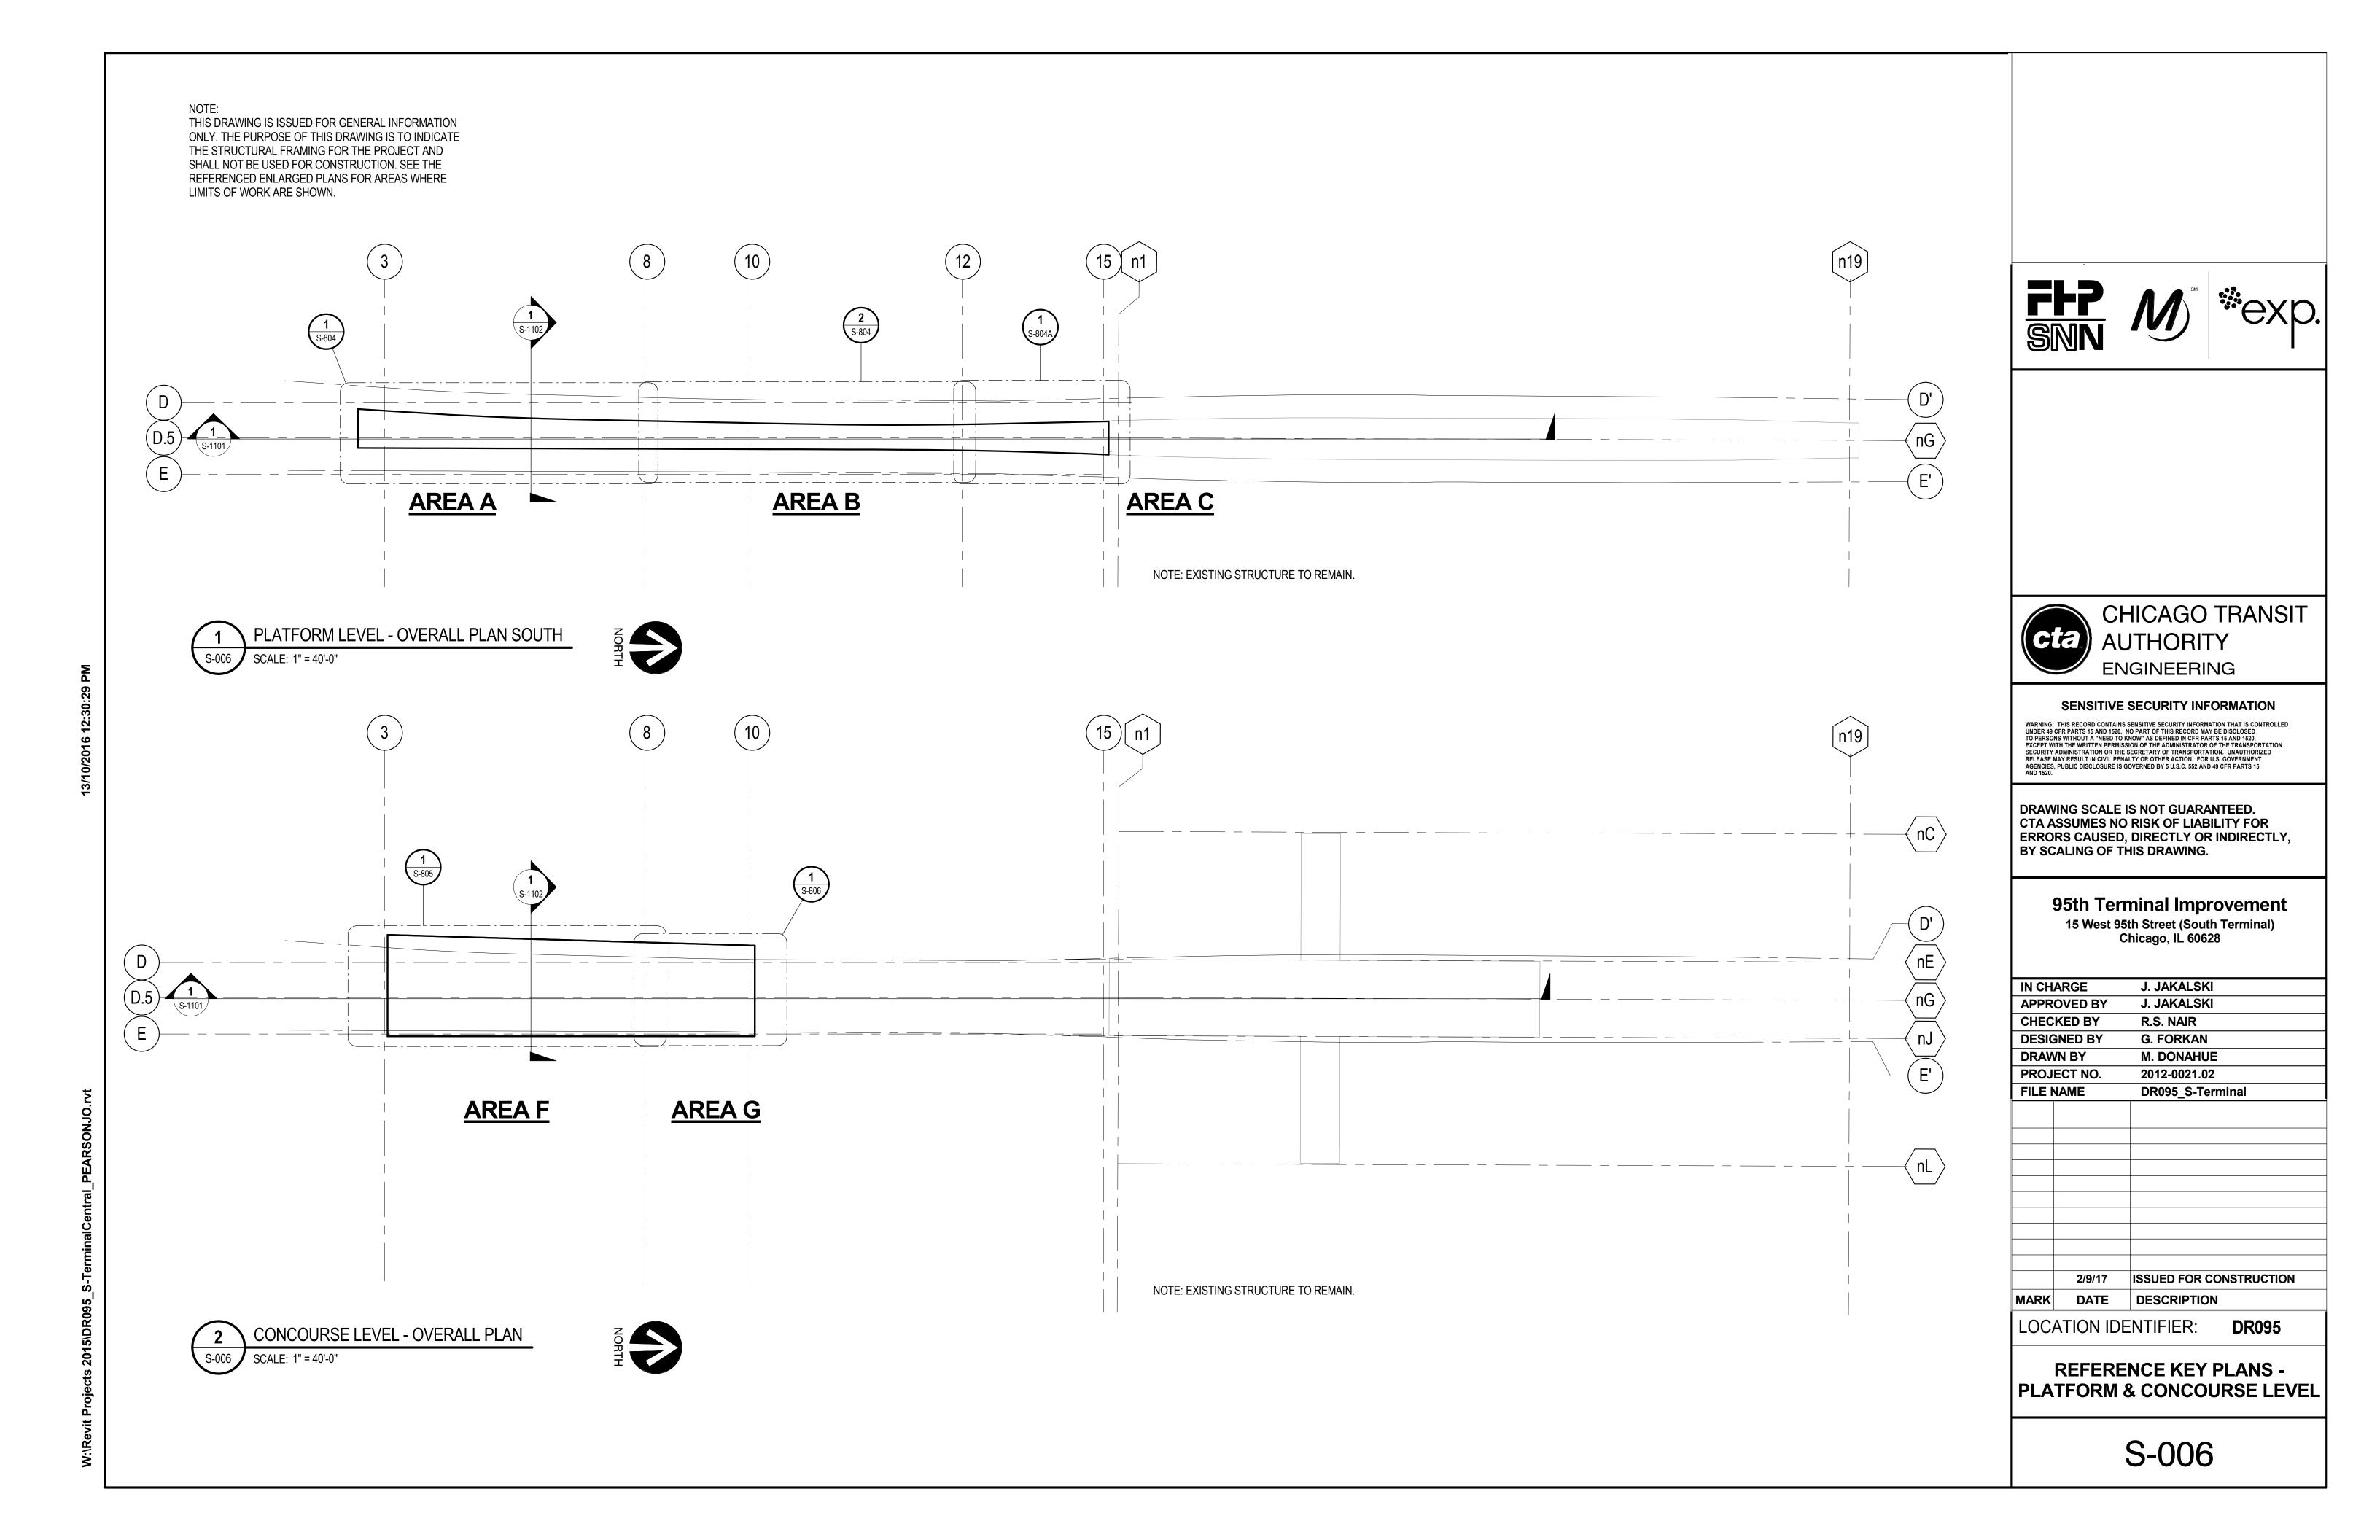
# 95th Terminal Improvement

15 West 95th Street (South Terminal) Chicago, IL 60628


IN CH	ARGE	J. JAKALSKI	
APPROVED BY		J. JAKALSKI	
CHEC	KED BY	R.S. NAIR	
DESIG	SNED BY	G. FORKAN	
DRAW	VN BY	M. DONAHUE	
PROJ	ECT NO.	2012-0021.02	
FILE N	NAME	DR095_S-StationFoundation	
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	10/6/16	ISSUED FOR CONSTRUCTION	
MARK	DATE	DESCRIPTION	
LOC	LOCATION IDENTIFIER: DR095		

LOCATION IDENTIFIER:

**REFERENCE KEY PLAN -FOUNDATIONS** 





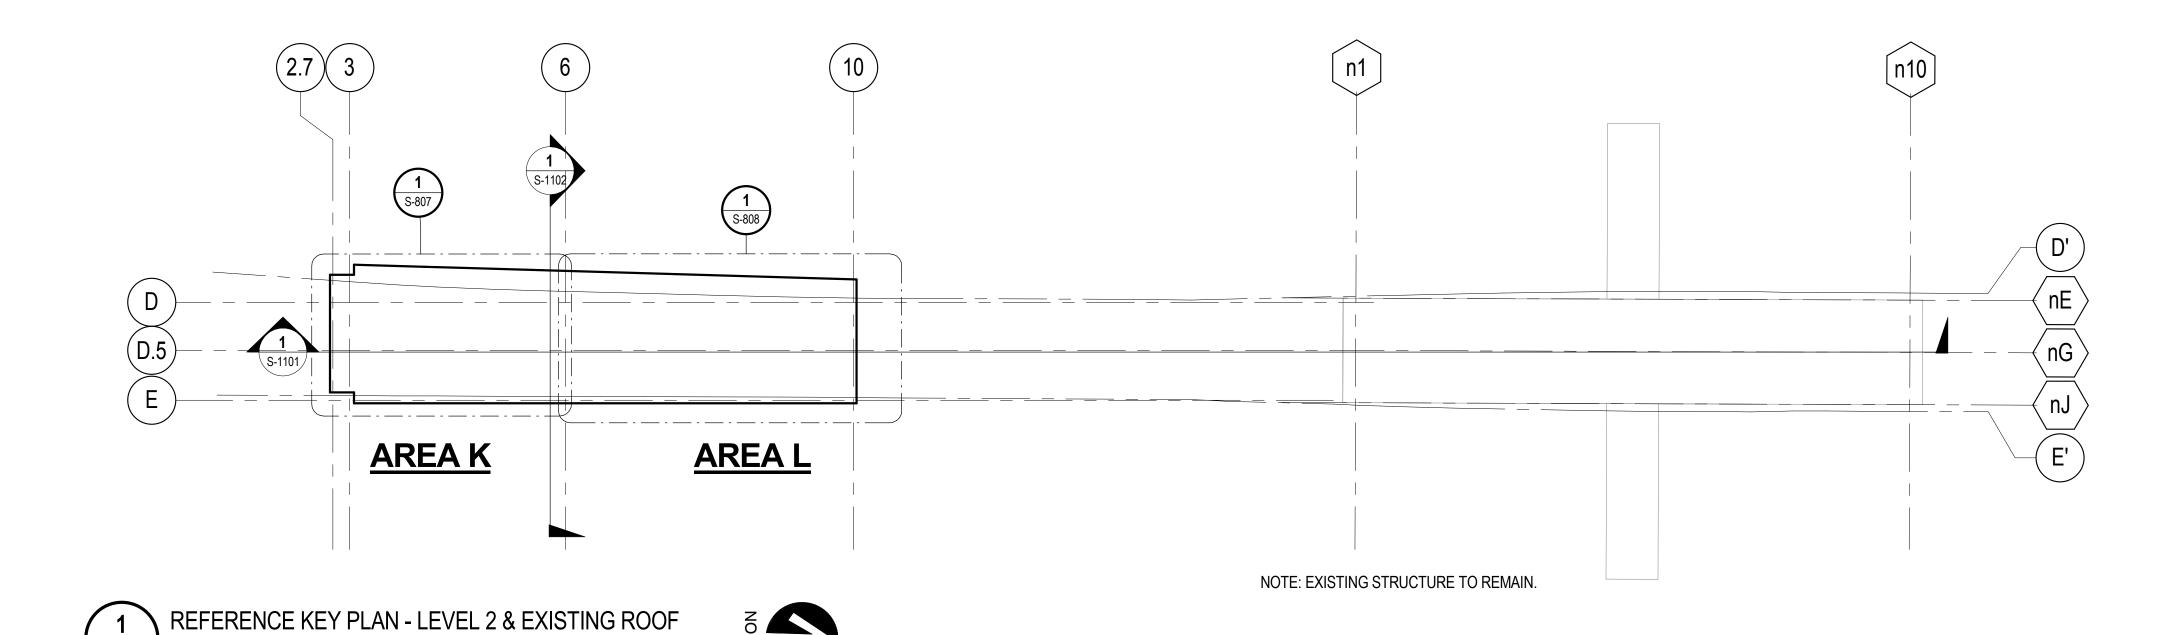

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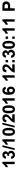
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# 95th Terminal Improvement

15 West 95th Street (South Terminal) Chicago, IL 60628


IN CH	ARGE	J. JAKALSKI	
APPR	OVED BY	J. JAKALSKI	
CHECKED BY		R.S. NAIR	
DESIGNED BY		G. FORKAN	
DRAWN BY		M. DONAHUI	<b>E</b>
PROJECT NO.		2012-0021.02	2
FILE	NAME	DR095_S-Te	rminal
	2/9/17	ISSUED FOR C	ONSTRUCTION
MADIC			
MARK	DATE	DESCRIPTION	<b>N</b>
LOC	ATION IDE	NTIFIER:	DR095


REFERENCE KEY PLAN - LEVEL 2 & EXISTING ROOF



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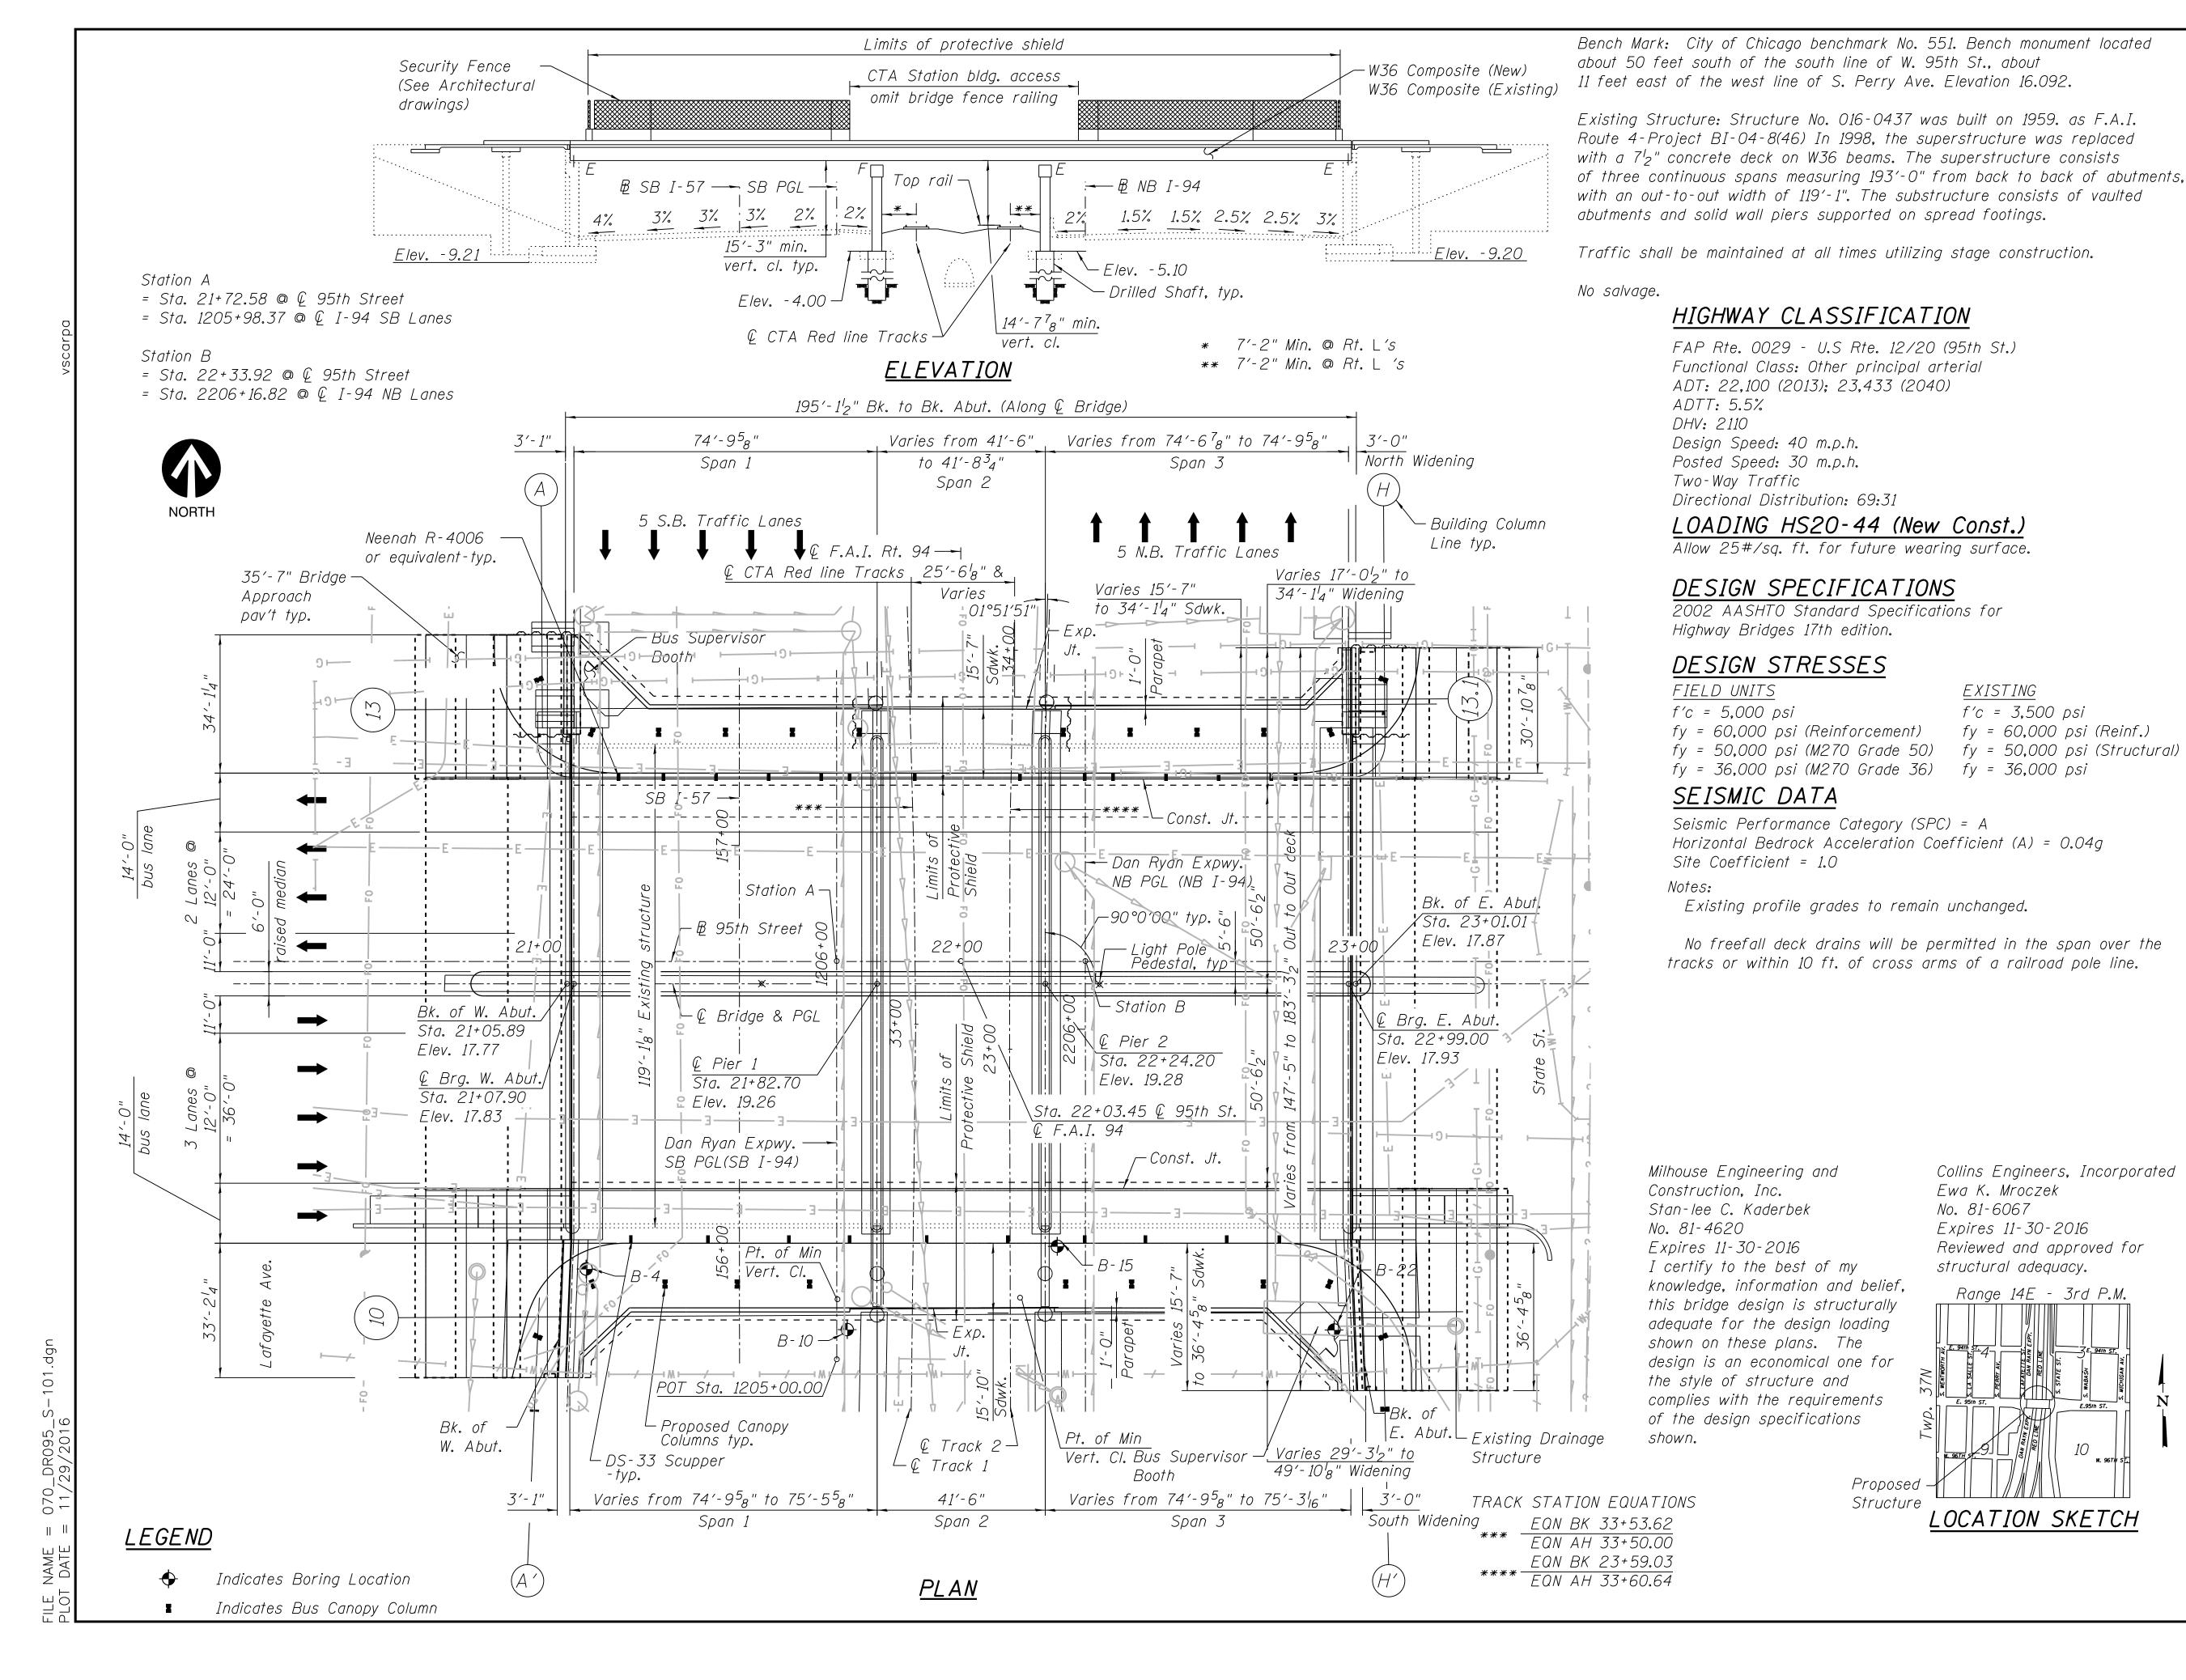
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# 95th Terminal Improvement

15 West 95th Street (South Terminal) Chicago, IL 60628

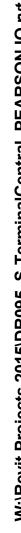IN CH	ARGE	J. JAKALSKI	
APPR	OVED BY	J. JAKALSKI	
CHEC	KED BY	R.S. NAIR	
DESIG	GNED BY	G. FORKAN	
DRAWN BY PROJECT NO.		M. DONAHUE	
		2012-0021.02	
FILE I	NAME	DR095_S-Terminal	
	2/9/17	ISSUED FOR CONSTRUC	CTION
MARK	DATE	DESCRIPTION	
		•	

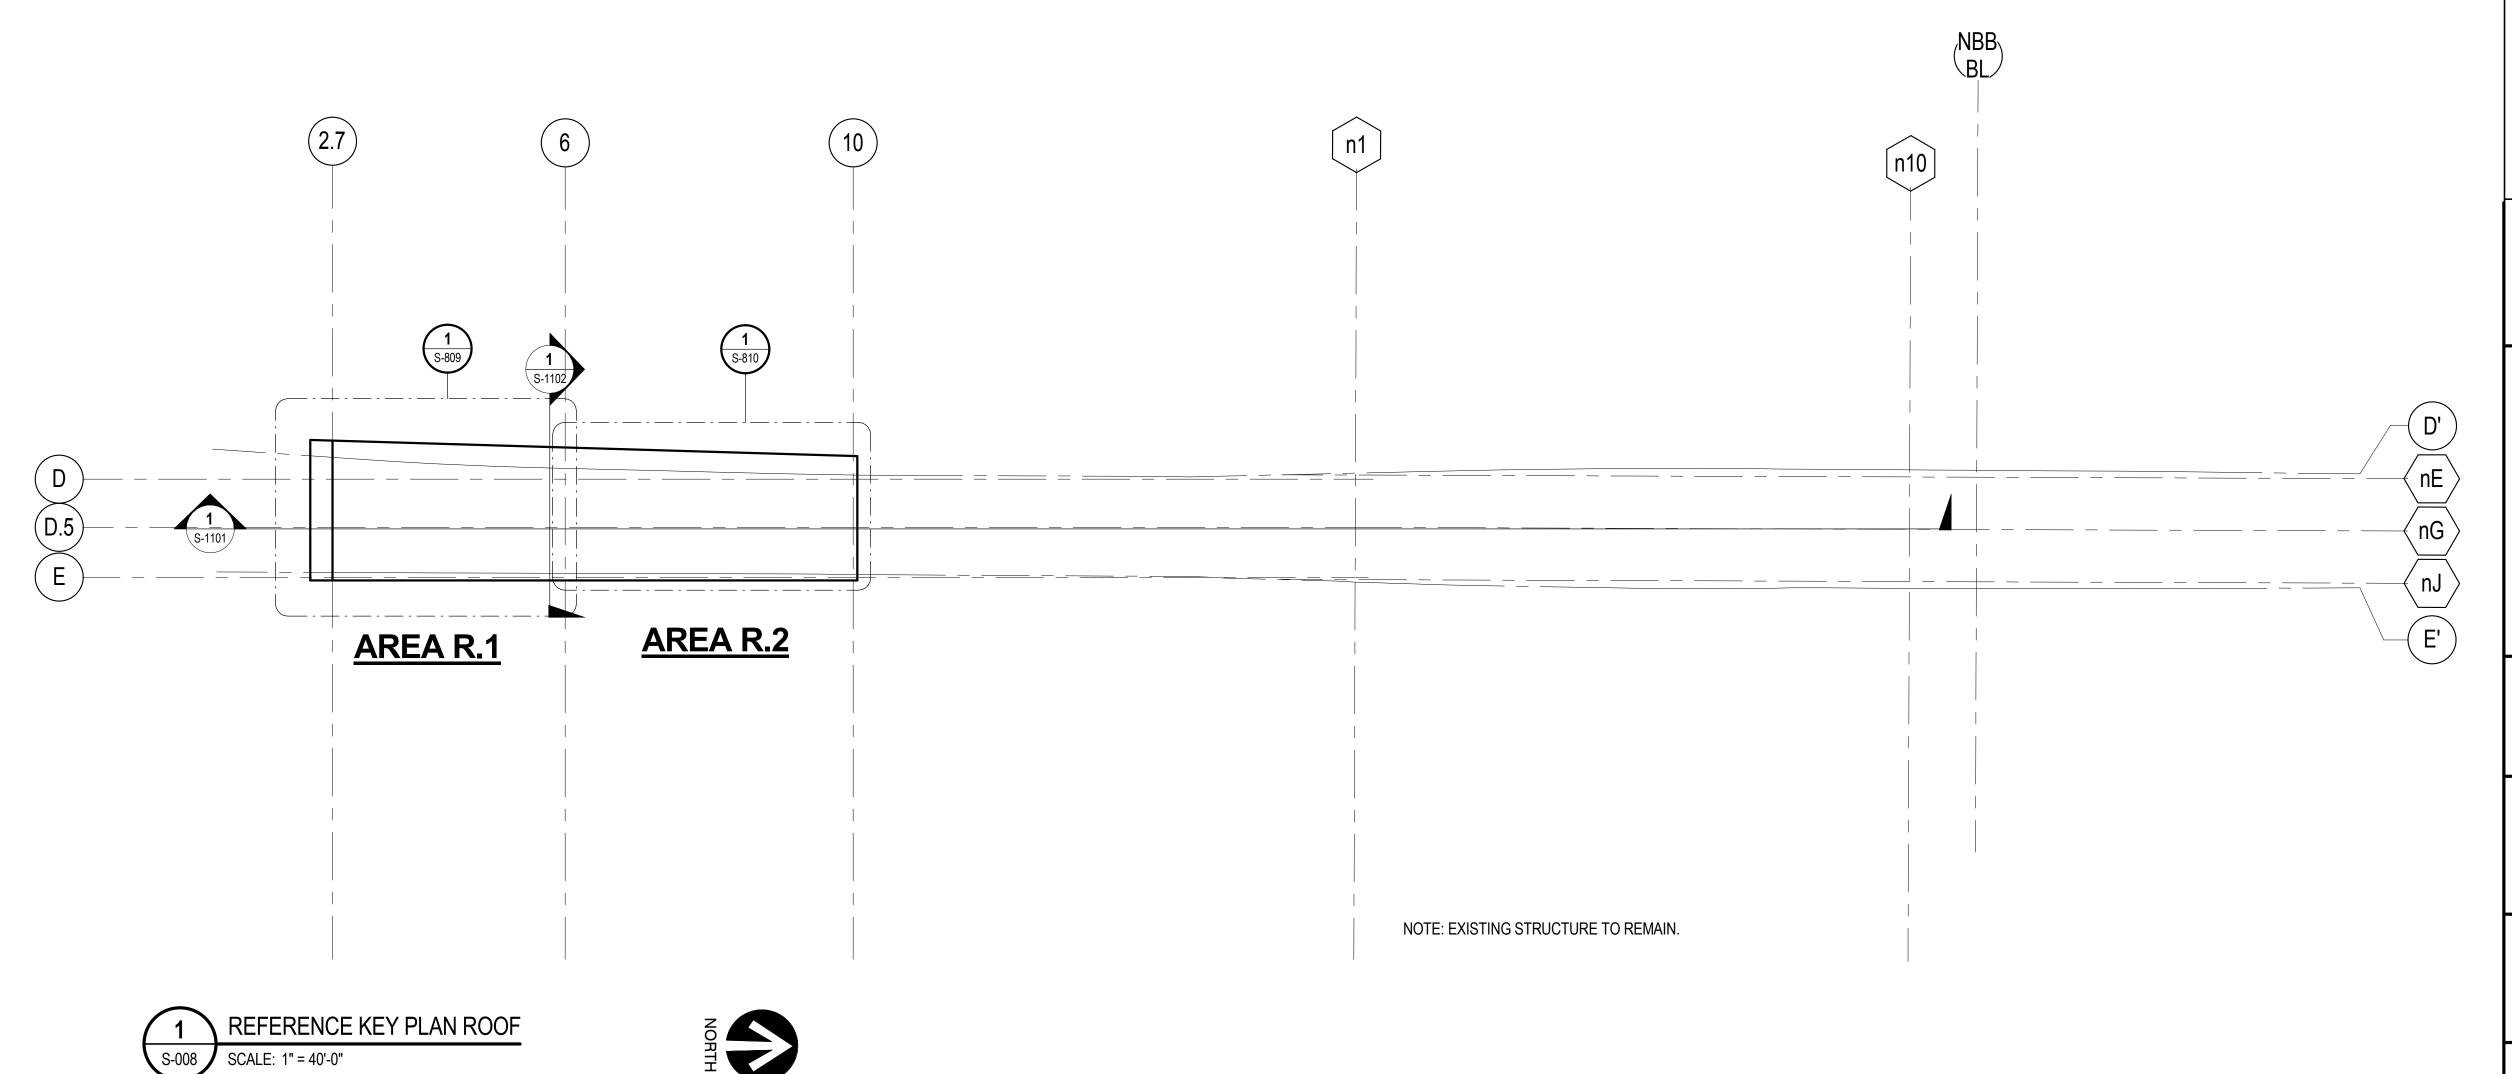**REFERENCE KEY PLAN - ROOF AND CANOPY** 



SMN



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# 95th Terminal Improvement

15 West 95th Street (South Terminal) Chicago, IL 60628


S. KADERBEK

IN CHARGE

APPF	OVED BY	D.ZROKA
CHECKED BY		P.MAID
DESI	GNED BY	L.SOMMER
DRAWN BY		T.SLEDGE
PROJ	ECT NO.	2012-0021
FILE	NAME	File Name
	2/9/17	ISSUED FOR CONSTRUCTION


LOCATION IDENTIFIER: DK095

95TH ST. BRIDGE GENERAL PLAN AND ELEVATION SN 016-0437

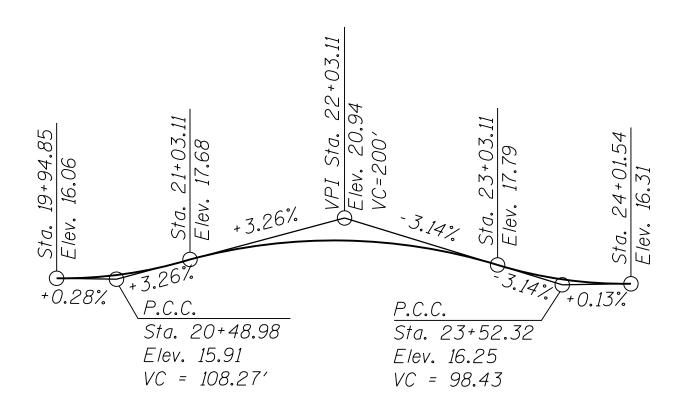


## EXISTING PROFILE GRADE

(Along © 95th St., See Note 1)

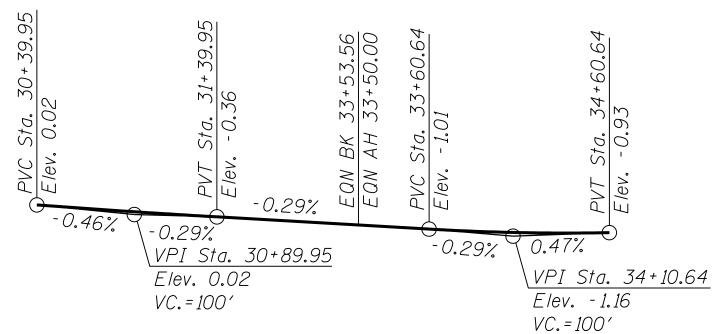


# EXISTING PROFILE GRADE

(Along Track 1)

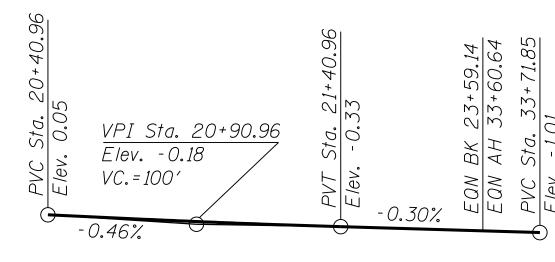


# EXISTING PROFILE GRADE

(Along Track 2)

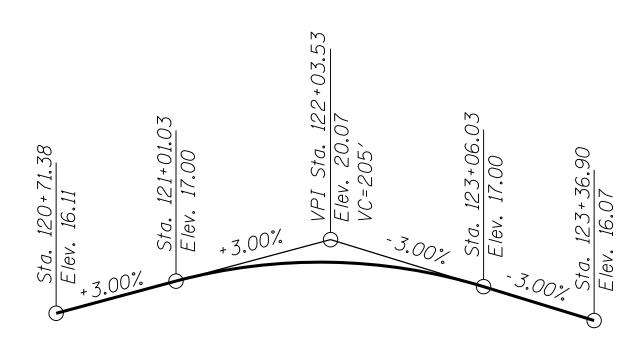


## EXISTING PROFILE GRADE

(Along South Const. Jt., See Note 1)

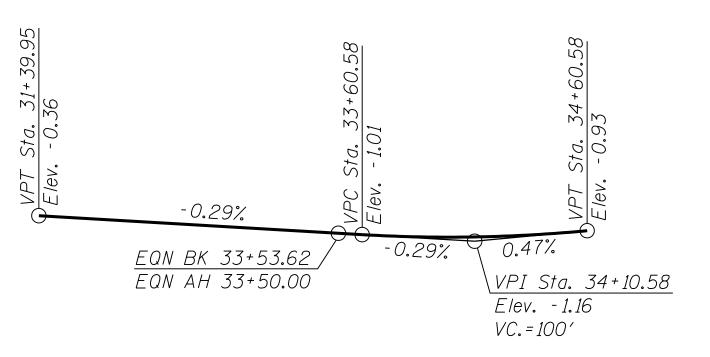


# PROPOSED PROFILE GRADE

(Along Track 1)

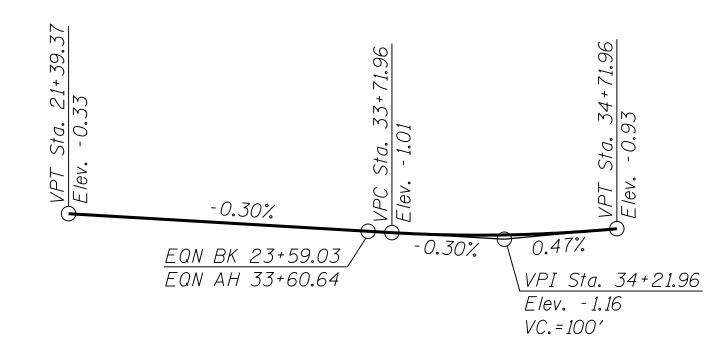


# PROPOSED PROFILE GRADE

(Along Track 2)

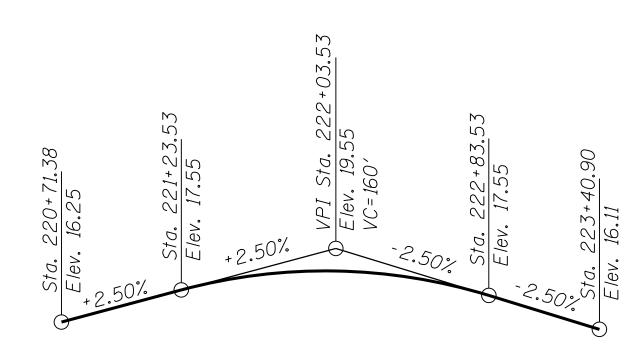


### EXISTING PROFILE GRADE

(Along North Const. Jt., See Note 1)

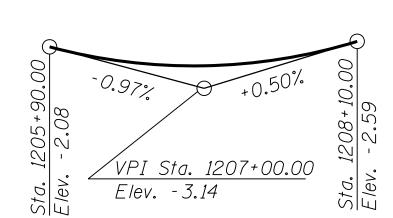

### EXISTING PROFILE GRADE

(Along SB I-94 Dan Ryan Expressway See Note 1)

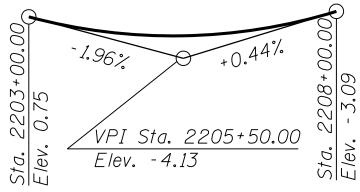

(Along NB I-94 Dan Ryan Expressway See Note 1)

# EXISTING PROFILE GRADE

LOCATION IDENTIFIER: DR095

DATE

95TH ST. BRIDGE GENERAL DATA SN 016-0437

95TH-S-102

2/9/17 ISSUED FOR CONSTRUCTION

DESCRIPTION

**CHICAGO TRANSIT** 

**AUTHORITY** 

**ENGINEERING** 

SENSITIVE SECURITY INFORMATION

DRAWING SCALE IS NOT GUARANTEED. CTA ASSUMES NO RISK OF LIABILITY FOR

BY SCALING OF THIS DRAWING.

IN CHARGE

APPROVED BY CHECKED BY

**DESIGNED BY** 

DRAWN BY PROJECT NO.

FILE NAME

MARK

ERRORS CAUSED, DIRECTLY OR INDIRECTLY,

95th Terminal Improvement

15 West 95th Street (South Terminal) Chicago, IL 60628

D.ZROKA

P.MAID L.SOMMER

T.SLEDGE


2012-0021

File Name

S. KADERBEK

*Note:* 

1. Existing profiles are representative of a best fit from field survey by Sanchez & Associates Land Surveying on 05-21-2013 and 09-29-2014. Existing profile grade is to remain unchanged.

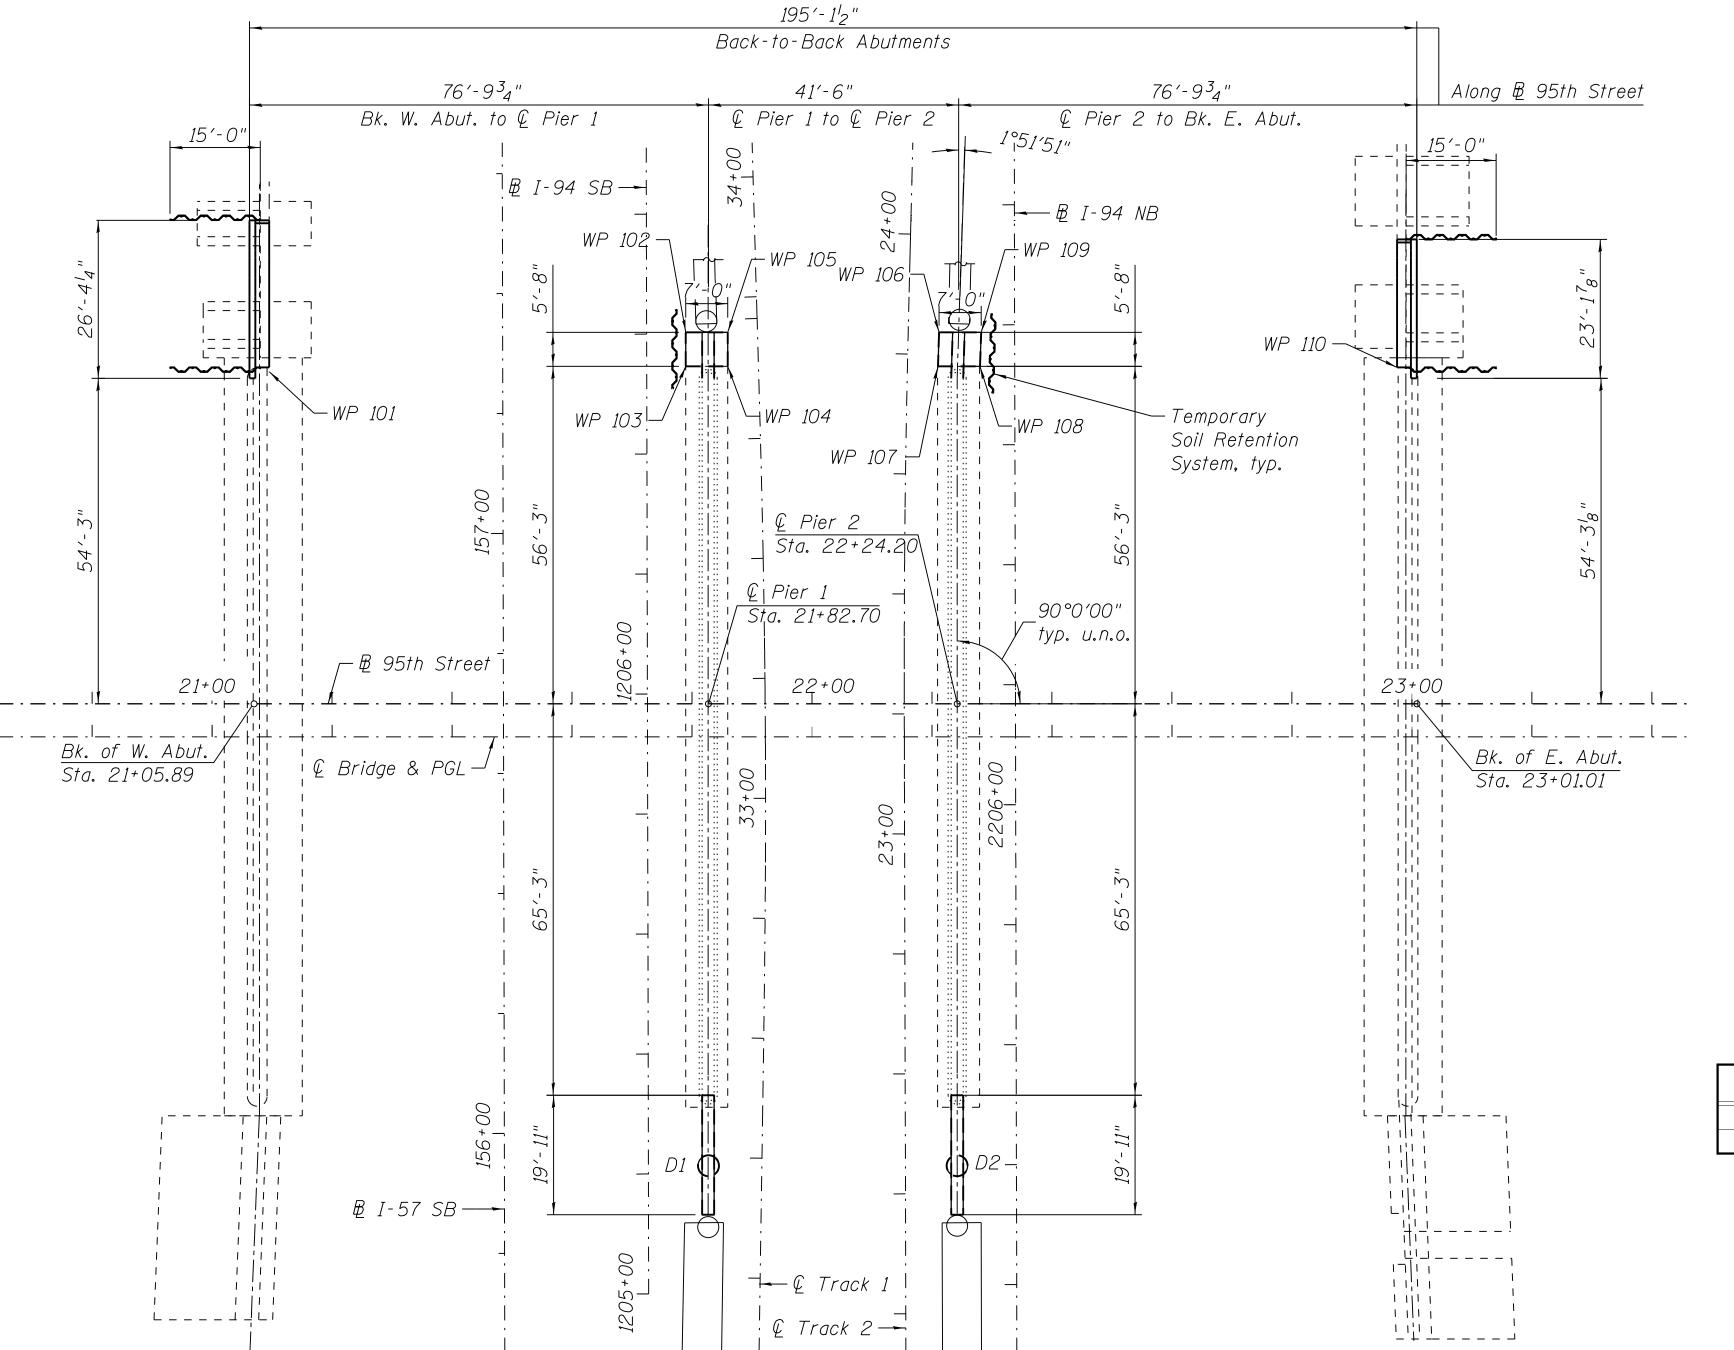

FOUNDATION PLAN



### WORK POINTS

	<u> </u>		
WP No.	Station	Offset	Baseline
101	1206+54.59	-62.926	SB I-94
102	1206+60.28	6.510	SB I-94
103	1206+54.62	6.547	SB I-94
104	1206+54.59	13.547	SB I-94
105	1206+60.26	13.509	SB I-94
106	2206+78.77	- 12.592	NB I-94
107	2206+73.10	- 12.826	NB I-94
108	2206+73.08	- 5.826	NB I-94
109	2206+78.74	- 5.589	NB I-94
110	2206+72.77	63.741	NB I-94

## <u>DRILLED SHAFTS</u>

Drilled Shaft	Station	Offset	Baseline
D1	1205+21.39	10.002	SB I-94
D2	2205+39.99	- 9.863	NB I-94

### 0100

- 1. For South Widening Abutment Details, See Advance Package 2 Plans.
- 2. For North Widening Abutment Details, See Sheets 95TH-S-135 and 95TH-S-140. 3. For Pier Widening Details, See sheets 95TH-S-145, 95TH-S-146, 95TH-S-148, 95TH-S-149 & 95TH-S-150.
- 4. Work Points are based on Alignments Established on Sheets V-100 thru V-104.







### SENSITIVE SECURITY INFORMATION

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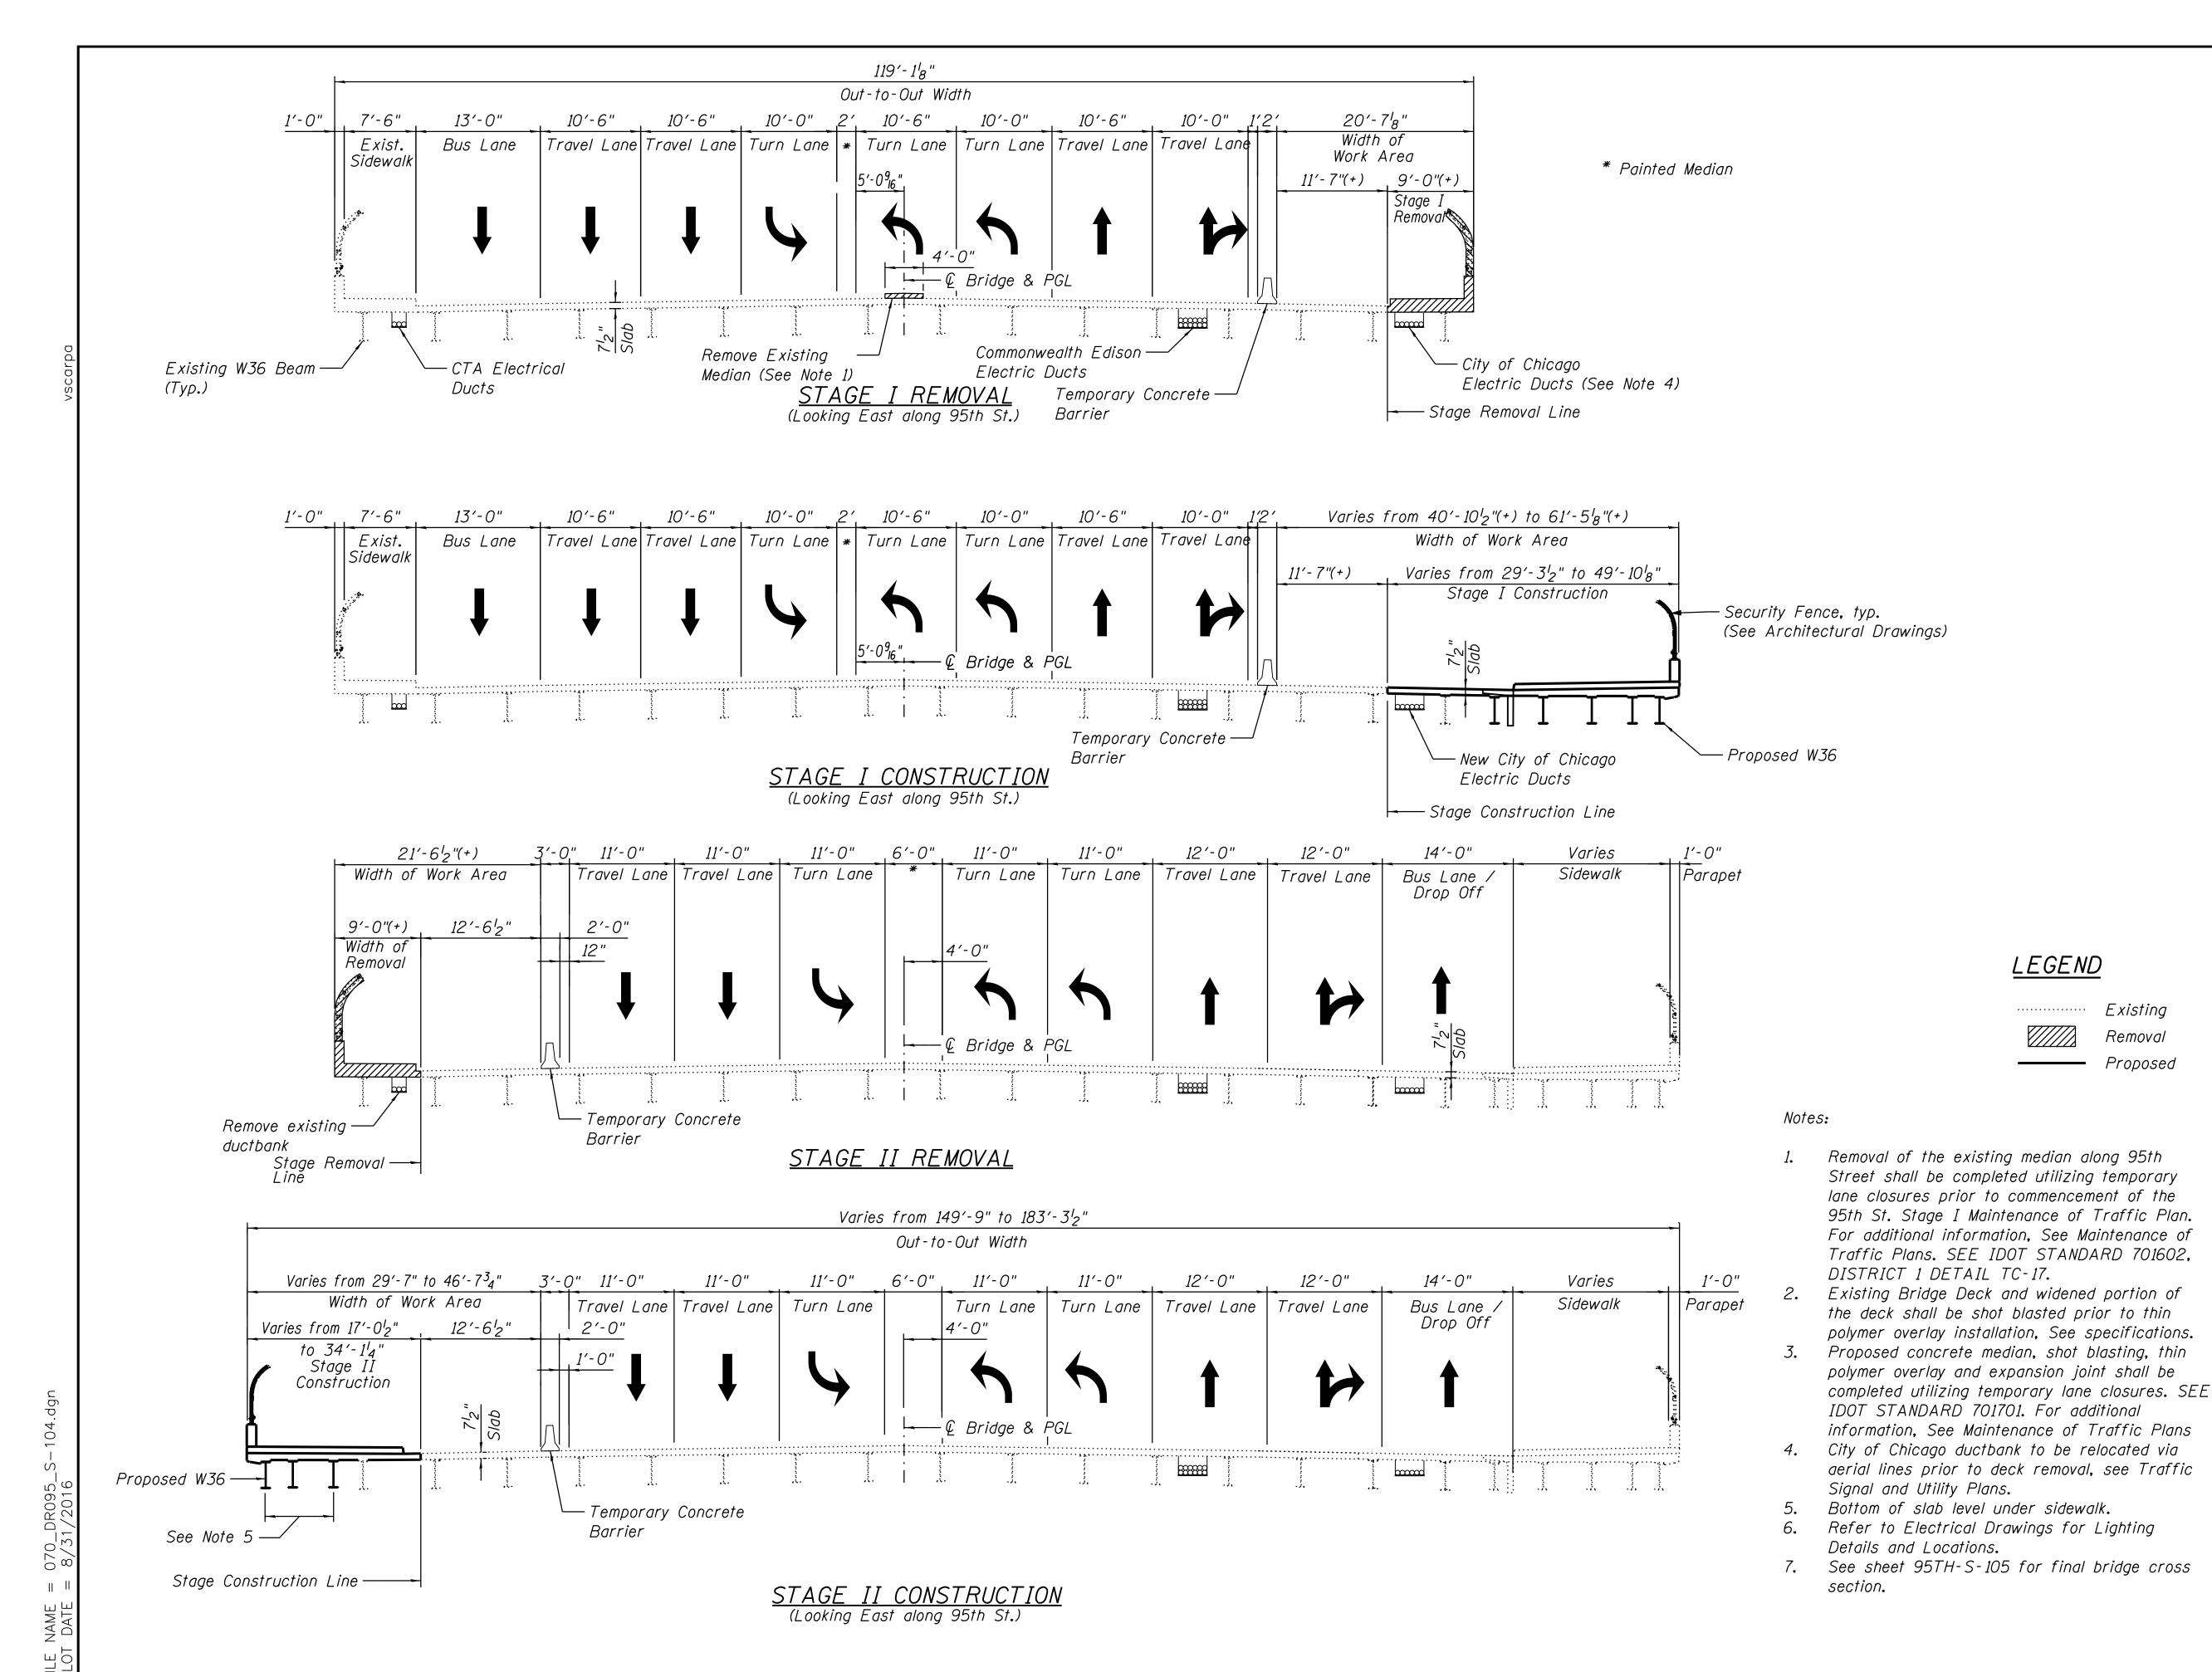
## 95th Terminal Improvement

14 West 95th Street (North Terminal) 15 West 95th Street (South Terminal) Chicago, IL 60628

	<u> </u>	90, 000_0
IN CHARGE		S. KADERBEK
APPR	OVED BY	D.ZROKA
CHEC	KED BY	P.MAID
DESIG	GNED BY	L.SOMMER
DRAV	VN BY	T.SLEDGE
PROJ	ECT NO.	2012-0021
FILE I	NAME	File Name
	10/06/16	ISSUED FOR CONSTRUCTION
MARK	DATE	DESCRIPTION

LOCATION IDENTIFIER: DR095

95TH ST. BRIDGE FOOTING LAYOUT SN 016-0437





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LEGEND

Existing

Removal

Proposed

# 95th Terminal Improvement

15 West 95th Street (South Terminal) Chicago, IL 60628

IN CH	ARGE	S. KADERBEK
APPR	OVED BY	D.ZROKA
CHEC	KED BY	P.MAID
DESIG	SNED BY	L.SOMMER
DRAV	VN BY	T.SLEDGE
PROJ	ECT NO.	2012-0021
FILE I	NAME	File Name
	2/9/17	ISSUED FOR CONSTRUCTIO
		DESCRIPTION
MARK	DATE	

### LOCATION IDENTIFIER.

95TH ST. BRIDGE STAGE CONSTRUCTION DETAILS (SHEET 1 OF 3) SN 016-0437

FINAL CROSS SECTION

(Looking East)

\* Parapets are omitted at the building entrances

Notes:

1. The  $^38$ " Thin Polymer Overlay to be included on the new and existing bridge decks, shall be inaccordance with specification 32 13 33.





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# 95th Terminal Improvement 15 West 95th Street (South Terminal) Chicago, IL 60628

IN CHARGE S. KADERBEK

APPROVED BY D.ZROKA

CHECKED BY P.MAID

DESIGNED BY L.SOMMER

DRAWN BY T.SLEDGE

PROJECT NO. 2012-0021
FILE NAME File Name

2/9/17 ISSUED FOR CONSTRUCTION
MARK DATE DESCRIPTION


LOCATION IDENTIFIER: DR095

95TH ST. BRIDGE
STAGE CONSTRUCTION DETAILS
(SHEET 3 OF 3)
SN 016-0437

When "A" is 3'-1'' or less, the temporary concrete barrier shall be restrained to the new slab according to Detail I or Detail II. No restraint is required when "A" is greater than 3'-1''.

\* Dimension shown is minimum required embedment into concrete. If hot-mix asphalt wearing surface is present, minimum embedment shall be in addition to wearing surface depth.

\*\* If existing deck beam is to remain in place after stage construction, embedment shall only be into wearing surface and not into existing deck beam concrete.

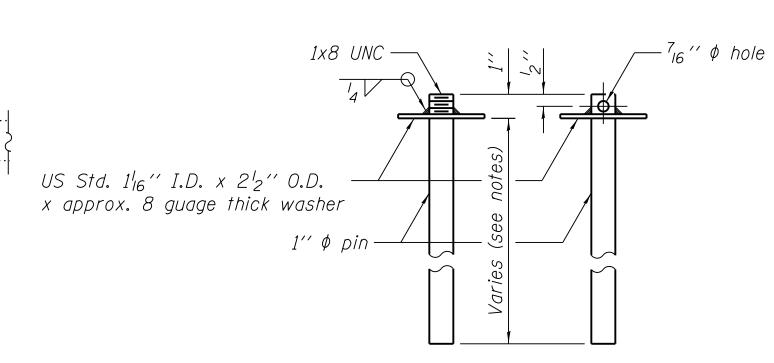

RESTRAINING PIN

### NEW SLAB

## SECTIONS THRU SLAB OR DECK BEAM

Temporary Concrete Barrier. No restraint

is required when "A" is greater than 3'-1".

Stage removal line

Temporary Concrete Barrier

See Standard 704001


1'-10<sup>1</sup>2''

EXISTING SLAB

Stage removal line


EXISTING DECK BEAM

1'-10<sup>1</sup>2''

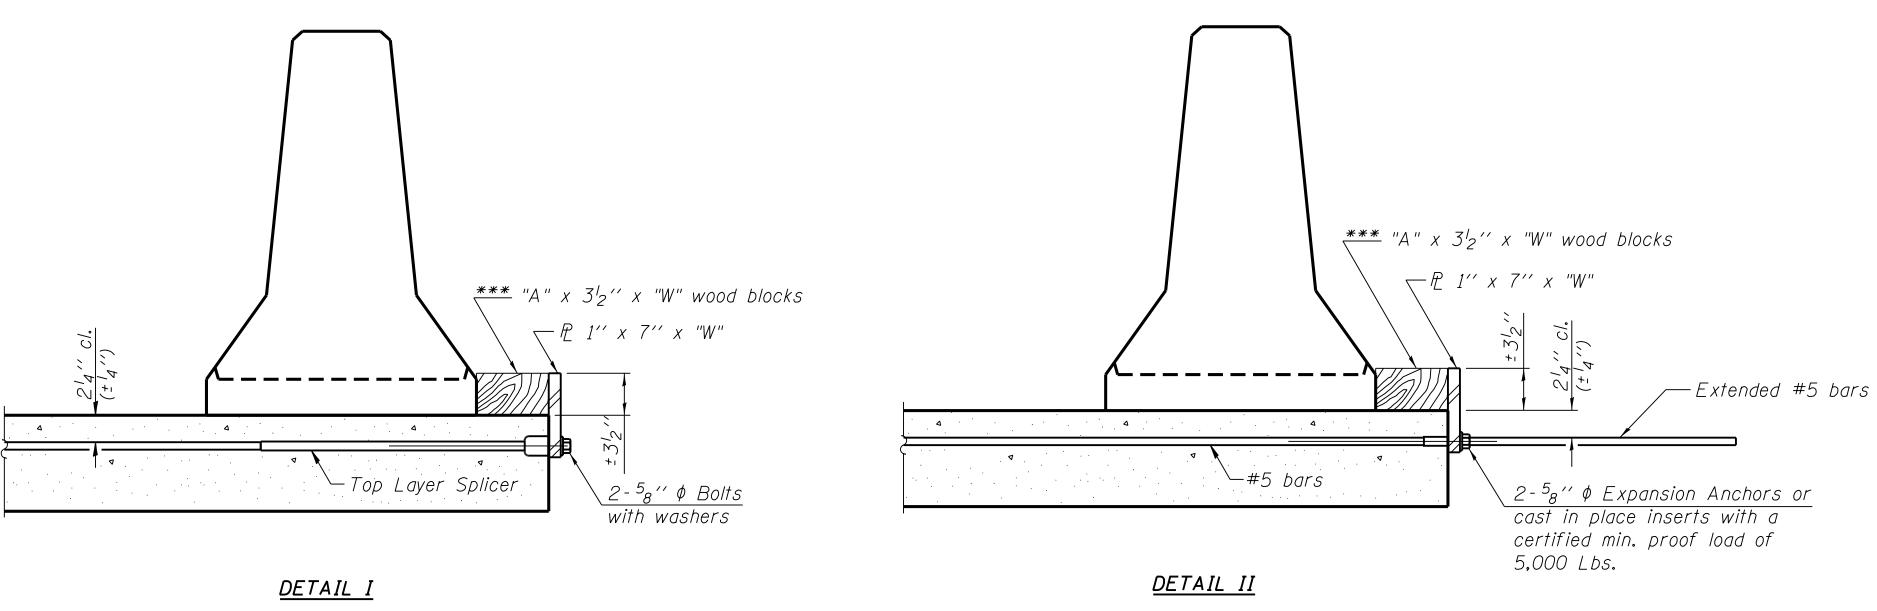

## RETAINER ASSEMBLY

\*\*\* Wood blocks may be omitted when required to provide minimum stage traffic lane width. When the wood blocks are omitted, the concrete barrier shall be in direct contact with the steel retainer plate.

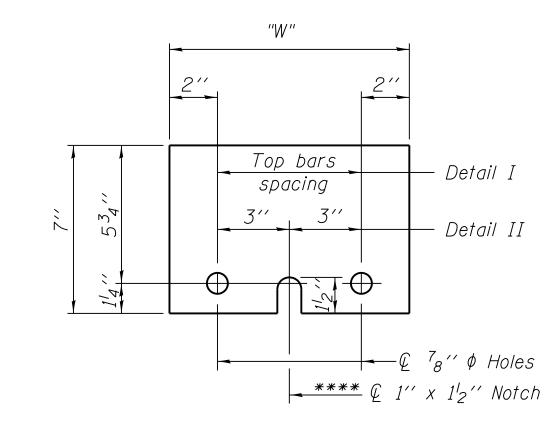

# STEEL RETAINER P 1" x 7" x "W"

\*\*\*\* Required only with Detail II

### NOTES

Detail I - With Bar Splicer or Couplers: Connect one (1)  $1'' \times 7' \times 1'' \times 1$ top layer of couplers with  $2 - \frac{5}{8}$ "  $\phi$  bolts screwed to coupler at approximate & of each barrier panel.

Detail II - With Extended Reinforcement Bars: Connect one (1)  $1'' \times 7'' \times ''W''$  steel  $P_c$  to the concrete slab or concrete wearing surface with 2- $^{5}8$  $^{\prime\prime}$   $\phi$ Expansion Anchors or cast in place inserts spaced between the top layer of reinforcement at approximate © of each barrier panel.

Cost of retainer assembly is included with Temporary Concrete Barrier. The 1" x 7" x "W" plate shall not be removed until stage II construction forms and all reinforcement bars are in place and the concrete is ready to be placed.





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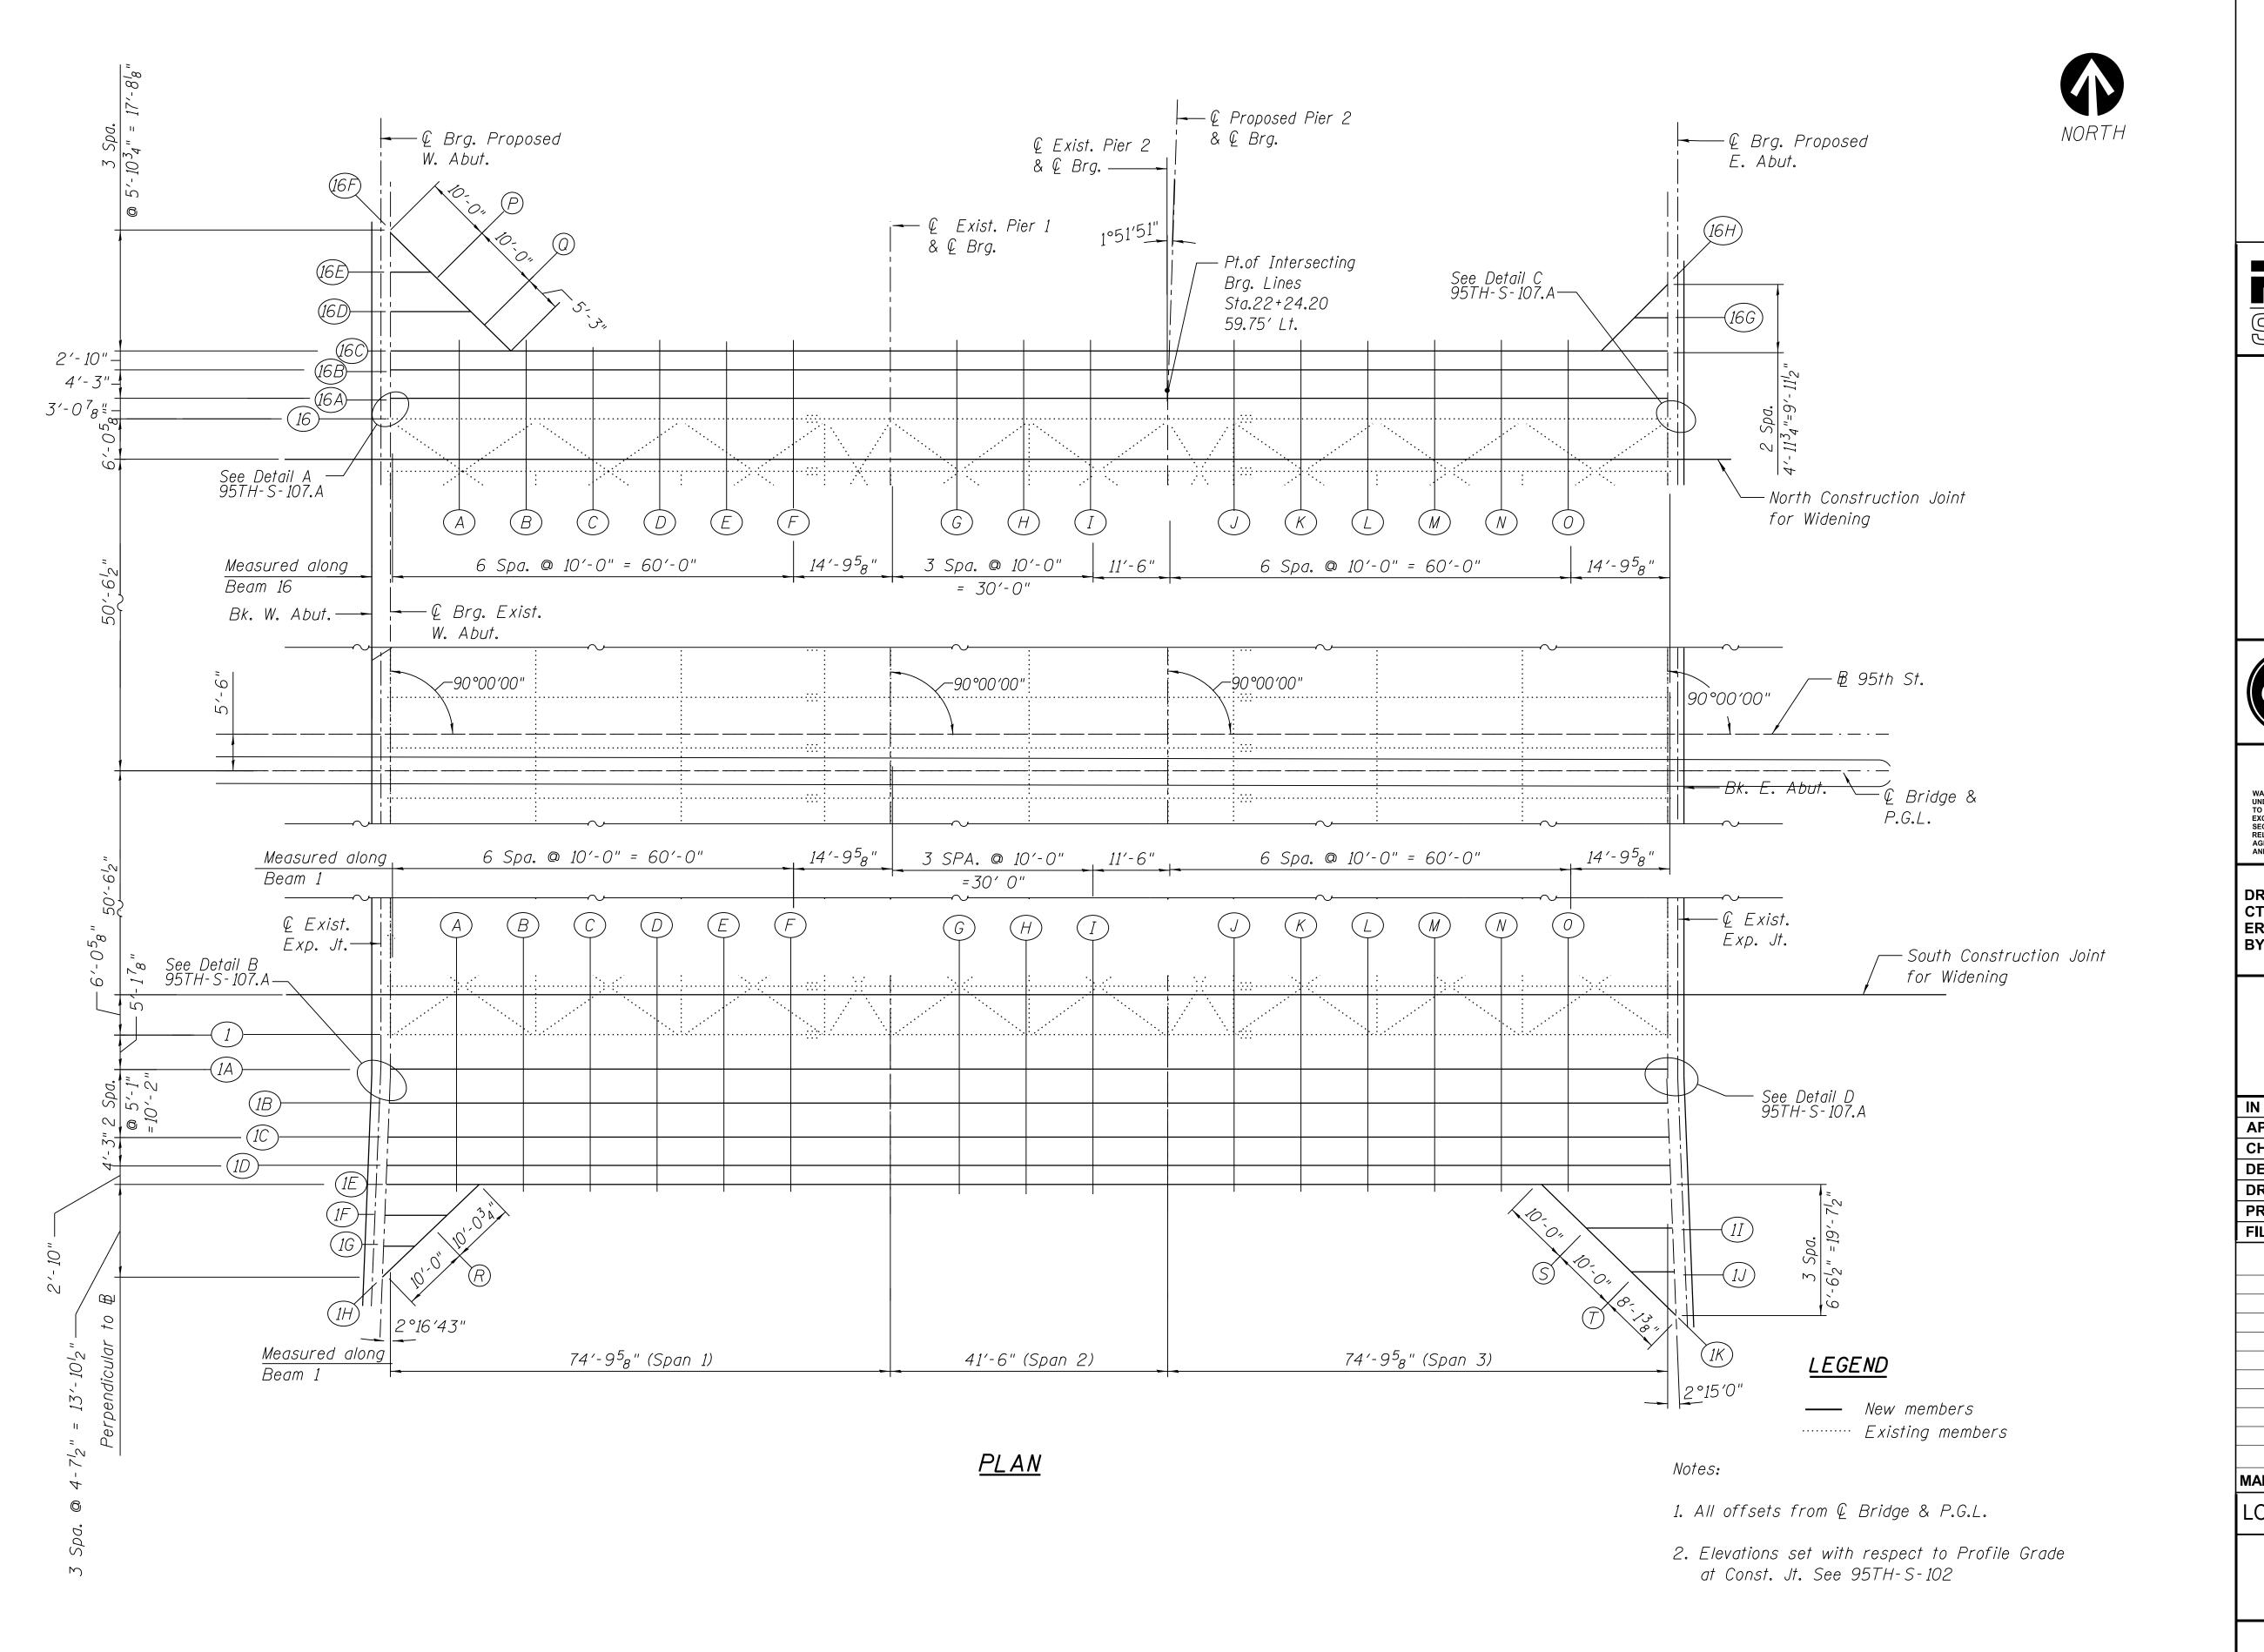
# 95th Terminal Improvement

15 West 95th Street (South Terminal) Chicago, IL 60628

RGE VED BY	S. KADERBEK D.ZROKA
VED BY	D ZDOKA
	D.ZROKA
ED BY	P.MAID
IED BY	L.SOMMER
I BY	T.SLEDGE
CT NO.	2012-0021
ME	File Name
2/9/17	ISSUED FOR CONSTRUCTION
DATE	DESCRIPTION
	2/9/17

LOCATION IDENTIFIER: DR095

95TH ST. BRIDGE TEMPORARY CONCRETE BARRIER SN 016-0437



 $= 070_DR095_S-107.dgn$ = 8/31/2016

FILE NAME PLOT DATE





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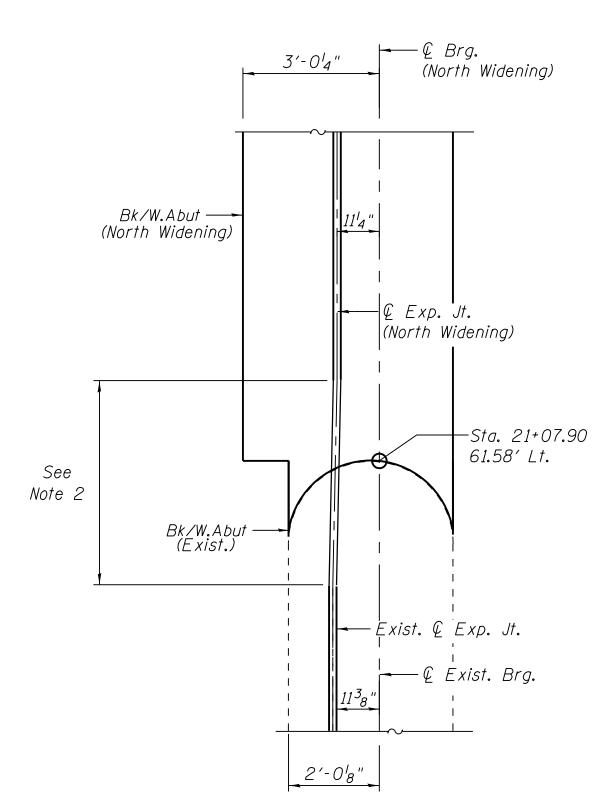
# 95th Terminal Improvement

15 West 95th Street (South Terminal) Chicago, IL 60628


MARK	DATE	DESCRIPTION
	2/9/17	ISSUED FOR CONSTRUCTION
FILE N	NAME	File Name
	ECT NO.	2012-0021
	VN BY	T.SLEDGE
DESIC	SNED BY	L.SOMMER
CHEC	KED BY	P.MAID
APPR	OVED BY	D.ZROKA
IN CH	ARGE	S. KADERBEK

LOCATION IDENTIFIER: DR095


95TH ST. BRIDGE TOP OF SLAB ELEVATIONS (SHEET 1 OF 6) SN 016-0437






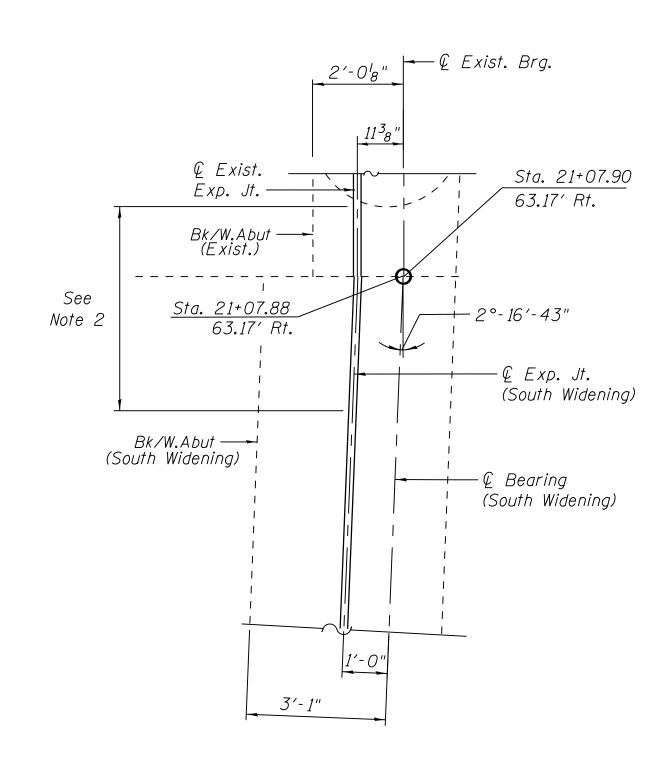

<u>DETAIL B</u>

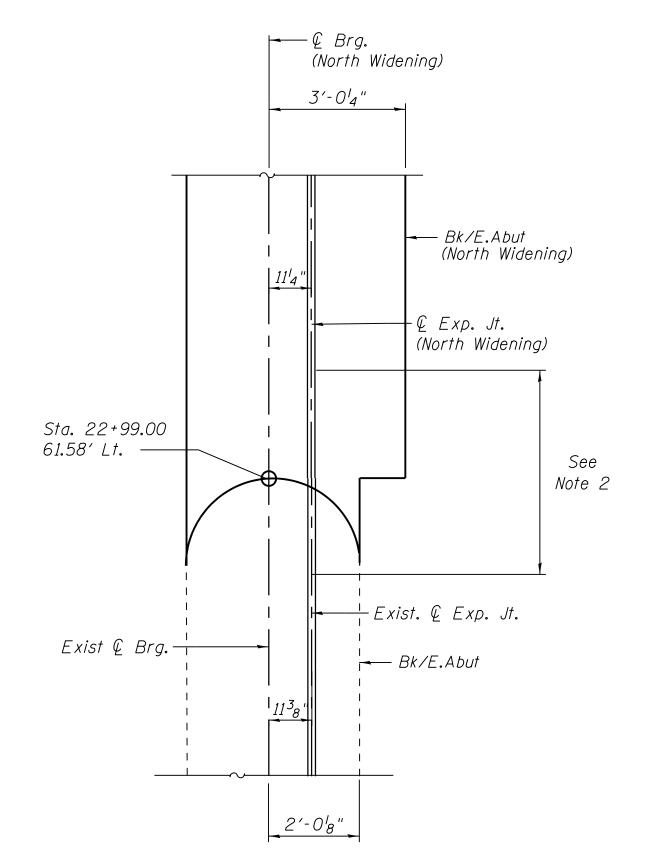

# <u>DETAIL C</u>

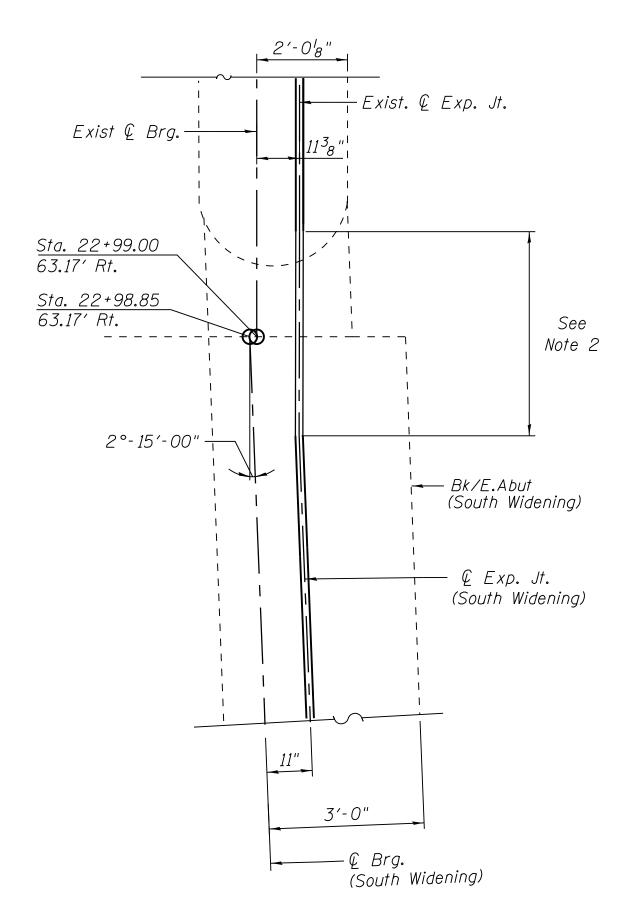

<u>DETAIL D</u>

- Notes
- All offsets with respect to & Bridge & P.G.L.
   Contractor to transition expansion joint at widened abutments so that joint is continuous over bridge.





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## 95th Terminal Improvement

15 West 95th Street (South Terminal) Chicago, IL 60628

MARK	DATE	DESCRIPTION
	2/9/17	ISSUED FOR CONSTRUCTION
FILE N	NAME	File Name
	ECT NO.	2012-0021
	VN BY	T.SLEDGE
DESIC	GNED BY	L.SOMMER
CHEC	KED BY	P.MAID
APPROVED BY		D.ZROKA
IN CH	ARGE	S. KADERBEK

LOCATION IDENTIFIER: DR095

95TH ST. BRIDGE TOP OF SLAB ELEVATIONS (SHEET 2 OF 6) SN 016-0437

95TH-S-107A

### SOUTH CONSTRUCTION JOINT


Location	Station	Offset	Theoretical Grade Elevations	Theoretical Grade Elevations Adjusted For Dead Load Deflection
BK W. ABUT	21+05.89	50.54	17.14	17.14
CL EXP JT	<i>21+06.95</i>	50.54	17.17	17.17
CL BRG. W. ABUT	21+07.90	50.54	17.20	17.20
Α	21+17.90	<i>50.54</i>	<i>17.46</i>	17.50
В	21+27.90	<i>50.54</i>	17.70	17.78
$\mathcal{C}$	21+37.90	<i>50.54</i>	17.90	18.00
D	21+47.90	50.54	<i>18.08</i>	<i>18.18</i>
Ε	21+57.90	50.54	<i>18.23</i>	<i>18.31</i>
F	21+67.90	50.54	<i>18.35</i>	18.40
CL BRG. PIER 1	21+82.70	50.54	18.47	18.47
${\it G}$	21+92.70	50.54	<i>18.52</i>	<i>18.50</i>
Н	22+02.70	50.54	<i>18.53</i>	<i>18.51</i>
I	22+12.70	<i>50.54</i>	<i>18.52</i>	<i>18.50</i>
CL BRG. PIER 2	22+24.20	<i>50.54</i>	18.47	<i>18.47</i>
J	22+34.20	<i>50.54</i>	18.40	<i>18.43</i>
K	22+44.20	<i>50.54</i>	<i>18.29</i>	<i>18.36</i>
L	22+54.20	<i>50.54</i>	<i>18.1</i> 6	<i>18.25</i>
М	22+64.20	50.54	<i>17.99</i>	<i>18.09</i>
N	22+74.20	50.54	17.80	17.89
0	22+84.20	50.54	17.58	17.64
CL BRG. E. ABUT	22+99.00	50.54	17.20	17.20
CL EXP JT	22+99.95	50.54	17.17	17.17
BK E. ABUT	23+01.01	50.54	17.14	17.14


### <u>BEAM 1</u> <u>BEAM 1A</u>

Location	Station	Offset	Theoretical Grade Elevations	Theoretical Grade Elevations Adjusted For Dead Load Deflection
BK W. ABUT	21+05.89	56.59	17.02	17.02
CL EXP JT	21+06.95	56.59	17.05	17.05
CL BRG. W. ABUT	21+07.90	56.59	17.08	17.08
А	21+17.90	56.59	17.34	17.38
В	21+27.90	56.59	17.58	17.66
С	21+37.90	56.59	17.78	17.88
D	21+47.90	56.59	17.96	<i>18.06</i>
Ε	21+57.90	56.59	18.11	<i>18.1</i> 9
F	21+67.90	56.59	<i>18.23</i>	18.28
CL BRG. PIER 1	21+82.70	56.59	<i>18.35</i>	<i>18.35</i>
G	21+92.70	56.59	18.40	<i>18.38</i>
Н	22+02.70	56.59	<i>18.41</i>	<i>18.39</i>
I	22+12.70	56.59	18.40	<i>18.38</i>
CL BRG. PIER 2	22+24.20	56.59	<i>18.35</i>	<i>18.35</i>
J	22+34.20	56.59	<i>18.27</i>	18.30
К	22+44.20	56.59	<i>18.17</i>	18.24
L	22+54.20	56.59	18.04	<i>18.13</i>
М	22+64.20	56.59	17.87	17.97
N	22+74.20	56.59	17.68	17.77
0	22+84.20	56.59	17.46	<i>17.52</i>
CL BRG. E. ABUT	22+99.00	56.59	17.08	17.08
CL EXP JT	22+99.95	56.59	17.05	17.05
BK E. ABUT	23+01.01	56.59	17.02	17.02

Location	Station	Offset	Theoretical Grade Elevations	Theoretical Grad Elevations Adjusted For Dead Load Deflection
BK W. ABUT	21+05.89	<i>61.75</i>	16.92	16.92
CL EXP JT	21+06.95	61.75	<i>1</i> 6.95	<i>1</i> 6.95
CL BRG. W. ABUT	21+07.90	61.75	<i>1</i> 6.97	<i>1</i> 6.97
A	21+17.90	61.75	17.24	17.28
В	21+27.90	61.75	17.47	17.54
С	21+37.90	61.75	17.68	17.77
D	21+47.90	61.75	17.86	17.95
E	21+57.90	61.75	18.01	18.08
F	21+67.90	61.75	18.12	<i>18.1</i> 6
CL BRG. PIER 1	21+82.70	61.75	<i>18.25</i>	<i>18.25</i>
G	21+92.70	61.75	<i>18.29</i>	18.28
Н	22+02.70	61.75	<i>18.31</i>	<i>18.29</i>
I	22+12.70	61.75	<i>18.30</i>	18.28
CL BRG. PIER 2	22+24.20	61.75	<i>18.25</i>	<i>18.25</i>
J	22+34.20	61.75	<i>18.17</i>	18.20
K	22+44.20	6 <i>1</i> .75	18.07	<i>18.12</i>
L	22+54.20	61.75	17.93	18.00
М	22+64.20	61.75	17.77	17.85
N	22+74.20	61.75	17.58	17.65
0	22+84.20	61.75	<i>17.36</i>	17.41
CL BRG. E. ABUT	22+99.00	61.75	<i>16.98</i>	<i>1</i> 6.98
CL EXP JT	22+99.95	61.75	<i>1</i> 6.95	<i>1</i> 6.95
BK E. ABUT	23+01.01	61.75	<i>16.92</i>	<i>1</i> 6.92

All Offsets with respect to @ Bridge & P.G.L.

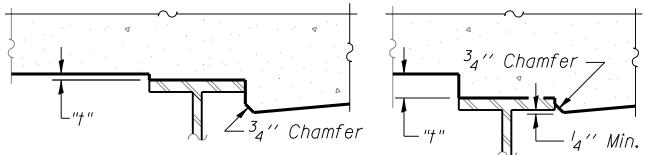

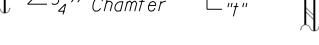

At Minimum Fillet

At Maximum Fillet

³₄′′ Chamfer →

To determine "t": After all structural steel has been erected, elevations of the top flanges of the beams shall be taken at intervals shown on S-107. These elevations subtracted from the "Theoretical Grade Elevations Adjusted for Dead Load Deflection" shown on sheets S-108 through S-110.A minus slab thickness, equals the fillet heights "t" above top flange of beams.

FILLET HEIGHTS





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# 95th Terminal Improvement

15 West 95th Street (South Terminal) Chicago, IL 60628

IN CH	ARGE	S. KADERBEK
APPR	OVED BY	D.ZROKA
CHEC	KED BY	P.MAID
DESIG	GNED BY	L.SOMMER
DRAV	VN BY	T.SLEDGE
PROJ	ECT NO.	2012-0021
FILE I	NAME	File Name
	2/9/17	ISSUED FOR CONSTRUCTION
MARK	DATE	DESCRIPTION
	ATIONIJO	

LOCATION IDENTIFIER: DR095

95TH ST. BRIDGE TOP OF SLAB ELEVATIONS (SHEET 3 OF 6) SN 016-0437

<u>DLAW 1D</u>					
Location	Station	Offset	Theoretical Grade Elevations	Theoretical Grade Elevations Adjusted For Dead Load Deflection	
BK W. ABUT	21+04.66	66.83	16.84	16.84	
CL EXP JT	21+06.74	66.83	<i>16.90</i>	16.90	
CL BRG. W. ABUT	21+07.74	66.83	<i>16.92</i>	<i>16.92</i>	
А	21+17.74	66.83	17.19	17.23	
В	21+27.74	66.83	17.43	17.50	
C	21+37.74	66.83	17.63	17.72	
D	21+47.74	66.83	17.81	17.90	
Ε	21+57.74	66.83	17.96	18.03	
F	21+67.74	66.83	18.08	18.12	
CL BRG. PIER 1	21+82.70	66.83	18.20	18.20	
${\mathcal G}$	21+92.70	66.83	<i>18.25</i>	18.24	
Н	22+02.70	66.83	<i>18.26</i>	18.24	
I	22+12.70	66.83	<i>18.25</i>	18.23	
CL BRG. PIER 2	22+24.20	66.83	<i>18.20</i>	18.20	
J	22+34.20	66.83	<i>18.13</i>	<i>18.1</i> 6	
K	22+44.20	66.83	<i>18.02</i>	<i>18.07</i>	
L	22+54.20	66.83	<i>17.89</i>	17.96	
М	22+64.20	66.83	17.73	17.81	
N	22+74.20	66.83	<i>17.53</i>	17.60	
0	22+84.20	66.83	17.31	<i>17.3</i> 6	

## <u>BEAM 1C</u>

Location	Station	Offset	Theoretical Grade Elevations	Theoretical Grade Elevations Adjusted For Dead Load Deflection
BK W. ABUT	21+04.45	71.92	<i>16.83</i>	<i>1</i> 6.83
CL EXP JT	21+06.54	71.92	<i>16.89</i>	<i>1</i> 6.89
CL BRG. W. ABUT	21+07.54	71.92	<i>16.92</i>	<i>1</i> 6.92
Α	21+17.54	71.92	<i>17.18</i>	17.26
В	21+27.54	71.92	17.42	17.55
C	21+37.54	71.92	<i>17.63</i>	17.80
D	21+47.54	71.92	17.81	17.98
Ε	21+57.54	71.92	17.96	<i>18.10</i>
F	21+67.54	71.92	<i>18.08</i>	18.17
CL BRG. PIER 1	21+82.70	71.92	<i>18.20</i>	18.20
G	21+92.70	71.92	<i>18.25</i>	18.22
Н	22+02.70	71.92	<i>18.26</i>	18.21
I	22+12.70	71.92	<i>18.25</i>	18.21
CL BRG. PIER 2	22+24.20	71.92	18.20	18.20
J	22+34.20	71.92	18.13	<i>18.18</i>
K	22+44.20	71.92	<i>18.02</i>	<i>18.13</i>
L	22+54.20	71.92	17.89	18.04
М	22+64.20	71.92	17.73	17.90
N	22+74.20	71.92	<i>17.53</i>	17.68
0	22+84.20	71.92	17.31	17.42
CL BRG. E. ABUT	22+99.20	71.92	<i>16.92</i>	<i>1</i> 6.92
CL EXP JT	23+00.11	71.92	16.90	<i>1</i> 6.90
BK E. ABUT	23+02.20	71.92	<i>16.84</i>	<i>1</i> 6.84

### <u>BEAM 1D</u>

Location	Station	Offset	Theoretical Grade Elevations	Theoretical Grad Elevations Adjusted For Dead Load Deflection
BK W. ABUT	21+04.28	76.17	<i>1</i> 6.83	<i>16.83</i>
CL EXP JT	21+06.36	76.17	<i>1</i> 6.88	16.88
CL BRG. W. ABUT	21+07.36	76.17	<i>1</i> 6.91	<i>1</i> 6.91
А	21+17.36	76.17	<i>17.18</i>	17.26
В	21+27.36	76.17	17.42	17.55
С	21+37.36	76.17	17.63	17.80
D	21+47.36	76.17	17.80	17.97
Ε	21+57.36	76.17	17.95	18.09
F	21+67.36	76.17	18.07	<i>18.1</i> 6
CL BRG. PIER 1	21+82.70	76.17	18.20	18.20
G	21+92.70	76.17	<i>18.25</i>	18.22
Н	22+02.70	76.17	18.26	<i>18.21</i>
I	22+12.70	76.17	<i>18.25</i>	<i>18.21</i>
CL BRG. PIER 2	22+24.20	76.17	18.20	<i>18.20</i>
J	22+34.20	76.17	<i>18.13</i>	18.18
К	22+44.20	76.17	18.02	<i>18.13</i>
L	22+54.20	76.17	17.89	18.04
М	22+64.20	76.17	17.73	17.90
N	22+74.20	76.17	17.53	17.68
0	22+84.20	76.17	17.31	17.42
CL BRG. E. ABUT	22+99.36	76.17	<i>1</i> 6.92	<i>16.92</i>
CL EXP JT	23+00.28	76.17	<i>1</i> 6.89	<i>16.89</i>
BK E. ABUT	23+02.36	76.17	<i>1</i> 6.83	<i>1</i> 6.83

# SNN



# CHICAGO TRANSIT AUTHORITY ENGINEERING

### SENSITIVE SECURITY INFORMATION

WARNING: THIS RECORD CONTAINS SENSITIVE SECURITY INFORMATION THAT IS CONTROLLED UNDER 49 CFR PARTS 15 AND 1520. NO PART OF THIS RECORD MAY BE DISCLOSED TO PERSONS WITHOUT A "NEED TO KNOW" AS DEFINED IN CFR PARTS 15 AND 1520, EXCEPT WITH THE WRITTEN PERMISSION OF THE ADMINISTRATOR OF THE TRANSPORTATION SECURITY ADMINISTRATION OR THE SECRETARY OF TRANSPORTATION. UNAUTHORIZED RELEASE MAY RESULT IN CIVIL PENALTY OR OTHER ACTION. FOR U.S. GOVERNMENT AGENCIES, PUBLIC DISCLOSURE IS GOVERNED BY 5 U.S.C. 552 AND 49 CFR PARTS 15 AND 1520.

DRAWING SCALE IS NOT GUARANTEED.
CTA ASSUMES NO RISK OF LIABILITY FOR
ERRORS CAUSED, DIRECTLY OR INDIRECTLY,
BY SCALING OF THIS DRAWING.

# 95th Terminal Improvement

15 West 95th Street (South Terminal) Chicago, IL 60628

IN CH	ARGE	S. KADERBEK	
APPR	OVED BY	D.ZROKA	
CHEC	KED BY	P.MAID	
DESIG	GNED BY	L.SOMMER	
DRAV	VN BY	T.SLEDGE	
PROJ	ECT NO.	2012-0021	
FILE	NAME	File Name	
	2/9/17	ISSUED FOR CO	NSTRUCTION
MARK	DATE	DESCRIPTION	
LOC	ATION IDE	NTIFIER:	DR095

# 95TH ST. BRIDGE

TOP OF SLAB ELEVATIONS (SHEET 4 OF 6) SN 016-0437

95TH-S-109

## <u>BEAM 1E</u>

66.83

66.83

*1*6.93

16.90

16.85

*1*6.93

*1*6.90

22+99.00

22+99.92

23+02.00

CL BRG. E. ABUT

CL EXP JT

BK E. ABUT

<u> </u>					
Location	Station	Offset	Theoretical Grade Elevations	Theoretical Grade Elevations Adjusted For Dead Load Deflection	
BK W. ABUT	21+04.15	79.00	16.82	16.82	
CL EXP JT	21+06.23	79.00	<i>16.88</i>	<i>16.88</i>	
CL BRG. W. ABUT	21+07.23	79.00	16.91	<i>1</i> 6.91	
Α	21+17.23	79.00	17.18	17.22	
В	21+27.23	79.00	17.41	17.48	
С	21+37.23	79.00	<i>17.62</i>	17.71	
D	21+47.23	79.00	17.80	17.88	
Ε	21+57.23	79.00	17.95	18.02	
F	21+67.23	79.00	<i>18.07</i>	<i>18.11</i>	
CL BRG. PIER 1	21+82.70	79.00	<i>18.20</i>	18.20	
G	21+92.70	79.00	<i>18.25</i>	<i>18.23</i>	
Н	22+02.70	79.00	<i>18.26</i>	18.24	
I	22+12.70	79.00	<i>18.25</i>	<i>18.23</i>	
CL BRG. PIER 2	22+24.20	79.00	<i>18.20</i>	18.20	
J	22+34.20	79.00	<i>18.13</i>	<i>18.1</i> 6	
K	22+44.20	79.00	18.02	18.08	
L	22+54.20	79.00	17.89	17.98	
М	22+64.20	79.00	17.73	17.83	
N	22+74.20	79.00	<i>17.53</i>	17.62	
0	22+84.20	79.00	17.31	17.38	
CL BRG. E. ABUT	22+99.46	79.00	<i>16.92</i>	<i>16.92</i>	
CL EXP JT	23+00.37	79.00	<i>1</i> 6.89	<i>1</i> 6.89	
BK E. ABUT	23+02.46	79.00	<i>16.83</i>	<i>16.83</i>	

### <u>BEAM 1F</u>

Location	Station	Offset	Theoretical Grade Elevations	Theoretical Grade Elevations Adjusted For Dead Load Deflection
BK W. ABUT	21+03.99	83.63	16.82	16.82
CL EXP JT	21+06.07	83.63	<i>1</i> 6.88	<i>16.88</i>
CL BRG. W. ABUT	21+07.07	83.63	<i>1</i> 6.90	<i>16.90</i>
END	21+16.36	83.63	<i>17.1</i> 5	17.19

# <u>BEAM 1G</u>

Location	Station	Offset	Theoretical Grade Elevations	Theoretical Grade Elevations Adjusted For Dead Load Deflection
BK W. ABUT	21+03.80	88.25	16.81	16.81
CL EXP JT	21+05.88	88.25	<i>1</i> 6.87	16.87
CL BRG. W. ABUT	21+06.88	88.25	<i>1</i> 6.90	<i>1</i> 6.90
END	21+11.53	88.25	17.03	17.05

# <u>BEAM 1H</u>

Location	Station	Offset	Theoretical Grade Elevations	Theoretical Grade Elevations Adjusted For Dead Load Deflection
BK W. ABUT	21+03.62	96.07	16.81	<i>1</i> 6.81
CL EXP JT	21+05.70	93.91	<i>16.87</i>	<i>1</i> 6.87
CL BRG. W. ABUT	21+06.70	92.88	<i>16.89</i>	<i>1</i> 6.89
R	21+13.92	85.96	17.09	17.12
END	21+21.18	79.00	17.27	17.33

## <u>BEAM 11</u>

Location	Station	Offset	Theoretical Grade Elevations	Theoretical Grade Elevations Adjusted For Dead Load Deflection
START	22+86.82	85.54	17.25	17.32
CL BRG. E. ABUT	22+99.73	85.54	16.91	16.91
CL EXP JT	23+00.65	85.54	16.88	16.88
BK E. ABUT	23+02.73	85.54	16.82	16.82

## <u>BEAM 1J</u>

Location	Station	Offset	Theoretical Grade Elevations	Theoretical Grade Elevations Adjusted For Dead Load Deflection
START	22+93.53	92.08	17.08	17.12
CL BRG. E. ABUT	22+99.99	92.08	<i>16.90</i>	<i>1</i> 6.90
CL EXP JT	23+00.91	92.08	<i>16.88</i>	<i>1</i> 6.88
BK E. ABUT	23+02.99	92.08	16.82	<i>16.82</i>

## <u>BEAM 1K</u>

Location	Station	Offset	Theoretical Grade Elevations	Theoretical Grade Elevations Adjusted For Dead Load Deflection
START	22+80.11	79.00	17.41	17.48
S	22+87.27	85.98	17.24	17.31
T	22+94.43	92.96	17.05	17.09
CL BRG. E. ABUT	23+00.24	98.63	<i>1</i> 6.90	<i>1</i> 6.90
CL EXP JT	23+01.16	99.60	<i>1</i> 6.87	<i>1</i> 6.87
BK E. ABUT	23+03.24	101.80	<i>16.81</i>	16.81

*Note:* 

All Offsets with respect to Q Bridge Q P.G.L.

NURTH CONSTRUCTION JUINT						
Location	Station	Offset	Theoretical Grade Elevations	Theoretical Grade Elevations Adjusted For Dead Load Deflection		
BK W. ABUT	21+05.89	- 50.54	17.11	17.11		
CL EXP JT	21+06.95	- 50.54	17.14	17.14		
CL BRG. W. ABUT	21+07.90	- 50.54	<i>17.1</i> 6	17.16		
А	21+17.90	- 50.54	17.41	17.45		
В	21+27.90	- 50.54	17.66	17.74		
C	21+37.90	- 50.54	17.88	17.98		
D	21+47.90	- 50.54	<i>18</i> .07	18.17		
Ε	21+57.90	- 50.54	<i>18.23</i>	18.31		
F	21+67.90	- 50.54	<i>18.35</i>	18.40		
CL BRG. PIER 1	21+82.70	- 50.54	<i>18.48</i>	18.48		
$\mathcal{G}$	21+92.70	- 50.54	<i>18</i> .53	<i>18.51</i>		
Н	22+02.70	- 50.54	<i>18</i> .55	<i>18.53</i>		
I	22+12.70	- 50.54	<i>18</i> .54	<i>18.52</i>		
CL BRG. PIER 2	22+24.20	- 50.54	18.48	18.48		

*18.43* 

*18.36* 

18.24

18.07

17.86

17.59

17.09

17.06

18.40

17.09

17.06

## <u>BEAM 16</u>

Location	Station	Offset	Theoretical Grade Elevations	Theoretical Grade Elevations Adjusted For Dead Load Deflection
BK W. ABUT	21+05.89	- 56.59	17.08	17.08
CL EXP JT	21+06.95	- 56.59	17.11	17.11
CL BRG. W. ABUT	21+07.90	- 56.59	17.13	17.13
А	21+17.90	- 56.59	<i>17.38</i>	17.42
В	21+27.90	- 56.59	<i>17.63</i>	17.71
C	21+37.90	- 56.59	17.85	17.95
D	21+47.90	- 56.59	18.04	18.14
Ε	21+57.90	- 56.59	<i>18.20</i>	<i>18.28</i>
F	21+67.90	- 56.59	<i>18.32</i>	<i>18.37</i>
CL BRG. PIER 1	21+82.70	- 56.59	<i>18.45</i>	<i>18.45</i>
G	21+92.70	- 56.59	<i>18.50</i>	18.48
Н	22+02.70	- 56.59	<i>18.52</i>	<i>18.50</i>
I	22+12.70	- 56.59	<i>18.51</i>	<i>18.49</i>
CL BRG. PIER 2	22+24.20	- 56.59	<i>18.45</i>	<i>18.45</i>
J	22+34.20	- 56.59	<i>18.37</i>	18.40
K	22+44.20	- 56.59	<i>18.26</i>	<i>18.33</i>
L	22+54.20	- 56.59	18.12	18.21
М	22+64.20	- 56.59	17.94	18.04
N	22+74.20	- 56.59	17.74	17.83
0	22+84.20	- 56.59	17.50	17.56
CL BRG. E. ABUT	22+99.00	- 56.59	17.09	17.09
CL EXP JT	22+99.95	- 56.59	17.06	17.06
BK E. ABUT	23+01.01	- 56.59	17.03	17.03

### <u>BEAM 16A</u>

Location	Station	Offset	Theoretical Grade Elevations	Theoretical Grad Elevations Adjusted For Dead Load Deflection
BK W. ABUT	21+05.89	- 59.67	17.08	17.08
CL EXP JT	21+06.95	- 59.67	17.11	17.11
CL BRG. W. ABUT	21+07.90	- 59.67	17.13	17.13
А	21+17.90	- 59.67	<i>17.38</i>	17.46
В	21+27.90	- 59.67	<i>17.63</i>	17.76
C	21+37.90	- 59.67	<i>17.85</i>	18.02
D	21+47.90	- 59.67	18.04	<i>18.21</i>
Ε	21+57.90	- 59.67	<i>18.20</i>	18.34
F	21+67.90	- 59.67	<i>18.32</i>	<i>18.41</i>
CL BRG. PIER 1	21+82.70	- 59.67	<i>18.45</i>	<i>18.45</i>
${\it G}$	21+92.70	- 59.67	<i>18.50</i>	<i>18.47</i>
Н	22+02.70	- 59.67	<i>18.52</i>	<i>18.47</i>
I	22+12.70	- 59.67	<i>18.51</i>	<i>18.47</i>
CL BRG. PIER 2	22+24.20	- 59.67	<i>18.45</i>	<i>18.45</i>
J	22+34.20	- 59.67	<i>18.37</i>	18.42
K	22+44.20	- 59.67	<i>18.26</i>	18.37
L	22+54.20	- 59.67	<i>18.12</i>	18.27
М	22+64.20	- 59.67	17.94	18.11
N	22+74.20	- 59.67	17.74	17.89
0	22+84.20	- 59.67	<i>17.50</i>	17.61
CL BRG. E. ABUT	22+99.00	- 59.67	17.09	17.09
CL EXP JT	22+99.95	- 59.67	17.06	17.06
BK E. ABUT	23+01.01	-59.67	17.03	17.03



# CHICAGO TRANSIT AUTHORITY **ENGINEERING**

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# 95th Terminal Improvement 15 West 95th Street (South Terminal) Chicago, IL 60628

MARK	DATE	DESCRIPTION
	2/9/17	ISSUED FOR CONSTRUCTION
FILE N	NAME	File Name
PROJ	ECT NO.	2012-0021
DRAW	/N BY	T.SLEDGE
DESIGNED BY		L.SOMMER
CHEC	KED BY	P.MAID
APPR	OVED BY	D.ZROKA
IN CH	ARGE	S. KADERBEK

LOCATION IDENTIFIER: DR095

95TH ST. BRIDGE TOP OF SLAB ELEVATIONS (SHEET 5 OF 6) SN 016-0437

95TH-S-110

## <u>BEAM 16B</u>

- 50.54

- 50.54

- 50.54

22+34.20

22+54.20

22+64.20

22+74.20

22+84.20

22+99.00

22+99.95

23+01.01

CL BRG. E. ABUT

CL EXP JT

BK E. ABUT

Location	Station	Offset	Theoretical Grade Elevations	Theoretical Grade Elevations Adjusted For Dead Load Deflection
BK W. ABUT	21+04.88	-63.92	17.06	17.06
CL EXP JT	21+06.96	-63.92	17.11	17.11
CL BRG. W. ABUT	21+07.90	-63.92	17.13	17.13
А	21+17.90	-63.92	<i>17.38</i>	17.46
В	21+27.90	-63.92	17.63	17.76
С	21+37.90	-63.92	<i>17.85</i>	18.02
D	21+47.90	-63.92	18.04	18.21
Ε	21+57.90	-63.92	18.20	18.34
F	21+67.90	-63.92	<i>18.32</i>	18.41
CL BRG. PIER 1	21+82.70	-63.92	<i>18.45</i>	<i>18.45</i>
$\mathcal{G}$	21+92.70	-63.92	<i>18</i> .50	<i>18.47</i>
Н	22+02.70	-63.92	<i>18.52</i>	<i>18.47</i>
I	22+12.70	-63.92	<i>18</i> .51	<i>18.47</i>
CL BRG. PIER 2	22+24.34	-63.92	<i>18.45</i>	<i>18.45</i>
J	22+34.34	-63.92	<i>18.37</i>	<i>18.42</i>
K	22+44.34	-63.92	<i>18.26</i>	<i>18.37</i>
L	22+54.34	-63.92	<i>18.12</i>	<i>18.27</i>
М	22+64.34	-63.92	17.94	18.11
N	22+74.34	-63.92	17.73	17.88
0	22+84.34	-63.92	<i>17.50</i>	17.61
CL BRG. E. ABUT	22+99.00	-63.92	17.09	17.09
CL EXP JT	22+99.94	-63.92	17.06	17.06
BK E. ABUT	23+02.02	-63.92	17.00	17.00

## <u>BEAM 16C</u>

Theoretical Grade

Location	Station	Offset	Theoretical Grade Elevations	Theorefical Grade Elevations Adjusted For Dead Load Deflection
BK W. ABUT	21+04.88	-66.75	17.06	17.06
CL EXP JT	21+06.96	-66.75	17.11	17.11
CL BRG. W. ABUT	21+07.90	-66.75	17.13	17.13
А	21+17.90	-66.75	<i>17.38</i>	17.42
В	21+27.90	-66.75	17.63	17.71
C	21+37.90	-66.75	17.85	17.94
D	21+47.90	-66.75	18.04	18.13
Ε	21+57.90	-66.75	18.20	18.27
F	21+67.90	-66.75	18.32	<i>18.36</i>
CL BRG. PIER 1	21+82.70	-66.75	<i>18.45</i>	<i>18.45</i>
G	21+92.70	-66.75	<i>18.50</i>	<i>18.49</i>
Н	22+02.70	-66.75	<i>18.52</i>	<i>18.50</i>
I	22+12.70	-66.75	<i>18.51</i>	18.49
CL BRG. PIER 2	22+24.43	-66.75	<i>18.45</i>	<i>18.45</i>
J	22+34.43	-66.75	18.37	<i>18.3</i> 9
К	22+44.43	-66.75	18.26	18.31
L	22+54.43	-66.75	18.11	18.18
М	22+64.43	-66.75	17.94	18.01
N	22+74.43	-66.75	17.73	17.80
0	22+84.43	-66.75	17.49	17.54
CL BRG. E. ABUT	22+99.00	-66.75	17.09	17.09
CL EXP JT	22+99.94	-66.75	17.06	17.06
BK E. ABUT	23+02.02	-66.75	17.00	17.00

## <u>BEAM 16D</u>

Location	Station	Offset	Theoretical Grade Elevations	Theoretical Grade Elevations Adjusted For Dead Load Deflection
BK W. ABUT CL EXP JT CL BRG. W. ABUT END	21+04.88 21+06.96 21+07.90 21+19.92	-72.65 -72.65 -72.65 -72.65	17.06 17.11 17.13 17.43	17.06 17.11 17.13 17.49

### <u>BEAM 16E</u>


			<del></del>	
Location	Station	Offset	Theoretical Grade Elevations	Theoretical Grade Elevations Adjusted For Dead Load Deflection
BK W. ABUT  CL EXP JT  CL BRG. W. ABUT  END	21+04.88 21+06.96 21+07.90 21+13.91	- 78.54 - 78.54 - 78.54 - 78.54	17.06 17.11 17.13 17.28	17.06 17.11 17.13 17.32

## <u>BEAM 16F</u>

Location	Station	Offset	Theoretical Grade Elevations	Theoretical Grade Elevations Adjusted For Dead Load Deflection
BK W. ABUT	21+04.88	-87.41	17.06	17.06
CL EXP JT	21+06.96	-85.36	17.11	17.11
CL BRG. W. ABUT	21+07.90	-84.84	17.13	17.13
P	21+15.04	- 77.43	17.31	<i>17.35</i>
Q	21+22.17	- 70.43	17.49	17.55
END	21+25.92	-66.75	<i>17.58</i>	<i>17</i> .65

All Offsets with respect to @ Bridge & P.G.L.

FILE NAME =  $070_DR095_S-110.dgn$ PLOT DATE = 8/31/2016

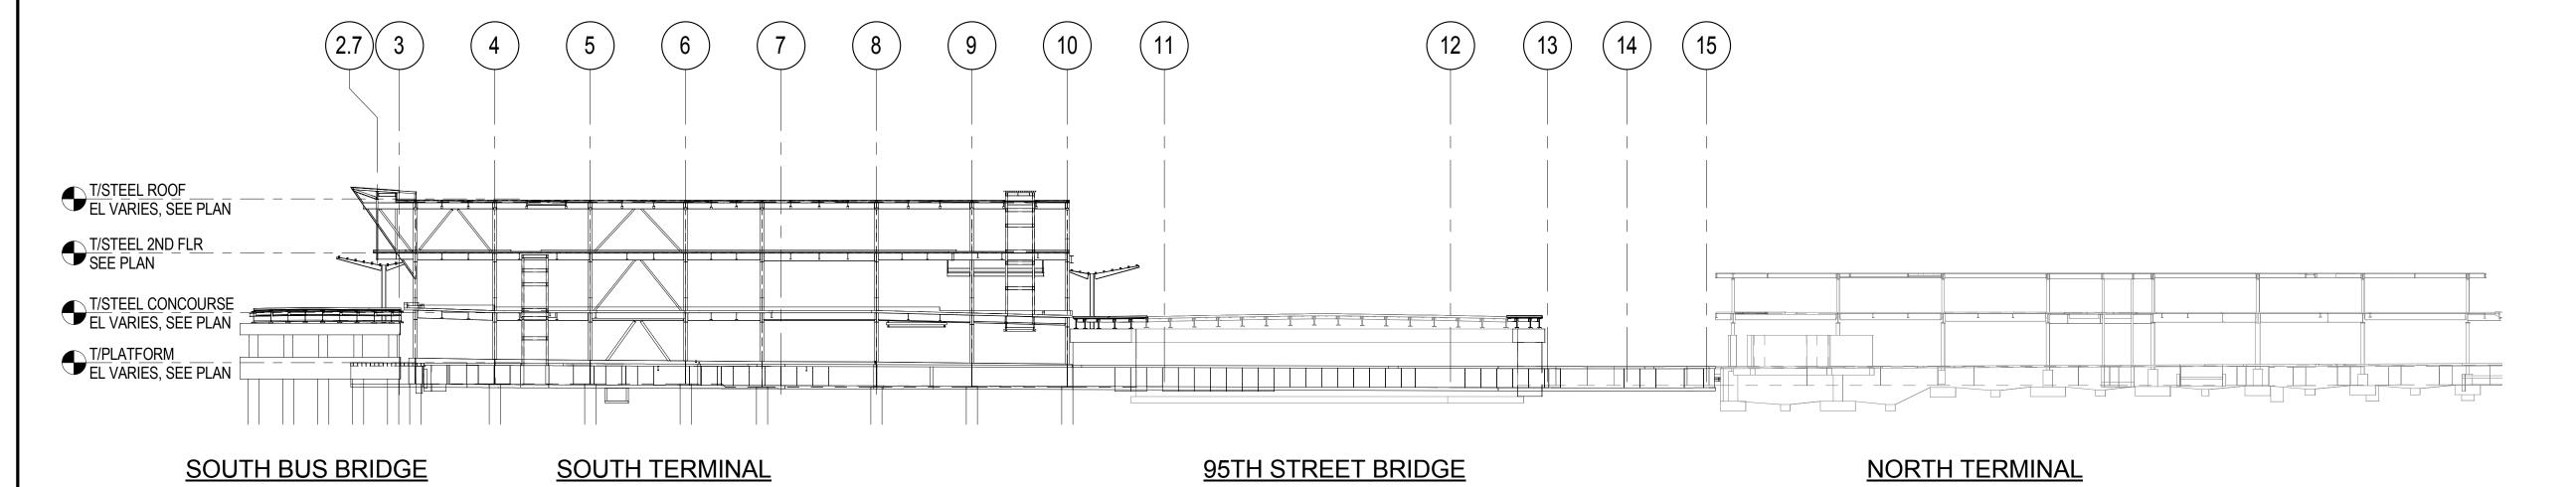

BUILDING LONGITUDINAL SECTION SCALE: 1" = 30'-0"

THIS DRAWING IS ISSUED FOR GENERAL INFORMATION ONLY. THE PURPOSE OF THIS DRAWING IS TO INDICATE THE STRUCTURAL FRAMING FOR THE PROJECT AND SHALL NOT BE USED FOR CONSTRUCTION. SEE THE REFERENCED ENLARGED PLANS FOR AREAS WHERE LIMITS OF WORK ARE SHOWN.









SENSITIVE SECURITY INFORMATION


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> 95th Terminal Improvement 15 West 95th Street (South Terminal) Chicago, IL 60628

IN CH	ARGE	J. JAKALSKI					
APPROVED BY		J. JAKALSKI	J. JAKALSKI				
CHEC	KED BY	R.S. NAIR					
DESIG	NED BY	G. FORKAN					
DRAW	/N BY	M. DONAHUE					
PROJ	ECT NO.	2012-0021.02					
FILE N	IAME	DR095_S-Terminal					
	2/9/17	ISSUED FOR CONSTRUCTIO	N				
MARK	DATE	DESCRIPTION					
LOC	ATION IDI	ENTIFIER: <b>DR095</b>					

**BUILDING TYPICAL SECTIONS** LONGITUDINAL



NOTE:
THIS DRAWING IS ISSUED FOR GENERAL INFORMATION
ONLY. THE PURPOSE OF THIS DRAWING IS TO INDICATE
THE STRUCTURAL FRAMING FOR THE PROJECT AND
SHALL NOT BE USED FOR CONSTRUCTION. SEE THE
REFERENCED ENLARGED PLANS FOR AREAS WHERE
LIMITS OF WORK ARE SHOWN.

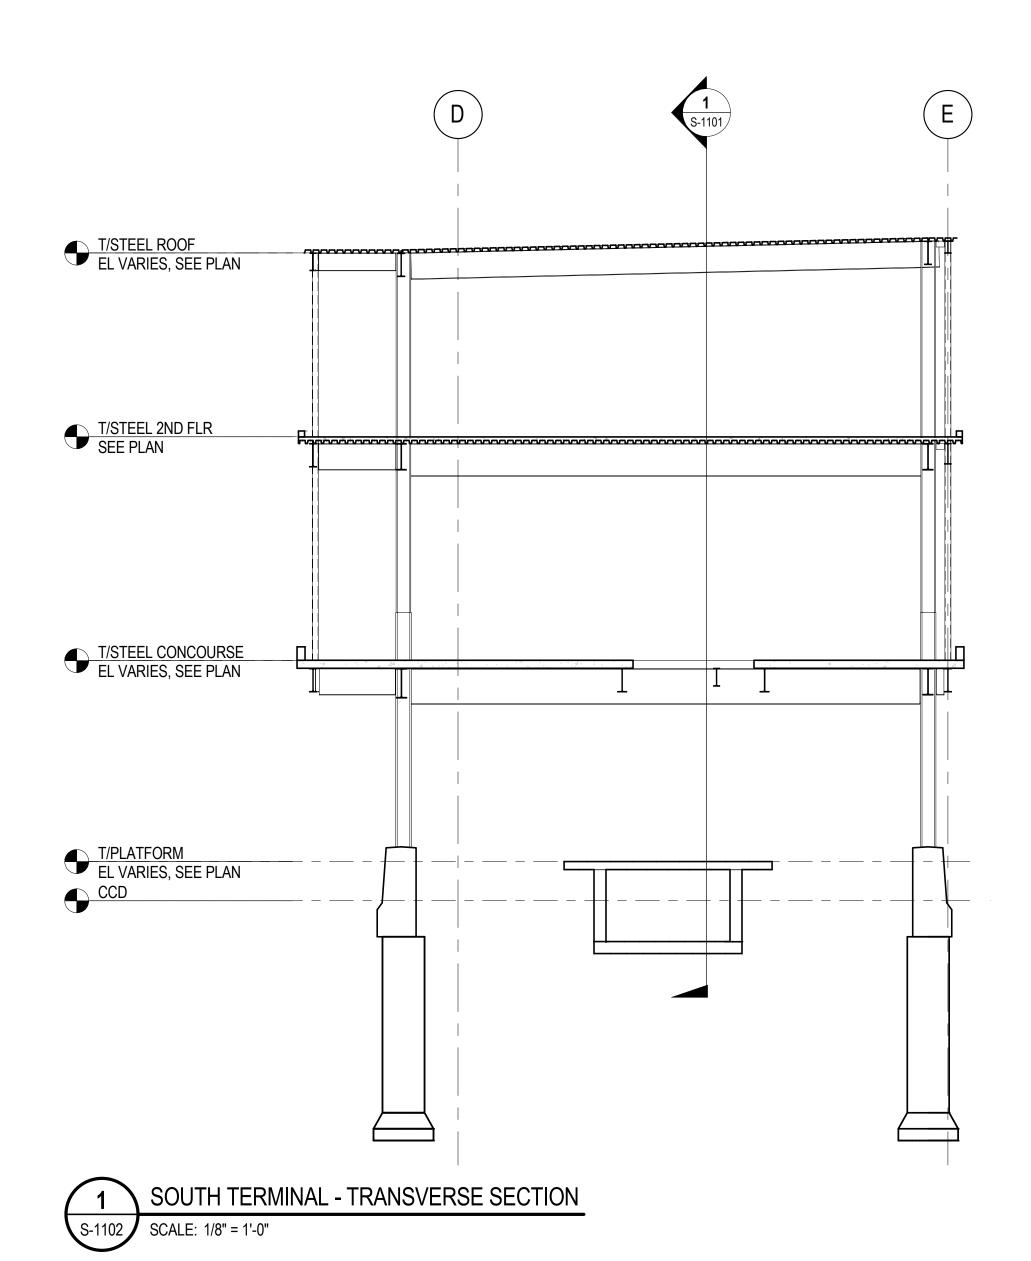



### SENSITIVE SECURITY INFORMATION

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BY SCALING OF THIS DRAWING.

# 95th Terminal Improvement 15 West 95th Street (South Terminal)

15 West 95th Street (South Terminal) Chicago, IL 60628


IN CH	ARGE	J. JAKALSKI
APPR	OVED BY	J. JAKALSKI
CHEC	KED BY	R.S. NAIR
DESIG	SNED BY	G. FORKAN
DRAW	VN BY	M. DONAHUE
PROJ	ECT NO.	2012-0021.02
FILE N	IAME	DR095_S-Terminal
	<del>                                     </del>	
	2/9/17	ISSUED FOR CONSTRUCTION
MARK	_	DESCRIPTION
IVICALAL	DAIL	DESCRIPTION
	ATION IDE	NTIFIER DR095


LOCATION IDENTIFIER: DR095

BUILDING TYPICAL SECTIONS
TRANSVERSE





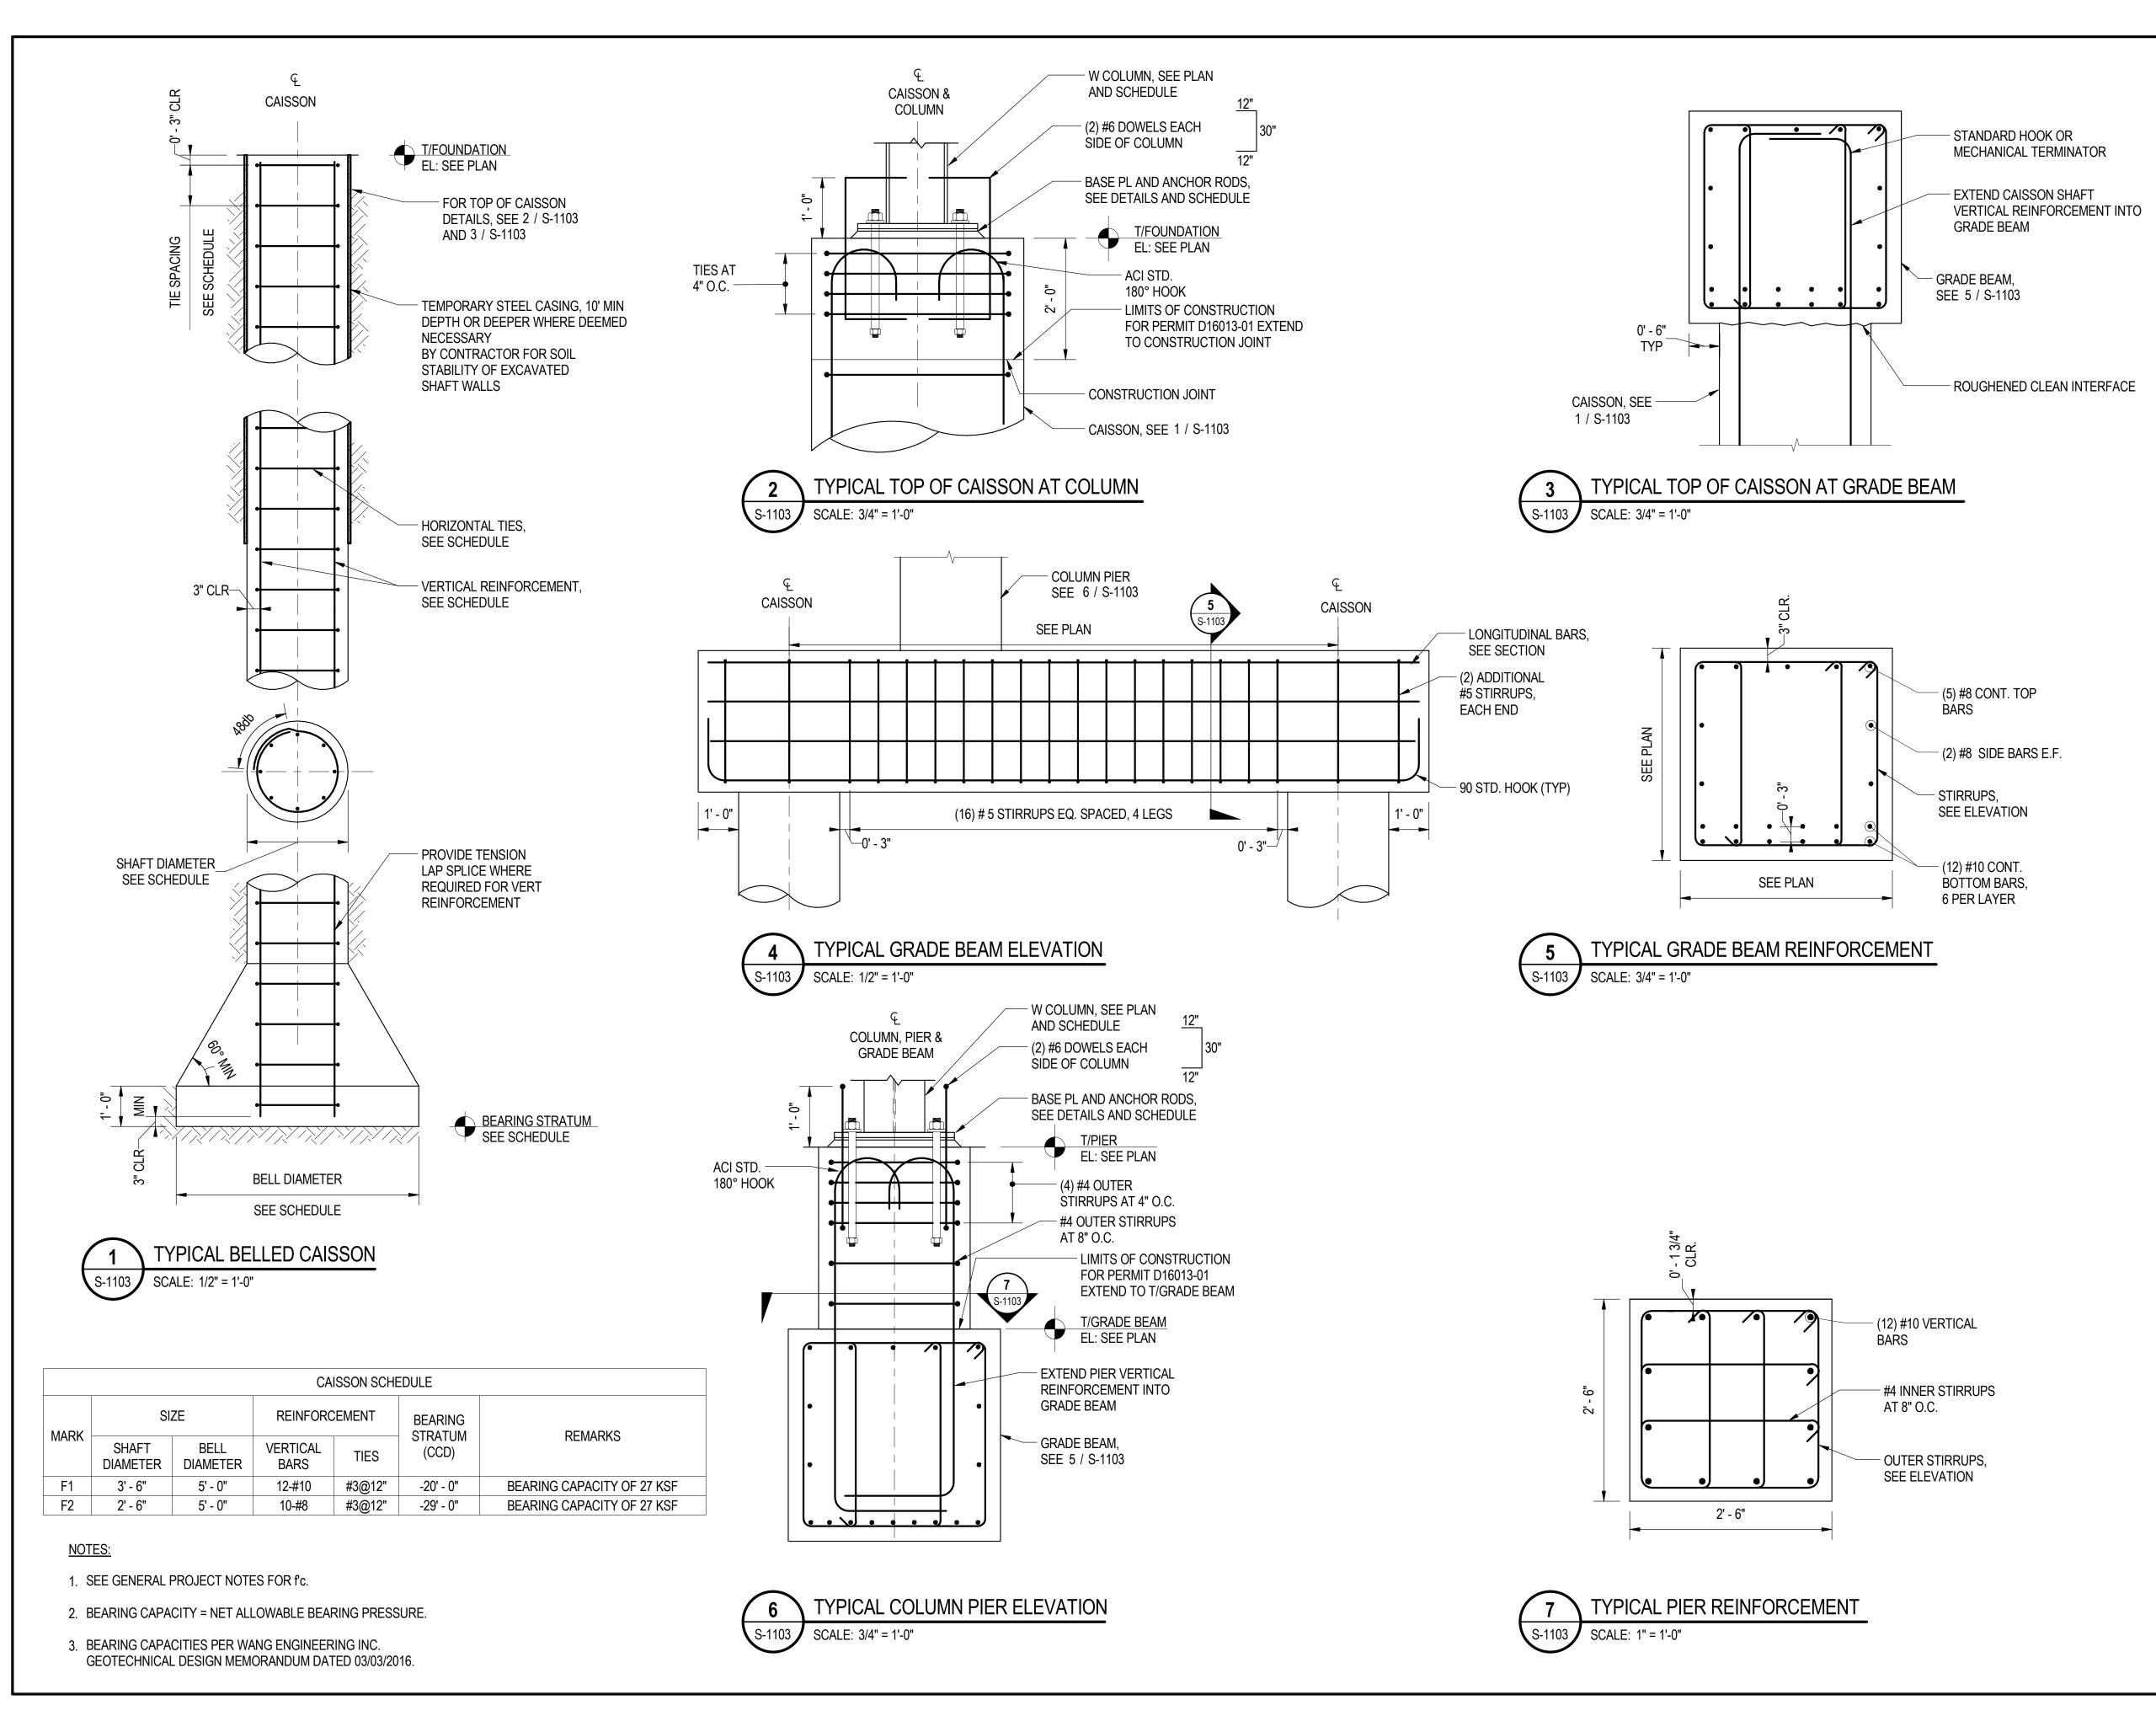

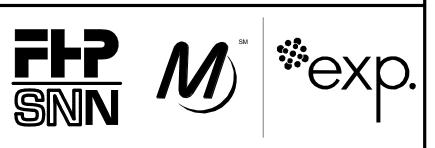



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# 95th Terminal Improvement

15 West 95th Street (South Terminal) Chicago, IL 60628


IN CH	ARGE	J. JAKALSKI
APPR	OVED BY	J. JAKALSKI
CHEC	KED BY	R.S. NAIR
DESIG	NED BY	G. FORKAN
DRAW	/N BY	D. LALLY
PROJ	ECT NO.	2012-0021.02
FILE N	IAME	DR095_S-StationFoundation
	40/0/40	
	10/6/16	ISSUED FOR CONSTRUCTION
MARK	DATE	DESCRIPTION
LOCA	ATION IDE	NTIFIER: <b>DR095</b>

LOCATION IDENTIFIER:

**FOUNDATION DETAILS** 






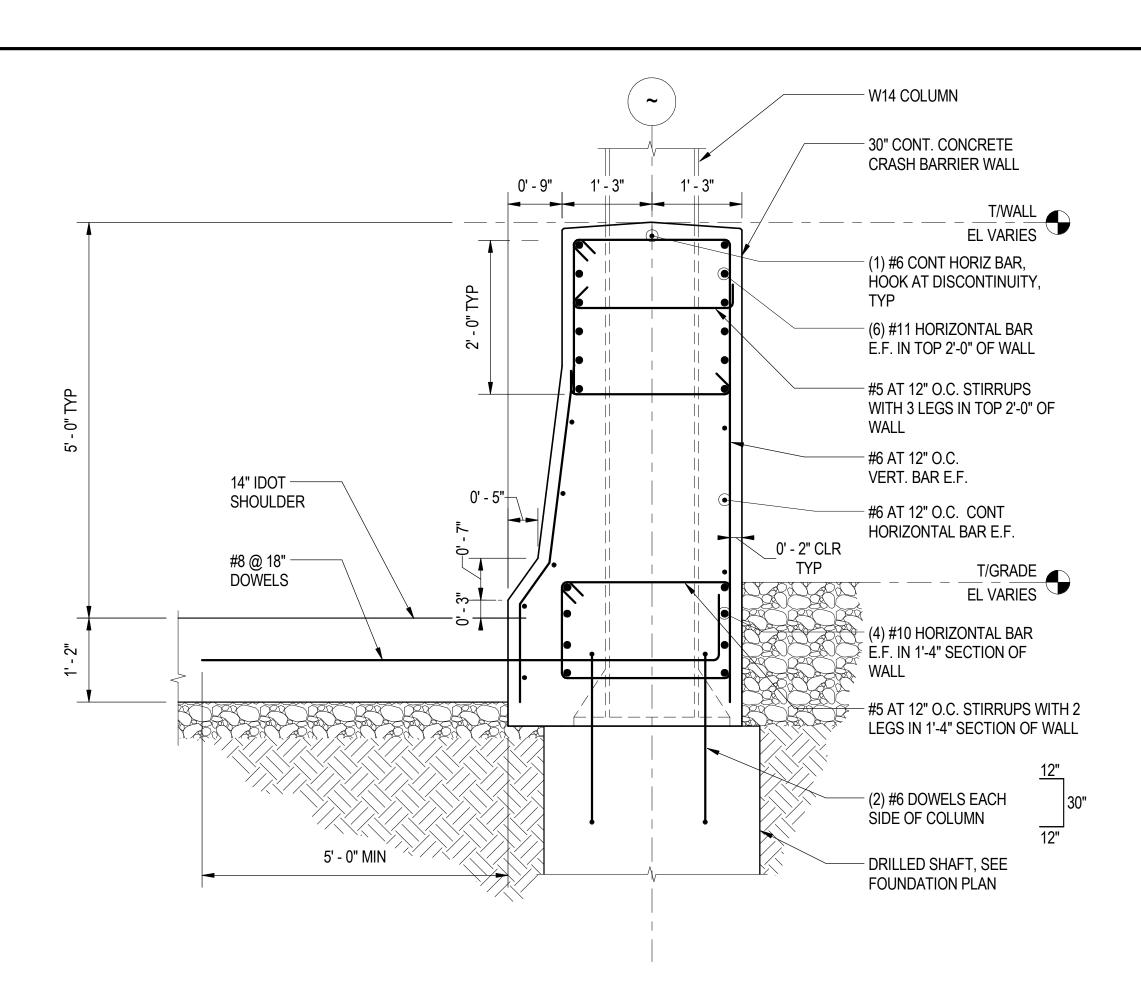

CRASH BARRIER WALL AT FOUNDATION

S-1104 SCALE: 3/4" = 1'-0"

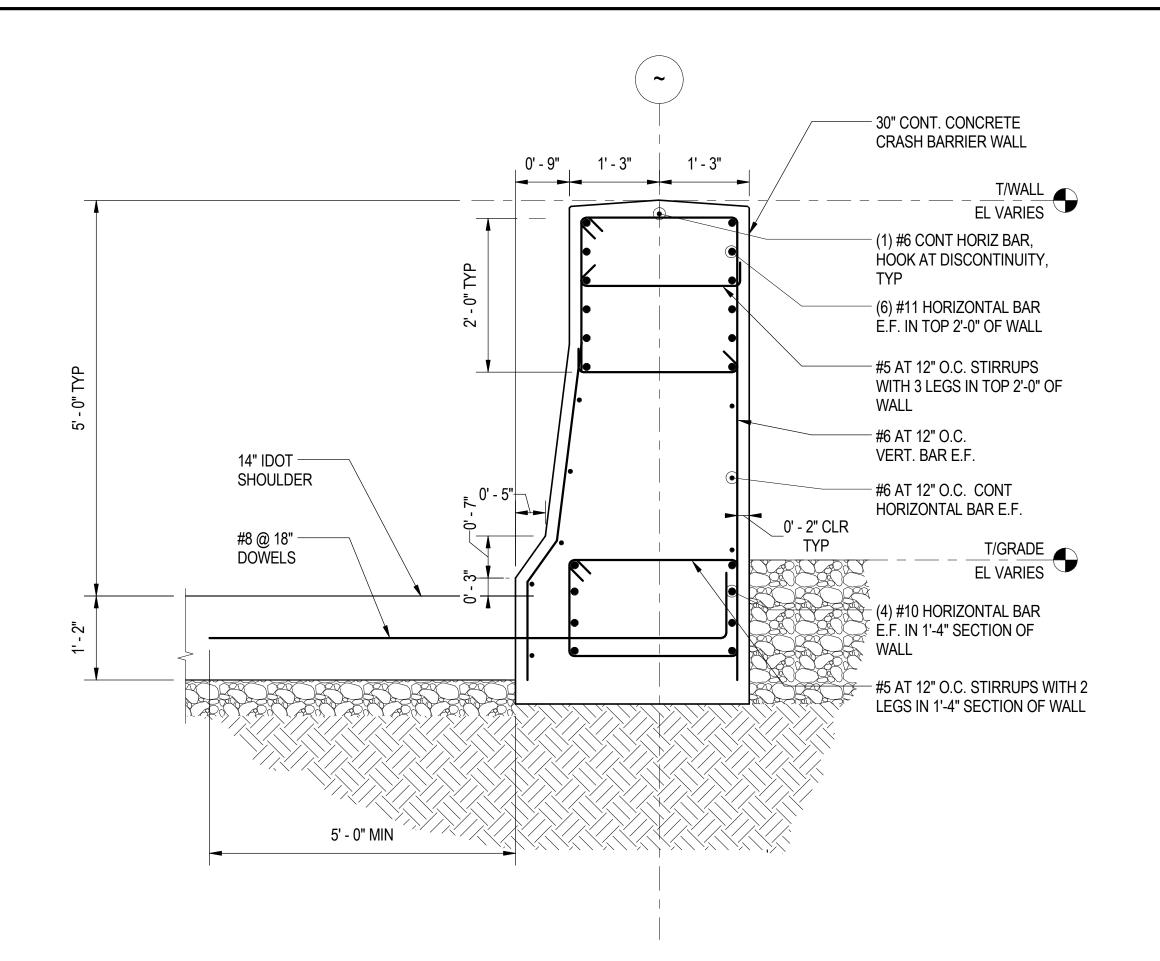

2 CRASH BARRIER BETWEEN FOUNDATIONS
SCALE: 3/4" = 1'-0"

### SHEET NOTES:

- 1. FOR GENERAL FOUNDATION NOTES, SEE S-000 SERIES.
- 2. FOR TYPICAL DETAILS, SEE S-1100 SERIES.
- 3. ALL REBAR SHALL BE EPOXY COATED.
- 4. SEE TYPICAL DETAILS FOR MINIMUM BAR LAP DIMENSIONS, UNLESS WHERE INDICATED ON THE DRAWINGS. WHEN LAPPING DIFFERENT DIAMETER BARS, LARGER BAR LAP SHALL APPLY.









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# 95th Terminal Improvement

15 West 95th Street (South Terminal) Chicago, IL 60628

IN CH	ARGE	J. JAKALSKI
APPROVED BY		J. JAKALSKI
CHEC	KED BY	R.S. NAIR
DESIG	ENED BY	G. FORKAN
DRAW	/N BY	M. DONAHUE
PROJ	ECT NO.	2012-0021.02
FILE	NAME	DR095_S-StationFoundation
	2/0/47	ISSUED FOR CONSTRUCTION
	2/9/17	ISSUED FOR CONSTRUCTION
MARK	DATE	DESCRIPTION
	ATIONIDI	NITICICO. DOME

LOCATION IDENTIFIER: DR095

**CRASH BARRIER WALL DETAILS** 

COLUMN	D'-3.1 & E'-3.1	D'-4 & E'-4	D'-5 & E'-5	D'-6 & E'-6	D'-6.8 & E'-6.8	D'-8 & E'-8	D'-9 & E'-9	D'-10 & E'-10	C'-5 & C'-6	E-5 & E-6
ROOF TOS EL VADIES										
T.O.S. EL VARIES SEE PLAN										
	9	9	9	9	9	9	9		3/8	3/8
SECOND FLOOR T.O.S. SEE PLAN	W14x176	W14x176	W14x176	W14x176	W14x176	W14x176	W14x176	W14x257	HSS6x6x3/8	HSS6x6x3/8
T.U.S. SEE PLAN	×	M		M	× ×	.W	.W	M	HSS	HSS
CONCOURSE	11	11	11	1 1	11	11	11			
1.0.S. EL VARIES									NDICATES SPL	ICE WITH
SEE PLAN	က္က	g)	စ္	g)	စ္	က္က	က္က		OLUMN BELO	W, 4'-0"
	W14x193	W14x193	W14x193	W14x193	W14x193	W14x193	W14x193		BOVE T.O.C. E YP U.N.O. 	ELEVATION,
FOUNDATION CAP										
T.O.C. EL VARIES SEE PLAN										
SPLICE DETAIL	SP-1	SP-1	SP-2	SP-2	SP-2	SP-2	SP-2	SP-2	-	-
BASE PL MARK	BP-1	BP-1	BP-1	BP-2	BP-1	BP-2	BP-2	BP-3	-	-

### SHEET NOTES:

- 1. FOR GENERAL NOTES, SEE DWGS S-001 TO S-004.
- 2. FOR TYPICAL DETAILS REFER TO S-1112 TO S-1120.
- 3. ALL STEEL SHALL BE CONTINUOUS U.N.O. REFER TO TYPICAL DETAILS FOR GRAVITY COLUMN SPLICING REQUIREMENTS. ALL SPLICE LOCATIONS NOT SHOWN SHALL BE REVIEWED AND APPROVED BY THE DOR PRIOR TO PROCEEDING WITH FABRICATION.
- 4. ALL STEEL AT CONCOURSE LEVEL AND BELOW SHALL BE GALVANIZED.
- 5. REFER TO S-832 FOR SOUTH TERMINAL BRACED FRAME ELEVATIONS.
- 6. REFER TO S-833 AND S-834 FOR SOUTH TERMINAL MOMENT FRAME ELEVATIONS.









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# 95th Terminal Improvement 15 West 95th Street (South Terminal)

15 West 95th Street (South Terminal) Chicago, IL 60628

MARK	DATE	DESCRIPTION
	2/9/17	ISSUED FOR CONSTRUCTION
FILE N	NAME	DR095_S-Terminal
	ECT NO.	2012-0021.02
	/N BY	J. PEARSON
	ENED BY	G. FORKAN
	KED BY	R.S. NAIR
	OVED BY	J. JAKALSKI
	ARGE	J. JAKALSKI

LOCATION IDENTIFIER: DR095

STEEL COLUMN SCHEDULES



FILLER PL AS REQD, SEE SCHEDULE

A325 SC BOLTS, SEE SCHEDULE FOR

DIA. AND # OF BOLTS
PER FLANGE PL

FLANGE PL,


SEE SCHEDULE

W14 COLUMN,

SEE PLAN & SCHEDULE

SHOP BOLTS — FOR FILLER PL




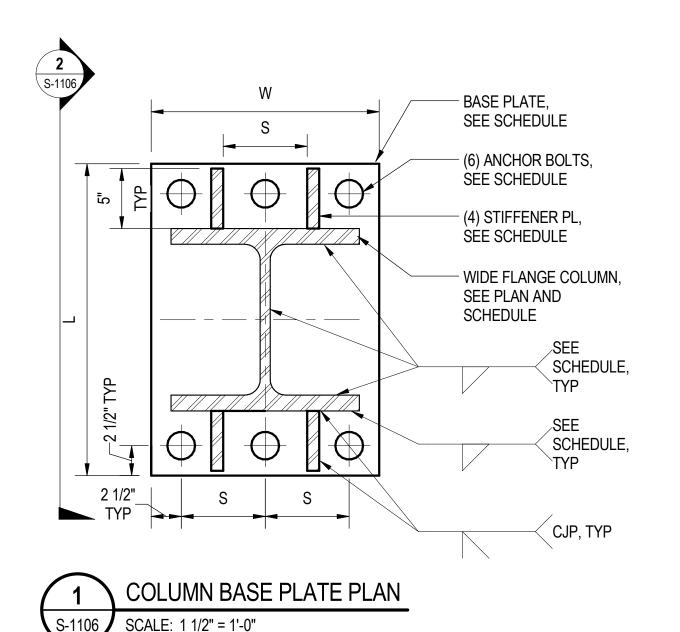

COL

**COLUMN SPLICE DETAIL** 


— TOP OF CONCRETE

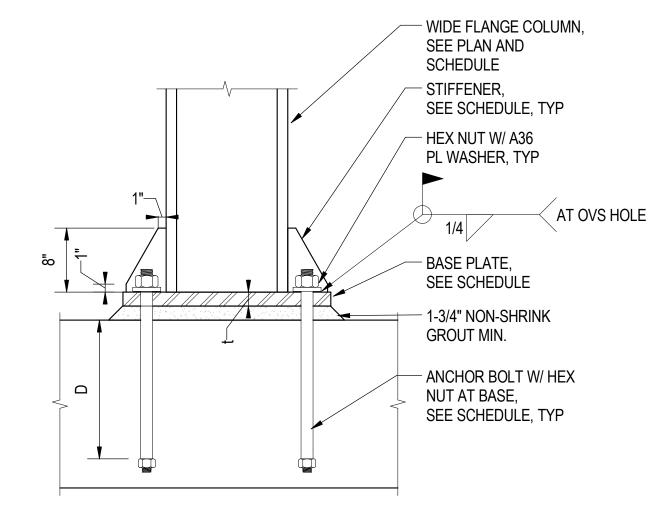


- 1		COLUMN BASE PLATE SECTION
1	S-1106	SCALE: 1" = 1'-0"

	BASE PLATE SCHEDULE									
MARK BASE PLATE ANCHOR BOLTS STIFFENER COL. TO BASE PL										
IVI/ (I (I (	L	W	t	DIA.	D	THICKNESS	FILLET WELD SIZE			
BP-1	26"	19"	1.75"	1.25"	18"	1"	5/16"			
BP-2	26"	19"	1.75"	1.25"	18"	1.25"	3/8"			
BP-3	26"	19"	1.75"	1.5"	18"	1.5"	1/2"			

COLUMN SPLICE SCHEDULE									
MARK	MARK FLANGE PLATE ALL BOLTS								
IVIZILALA	L W t g #OF BOLTS / PL								
SP-1	30"	14"	3/4"	11.5"	20	1"			
SP-2	42"	14"	3/4"	11.5"	28	1"			

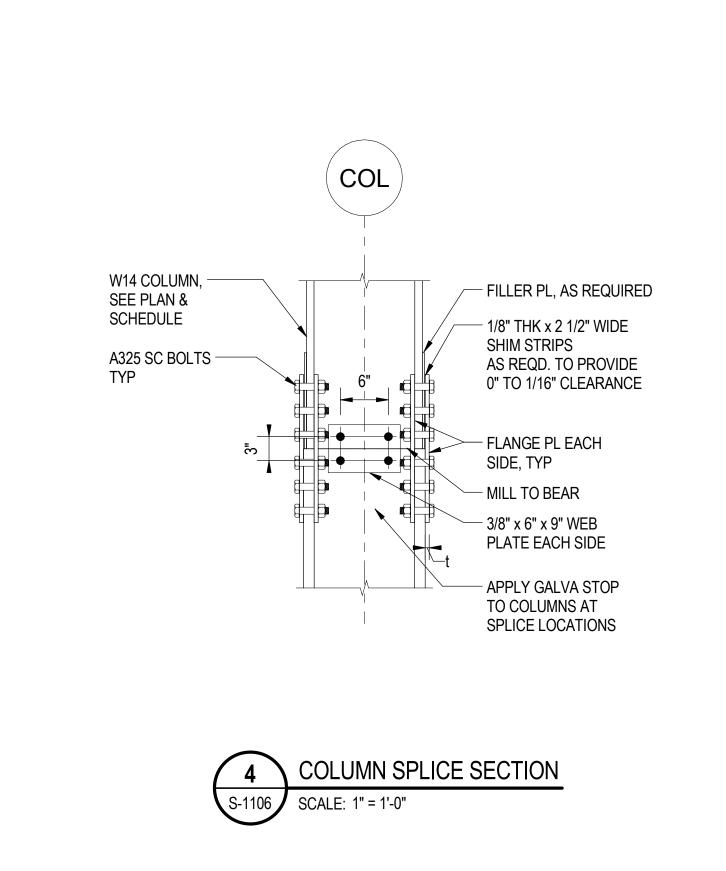

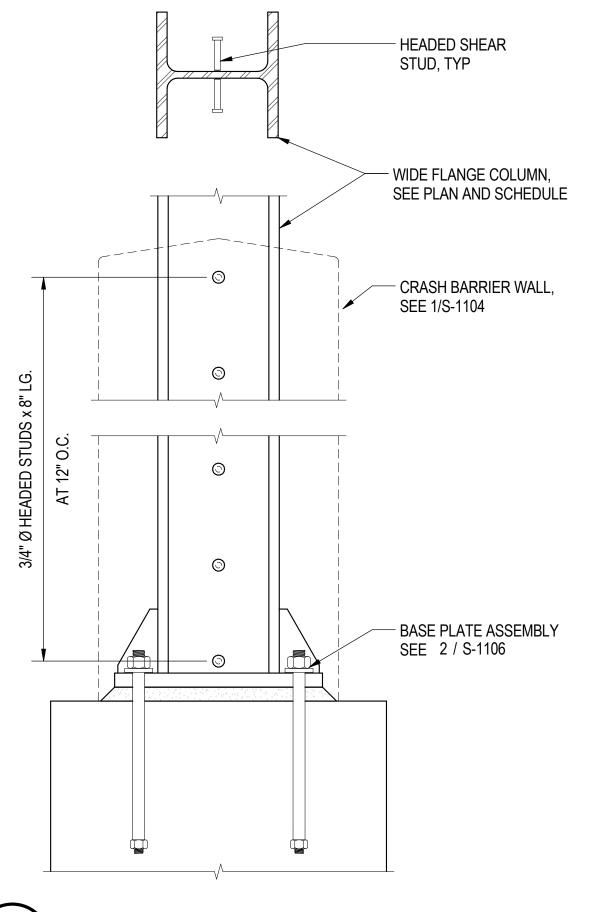

HEADED STUD AT COLUMN DETAIL SCALE: 1" = 1'-0"





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# 95th Terminal Improvement

15 West 95th Street (South Terminal) Chicago, IL 60628

IN CH	ARGE	J. JAKALSKI
APPR	OVED BY	J. JAKALSKI
CHEC	KED BY	R.S. NAIR
DESIG	ENED BY	G. FORKAN
DRAW	/N BY	M. DONAHUE
PROJ	ECT NO.	2012-0021.02
FILE N	NAME	DR095_S-Terminal
	0/0/4=	LOCUED FOR CONSTRUCTION
	2/9/17	ISSUED FOR CONSTRUCTION
MARK	DATE	DESCRIPTION
LOC	ATION IDE	ENTIFIER: <b>DR095</b>


**COLUMN AND BASE PLATE DETAILS** 

### BEAM 16G

Location	Station	Offset	Theoretical Grade Elevations	Theoretical Grade Elevations Adjusted For Dead Load Deflection
START	22+94.03	- 71.73	17.24	17.25
CL BRG. E. ABUT	22+99.00	- 71.73	17.09	17.09
CL EXP JT	22+99.94	- 71.73	17.06	17.06
BK E. ABUT	23+02.02	- 71.73	17.00	17.00

### BEAM 16H

Location	Station	Offset	Theoretical Grade Elevations	Theoretical Grade Elevations Adjusted For Dead Load Deflection
START	22+89.06	-66.75	17.37	17.40
CL BRG. E. ABUT	22+99.00	-76.71	17.09	17.09
CL EXP JT	22+99.94	-77.65	17.06	17.06
BK E. ABUT	23+02.02	-79.73	17.00	17.00

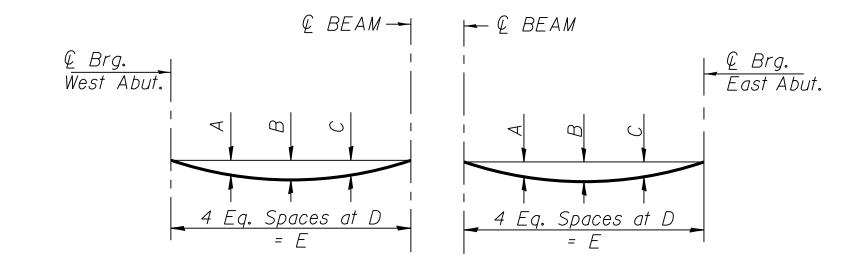


### DEAD LOAD DEFLECTIONS

Beam	А	В	С	D	Ε
1K	/ " 8	4"	4"	7'-0 <sup>3</sup> 8"(-)	28′-1 <sup>3</sup> 8"
16F	/ <sub>8</sub> "	/ <sub>8</sub> "	<i>l</i> "	6'-3 <sup>3</sup> 4"(+)	25'-3 <sub>16</sub> "

Beams 1F,1G,1H,1I,1J,16D,16E,16G & 16H have no measurable dead load deflection.

# DEAD LOAD DEFLECTIONS

Beam			Span 1			Span 2			Span 3						
Deam	А	В	С	D	E	F	G	Н	I	J	К	L	М	N	0
1A	78"	18"	<sup>5</sup> 8"	18'-10 <sup>3</sup> 8"(+	) 75′-5 <sup>5</sup> 8"	<i>l</i> "	/ <sub>4</sub> "	<i> </i>	10'-412"	41'-6"	<sup>5</sup> 8"	1"	34"	18'-9 <sup>3</sup> 4"(+)	75′-3¦ <sub>6</sub> "
1B	78"	1/8"	<sup>5</sup> 8"	18'-10"(+)	75′-4¦ <sub>6</sub> "	/ <sub>8</sub> "	/ <sub>4</sub> "	<i>l</i> , "	10'-412"	41'-6"	<sup>5</sup> 8"	1"	34"	18'-9 <sup>1</sup> 2"(-)	75'-1 <sup>15</sup> 16"
1C	1/2"	2"	1'4"	18'-9 <sup>1</sup> 2"	75′-2"	38"	12"	38"	10'-412"	41'-6"	14"	2"	1/2"	18'-9"(-)	74 '- 11 <sup>15</sup> 16 "
1D	1/2"	2"	1'4"	18'-8 <sup>7</sup> 8"(+)	74′-11 <sup>9</sup> 16″	38"	1 "	38"	10'-412"	41'-6"	14"	2"	1/2"	18'-8 <sup>3</sup> 8"(+)	
1E	34"	<sup>7</sup> 8"	<i>l</i> "	18'-8 <sup>3</sup> 8"(+)	74′-9 <sup>5</sup> 8"	/ <sub>8</sub> "	/ <sub>4</sub> "	<i>l</i> "	10'-412"	41'-6"	5 <sub>8</sub> "	1"	34"	18'-8 <sup>3</sup> 8"(+)	74′-9 <sup>5</sup> 8"
16 A	1/2"	2"	1'4"	18'-8 <sup>3</sup> 8"(+)	74′-9 <sup>5</sup> 8"	38"	2"	38"	10'-412"	41'-6"	1/4"	2"	1/2"	18'-8 <sup>3</sup> 8"(+)	74′-9 <sup>5</sup> 8"
16B	1/2"	2"	1'4"	18'-8 <sup>3</sup> 8"(+)	74′-9 <sup>5</sup> 8"	38"	1 <sub>2</sub> "	38"	10'-478"(+)	41'-7 <sup>5</sup> 8"	1/4"	2"	1/2"	18'-8 "(+)	74′-8"
16C	<i>3</i> <sub>4</sub> "	1"	<sup>5</sup> 8"	18'-8 <sup>3</sup> 8"(+)	74′-9 <sup>5</sup> 8"	l " 8	/ <sub>4</sub> "	<i> </i>	10'-518"(+)	41'-8 <sup>3</sup> 4"	12"	7 <sub>8</sub> "	58"	18'-7 <sup>3</sup> 4"(-)	74′-6 <sup>7</sup> 8"

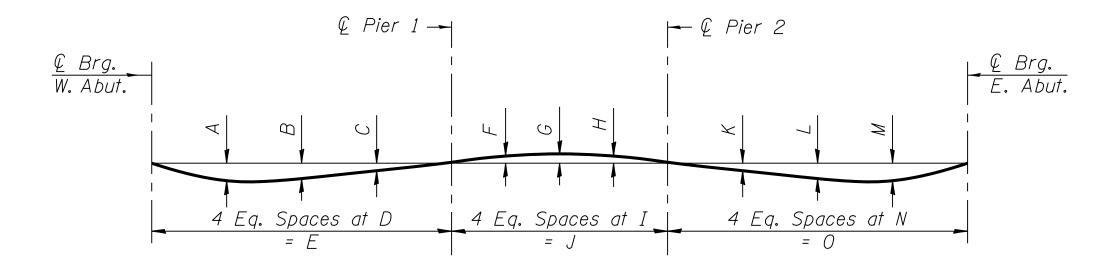


## DEAD LOAD DEFLECTION DIAGRAM

(Includes weight of concrete, excluding beams).

*Note:* 

The above deflections are not to be used in the field if the engineer is working from the grade elevations adjusted for dead load deflections as shown on sheets 95TH-S-108 thru 95TH-S-110A.

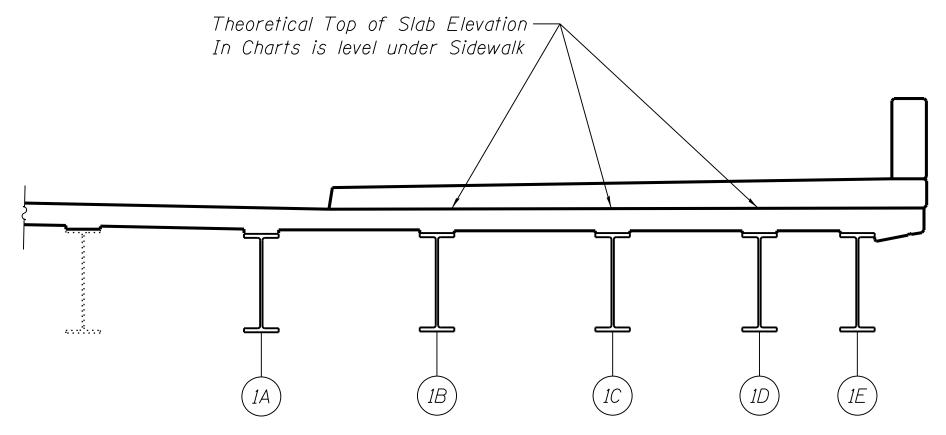

THEORETICAL TOP OF SLAB ELEVATION FOR BEAMS UNDER SIDEWALK

(Applies to beams 1B thru 1J & 16 thru 16H)

All Offsets with respect to @ Bridge & P.G.L.





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# 95th Terminal Improvement

15 West 95th Street (South Terminal) Chicago, IL 60628


ARGE	S. KADERBEK
OVED BY	D.ZROKA
KED BY	P.MAID
NED BY	L.SOMMER
N BY	T.SLEDGE
CT NO.	2012-0021
AME	File Name
	1
	_
2/9/17	ISSUED FOR CONSTRUCTION
DATE	DESCRIPTION

LOCATION IDENTIFIER: DR095

95TH ST. BRIDGE TOP OF SLAB ELEVATIONS (SHEET 6 OF 6) SN 016-0437

95TH-S-110A



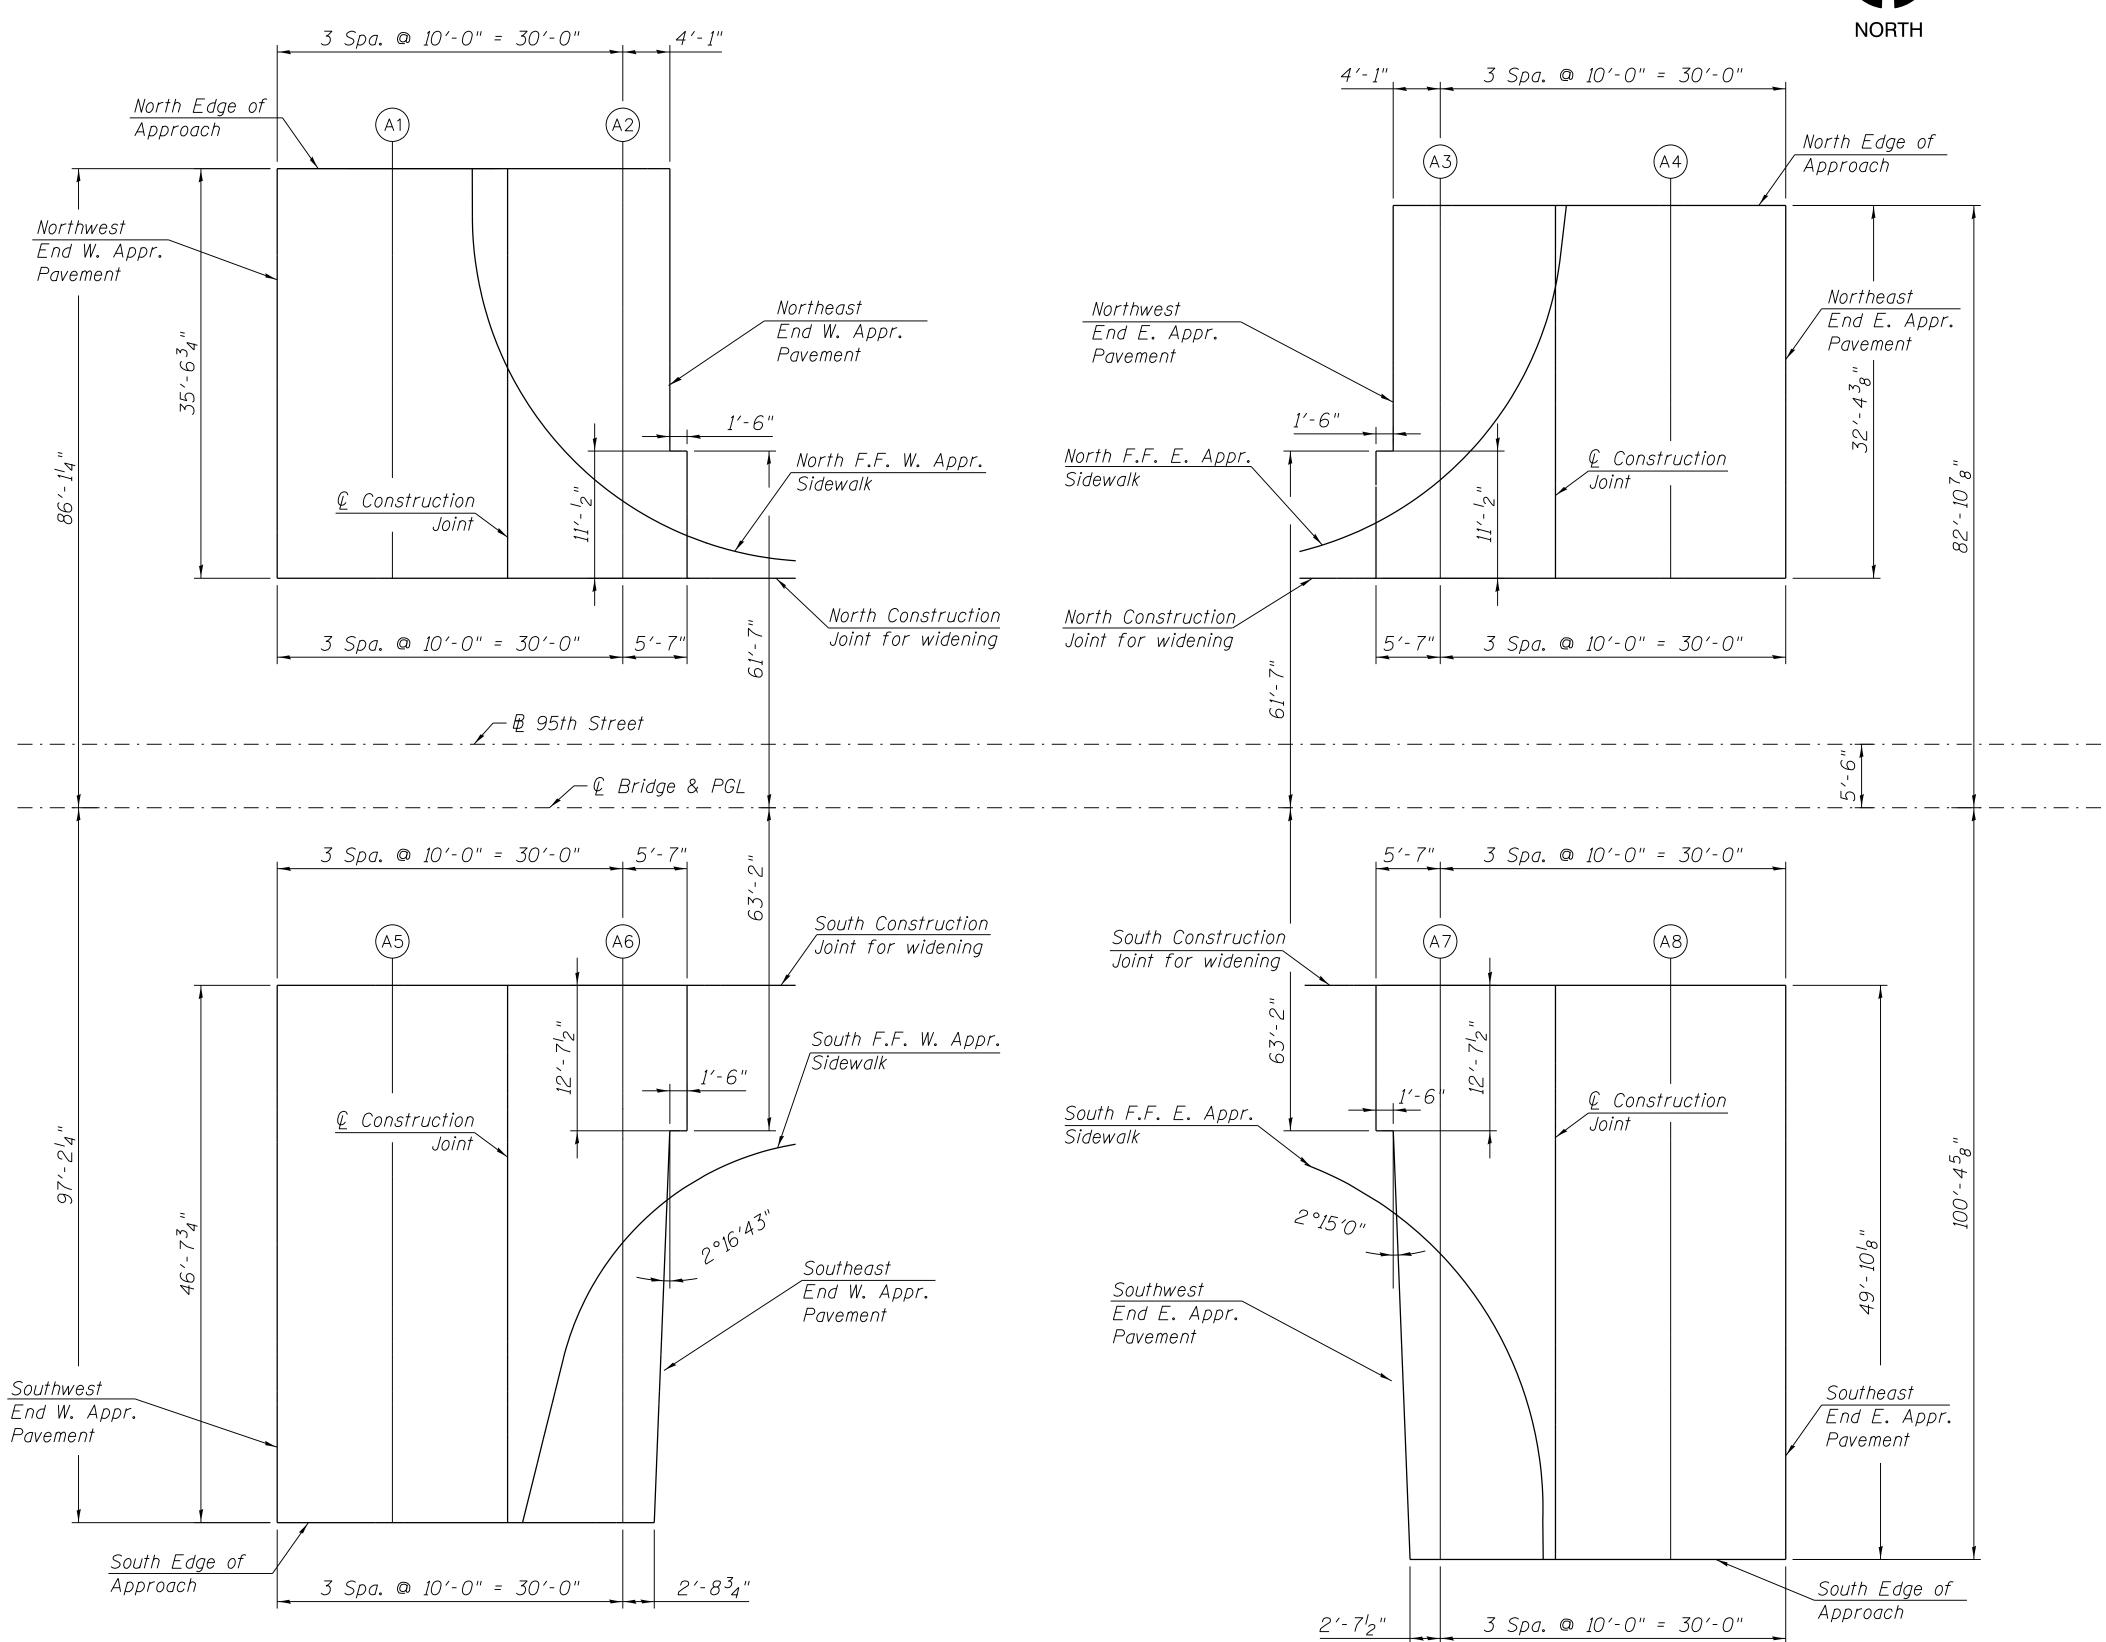

<u>PLAN</u>



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15 West 95th Street (South Terminal) Chicago, IL 60628

IN CH	ARGE	S. KADERBEK
APPR	OVED BY	D.ZROKA
CHEC	KED BY	P.MAID
DESI	SNED BY	L.SOMMER
DRAV	VN BY	T.SLEDGE
PROJ	ECT NO.	2012-0021
FILE I	NAME	File Name
	2/9/17	ISSUED FOR CONSTRUCTION
	2/3/17	


| LOCATION IDENTIFIER: DKU95

> 95TH ST. BRIDGE TOP OF APPROACH SLAB ELEVATIONS (SHEET 1 OF 2) SN 016-0437

95TH-S-111

 $= 070_DR095_S-111.dgn$ = 8/31/2016

FILE NAME : PLOT DATE

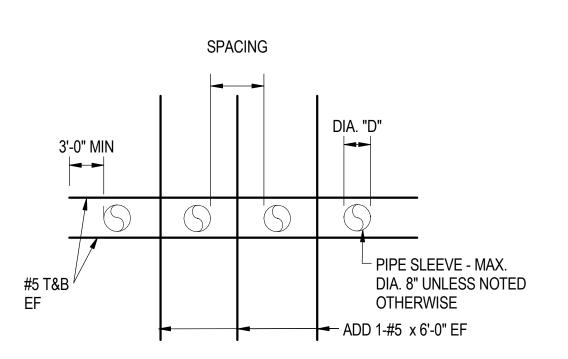



1. DETAIL APPLIES TO LOCATION WHERE S>4" OR

2. MIN. PIPE SPACING SHALL BE 2 x "D" WITH SPACING NO LESS THAN 4" CLEAR.

3. FOR SPACING WHERE S<=4", SLEEVES SHALL BE CONSIDERED AS A GROUP AND THE TYPICAL OPENING IN CONCRETE WALL OR SLAB DETAIL SHALL APPLY.

4. FOR SLEEVE OPENINGS LESS THAN TYPICAL WALL OR SLAB REINFORCING, NO ADDITIONAL REINFORCEMENT IS REQUIRED.

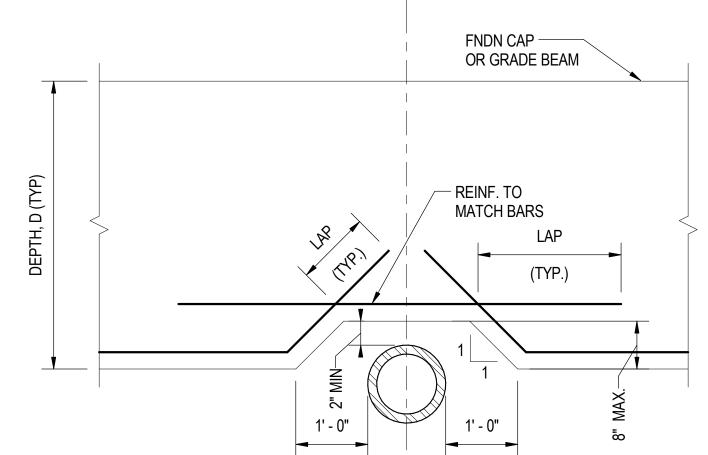


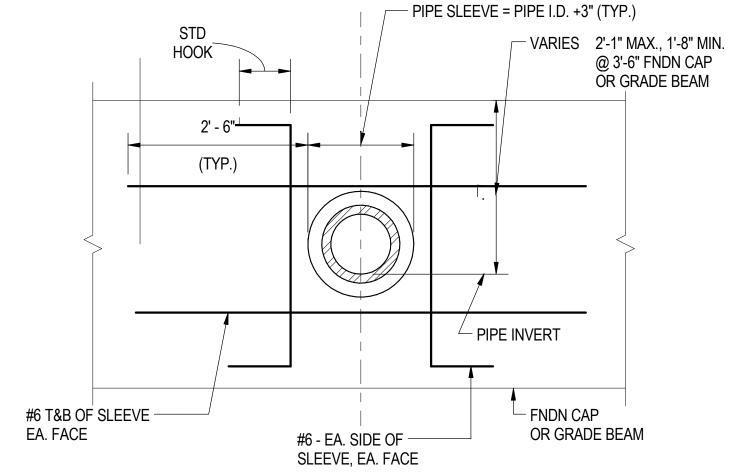


MID BLOCKOUT DETAIL
S-1112 SCALE: 3/4" = 1'-0"





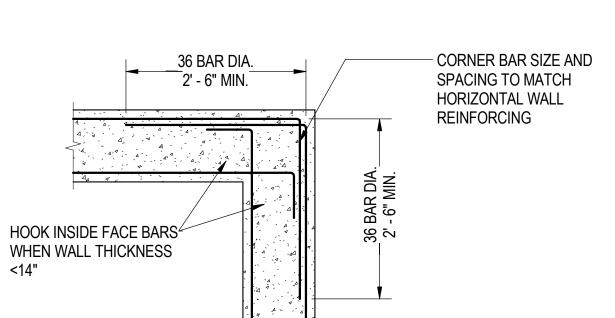

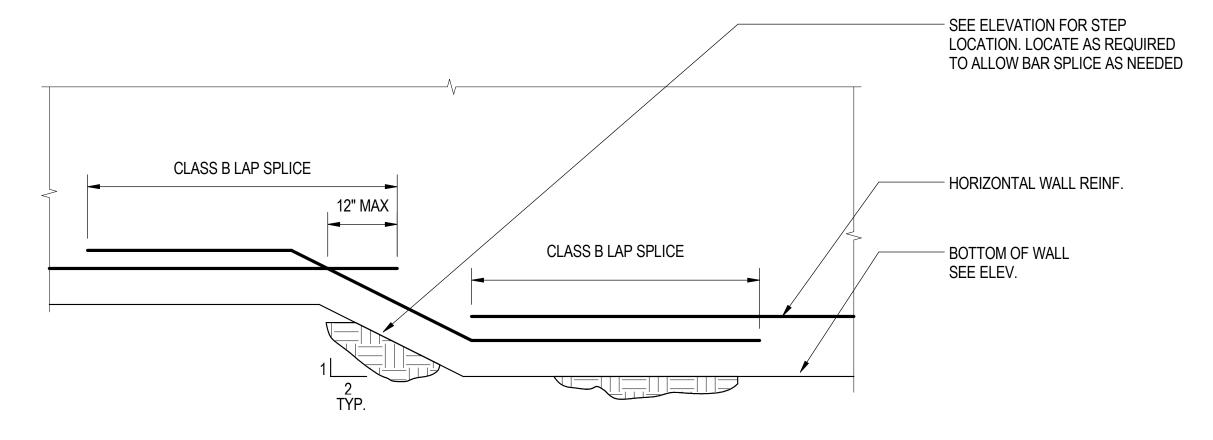


SMOOTH DOWELS AT 18" VERT WITH HILTI HY-200 ADHESIVE

- APPLY GREASE THIS END

OR EQUIVALENT


**BOTTOM BLOCKOUT DETAIL** 

SCALE: 3/4" = 1'-0"

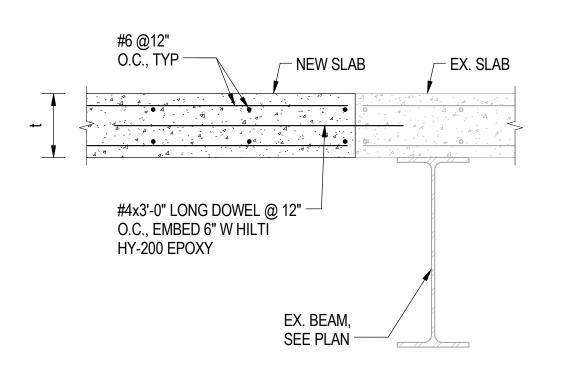

TYPICAL CORNER DETAIL FOR HORIZONTAL REINFORCING
S-1112 SCALE: 3/4" = 1'-0"



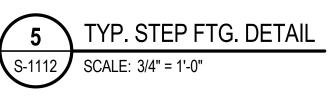





NO COLD JOINT OR KEYWAY AT CONTROL JOINT

WALL
REINFORCEMENT

CLASS B

LAP SPLICE, TYP

WYAL

REINFORCEMENT

1/2

CHAMFER

2"x6" CONT

KEYWAY


PLAN

7 CONST. JT. DETAIL FOR BARRIER WALLS
S-1112 SCALE: 1 1/2" = 1'-0"



## NOTES:

1. PRIOR TO PROCEEDING WITH ANY CONCRETE WALL OR SLAB POURS, THE CONTRACTOR SHALL SUBMIT COMPLETE COORDINATION DRAWINGS INDICATING ALL PENETRATIONS THROUGH CONCRETE FOR REVIEW AND APPROVAL. REFER TO MEP AND ARCH DWGS FOR ALL INFORMATION NOT SHOWN.

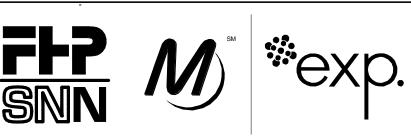



### **SENSITIVE SECURITY INFORMATION**

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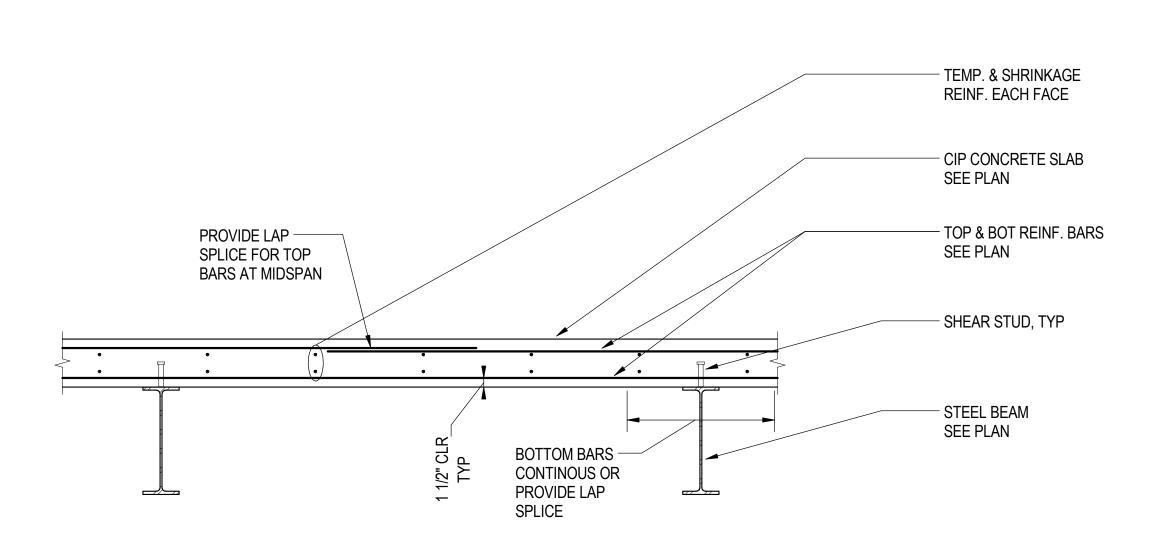
# 95th Terminal Improvement

15 West 95th Street (South Terminal) Chicago, IL 60628

IN CH	ARGE	J. JAKALSKI
APPR	OVED BY	J. JAKALSKI
CHEC	KED BY	R.S. NAIR
DESIC	ENED BY	G. FORKAN
DRAV	/N BY	C. BOVE
PROJ	ECT NO.	2012-0021.02
FILE N	NAME	DR095_S-Terminal
	2/9/17	<b>ISSUED FOR CONSTRUCTION</b>

LOCATION IDENTIFIER: **DR095** 

**TYPICAL DETAILS-CONCRETE-1** 




SEE PLAN <sup>⊊</sup> BEAM **FBEAM** - SEE MEP/ARCH - W BEAM W BEAM -**DWGS** 1-#4 EACH SIDE OF OPENING FIELD CUT STEEL DECK OPENING 0' - 3" MIN. - BLOCK OUT 1-#4 x 3'-0" - 2-#6 T&B PLACE BOT EACH CORNER BARS IN RIB OF DECK/SLAB SPAN STEEL DECK, IF POSSIBLE

### NOTE:

- 1. DO NOT CUT DECKING UNTIL CONCRETE HAS ATTAINED 80% OF DESIGN STRENGTH.
- 2. OPENING MAY BE DEFINED BY A GROUP OF SLEEVES.
- 3. FOR OPENINGS LARGER THAN 2'-0", REFER TO PLANS FOR STRUCTURAL STEEL FRAMING AT OPENING LOCATIONS.
- 4. PRIOR TO PROCEEDING WITH ANY CONCRETE SLAB POURS, THE CONTRACTOR SHALL SUBMIT COMPLETE COORDINATION DRAWINGS INDICATING ALL PENETRATIONS THROUGH CONCRETE FOR REVIEW AND APPROVAL. REFER TO MEP AND ARCH DWGS FOR ALL INFORMATION NOT SHOWN.


REINF AT CIP OR COMPOSITE SLAB OPENING
S-1113 SCALE: 1/2" = 1'-0"

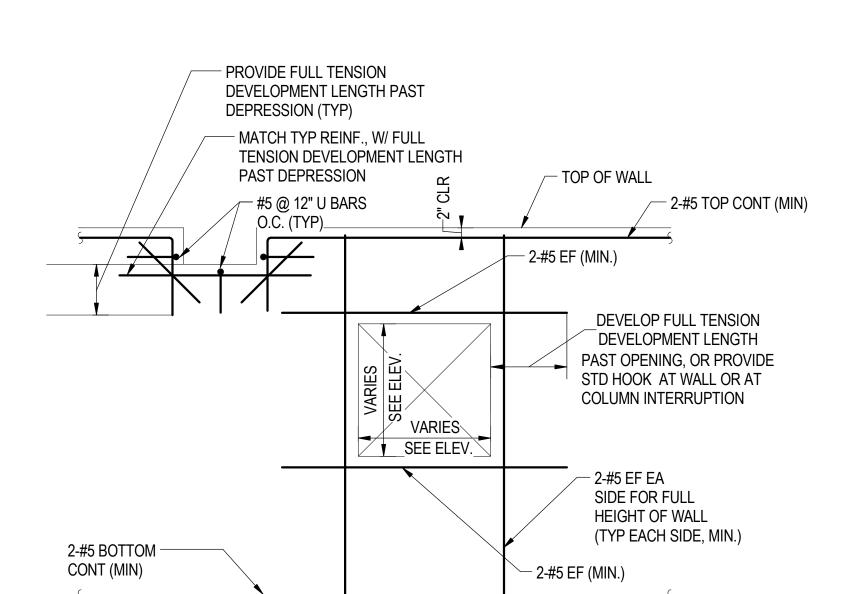

3 OPENING IN REINFORCED CONCRETE WALLS
SCALE: 1" = 1'-0"

CIP CONCRETE SLAB DETAIL

SCALE: 3/4" = 1'-0"

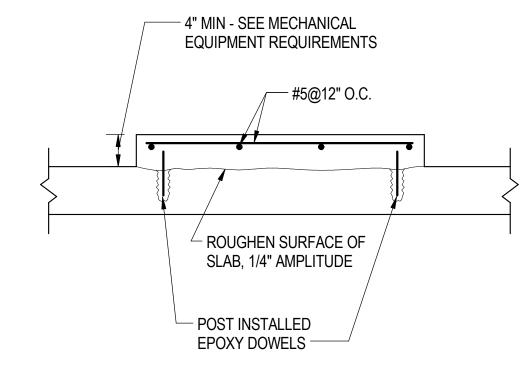


NOTES:

1. CONTRACTOR TO SUBMIT ALL ANCHOR INFORMATION BASED ON MANUFACTURER REQUIREMENTS, DO NOT DAMAGE EXISTING REINFORCEMENT.

2. COORDINATE SIZE AND LOCATION WITH ARCHITECTURAL AND MECHANICAL DRAWINGS.



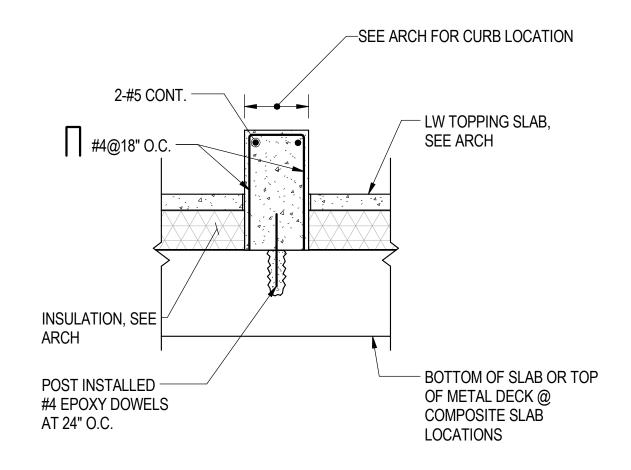

5 INTERIOR CONCRETE CURB DETAIL
S-1113 SCALE: 1" = 1'-0"





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# 95th Terminal Improvement 15 West 95th Street (South Terminal) Chicago, IL 60628

IN CHARGE

APPROVED BY

J. JAKALSKI

CHECKED BY

R.S. NAIR

DESIGNED BY

G. FORKAN

DRAWN BY

C. BOVE

PROJECT NO. 2012-0021.02

FILE NAME


DR095\_S-Terminal

2/9/17 ISSUED FOR CONSTRUCTION
MARK DATE DESCRIPTION

**DR095** 

LOCATION IDENTIFIER:

TYPICAL DETAILS-CONCRETE-2

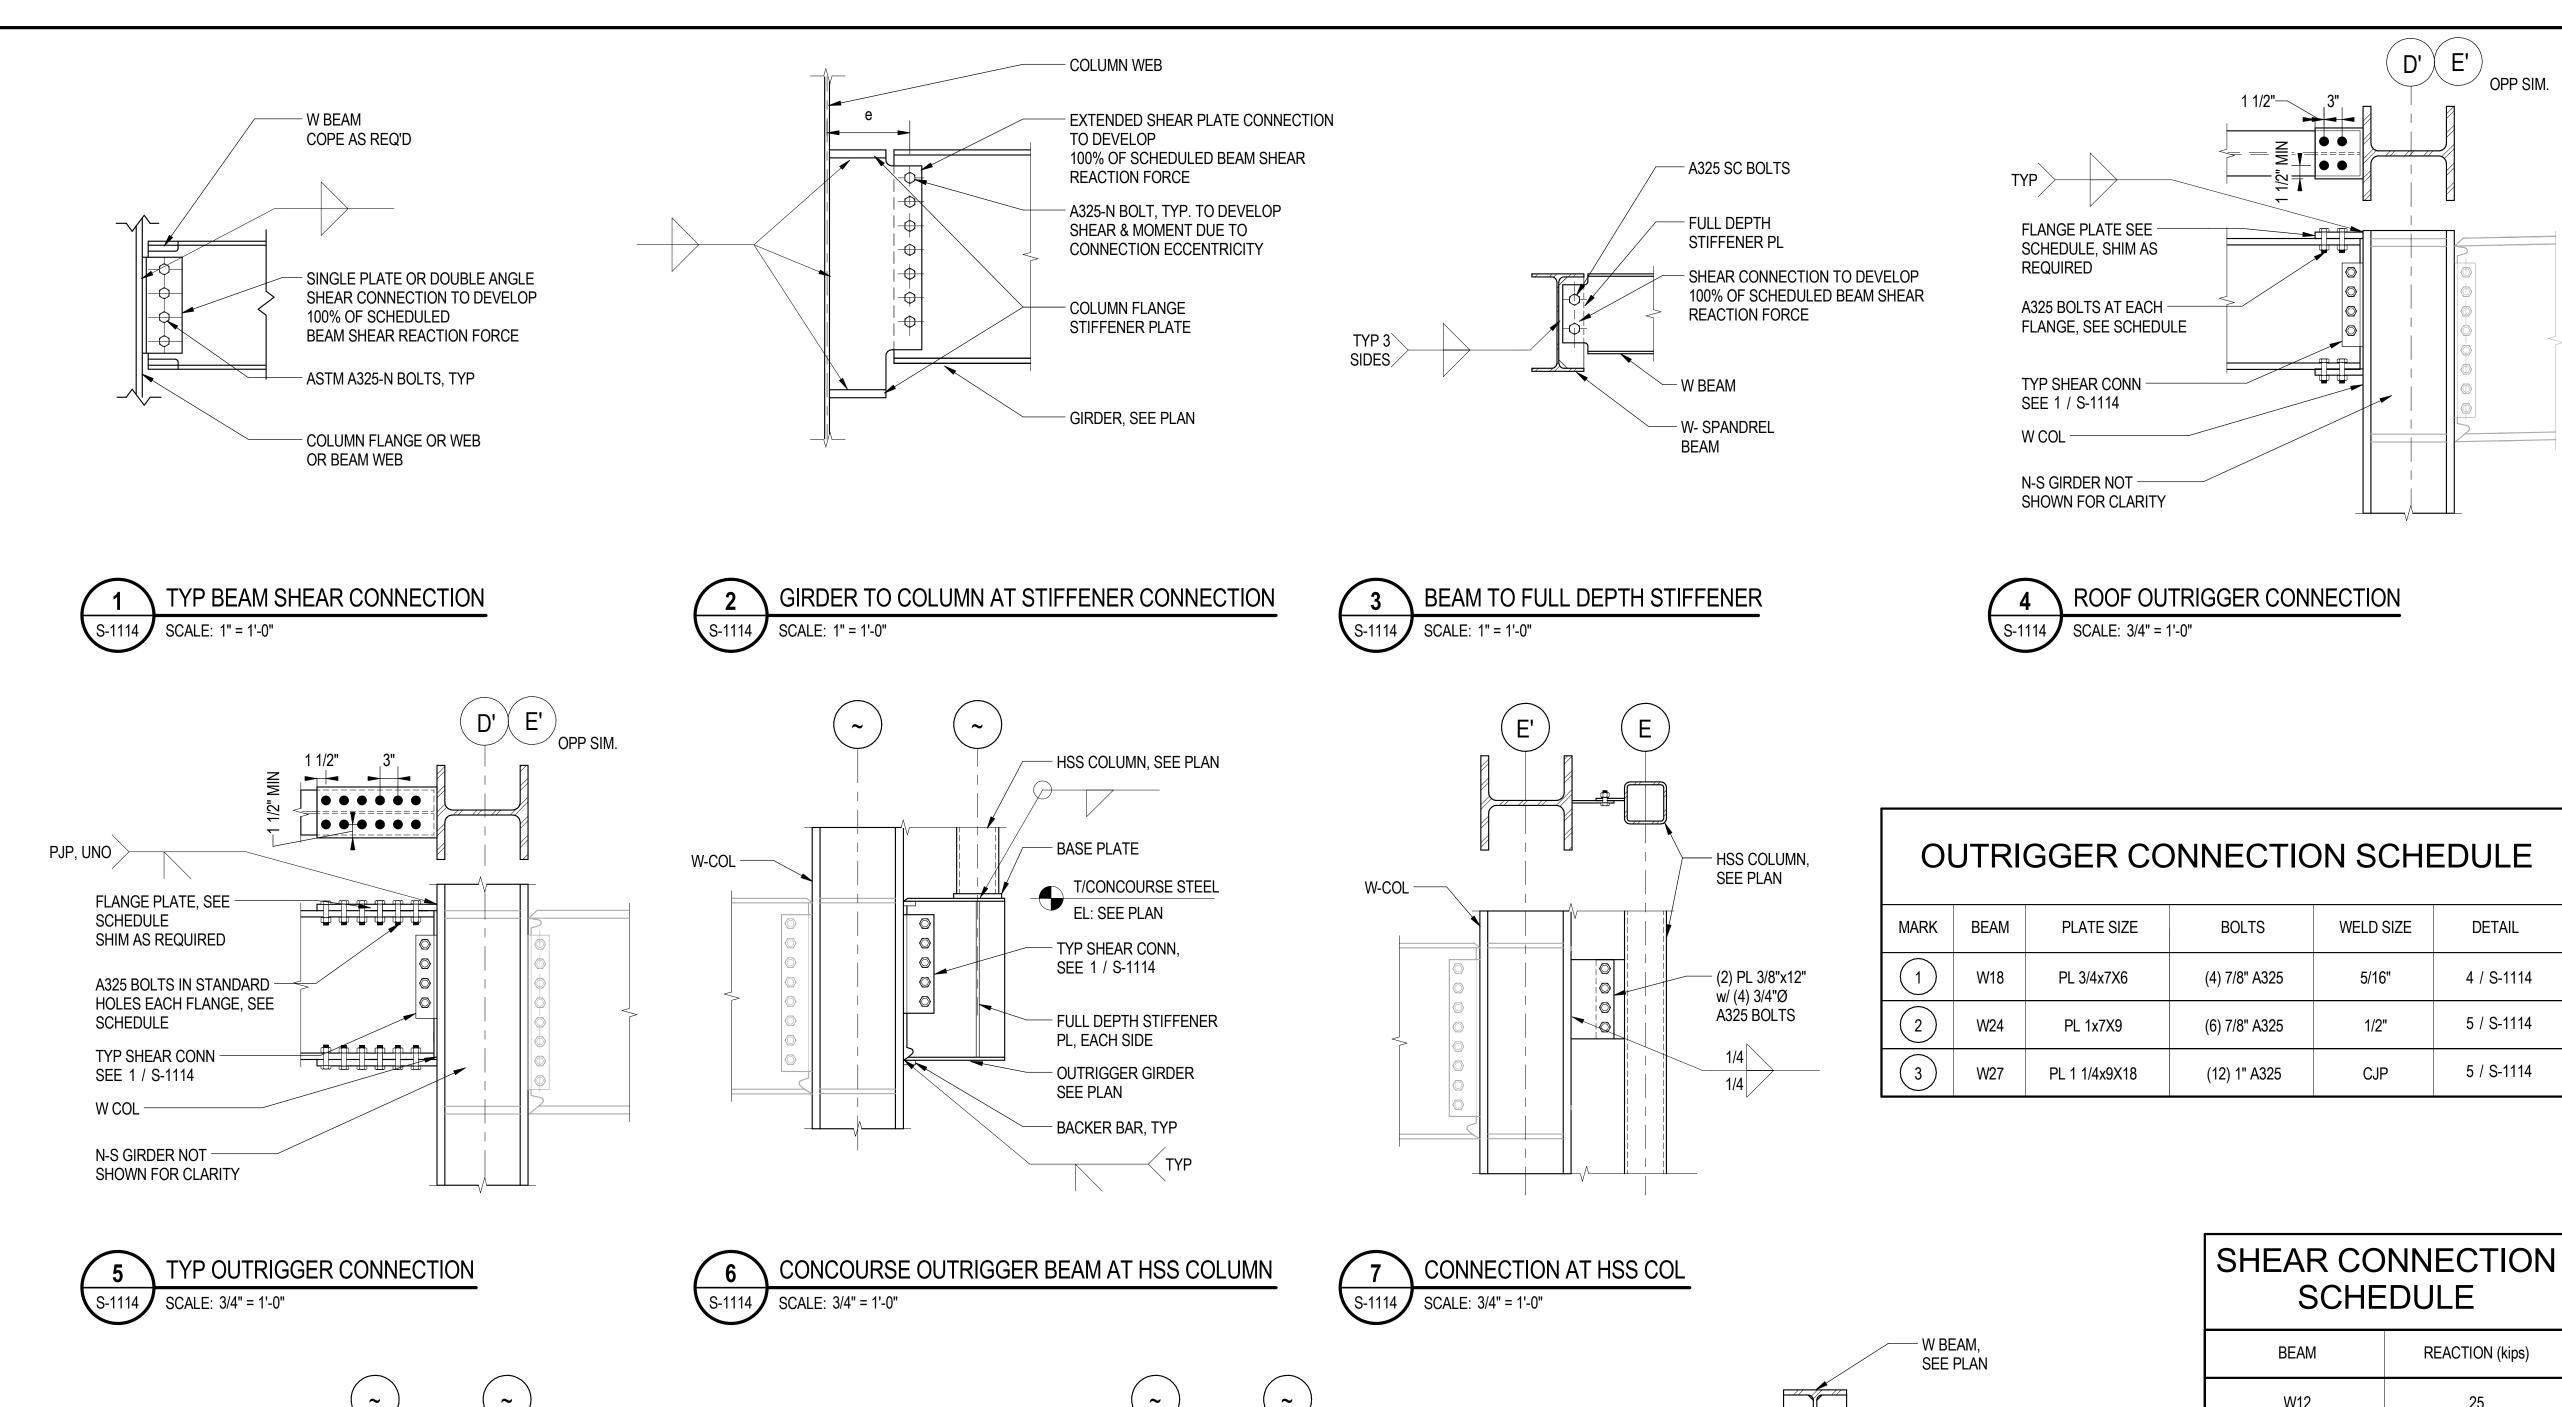

OUTRIGGER GIRDER

(2)L4x4x5/16 w/ (6)7/8"

- W24 TRUSS CHORD

STIFFENER PL EA SIDE

(2) PL3/8"x6 1/4"x18" w/

HSS TRUSS MEMBER

BACKER BAR, TYP

(14) 7/8" DIA A325 BOLTS

AT GRID LINE D' A BOLTED

FLANGE PL MOMENT CONNECTION MAY

DÍA. A325 BOLTS

1/2" FULL DEPTH

BE USED

W-COL

**OUTRIGGER BEAM AT TRUSS** 

SCALE: 3/4" = 1'-0"

T/2ND FLR STL

5/16

5/16

S-1114

SEE PLAN

T/ROOF STL

5/16

W-COL

SCALE: 3/4" = 1'-0"

ROOF OUTRIGGER BEAM AT TRUSS

- HSS TRUSS MEMBER

OUTRIGGER GIRDER

(2)L4x4x5/16 w/ (6)7/8"

DÍA. A325 BOLTS

- W24 TRUSS CHORD

1/2" FULL DEPTH

BE USED

BACKER BAR, TYP

STIFFENER PL EA SIDE

- (2) PL3/8"x6 1/4"x18" w/

(14) 7/8" DIA A325 BOLTS

AT GRID LINE D' A BOLTED

FLANGE PL MOMENT CONNECTION MAY

SEE PLAN

**SCHEDULE** REACTION (kips) W12 25 50 W18 W21 50 70 W24 110 W27 W30 125 W33 150 W36 200

HSS20

1/4" FULL DEPTH STIFFENER

3 SIDES TYP

PL,EACH SICE

- HSS HANGER

- (8) 3/4" A325 BOLTS

SEE PLAN

HANGER CONNECTION

SCALE: 3/4" = 1'-0"

- 10 1/2"x1' - 0"x1" THK PL

DETAIL

4 / S-1114

5 / S-1114

5 / S-1114

NOTES: 1. SHEAR CONNECTIONS SHALL BE DESIGNED BY A LICENSED SE IN THE STATE OF IL TO DEVELOP 100% OF THE INDICATED FORCES 2. INDICATED FORCES ARE FACTORED LOADS 3. DESIGN FOR THE FORCES IN THIS SCHEDULE UNLESS NOTED OTHERWISE ON PLAN.

45

CHICAGO TRANSIT cta **AUTHORITY ENGINEERING** 

**SENSITIVE SECURITY INFORMATION** 


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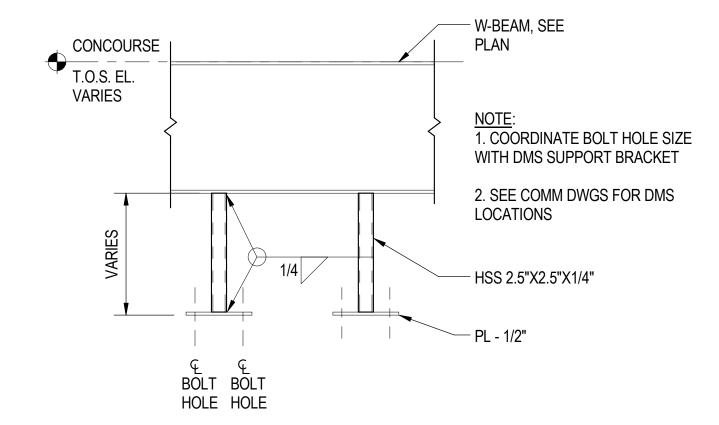
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95th Terminal Improvement 15 West 95th Street (South Terminal) Chicago, IL 60628


//ARK	2/9/17 DATE	DESCRIPTION
FILE F	NAME	DR095_S-Terminal
	ECT NO.	2012-0021.02
DRAW	/N BY	C. BOVE
DESIG	ENED BY	G. FORKAN
	KED BY	R.S. NAIR
	ARGE OVED BY	J. JAKALSKI J. JAKALSKI

**TYPICAL DETAILS - STEEL - 1** 




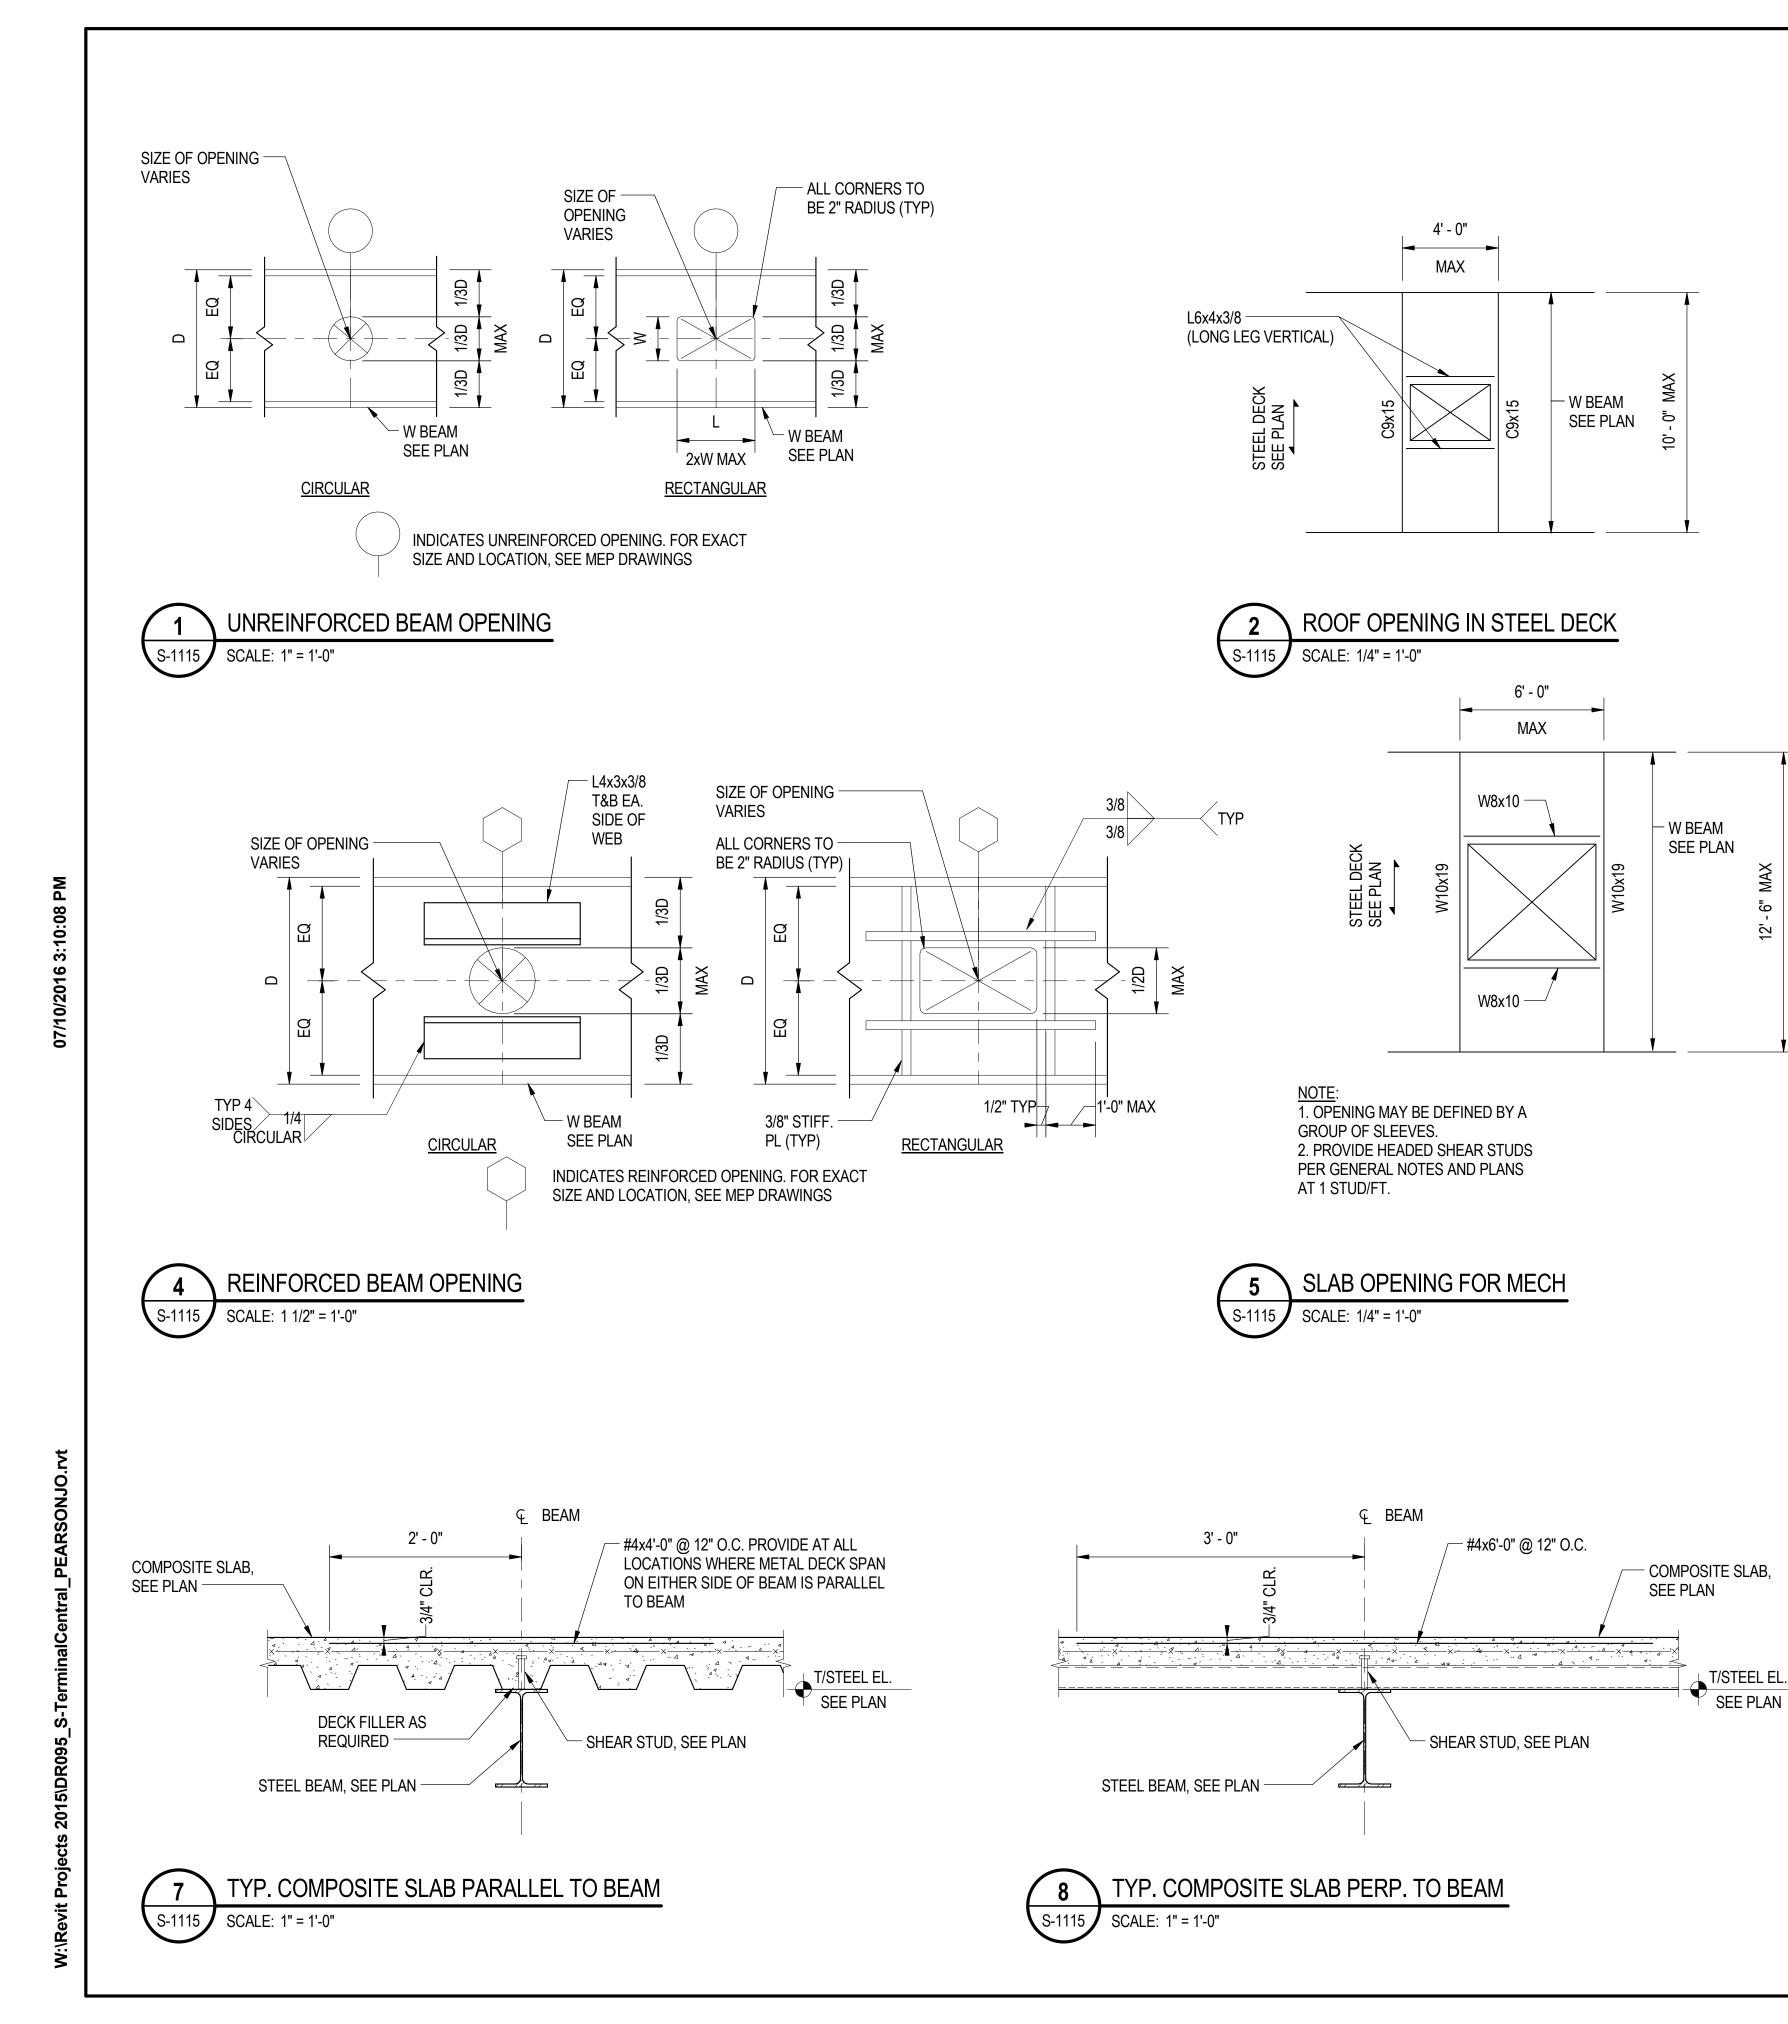


3 DMS SUPPORTS AT PLATFORM S-1115 SCALE: 3/4" = 1'-0"

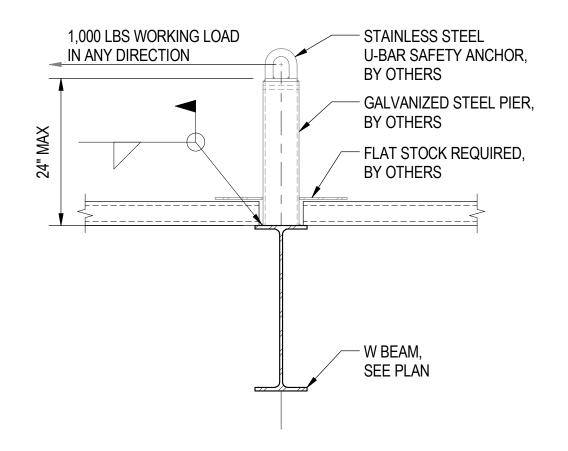

6 DAVIT DETAIL
S-1115 SCALE: 1" = 1'-0"

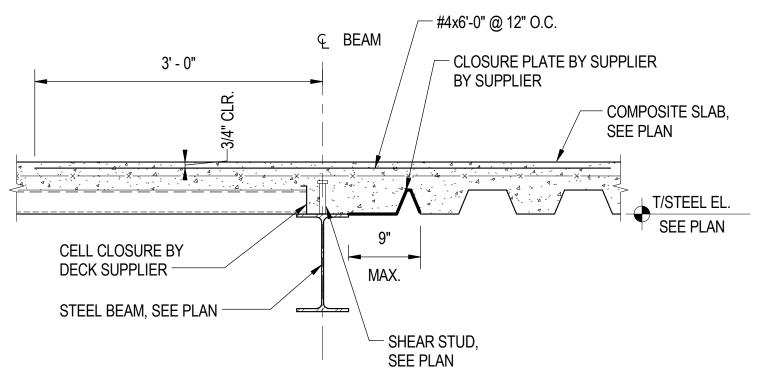

9 TYP COMPOSITE SLAB DIRECTION CHANGE AT BEAM
SCALE: 1" = 1'-0"

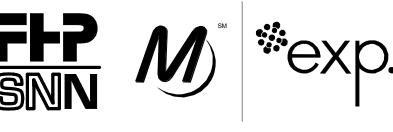



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95th Terminal Improvement
15 West 95th Street (South Terminal)
Chicago, IL 60628

IN CHARGE

APPROVED BY

J. JAKALSKI

CHECKED BY

R.S. NAIR

DESIGNED BY

G. FORKAN

DRAWN BY

C. BOVE

PROJECT NO. 2012-0021.02

FILE NAME


DR095\_S-Terminal


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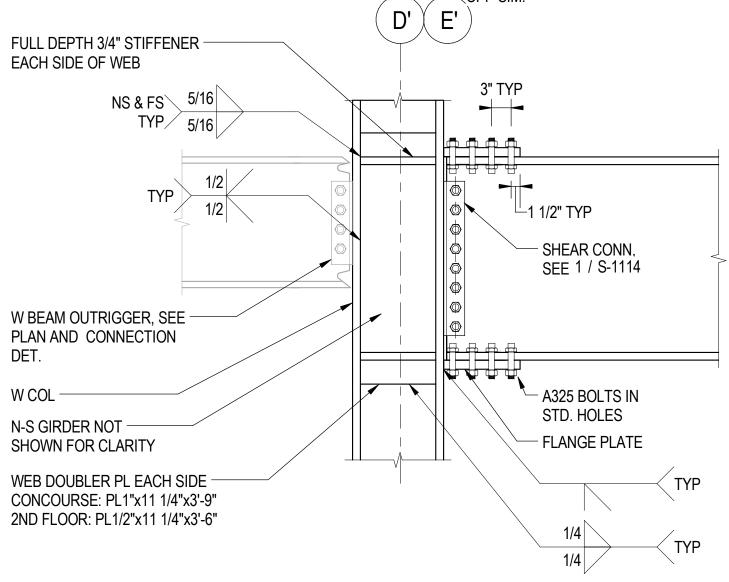
LOCATION IDENTIFIER: DR095

2/9/17 ISSUED FOR CONSTRUCTION

**TYPICAL DETAILS - STEEL - 2** 



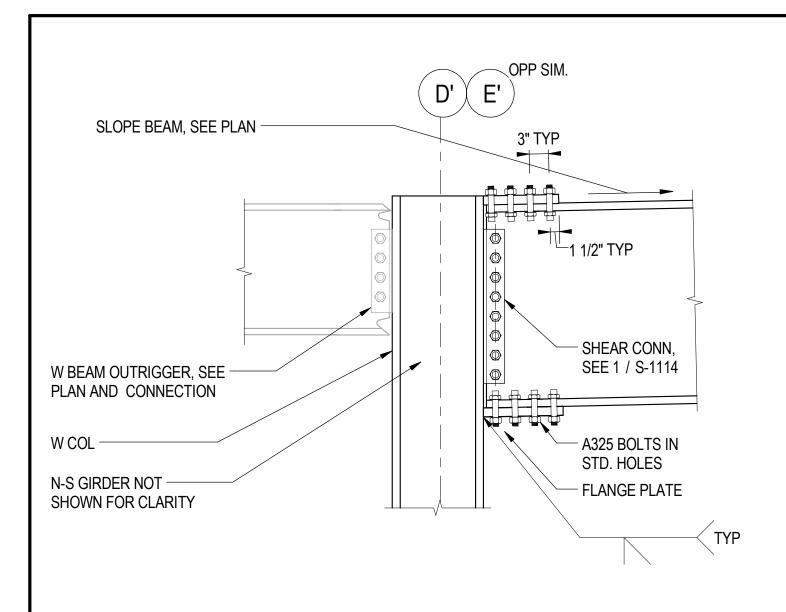

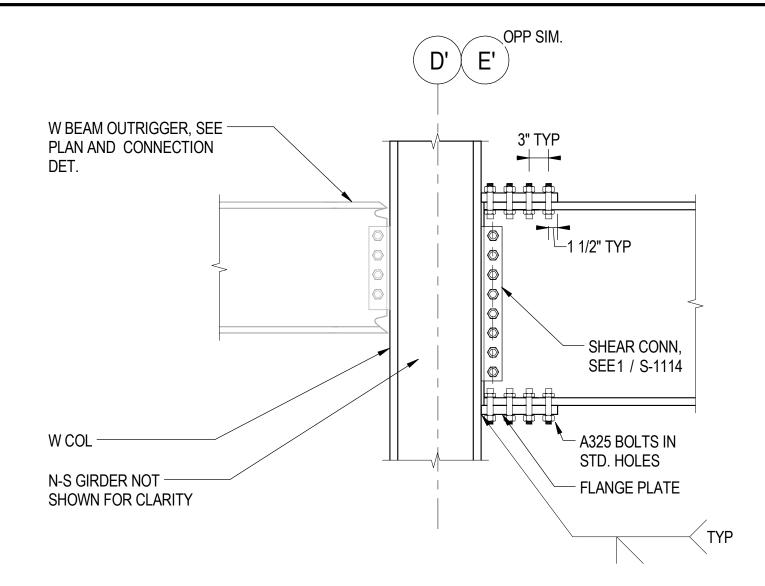



CHICAGO TRANSIT

**AUTHORITY** 

**ENGINEERING** 

**SENSITIVE SECURITY INFORMATION** 

95th Terminal Improvement


15 West 95th Street (South Terminal) Chicago, IL 60628


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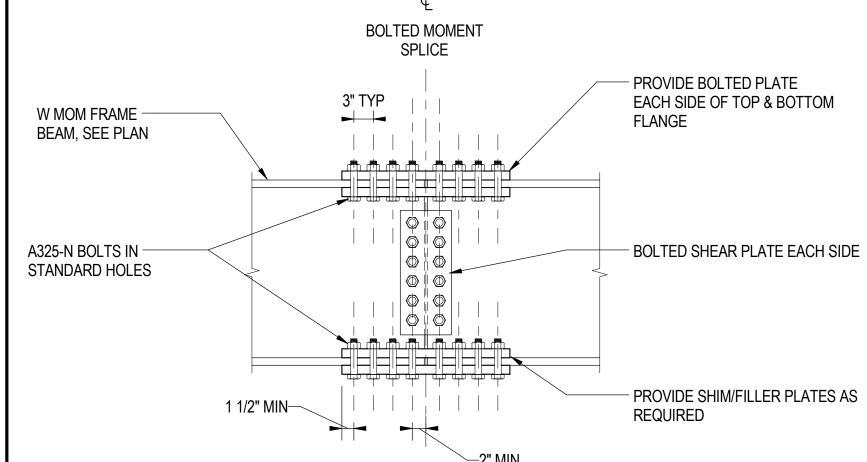
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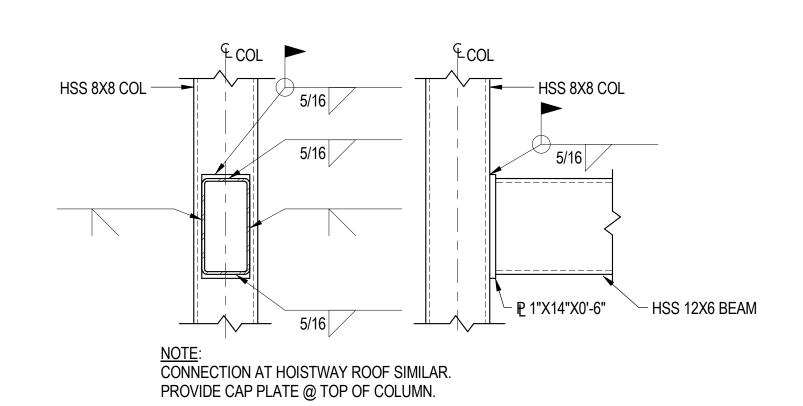
BY SCALING OF THIS DRAWING.






STIFFENED MOMENT FRAME CONNECTION SCALE: 3/4" = 1'-0"

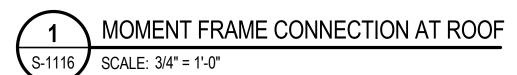

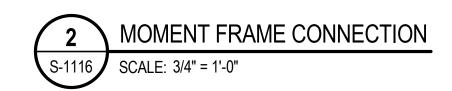

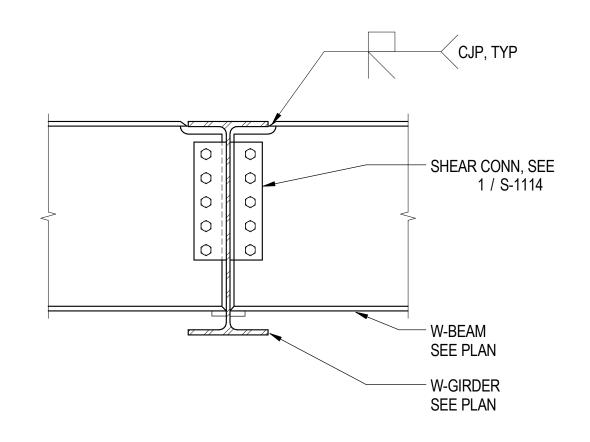



5	HSS BEAM TO COLUMN MOMENT CONNECTION
S-1116	SCALE: 1" = 1'-0"




7	BEAM TO GIRDER MOMENT CONNECTION
S-1116	SCALE: 1" = 1'-0"


IN CH	ARGE	J. JAKALSKI
APPR	OVED BY	J. JAKALSKI
CHEC	KED BY	R.S. NAIR
DESIG	ENED BY	G. FORKAN
DRAW	/N BY	C. BOVE
PROJ	ECT NO.	2012-0021.02
FILE	NAME	DR095_S-Terminal
	1	
	<u> </u>	
	2/9/17	ISSUED FOR CONSTRUCTION
MARK	DATE	DESCRIPTION
LOC	ATION IDI	ENTIFIER: <b>DR095</b>


**TYPICAL MOMENT CONNECTION DETAILS - 1** 

S-1116

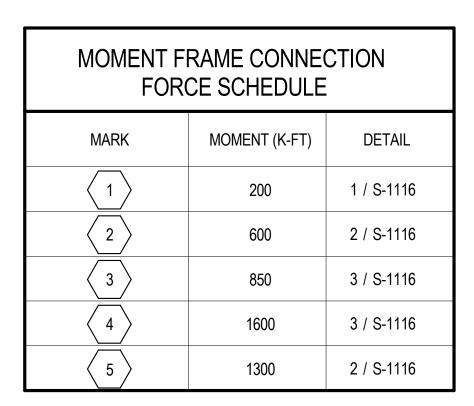

1. MOMENT CONNECTIONS SHALL BE DESIGNED BY A LICENSED SE IN THE STATE OF IL TO DEVELOP 100% OF THE INDICATED 2. INDICATED FORCES ARE FACTORED LOADS

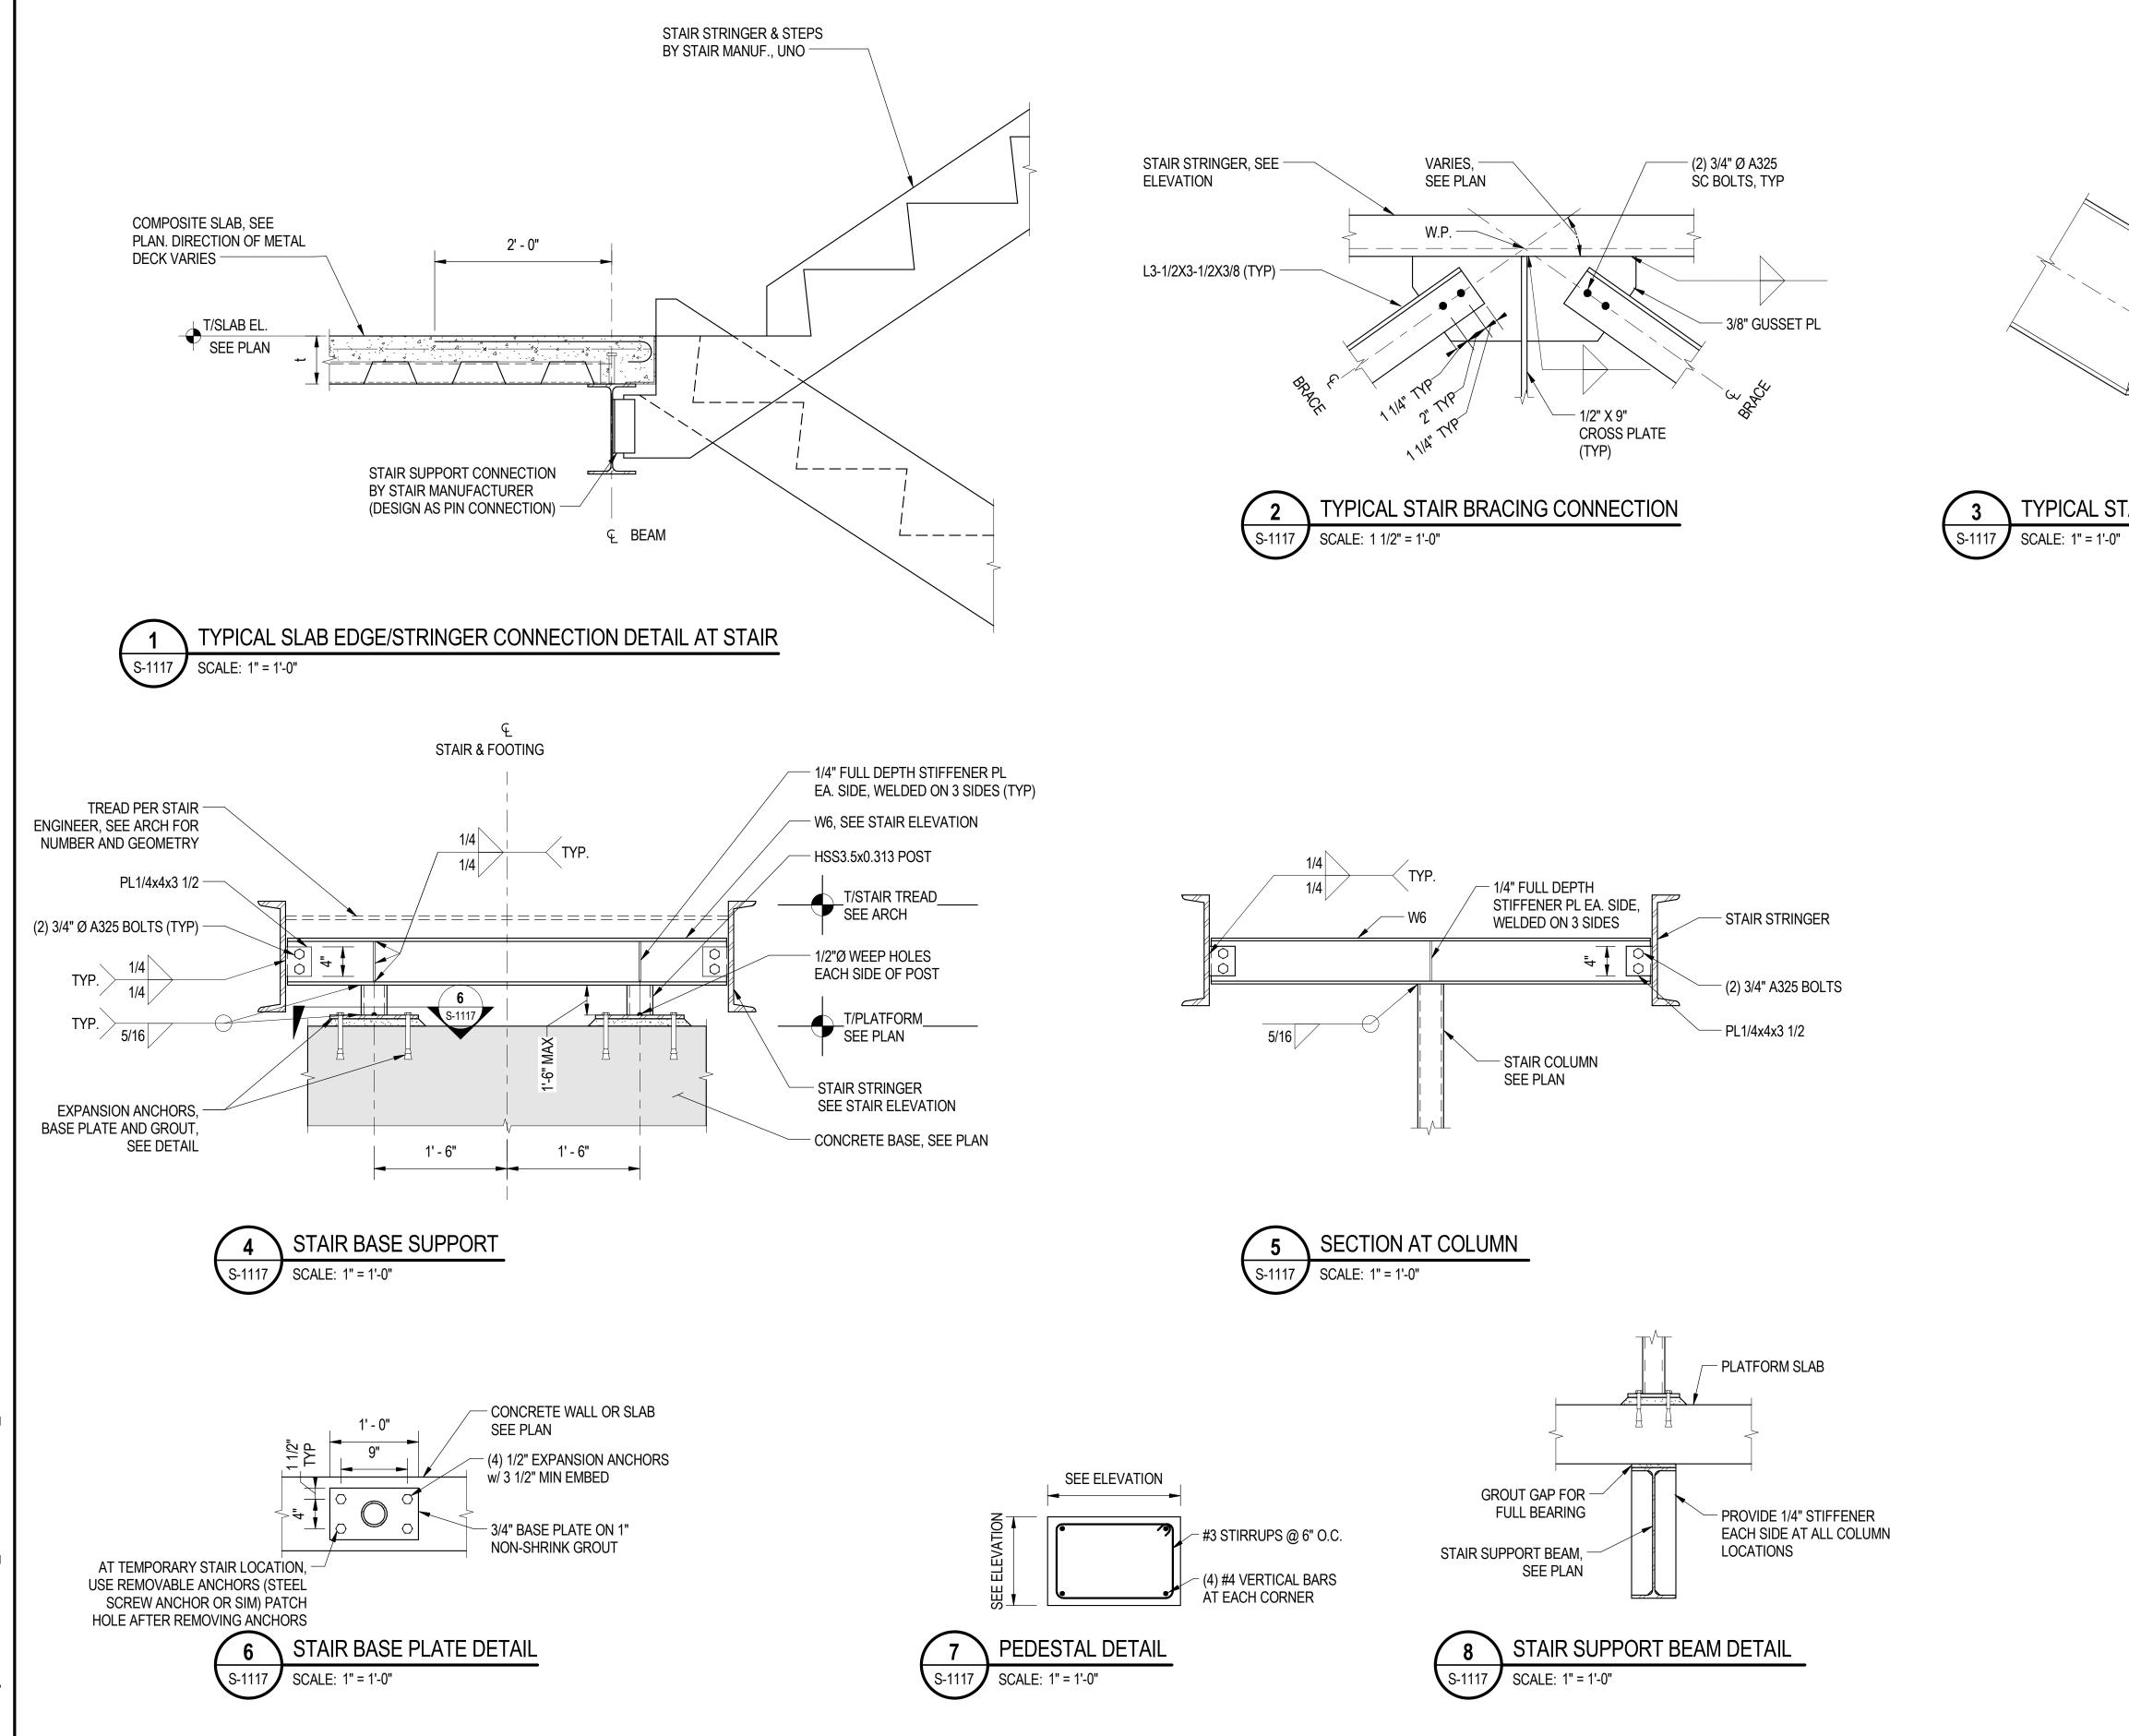

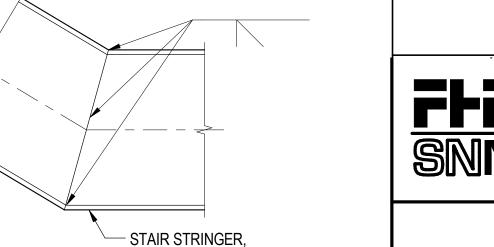

SEE STAIR ELEVATION

3 TYPICAL STAIR STRINGER DOG LEG
S-1117 SCALE: 1" = 1'-0"





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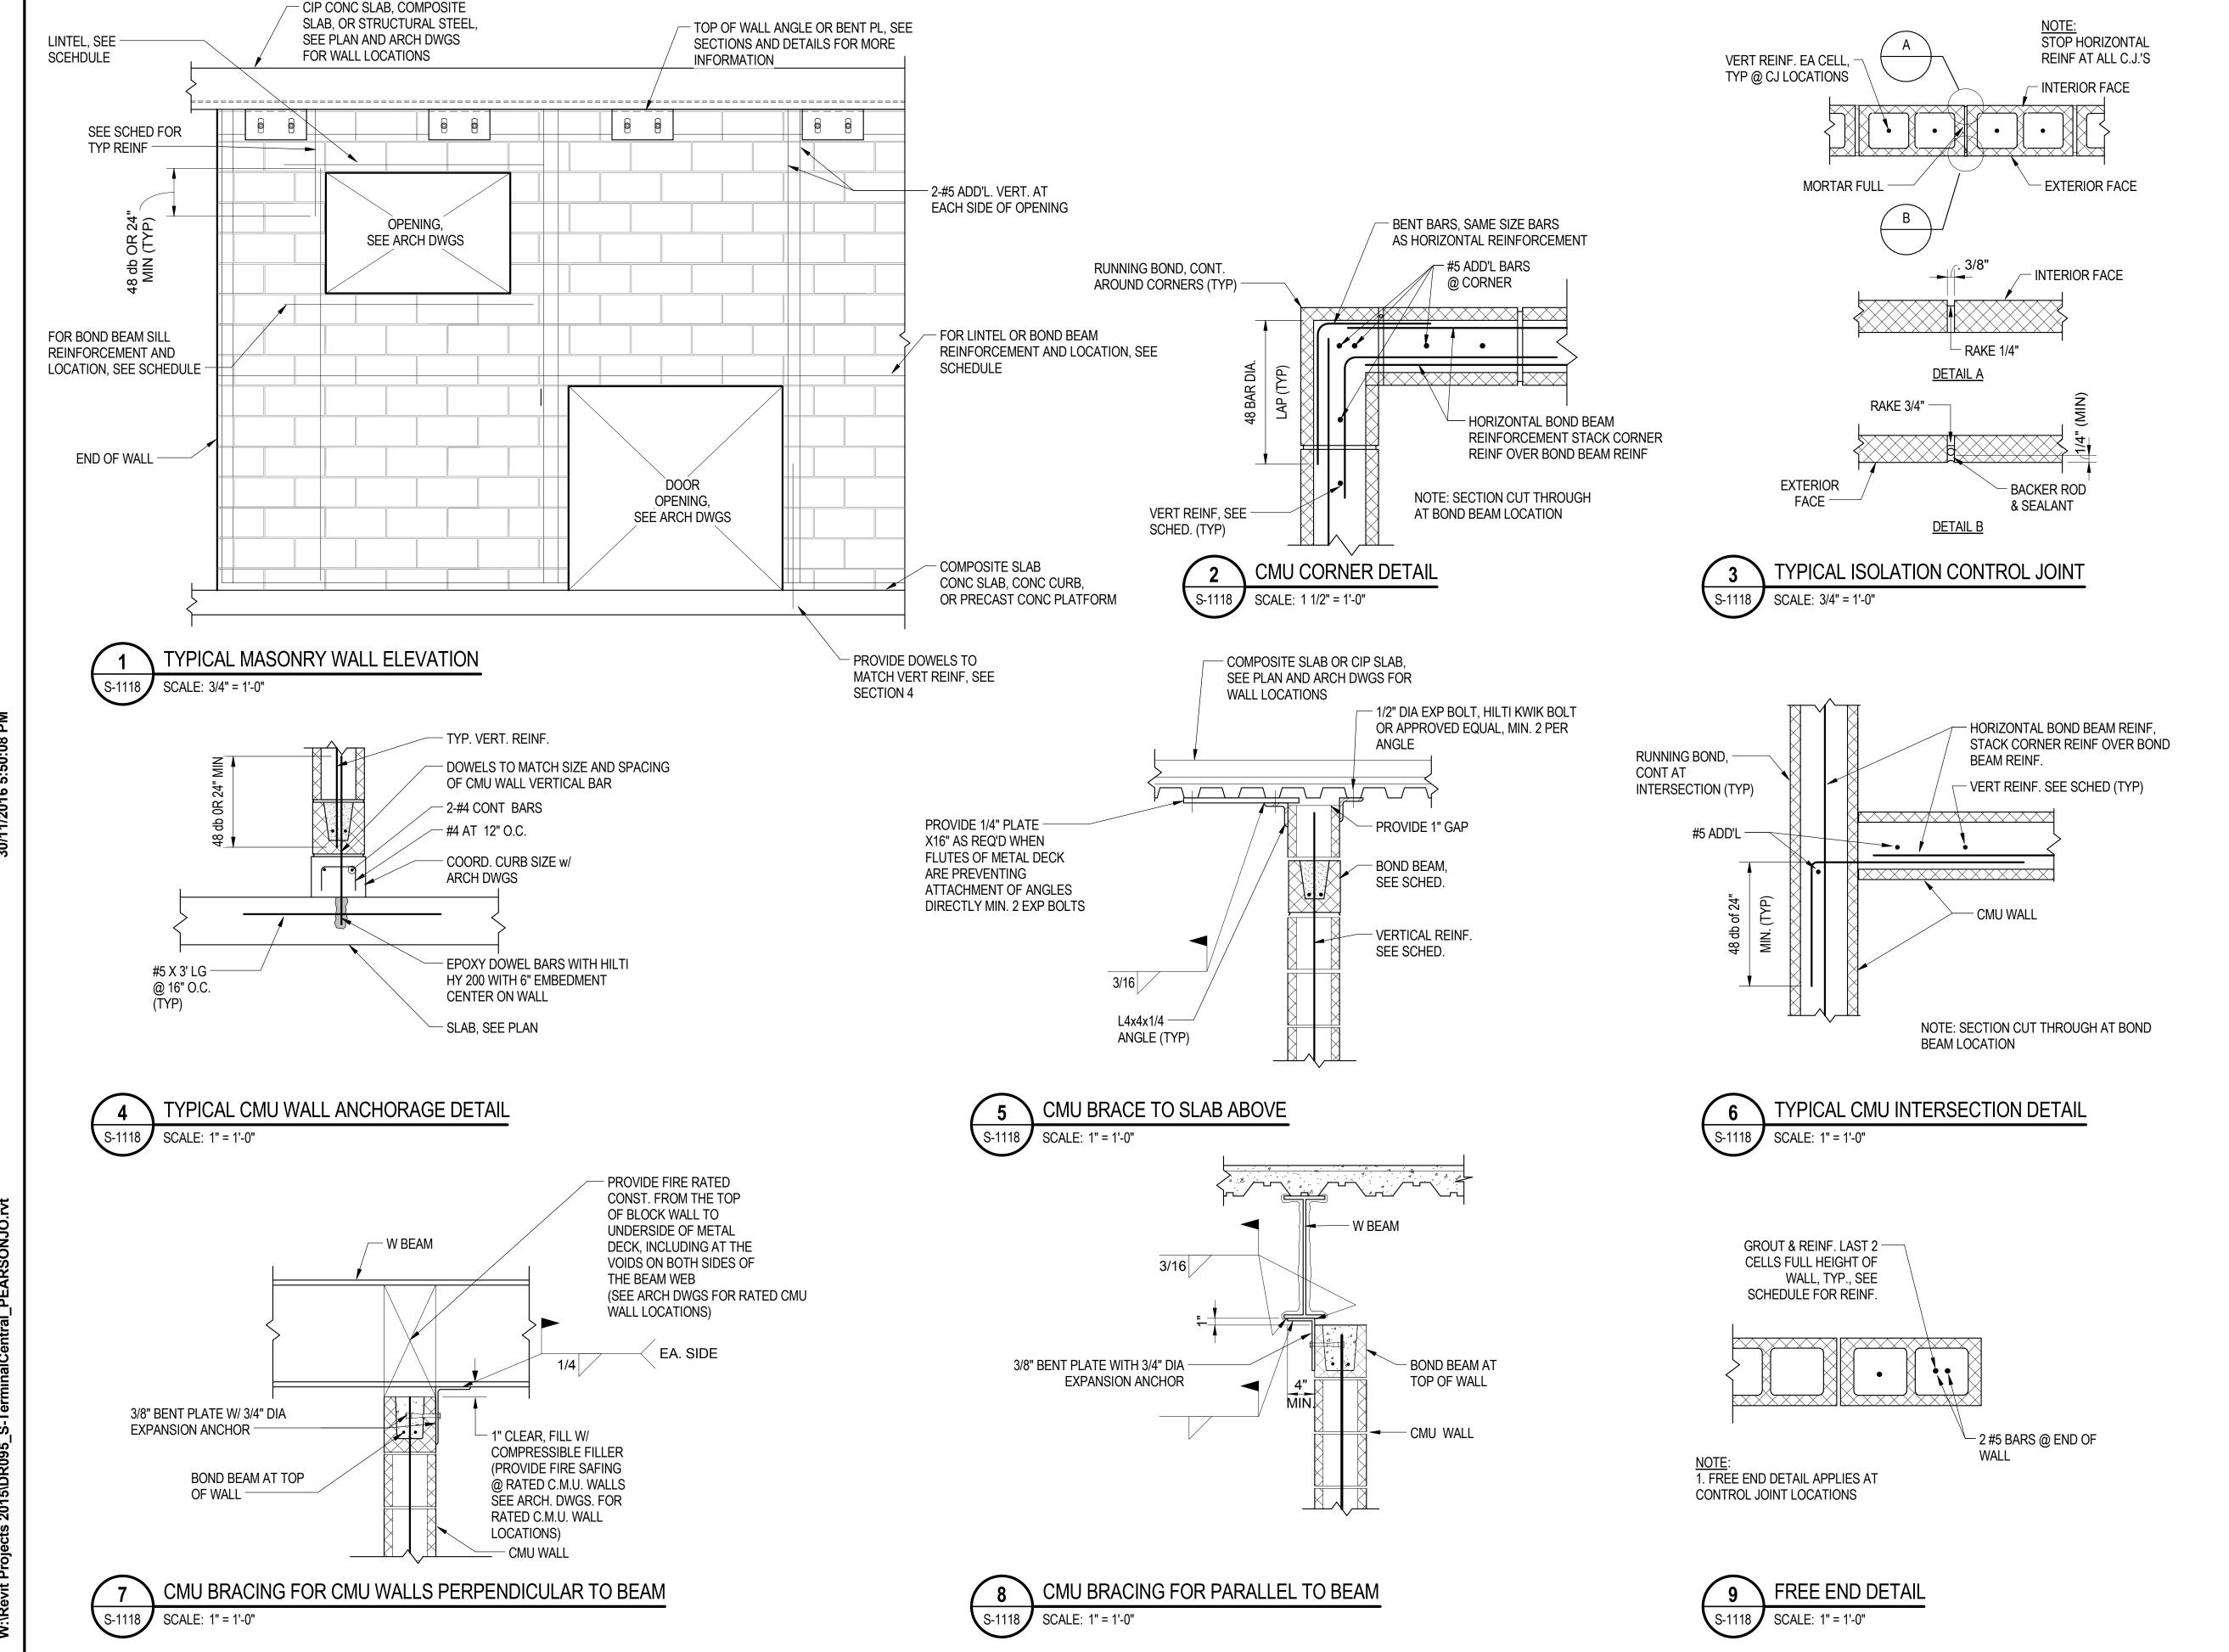
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# 95th Terminal Improvement 15 West 95th Street (South Terminal)

15 West 95th Street (South Terminal) Chicago, IL 60628

ARGE	J. JAKALSKI
OVED BY	J. JAKALSKI
KED BY	R.S. NAIR
NED BY	G. FORKAN
/N BY	J. PEARSON
ECT NO.	2012-0021.02
NAME	DR095_S-Terminal
	_
	+
	_
2/9/17	ISSUED FOR CONSTRUCTION
DATE	DESCRIPTION
ATION ID	ENTIFIER: <b>DR095</b>
	KED BY SNED BY /N BY ECT NO. NAME  2/9/17 DATE

**TYPICAL MISC STEEL DETAILS** 





### **SENSITIVE SECURITY INFORMATION**

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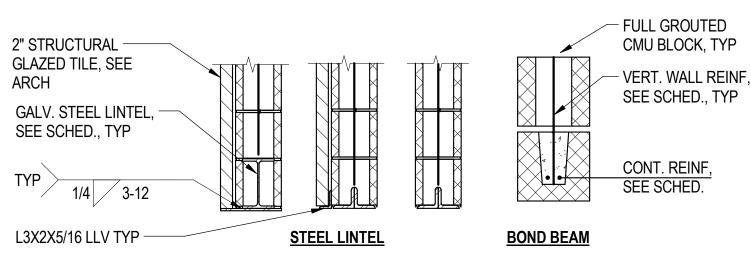
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# 95th Terminal Improvement


15 West 95th Street (South Terminal) Chicago, IL 60628


IN CH	ARGE	J. JAKALSKI
APPR	OVED BY	J. JAKALSKI
CHEC	KED BY	R.S. NAIR
DESIC	SNED BY	G. FORKAN
DRAWN BY		C. BOVE
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FILE N	NAME	DR095_S-Terminal
		_
	2/9/17	ISSUED FOR CONSTRUCTIO
MARK	DATE	DESCRIPTION
		ENTIFIER: <b>DR095</b>

**TYPICAL DETAILS - CMU - 1** 




NOTE: LINTELS SHALL BEAR A MIN. OF 4" INTO CMU BLOCK AT EACH SIDE OF OPENING.

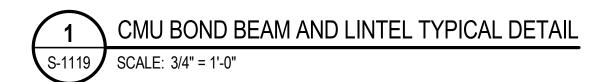

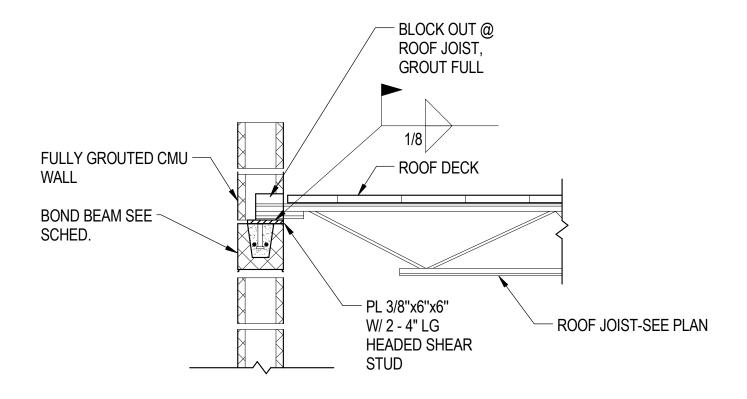



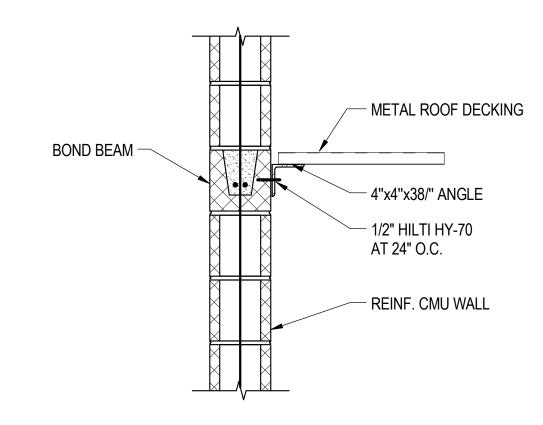



TYPICAL EXTERIOR MASONRY WALL SCHEDULE		
THICKNESS HEIGHT	REINFORCEMENT	8" CMU
UP	VERTICAL	#5 @ 32"
TO 20'-0"	HORIZONTAL	9 GAUGE JOINT REINF @ 16" O.C., LADDER TYPE

TYPICA	AL INTERIOR N	MASONRY WALLS	CHEDULE
THICKNESS HEIGHT	REINFORCEMENT	6" CMU	8" CMU
UP	VERTICAL	#4 @ 48"	#4 @ 48"
TO 20'-0"	HORIZONTAL	9 GAUGE JOINT REINF @ 16" O.C., LADDER TYPE	9 GAUGE JOINT REINF @ 16" O.C., LADDER TYPE

6" CMU WALL LINTEL SCHEDULE		
MAXIMUM MASONRY OPENING	LINTEL	
UP TO 4'-0"	TYP BOND BEAM OR 2- L3 1/2 x2 1/2 x5/16	
4'-0" TO 8'-0"	2 - L5x3x5/16 LLV	
8'-0" TO 12'-0"	W8x21 w/ 1/4" PL	

8" CMU WALL LINTEL SCHEDULE		
MAXIMUM MASONRY OPENING	LINTEL	
UP TO 4'-0"	TYP BOND BEAM OR 2- L3 1/2x3 1/2 x5/16	
4'-0" TO 8'-0"	2 - L5x3 1/2x5/16 LLV	
8'-0" TO 12'-0"	W8x21 w/ 1/4" PL	

TYPICAL BOND	BEAM SCHEDULE
8"	6"
SINGLE BOND BEAM 2-#5 W/ 1 1/2" BOTTOM COVER	SINGLE BOND BEAM 1-#6 W/ 1 1/2" BOTTOM COVER

NOTE:

1. BOND BEAMS SHALL BE LOCATED AT TOP AND BOTTOM OF WALLS, AT TOP AND BOTTOM OF OPENINGS AND AT 8' O.C.



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95th Terminal Improvement 15 West 95th Street (South Terminal) Chicago, IL 60628

IN CHARGE

APPROVED BY

J. JAKALSKI

CHECKED BY

R.S. NAIR

DESIGNED BY

G. FORKAN

DRAWN BY

C. BOVE

PROJECT NO. 2012-0021.02

FILE NAME

DR095\_S-Terminal

LOCATION IDENTIFIER:

MARK DATE DESCRIPTION

TYPICAL DETAILS - CMU - 2

2/9/17 ISSUED FOR CONSTRUCTION

**DR095** 

*23+35.68* 

Northeast End E. Appr. Pav't.

### SOUTH CONSTRUCTION JOINT

+77.40

*16.68* 

Location	Station	Offset	Theoretical Grade Elevations
Southwest End W. Appr. Pav't.	20+71.38	- 56.04	16.12
A5	20+81.38	- 56.04	16.42
Construction Joint	20+91.38	- 56.04	16.71
A6	21+01.38	- 56.04	17.00
Southeast End W. Appr. Pav't.	21+06.97	- 56.04	17.17
Southwest End E. Appr. Pav't.	23+00.10	- 56.04	17.17
A7	23+05.68	- 56.04	17.00
Construction Joint	23+15.68	- 56.04	16.69
A8	23+25.68	- 56.04	16.38
Southeast End E. Appr. Pav't.	23+35.68	- 56.04	16.08

### NORTH CONSTRUCTION JOINT

Location	Station	Offset	Theoretical Grade Elevations
Northwest End W. Appr. Pav't.	20+71.38	+45.04	16.25
A1	20+81.38	+45.04	16.50
Construction Joint	20+91.38	+45.04	16.75
A2	21+01.38	+45.04	17.00
Northeast End W. Appr. Pav't.	21+06.97	+45.04	17.14
Northwest End E. Appr. Pav't.	23+00.10	+45.04	17.14
A3	23+05.68	+45.04	17.00
Construction Joint	23+15.68	+45.04	16.75
A4	23+25.68	+45.04	16.50
Northeast End E. Appr. Pav't.	23+35.68	+45.04	16.25

### SOUTH EDGE OF APPROACH

Location	Station	Offset	Theoretical Grade Elevations
Southwest End W. Appr. Pav't.	20+71.38	- 102.69	16.53
A5	20+81.38	- 102.69	16.67
Construction Joint	20+91.38	- 102.69	16.82
South F.F. W. Appr. Sidewalk	20+92.68	- 102.69	17.51
A6	21+01.38	- 102.69	17.59
Southeast End W. Appr. Pav't.	21+04.11	- 102.69	17.61
Southwest End E. Appr. Pav't.	23+03.06	- 105 <b>.</b> 89	17.94
A7	23+05.68	- 105.89	17.90
South F.F. E. Appr. Sidewalk	23+14.90	- 105.89	17.76
Construction Joint	23+15.68	- 105.89	17.07
A8	23+25.68	- 105.89	16.82
Southeast End E. Appr. Pav't.	23+35 <b>.</b> 68	<i>- 105.89</i>	16.57

#### NOTE:

1. All offsets are to centerline.





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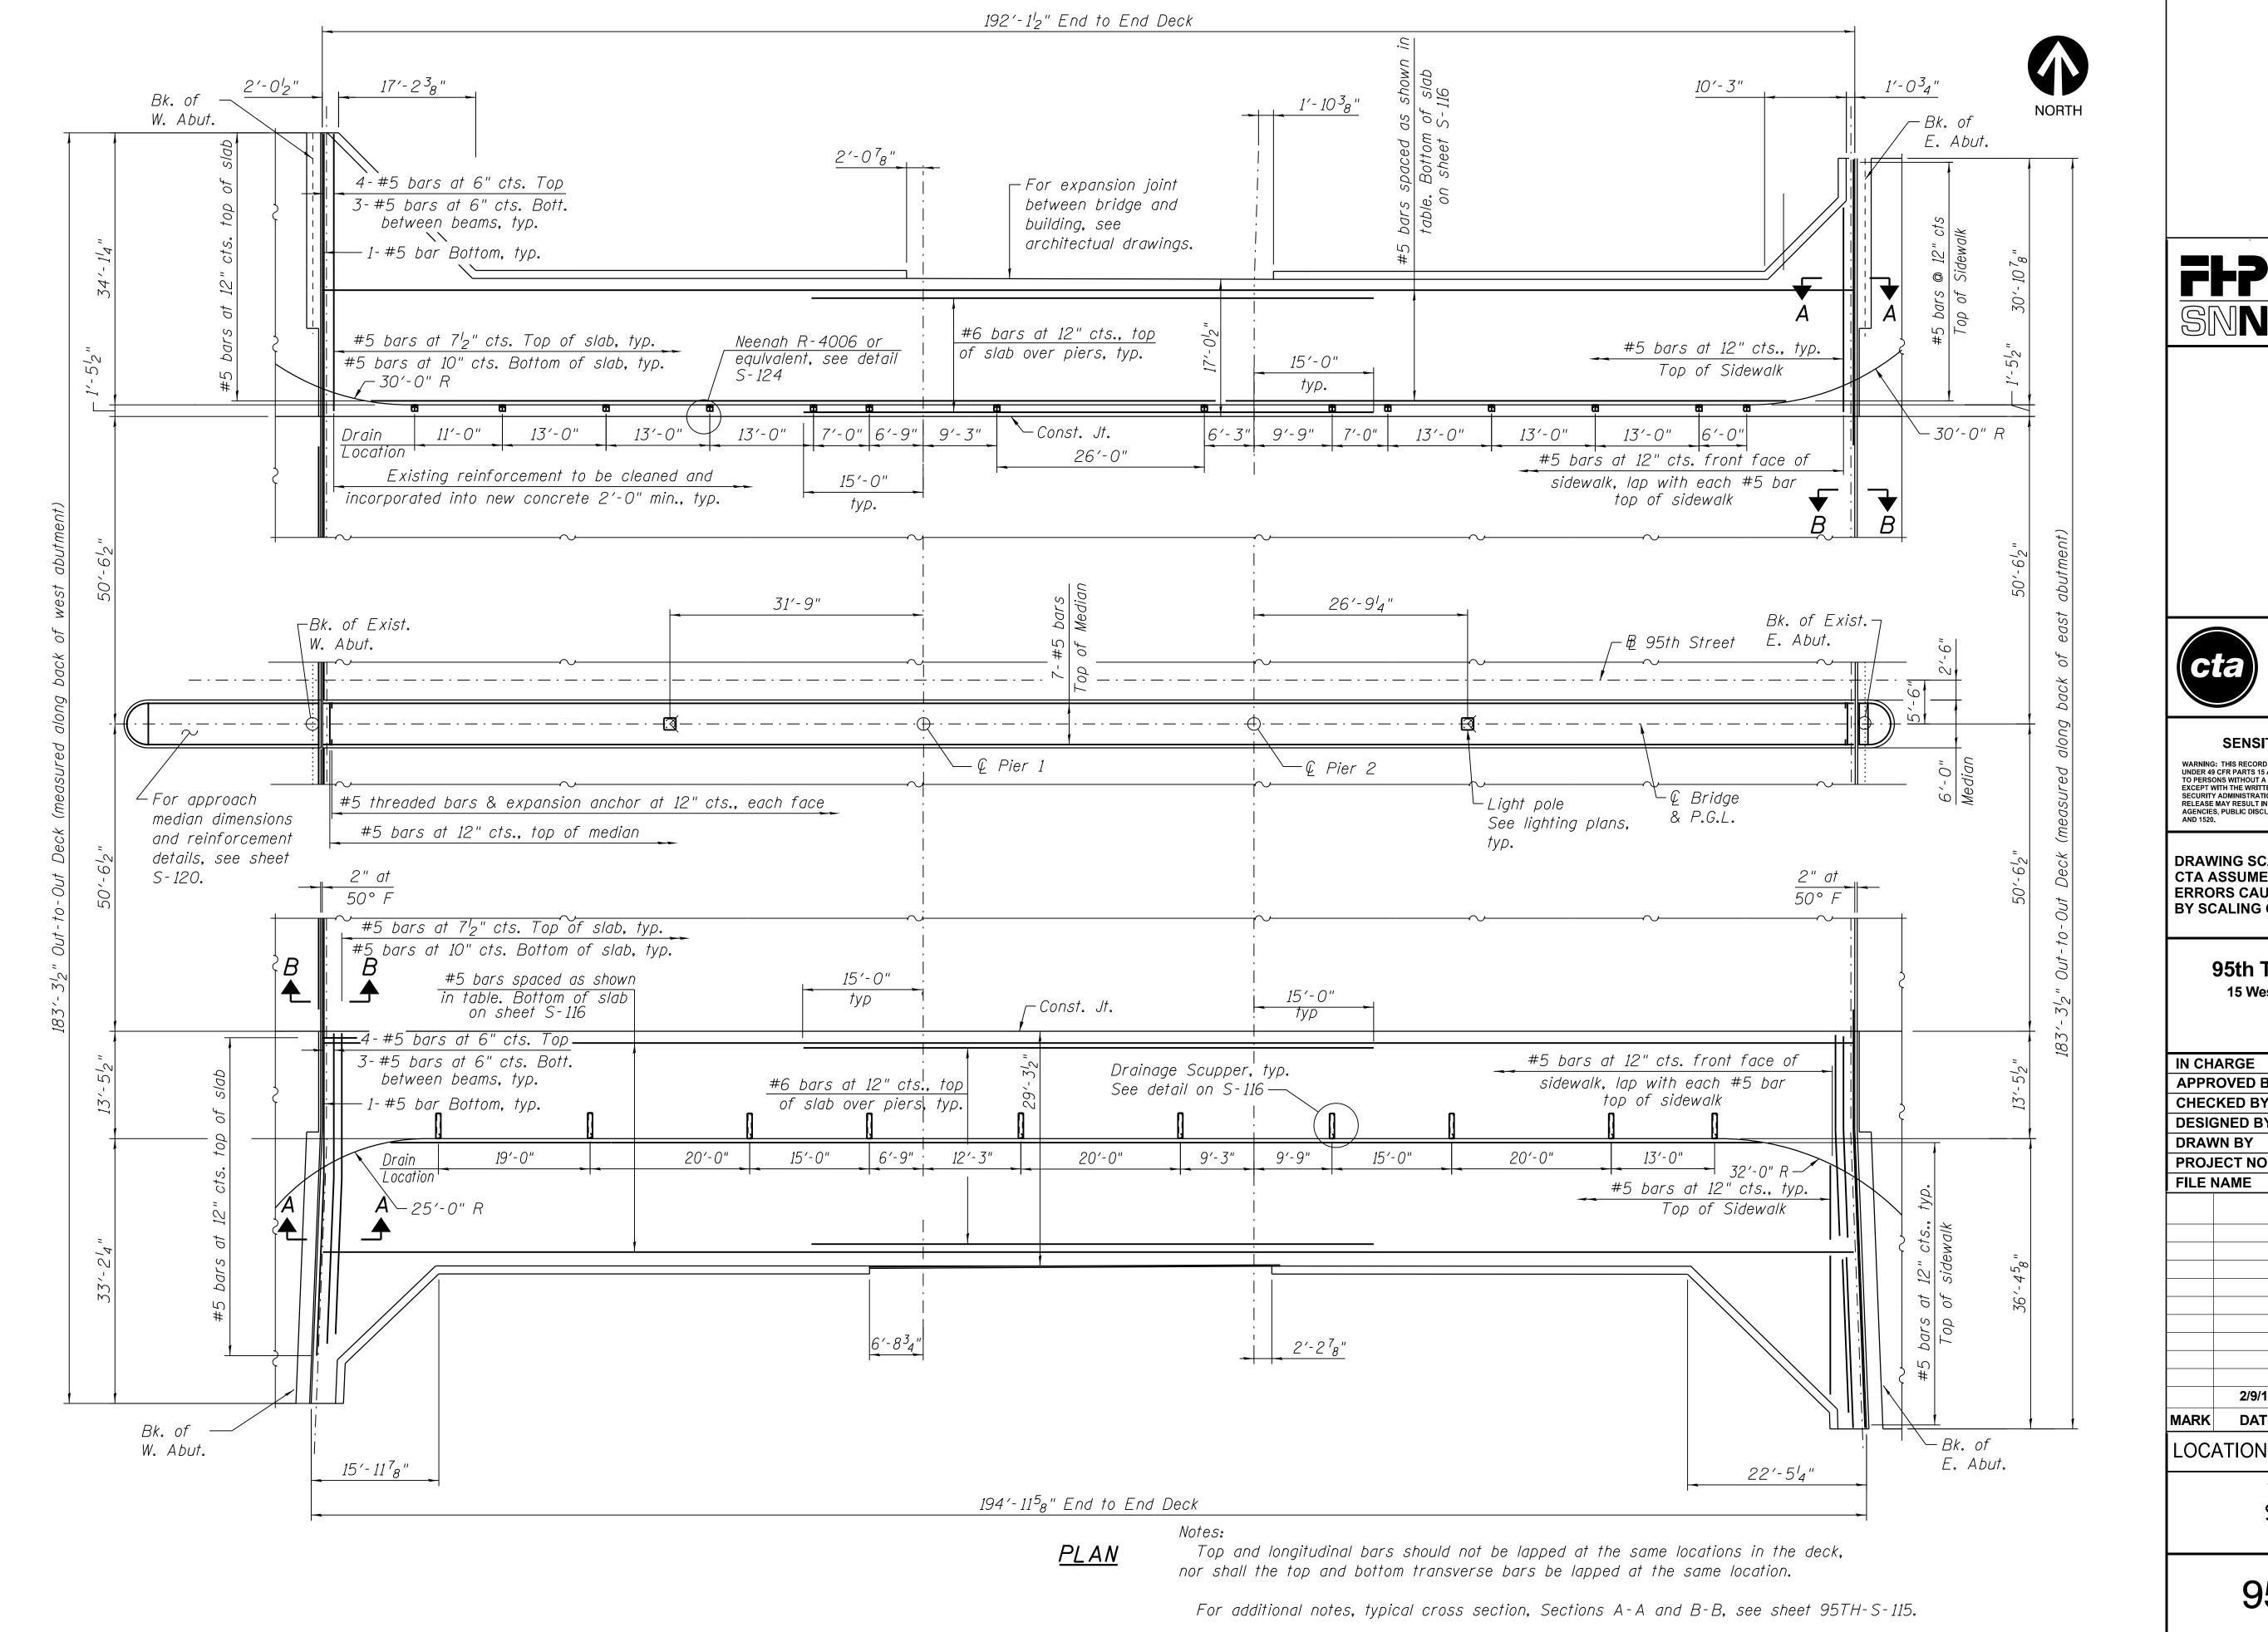
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# 95th Terminal Improvement 15 West 95th Street (South Terminal) Chicago, IL 60628

MARK	DATE	DESCRIPTION
	2/9/17	ISSUED FOR CONSTRUCTION
FILE N	NAME	File Name
PROJ	ECT NO.	2012-0021
DRAV	VN BY	T.SLEDGE
DESIG	SNED BY	L.SOMMER
CHEC	KED BY	P.MAID
APPR	OVED BY	D.ZROKA
IN CH	ARGE	S. KADERBEK

LOCATION IDENTIFIER: DR095

95TH ST. BRIDGE
TOP OF APPROACH SLAB ELEVATIONS
(SHEET 2 OF 2)
SN 016-0437





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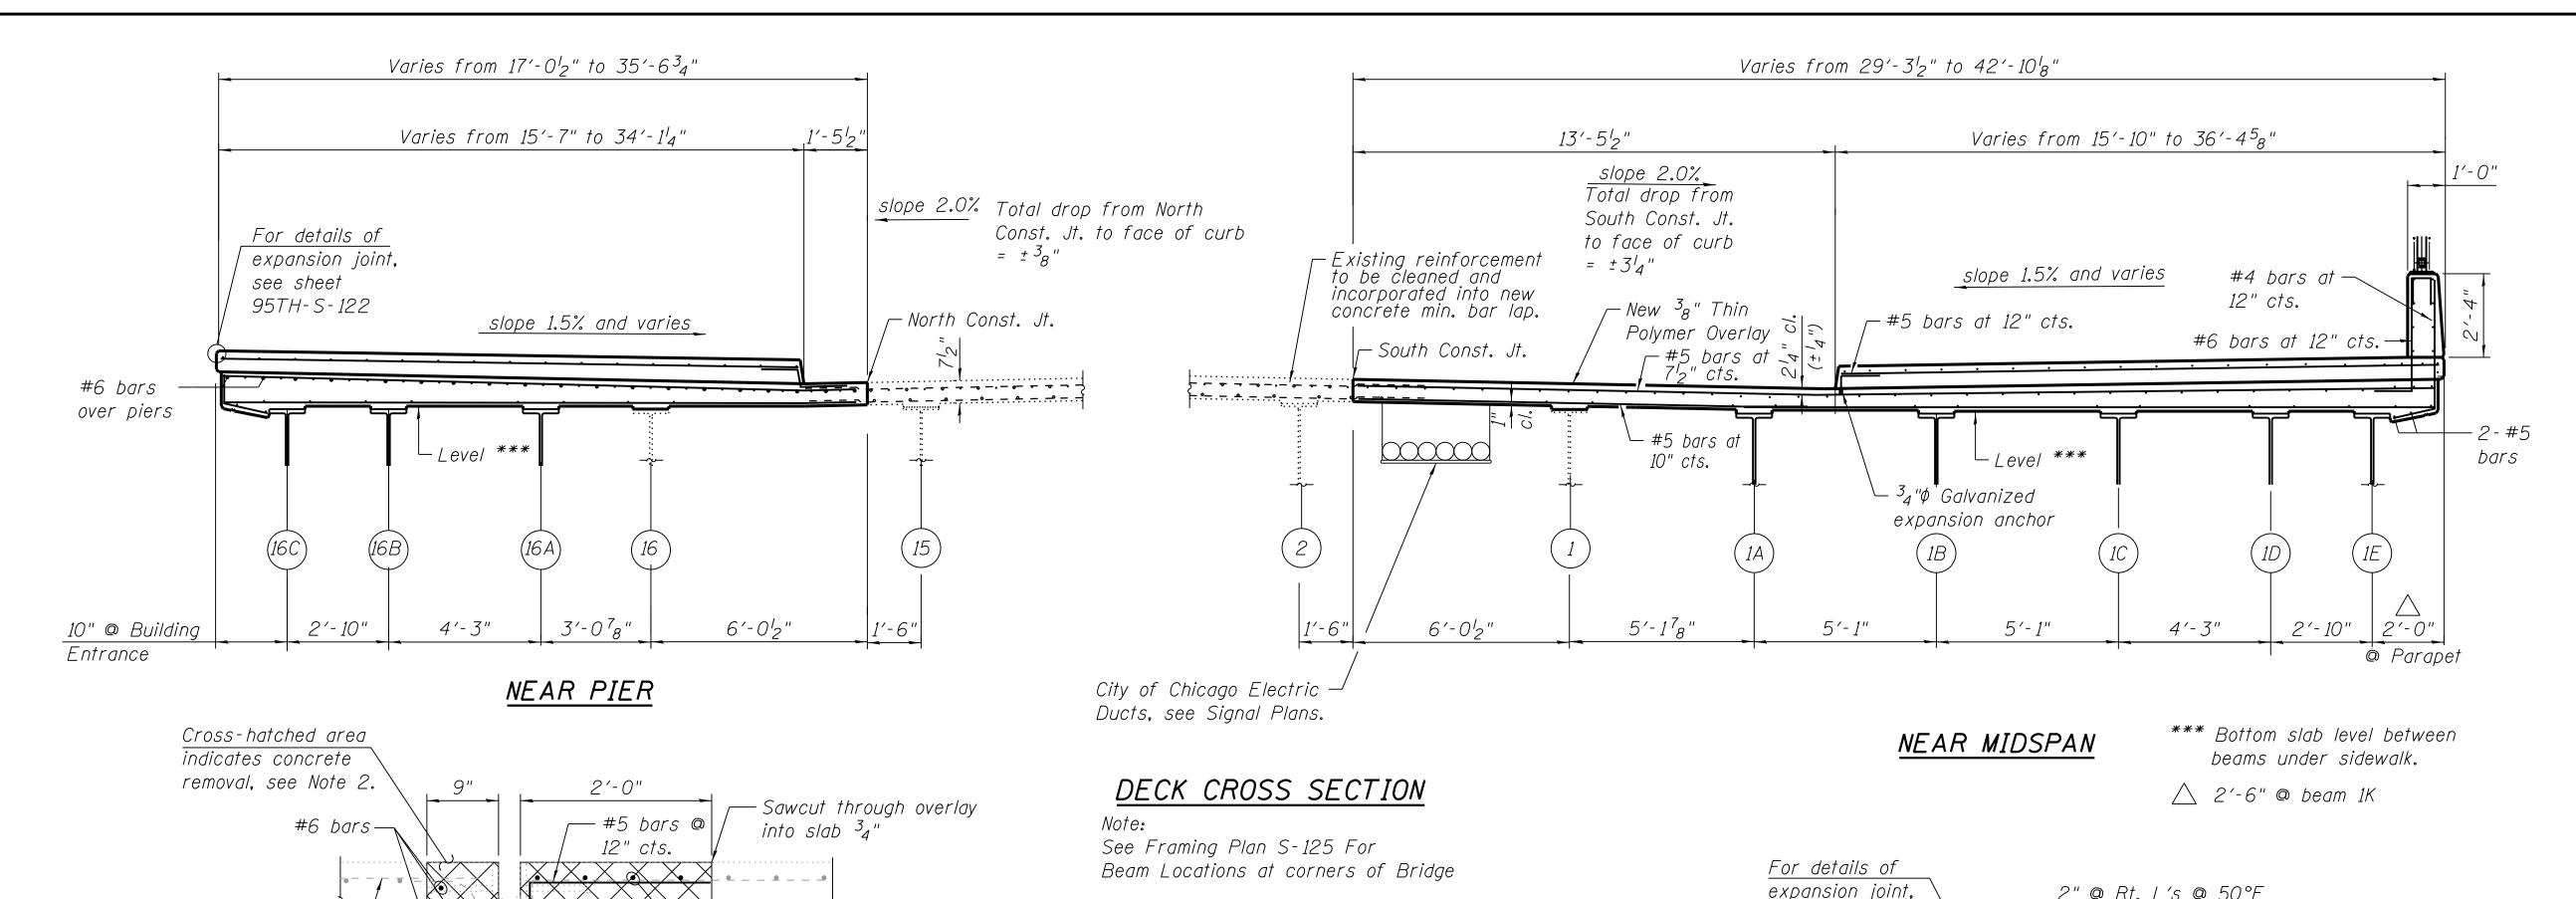
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## 95th Terminal Improvement

15 West 95th Street (South Terminal) Chicago, IL 60628

IN CH	ARGE	S. KADERBEK
APPROVED BY		D.ZROKA
CHEC	KED BY	P.MAID
DESIG	NED BY	L.SOMMER
DRAW	N BY	T.SLEDGE
PROJI	ECT NO.	2012-0021
FILE N	IAME	File Name
	2/9/17	ISSUED FOR CONSTRUCTION
MARK	DATE	DESCRIPTION
LOC	ATION IDI	ENTIFIER: <b>DR095</b>

95TH ST. BRIDGE SUPERSTRUCTURE SN 016-0437



MINIMUM BAR LAPS

LAPS

2'-7"

3'-3"

3'-10"

BARS

#4

#5

#6

### SECTION B-B AT EXISTING ABUTMENT

Existing reinforcement to be cleaned and

Bk. Exist. W. Abut.


incorporated into

NAME

71LE


new concrete, typ.

(Preformed Joint Seal not shown for clarity. W. Abut. shown, E. Abut. similar)

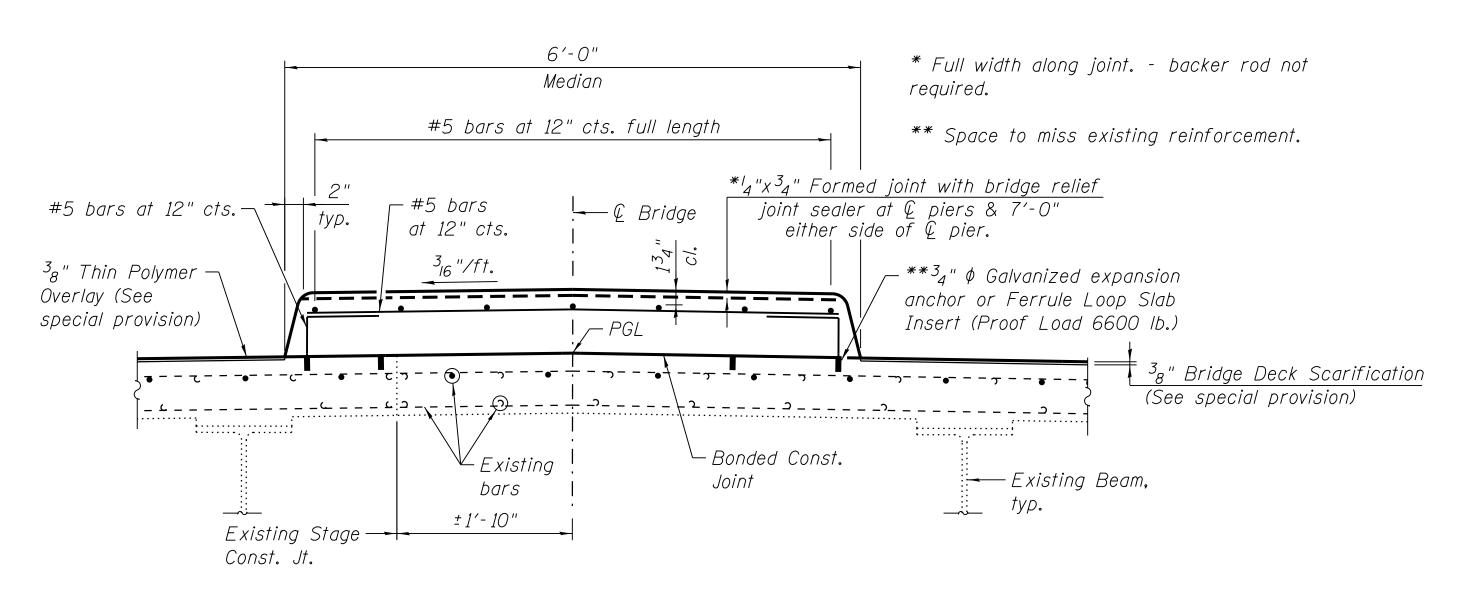

├─ @ Brg. W. Abut

SUPERIMPOSED MEDIAN - INSTALL AFTER STAGE II CONSTRUCTION

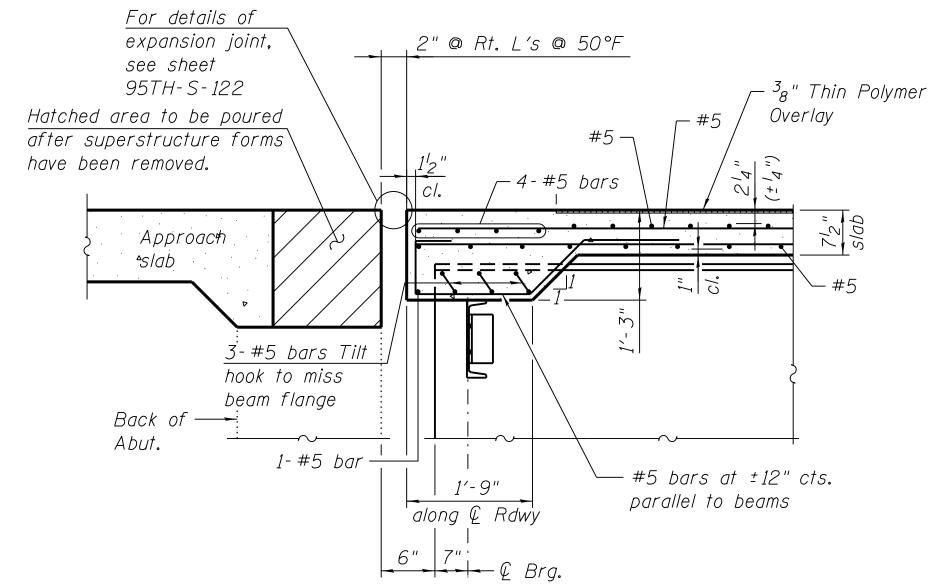

SECTION A-A

(at widened abutment)

#### Notes:

- 1. For bridge fence railing details refer to Architectural drawings, see sheets A-842 and A-844.
- 2. Existing expansion joint to be removed and replaced. For expansion joint replacement details within existing bridge deck, see sheet 95TH-S-122.



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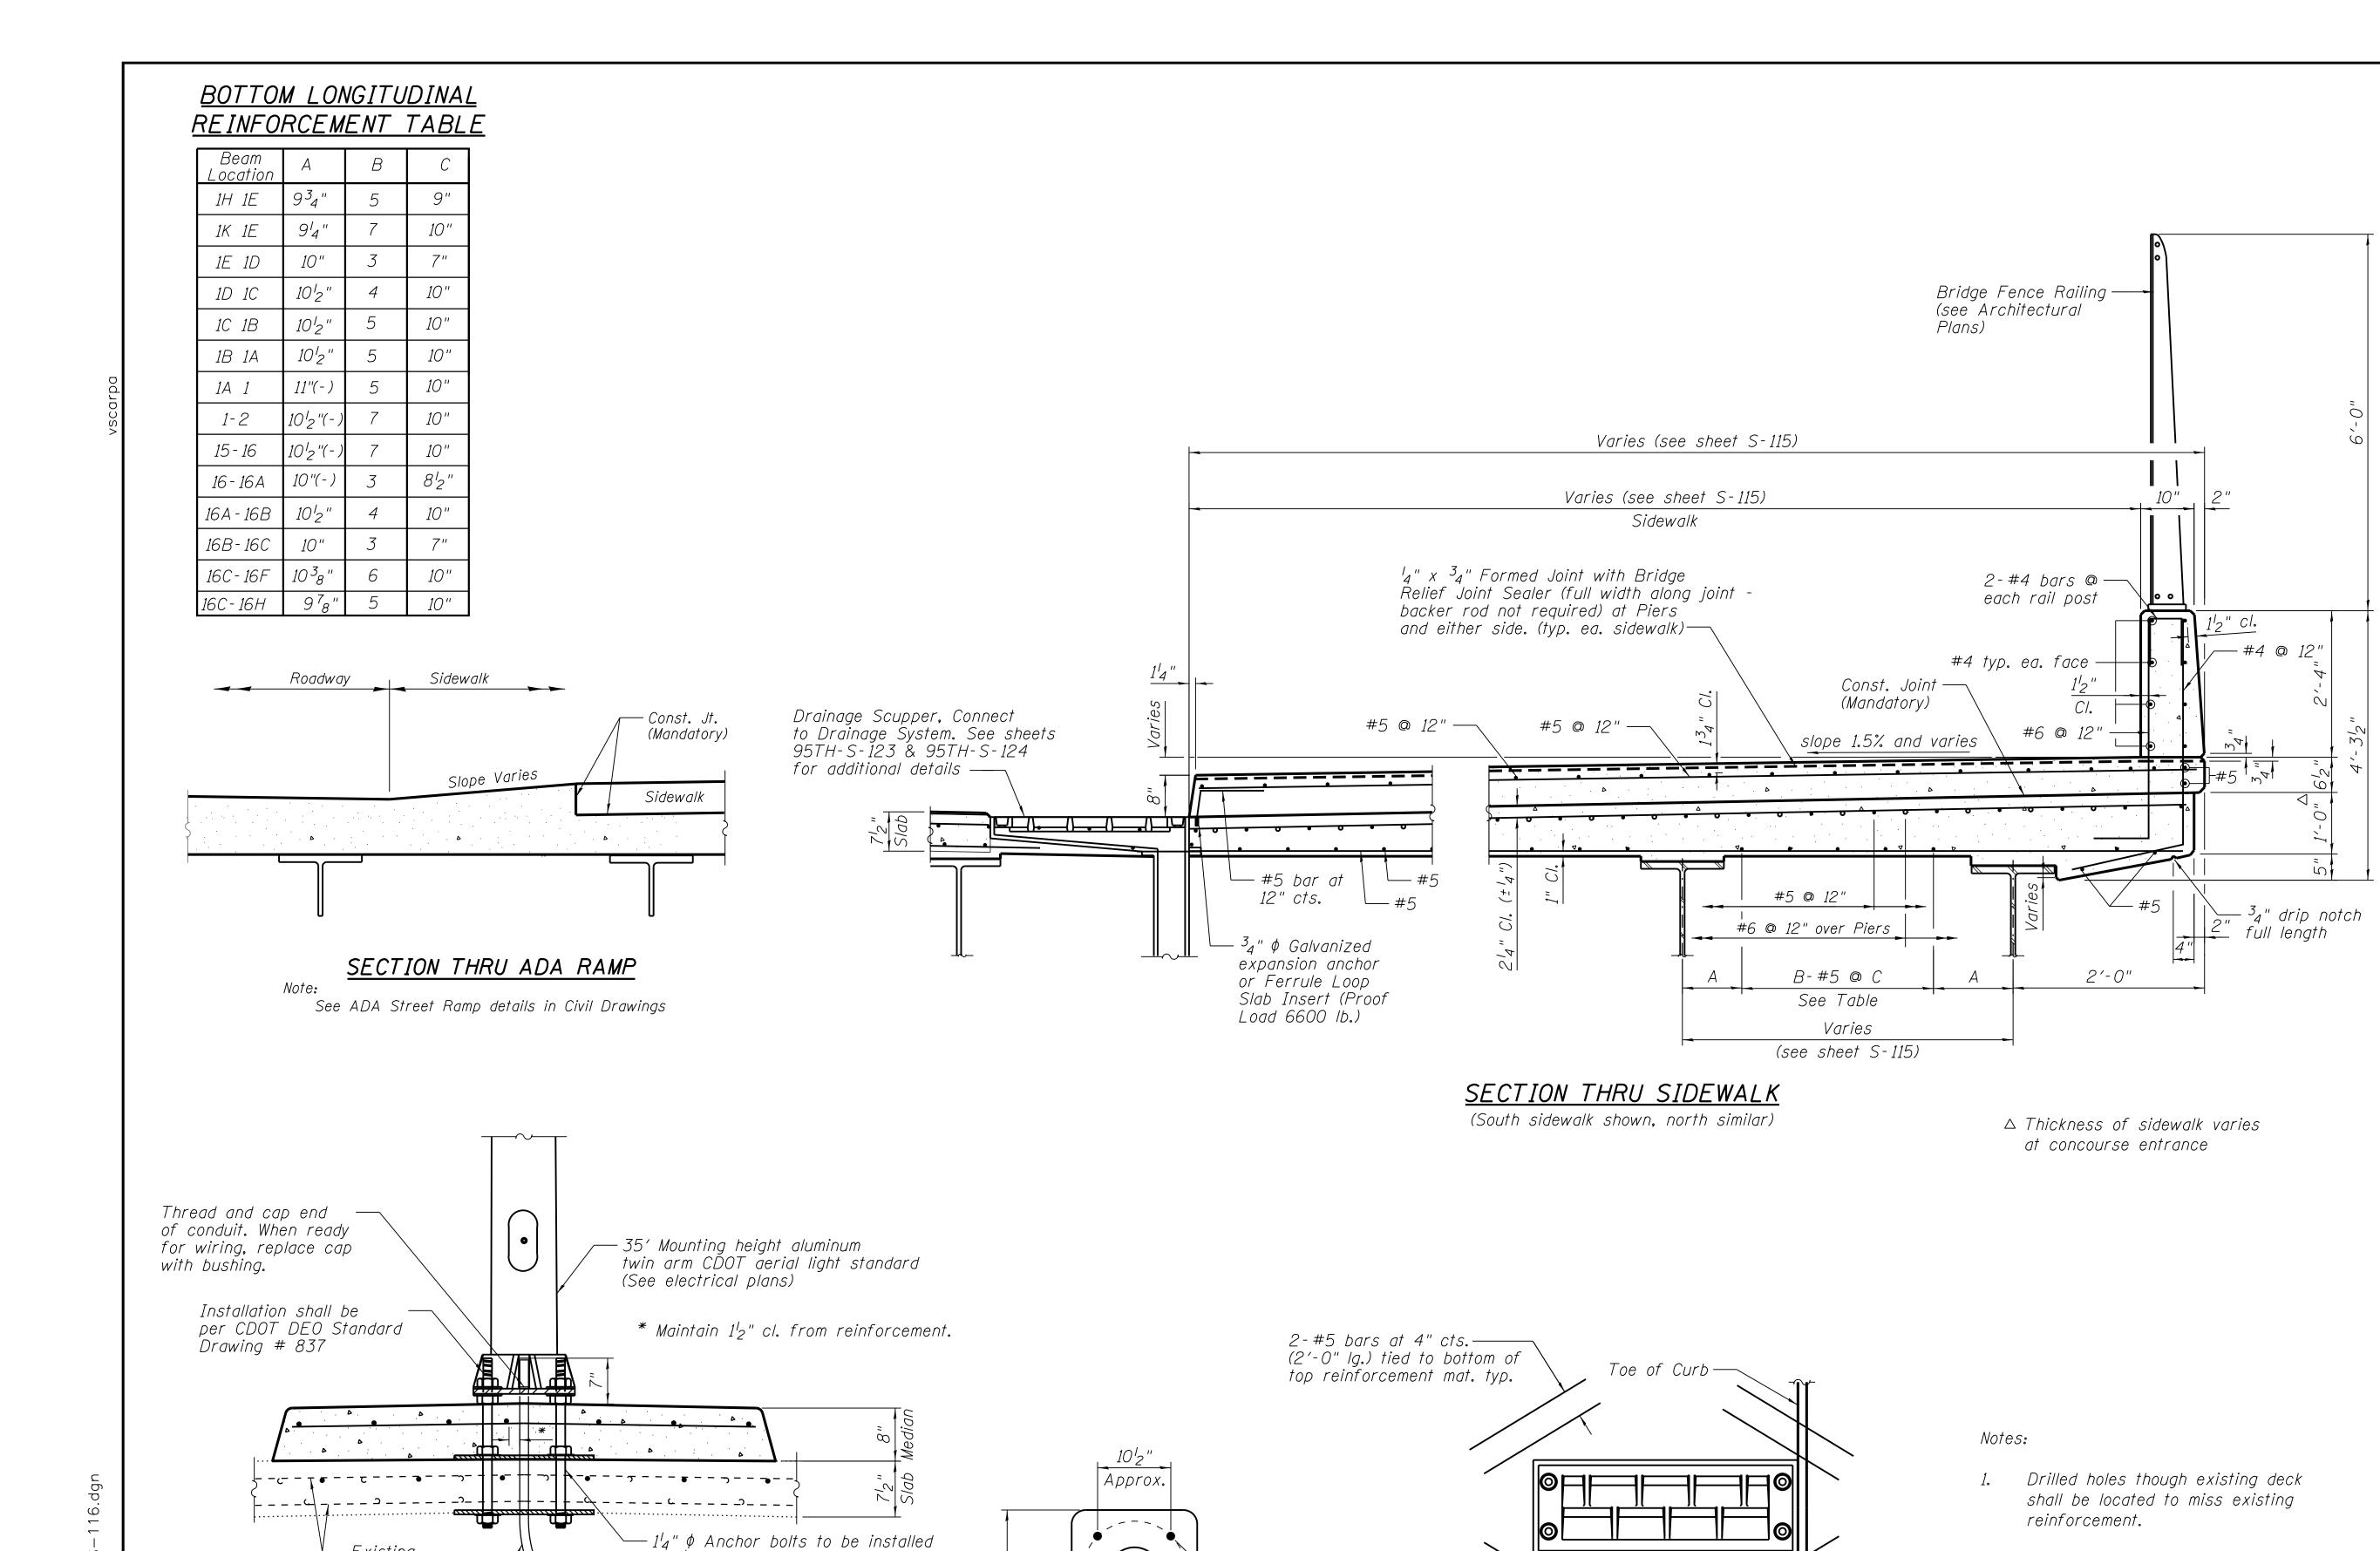
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## 95th Terminal Improvement

15 West 95th Street (South Terminal) Chicago, IL 60628

IN CH	ARGE	S. KADERBEK
APPR	OVED BY	D.ZROKA
CHEC	KED BY	P.MAID
DESIG	ENED BY	L.SOMMER
DRAV	VN BY	T.SLEDGE
PROJ	ECT NO.	2012-0021
FILE NAME		File Name
	2/9/17	ISSUED FOR CONSTRUCTION
MARK	DATE	DESCRIPTION
LOC	ATION IDE	NTIFIER: <b>DR095</b>

95TH ST. BRIDGE SUPERSTRUCTURE DETAILS (SHEET 1 OF 3) SN 016-0437



BASE PLATE DETAIL

V— Existing

 $1^{l}_{2}$ " PVC Coated Galvanized Steel conduit to be installed in  $1^{3}_{4}$ "  $\phi$  hole

through existing deck. (see Note 1)

ΗЩ

reinforcement

MEDIAN MOUNTED LIGHT POLE DETAIL

in  $1^l_2$ "  $\phi$  holes through existing deck. (see Note 1)

SIN (W) \*\*exp



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# 95th Terminal Improvement 15 West 95th Street (South Terminal) Chicago, IL 60628

IN CHARGE S. KADERBEK

APPROVED BY D. ZROKA

🗸	ARGE	S. KADERBEK
APPROVED BY		D.ZROKA
CHEC	KED BY	P.MAID
DESIG	SNED BY	L.SOMMER
DRAWN BY PROJECT NO.		T.SLEDGE
		2012-0021
FILE NAME		File Name
	2/9/17	ISSUED FOR CONSTRUCTION
		DESCRIPTION

95TH ST. BRIDGE SUPERSTRUCTURE DETAILS (SHEET 2 OF 3) SN 016-0437


2. For additional light pole details, see


Drains shall be located clear of


electrical plans.

all diaphragms.

SCUPPER DETAIL

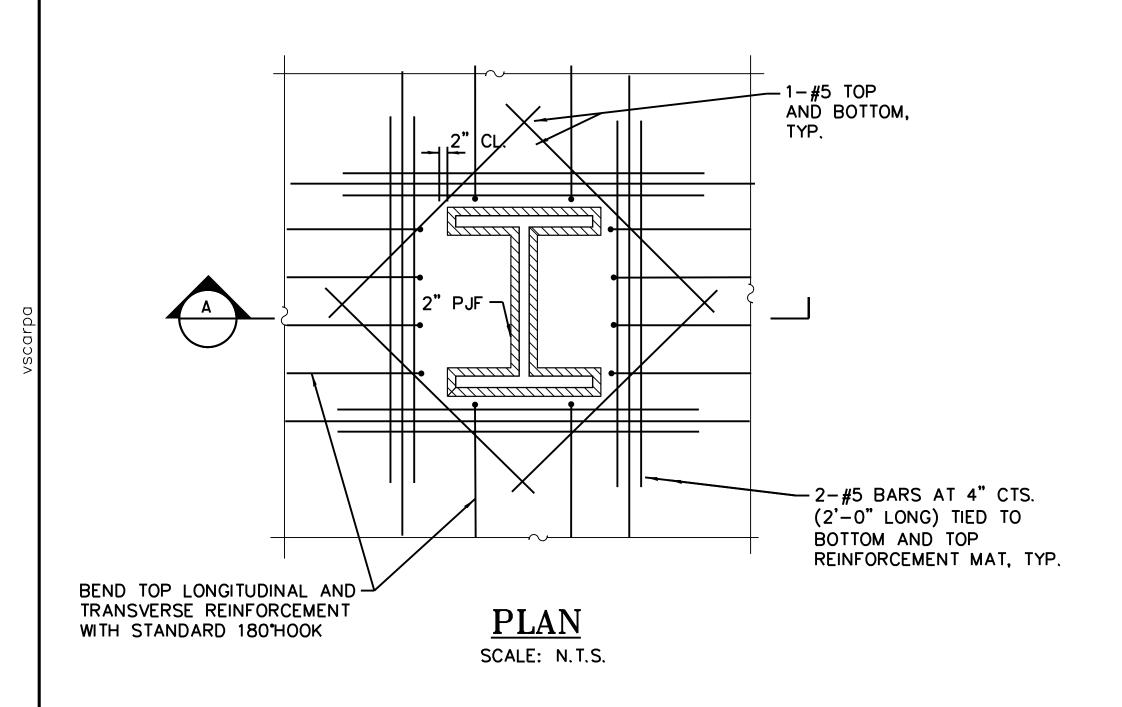

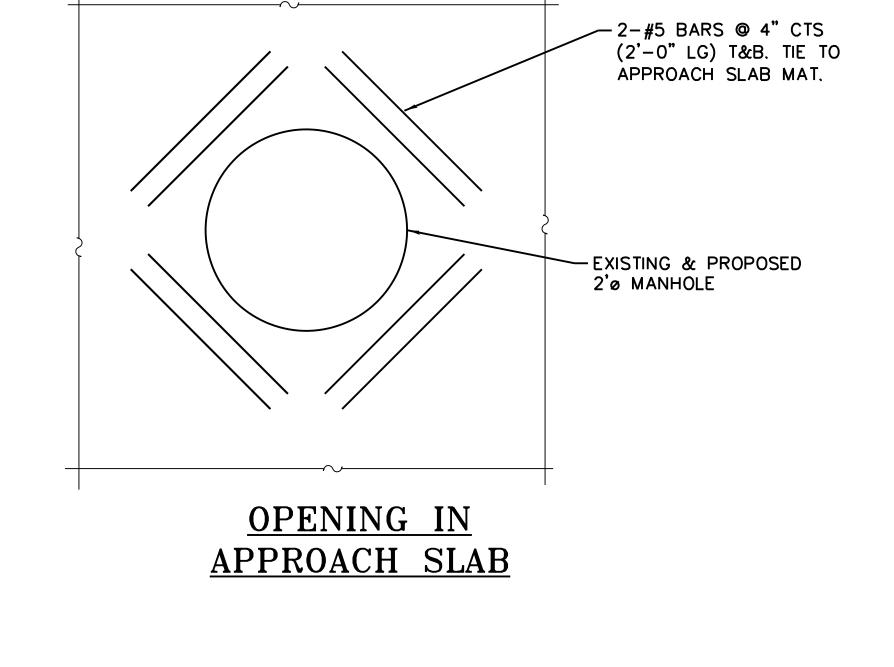

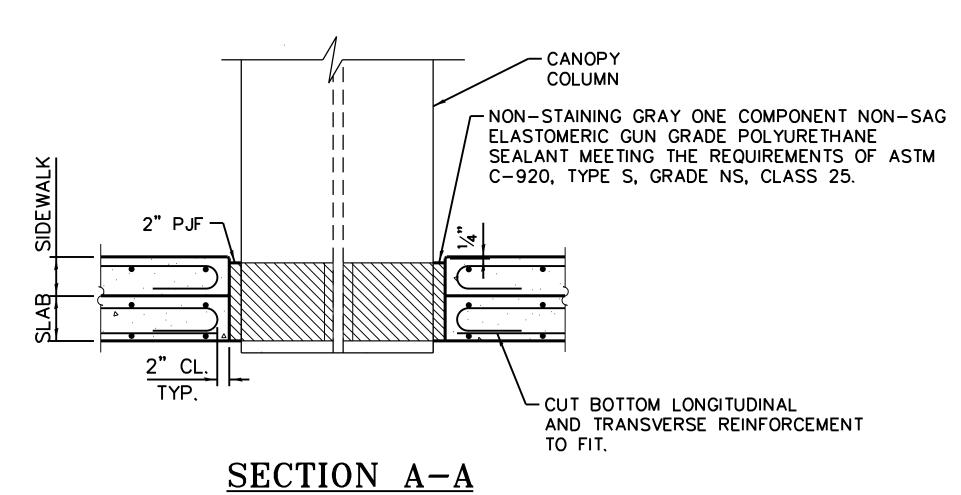

STEEL COLUMN CONNECTION NOT SHOWN FOR CLARITY.





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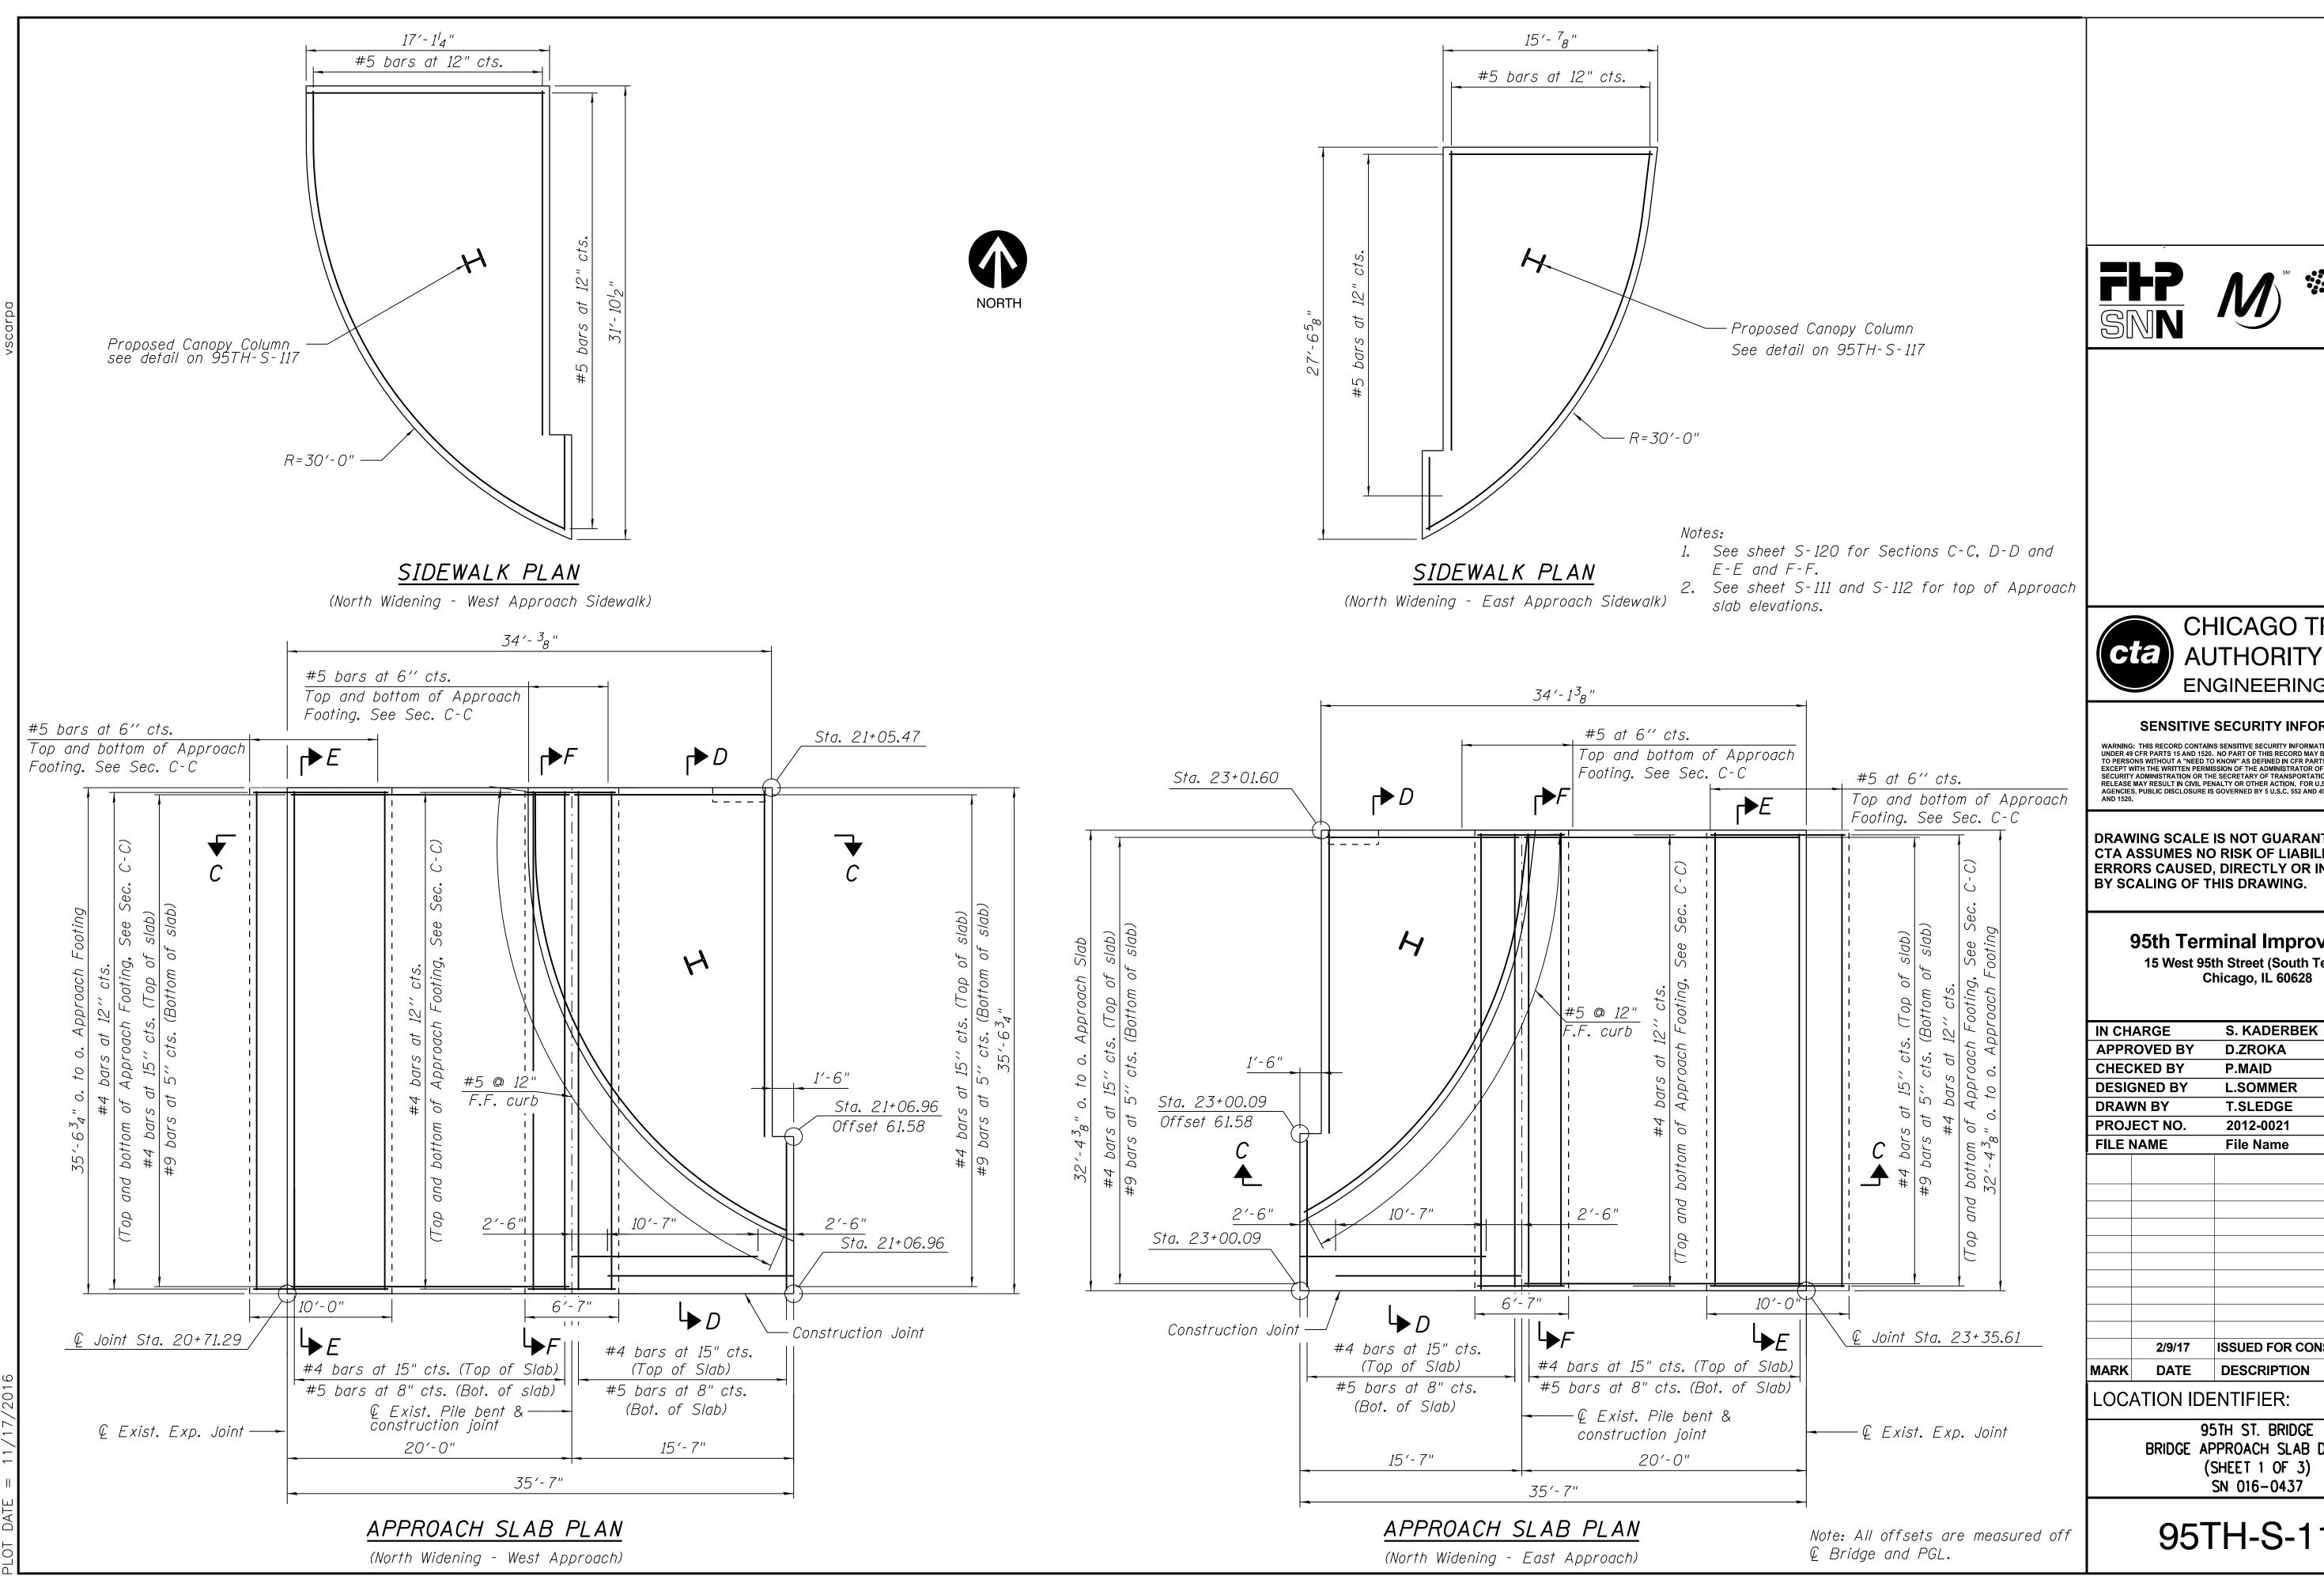
#### 95th Terminal Improvement

15 West 95th Street (South Terminal) Chicago, IL 60628

IN CH	ARGE	3. NAVERBEN			
APPROVED BY		D.ZROKA			
CHECKED BY		P.MAID			
DESIG	SNED BY	L.SOMMER			
DRAV	VN BY	T.SLEDGE			
PROJ	ECT NO.	2012-0021			
FILE I	NAME	File Name			
	2/9/17	ISSUED FOR CONSTRUCTION			
IARK	DATE	DESCRIPTION			
00	COATION IDENTIFIED. BROOF				

LOCATION IDENTIFIER: DR095

95TH ST. BRIDGE SUPERSTRUCTURE DETAILS (SHEET 3 OF 3) SN 016-0437





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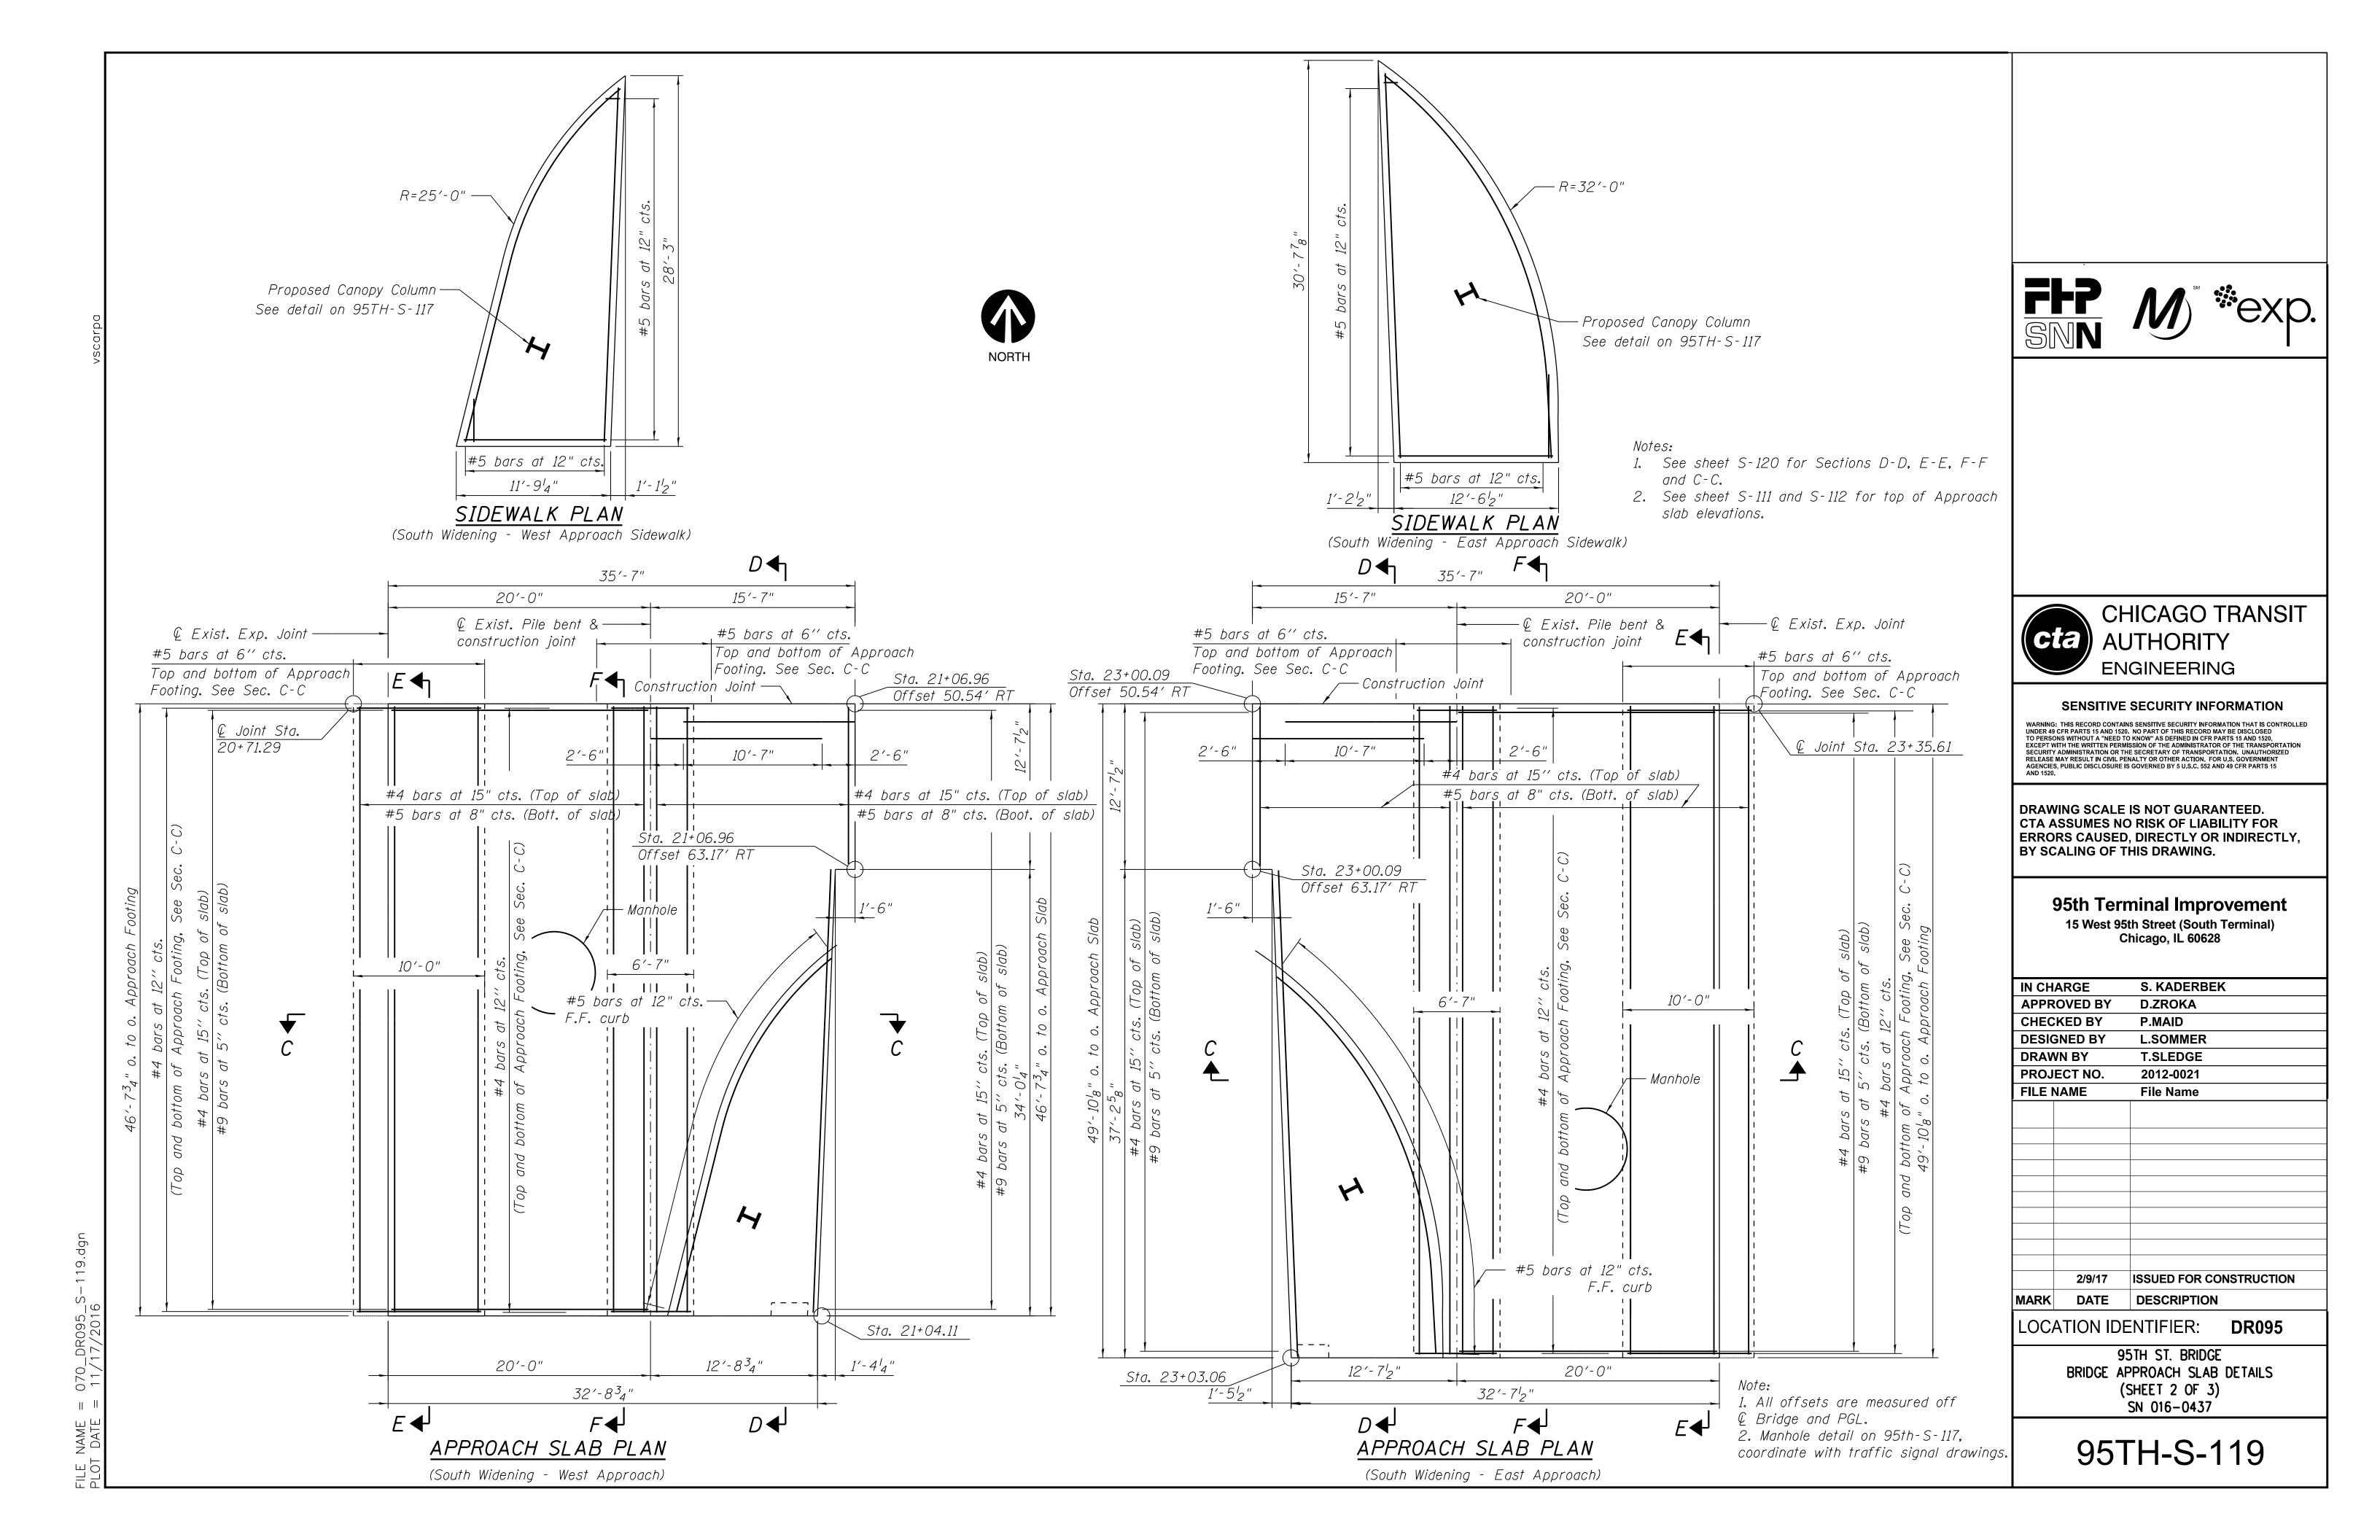
DRAWING SCALE IS NOT GUARANTEED. CTA ASSUMES NO RISK OF LIABILITY FOR ERRORS CAUSED, DIRECTLY OR INDIRECTLY,


### 95th Terminal Improvement


15 West 95th Street (South Terminal) Chicago, IL 60628


APPR	CAED BA	D.ZRUKA				
CHEC	KED BY	P.MAID				
DESIG	ENED BY	L.SOMMER				
DRAV	VN BY	T.SLEDGE				
PROJ	ECT NO.	2012-0021				
FILE	NAME	File Name				
	2/9/17	ISSUED FOR CONSTRUCTION				
MARK	DATE	DESCRIPTION				
LOC	LOCATION IDENTIFIER: DR095					
	9:	5TH ST. BRIDGE				

BRIDGE APPROACH SLAB DETAILS (SHEET 1 OF 3) SN 016-0437



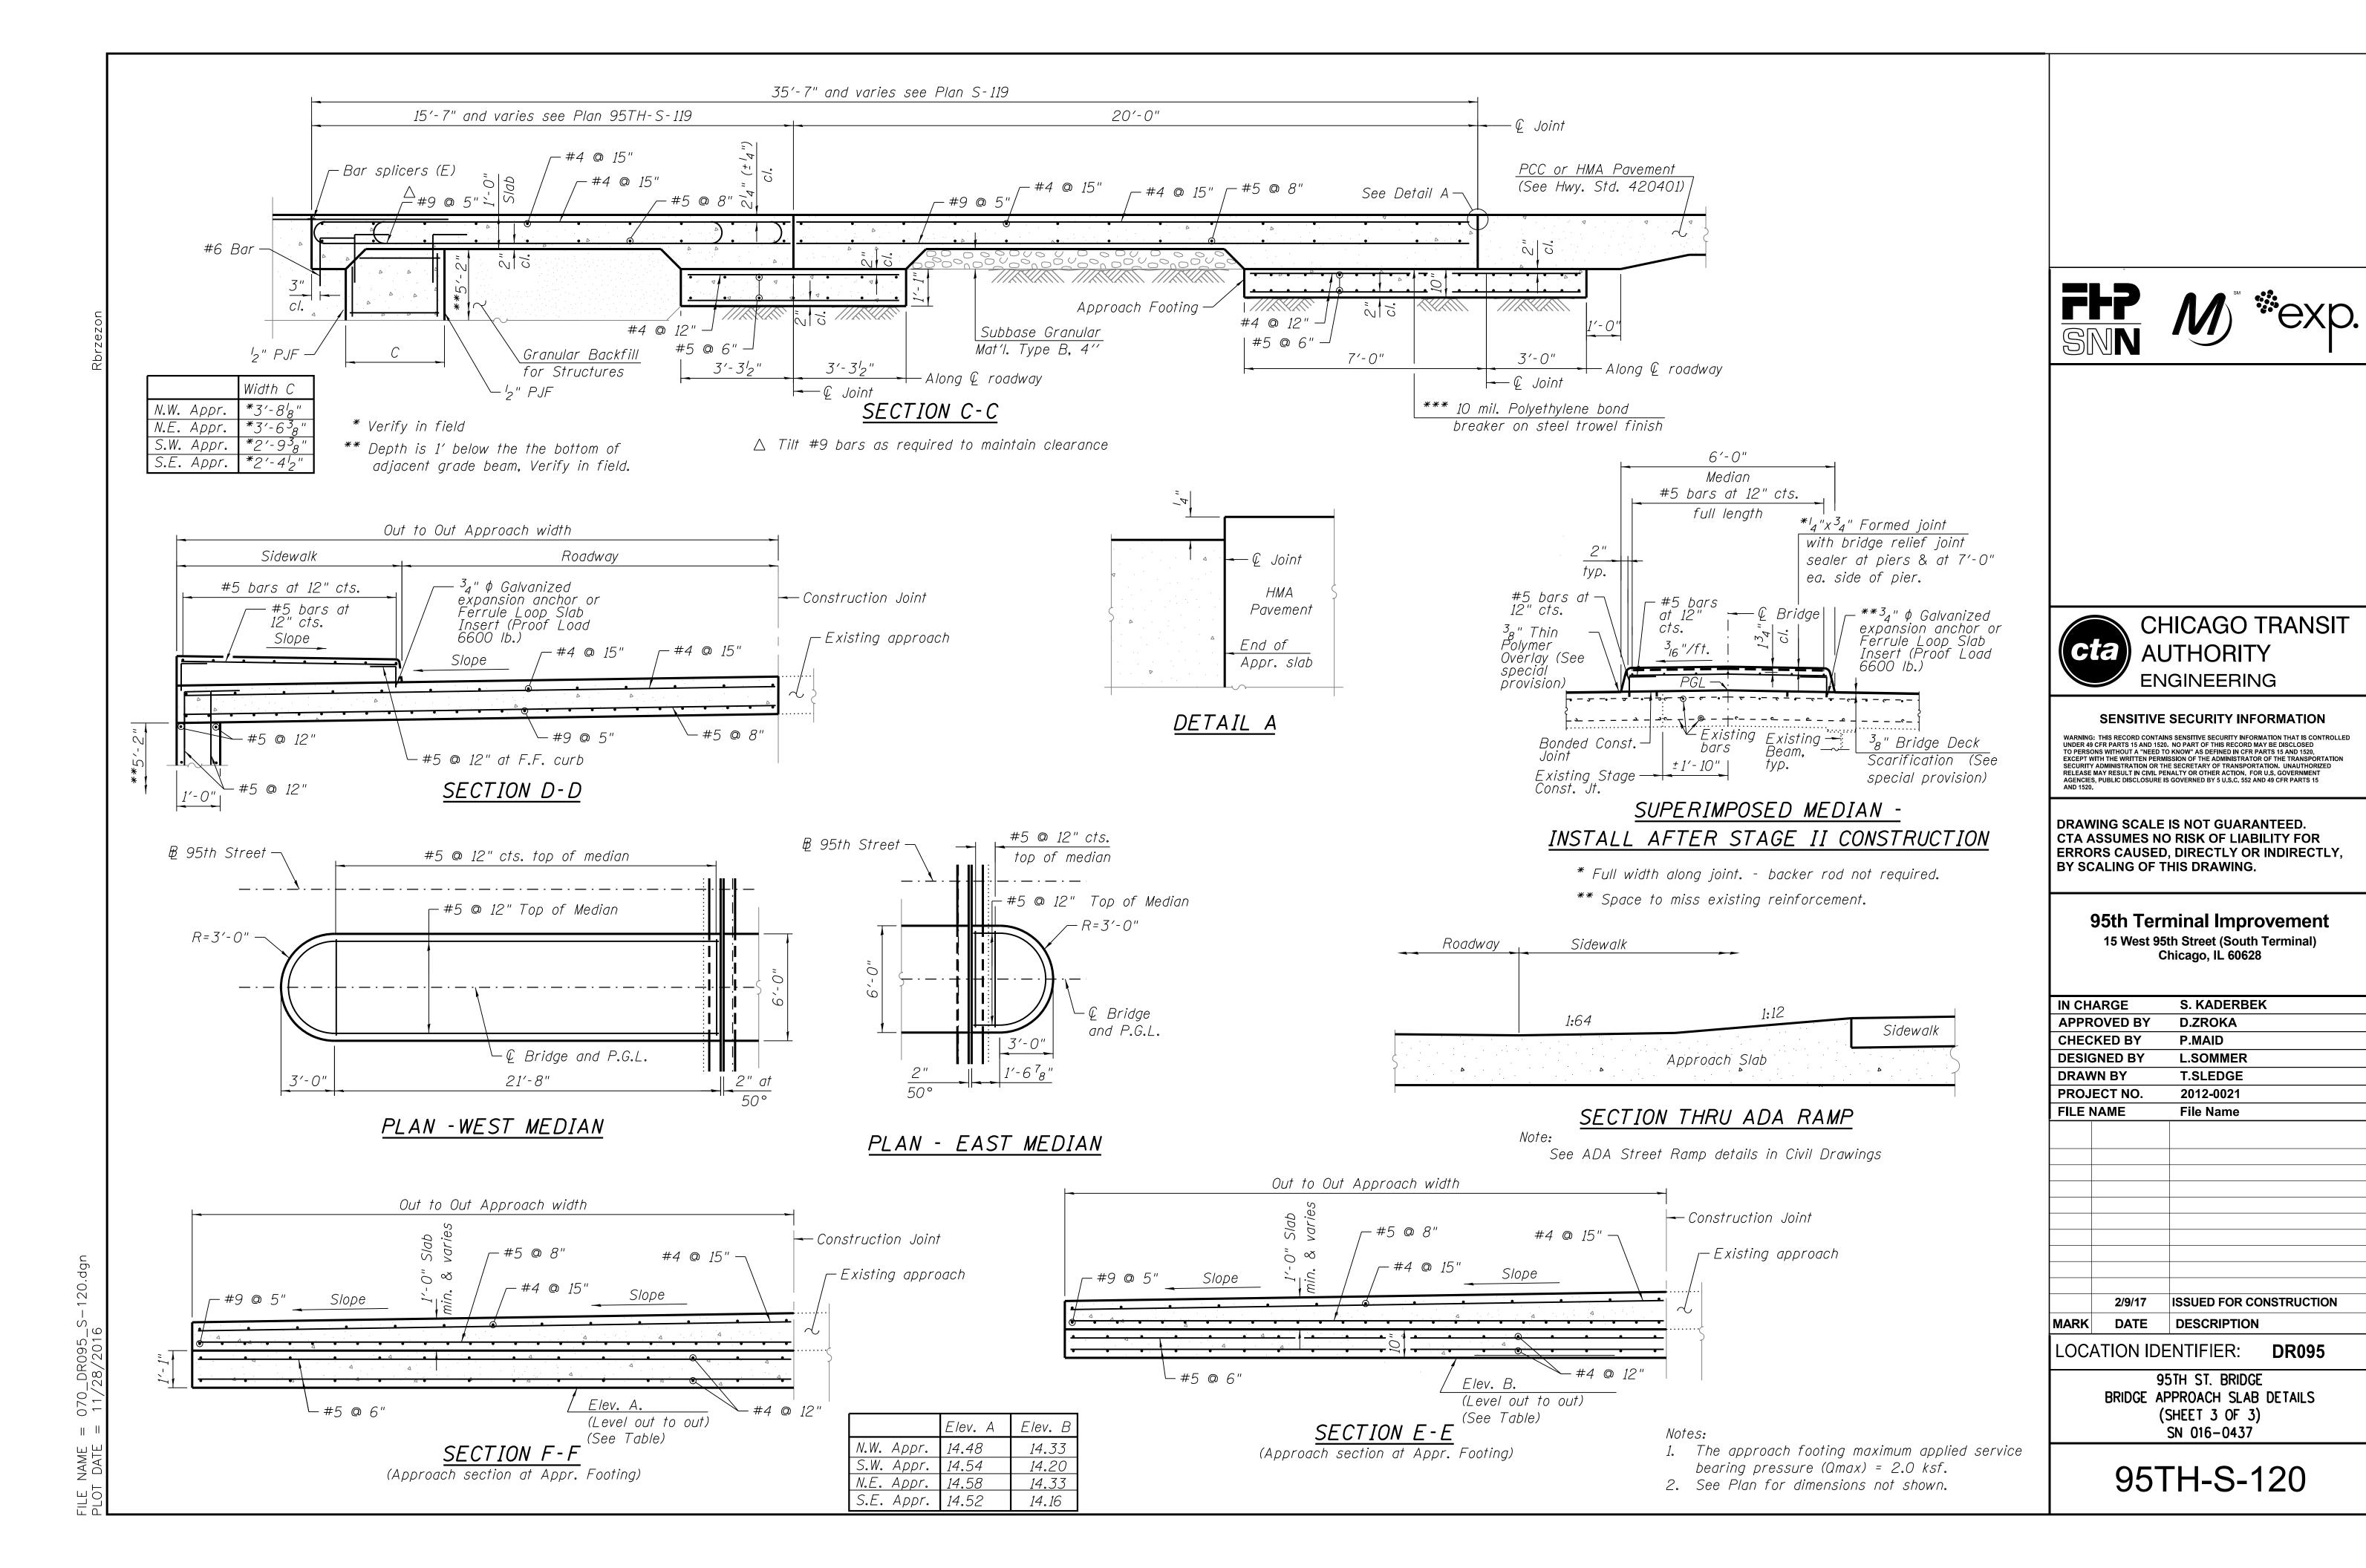


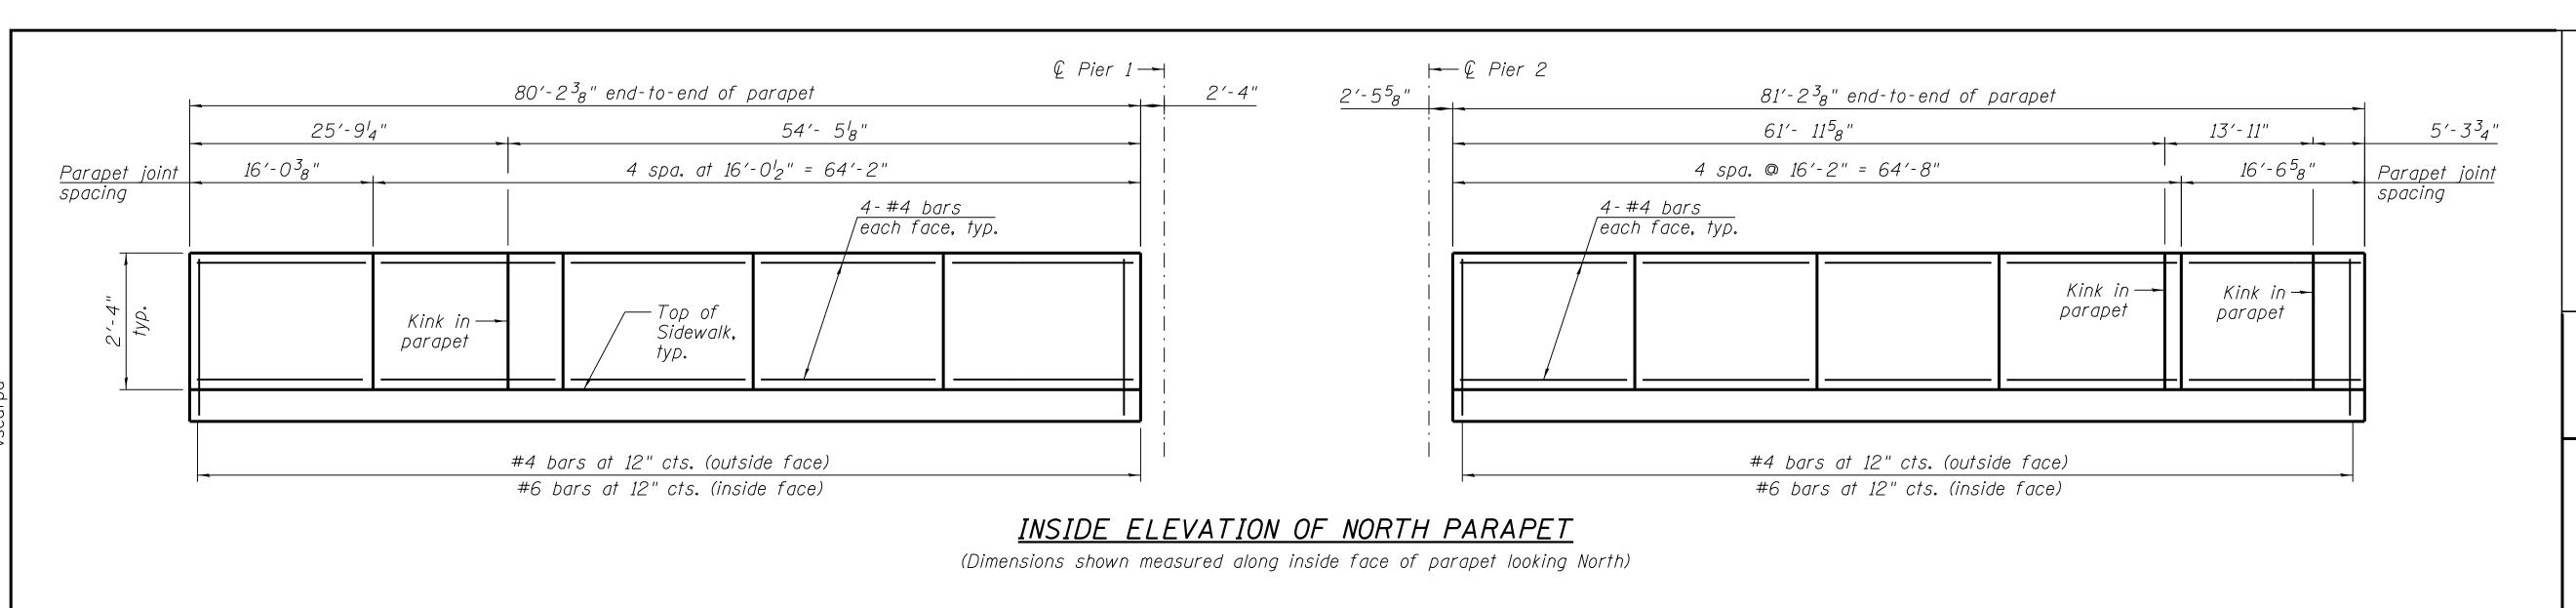

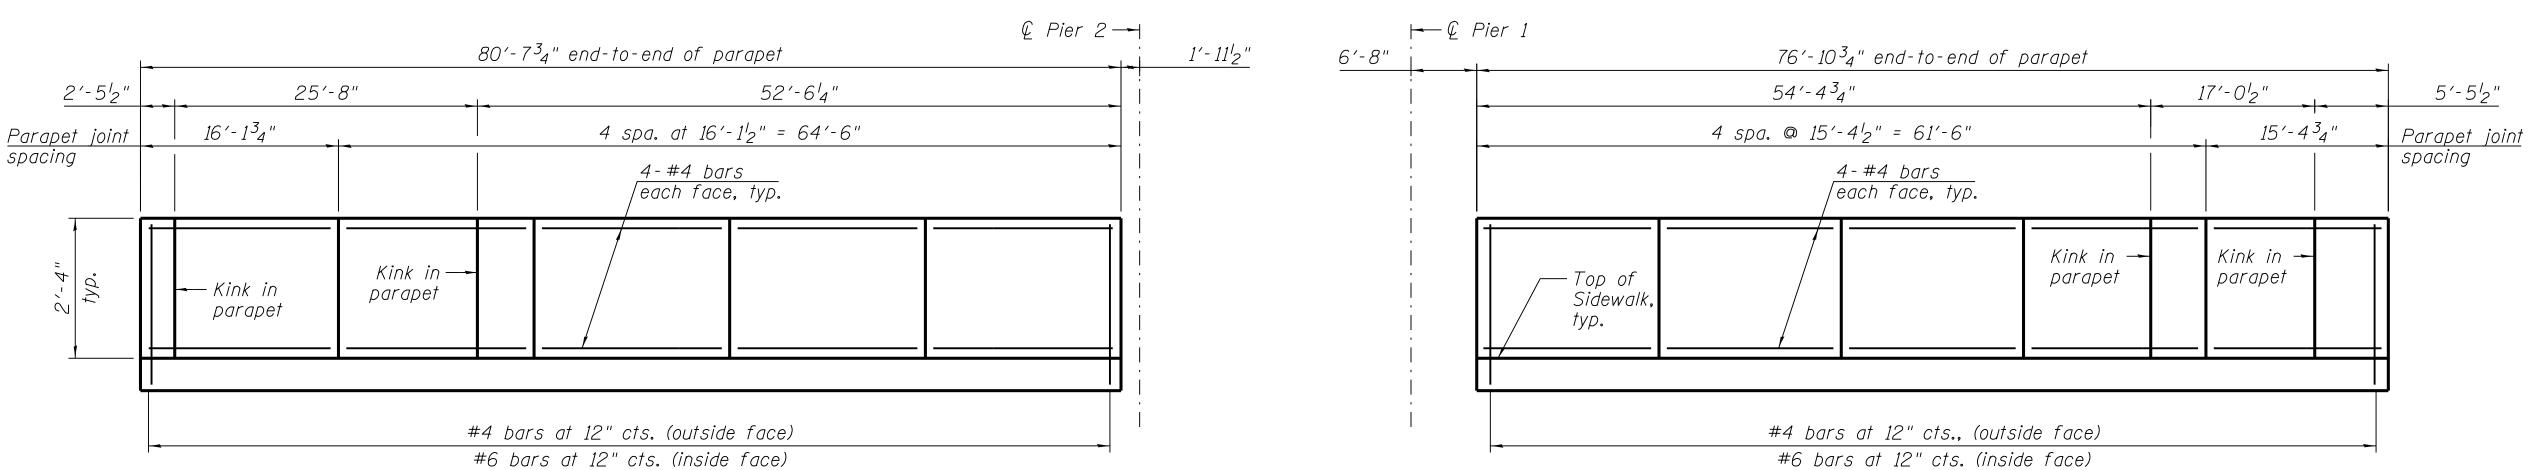

#### INSIDE ELEVATION OF SOUTH PARAPET


(Dimensions shown measured along inside face of parapet looking South)

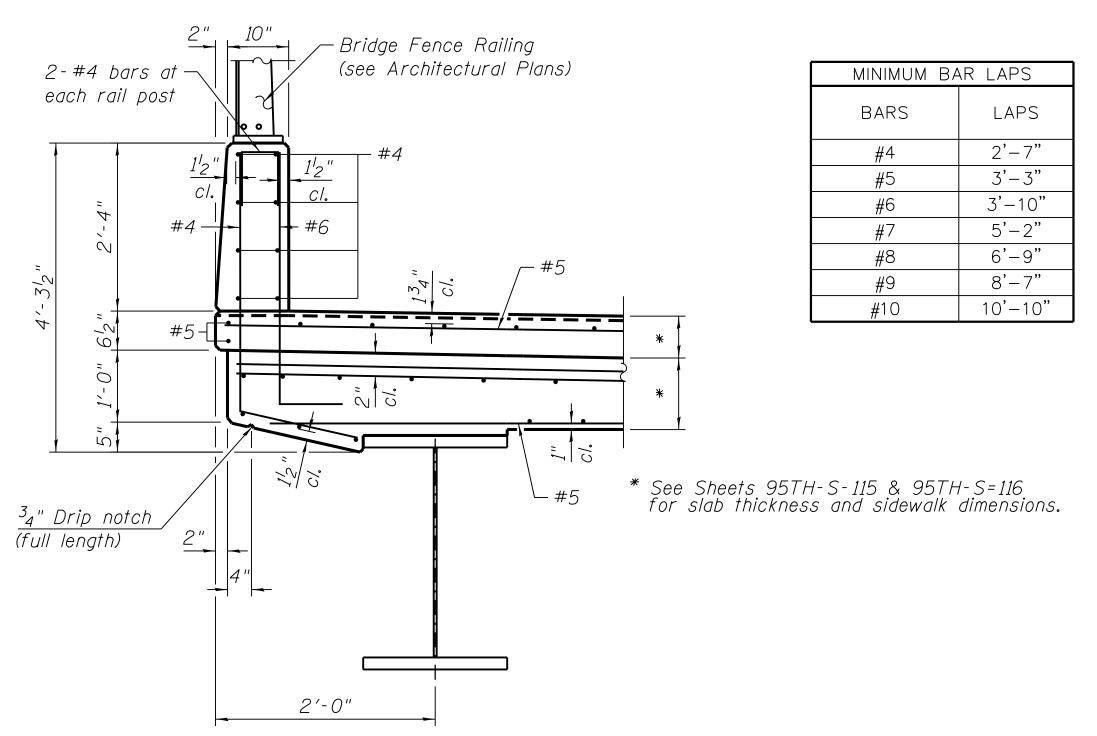

SECTION THRU PARAPET

070\_DR095\_S-121.dgn 8/31/2016

FILE NAME

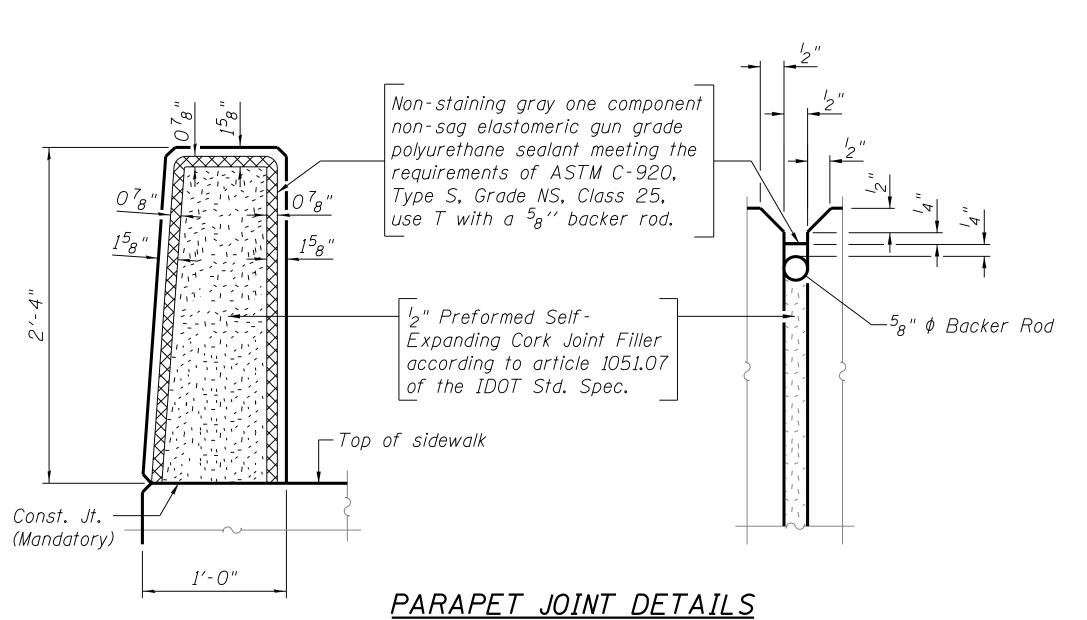

1. For sidewalk reinforcement, see sheets 95TH-S-115 and 95TH-S-116.

*Note:* 

MINIMUM BAR LAP

(Parapet)

#4 bar = 2'-0"



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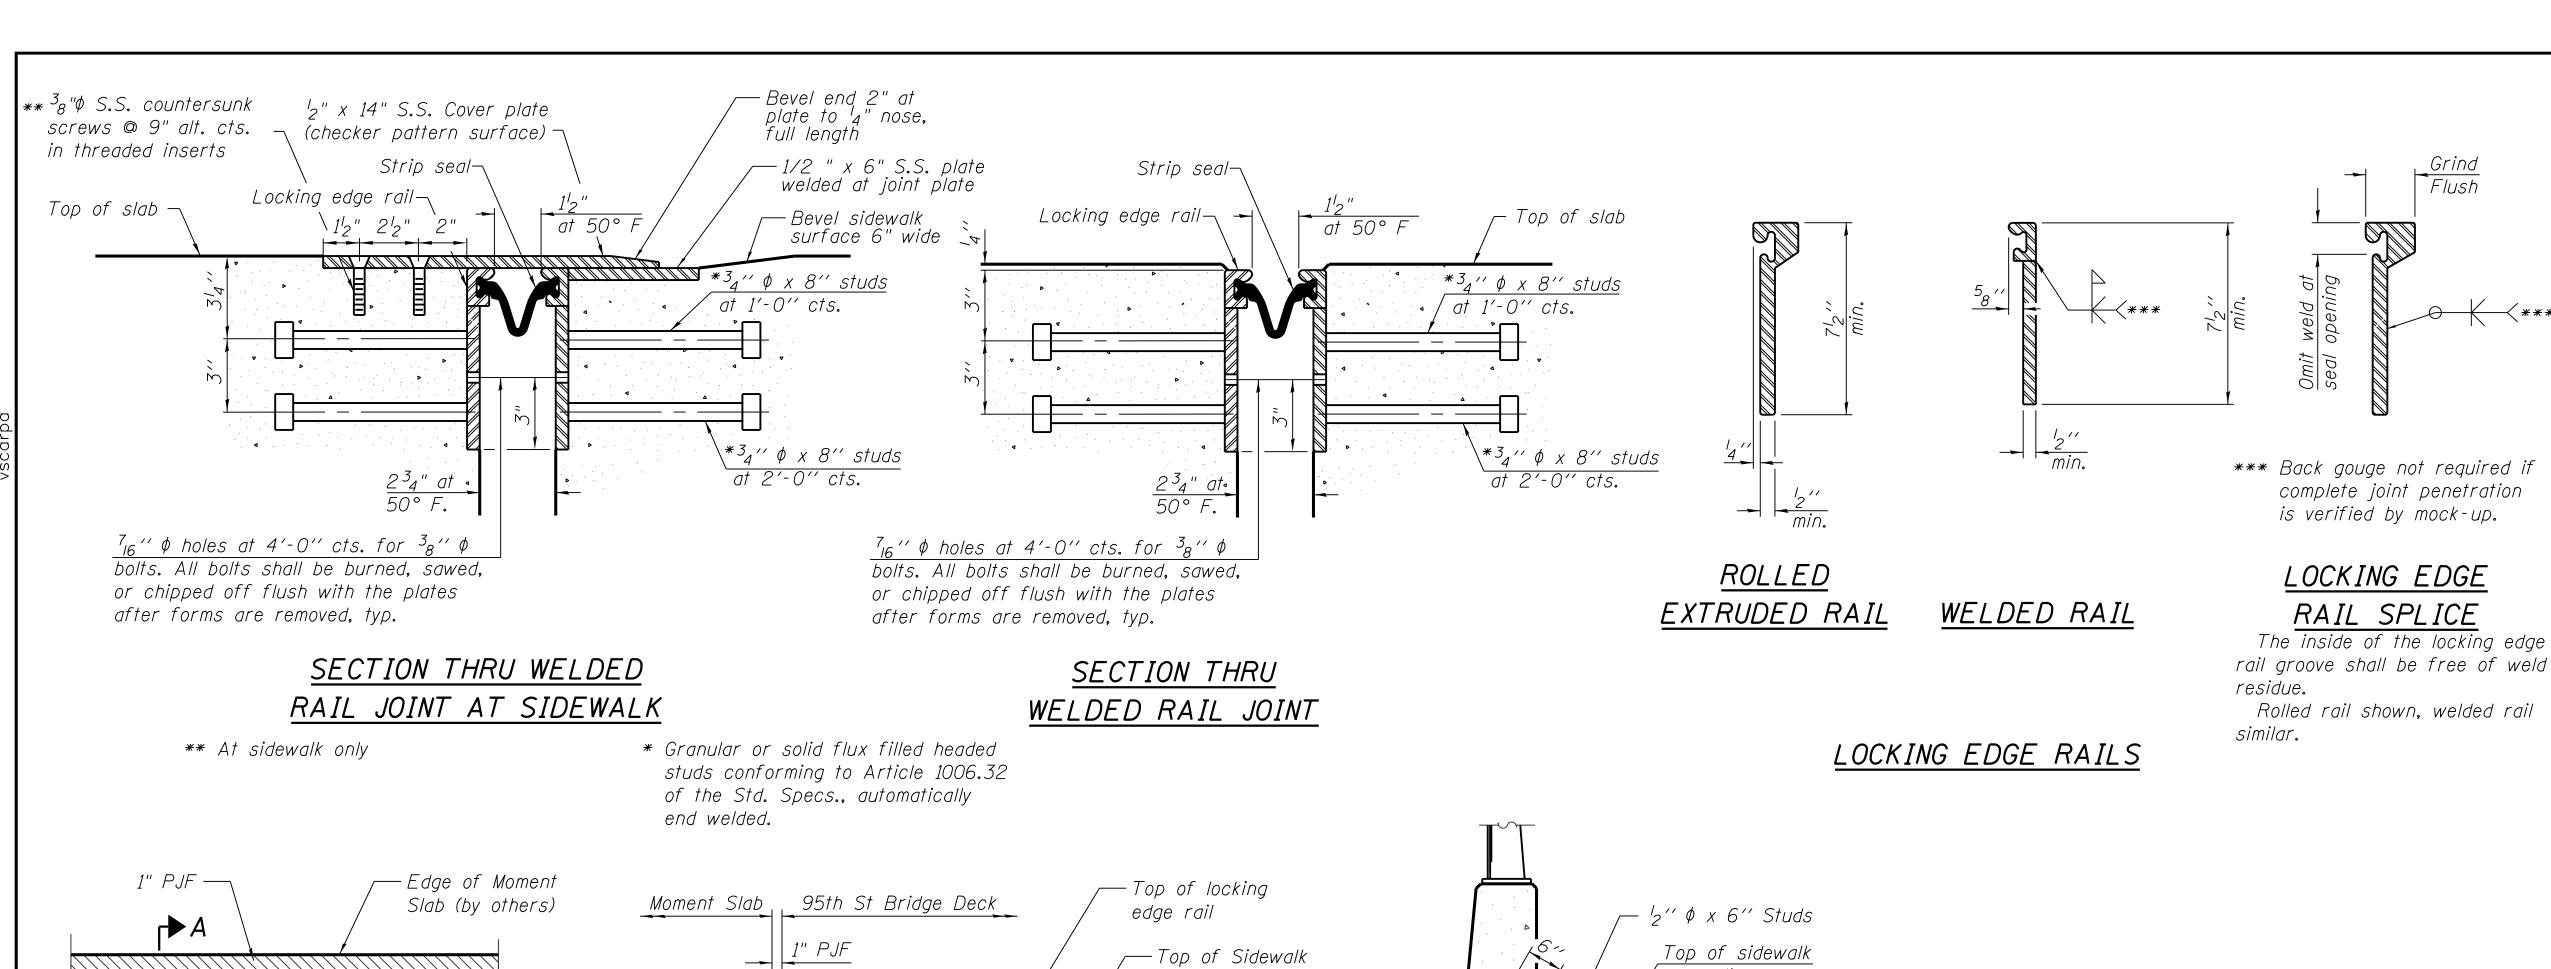
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### 95th Terminal Improvement

15 West 95th Street (South Terminal) Chicago, IL 60628

IN CH	ARGE	S. KADERBEK
APPR	OVED BY	D.ZROKA
CHEC	KED BY	P.MAID
DESIG	ENED BY	L.SOMMER
DRAV	VN BY	T.SLEDGE
PROJ	ECT NO.	2012-0021
FILE	NAME	File Name
	2/9/17	ISSUED FOR CONSTRUCTION
MARK	DATE	DESCRIPTION
LOC	ATION IDE	NTIFIER: DR095

95TH ST. BRIDGE BRIDGE RAILING DETAILS SN 016-0437





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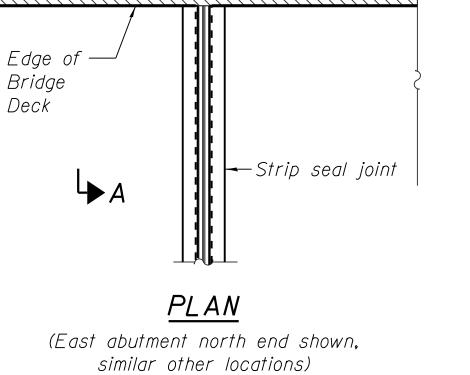
#### 95th Terminal Improvement 15 West 95th Street (South Terminal) Chicago, IL 60628


IN CH	ARGE	S. KADERBEK
APPR	OVED BY	D.ZROKA
CHEC	KED BY	P.MAID
DESIG	ENED BY	L.SOMMER
DRAV	VN BY	T.SLEDGE
PROJ	ECT NO.	2012-0021
FILE N	NAME	File Name
	2/9/17	ISSUED FOR CONSTRUCTION
MARK	DATE	DESCRIPTION

LOCATION IDENTIFIER: **DR095** 


95TH ST. BRIDGE PREFORMED JOINT STRIP SEAL SN 016-0437

95TH-S-122



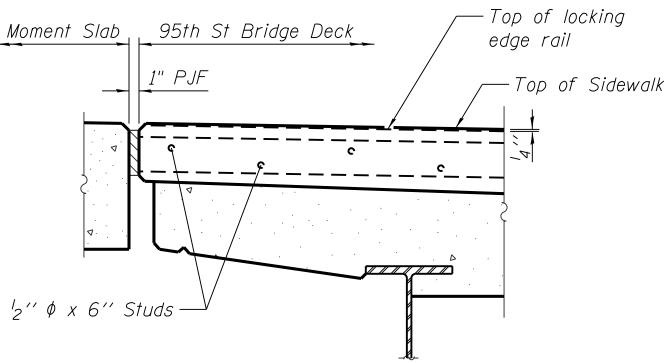

SECTION A-A

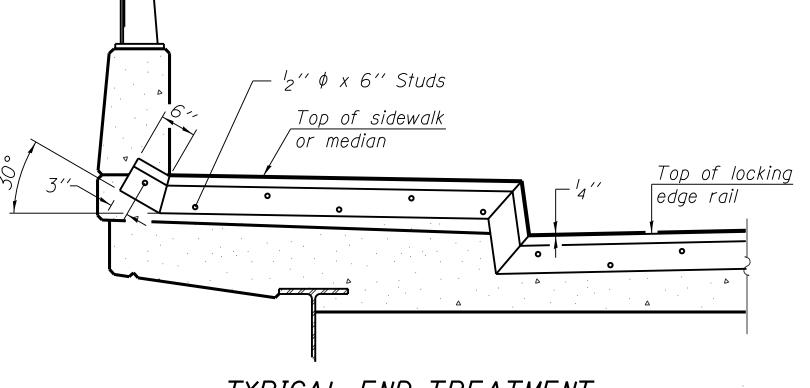

TYPICAL END TREATMENT AT SIDEWALK OR MEDIAN

Shorter plates with a single row of studs at 12" cts. may be necessary on medians which are shallower than 9". See manufacturer's recommendation.

The strip seal shall be made continuous and shall have a minimum thickness of  $\frac{1}{4}$ . The configuration of the strip seal shall match the configuration of the Locking Edge Rails. Open or "webbed" strip seal gland configurations are not permitted. The gland shall be sized for a maximum rated movement of 4 inches.

The Locking Edge Rails depicted are conceptual only, except for the minimum dimensions shown. The actual configuration of the Locking Edge Rails and matching strip seal may vary from manufacturer to manufacturer. Flanged edge rails will not be allowed. Locking Edge Rails may be spliced at slope discontinuities and stage construction joints.

The manufacturer's recommended installation methods shall be followed.


The inside of the Locking Edge Rail groove shall be free of weld

The joint opening and deck dimensions detailed on the superstructure are based on a rolled rail expansion joint. If the Contractor elects to use the welded rail expansion joint, the opening and deck dimensions shall be modified according to the dimensions detailed on this sheet at no additional cost.

All stainless steel cover plates to be stainless diamond floor plate conforming to the requirements of ASTM A793, Type 304.

All steel components shall be galvanized after fabrication according to Article 520.03 of the IDOT Standard Specifications.

Maximum space between rail segments shall be 3<sub>16</sub> '', sealed with a suitable sealant. Joints in rails within 10 ft. of curbs shall be welded.

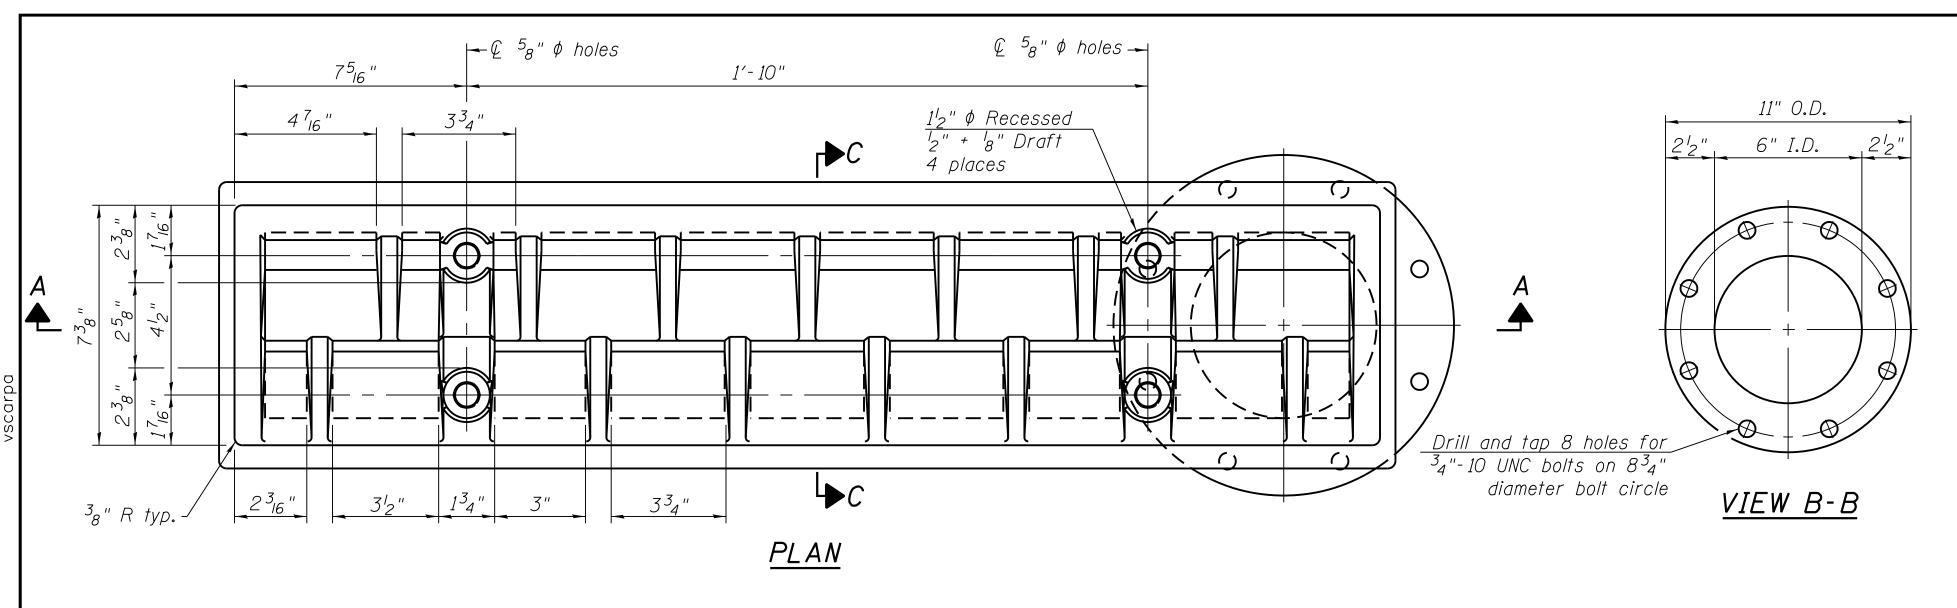

Not

Refer to Drainage system specification, section 33 41 10.

All cast iron parts shall be gray iron conforming to the requirements of AASHTO M 105, Class 35B.

Bolts, anchor studs, washers and nuts shall conform to the requirements of ASTM A 307 and shall be galvanized according to AASHTO M 232.

As an alternate, bolts, anchor studs, washers and nuts may be stainless steel according to Article 1006.29(d) of the IDOT Standard Specifications.

Structural steel weldments of equal sections and of the same configuration may be substituted for the cast iron scupper frame. Fillet or full penetration welds shall be used for the weldments. Details shall be submitted to the Engineer for approval. Structural steel weldments shall not be substituted for the cast iron scupper grate. Structural steel frames and downspouts shall be galvanized according to AASHTO M111.

The Contractor shall take appropriate measures to assure that Protective Coat is not applied to the scupper.

Alternate fiberglass downspout conforming to ASTM D 2996 with a short-time rupture strength hoop tensile stress of 30,000 psi min. may be used in lieu of the cast iron or steel equivalent.

11" O.D.

6" I.D.

6" I.D.

7" O.D.

**DOWNSPOUT** 





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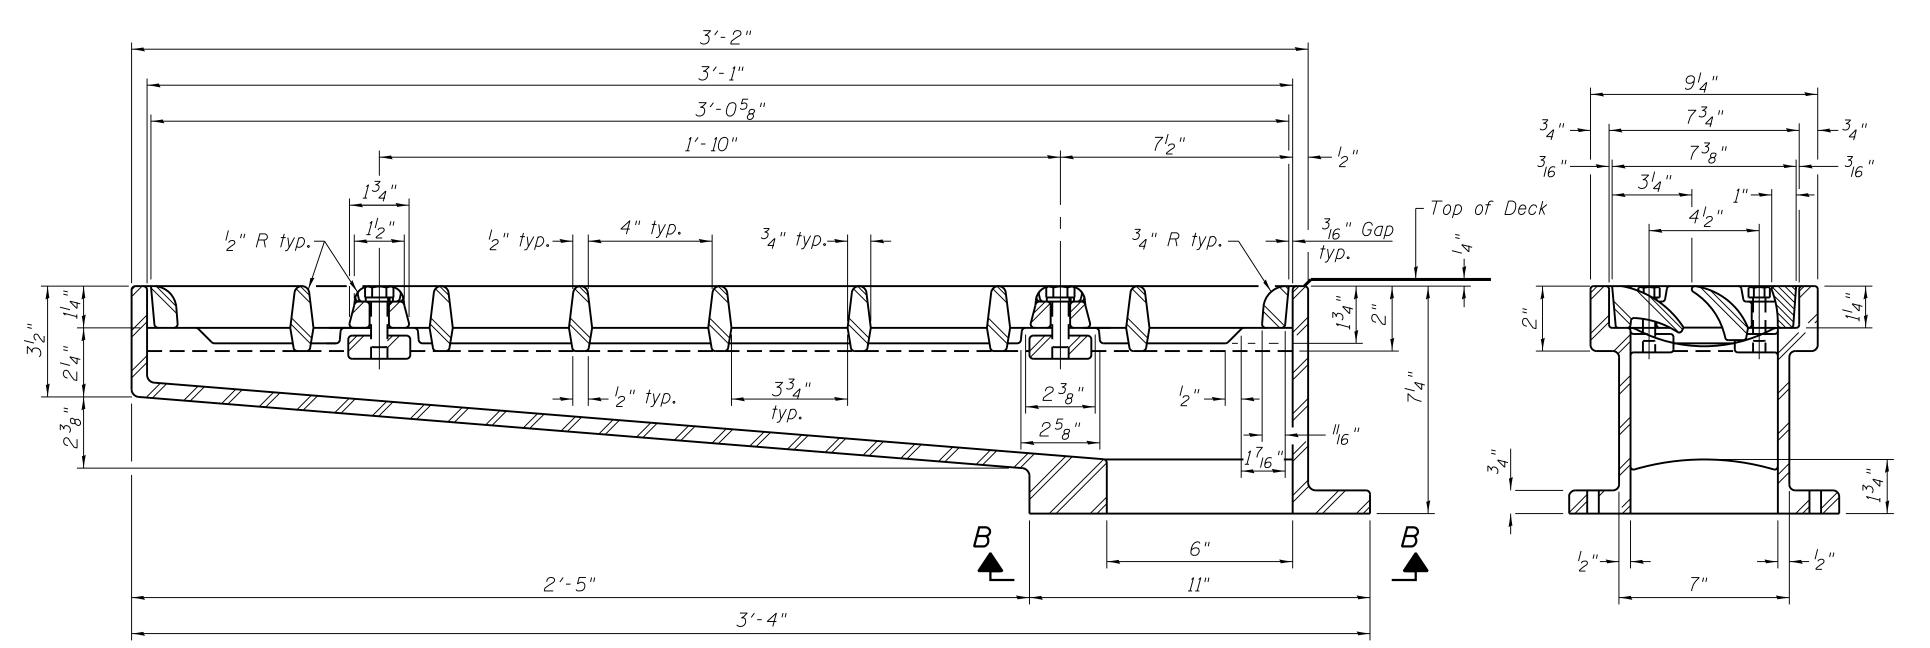
# 95th Terminal Improvement 15 West 95th Street (South Terminal) Chicago, IL 60628

IN CH	ARGE	S. KADERBEK
APPR	OVED BY	D.ZROKA
CHEC	KED BY	P.MAID
DESIG	ENED BY	L.SOMMER
DRAV	VN BY	T.SLEDGE
PROJ	ECT NO.	2012-0021
FILE	NAME	File Name
	0/0/4=	LOCUED FOR CONCERNATION
	2/9/17	ISSUED FOR CONSTRUCTION
MARK	DATE	DESCRIPTION
		ENTIFIED: DDAGE

LOCATION IDENTIFIER: DR095


95TH ST. BRIDGE DRAINAGE SCUPPER, DS-33 SN 016-0437

95TH-S-123




 $\frac{8^{-9}_{16}" \phi \text{ holes on an}}{8^{3}_{4}" \phi \text{ bolt circle}}$ 

SECTION C-C

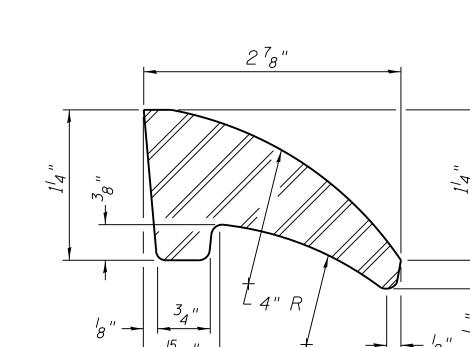

SECTION A-A

See sheet S-114 and S-116 for scupper location relative to curb.

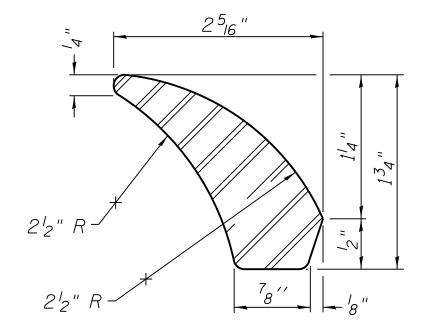


FIRST VANE DETAIL

SECOND VANE DETAIL

1/4"
= No. 1/4"
= No.

BOLT HOLE DETAIL

NAME = 070\_DR095\_S-123.dgn DATE = 8/31/2016

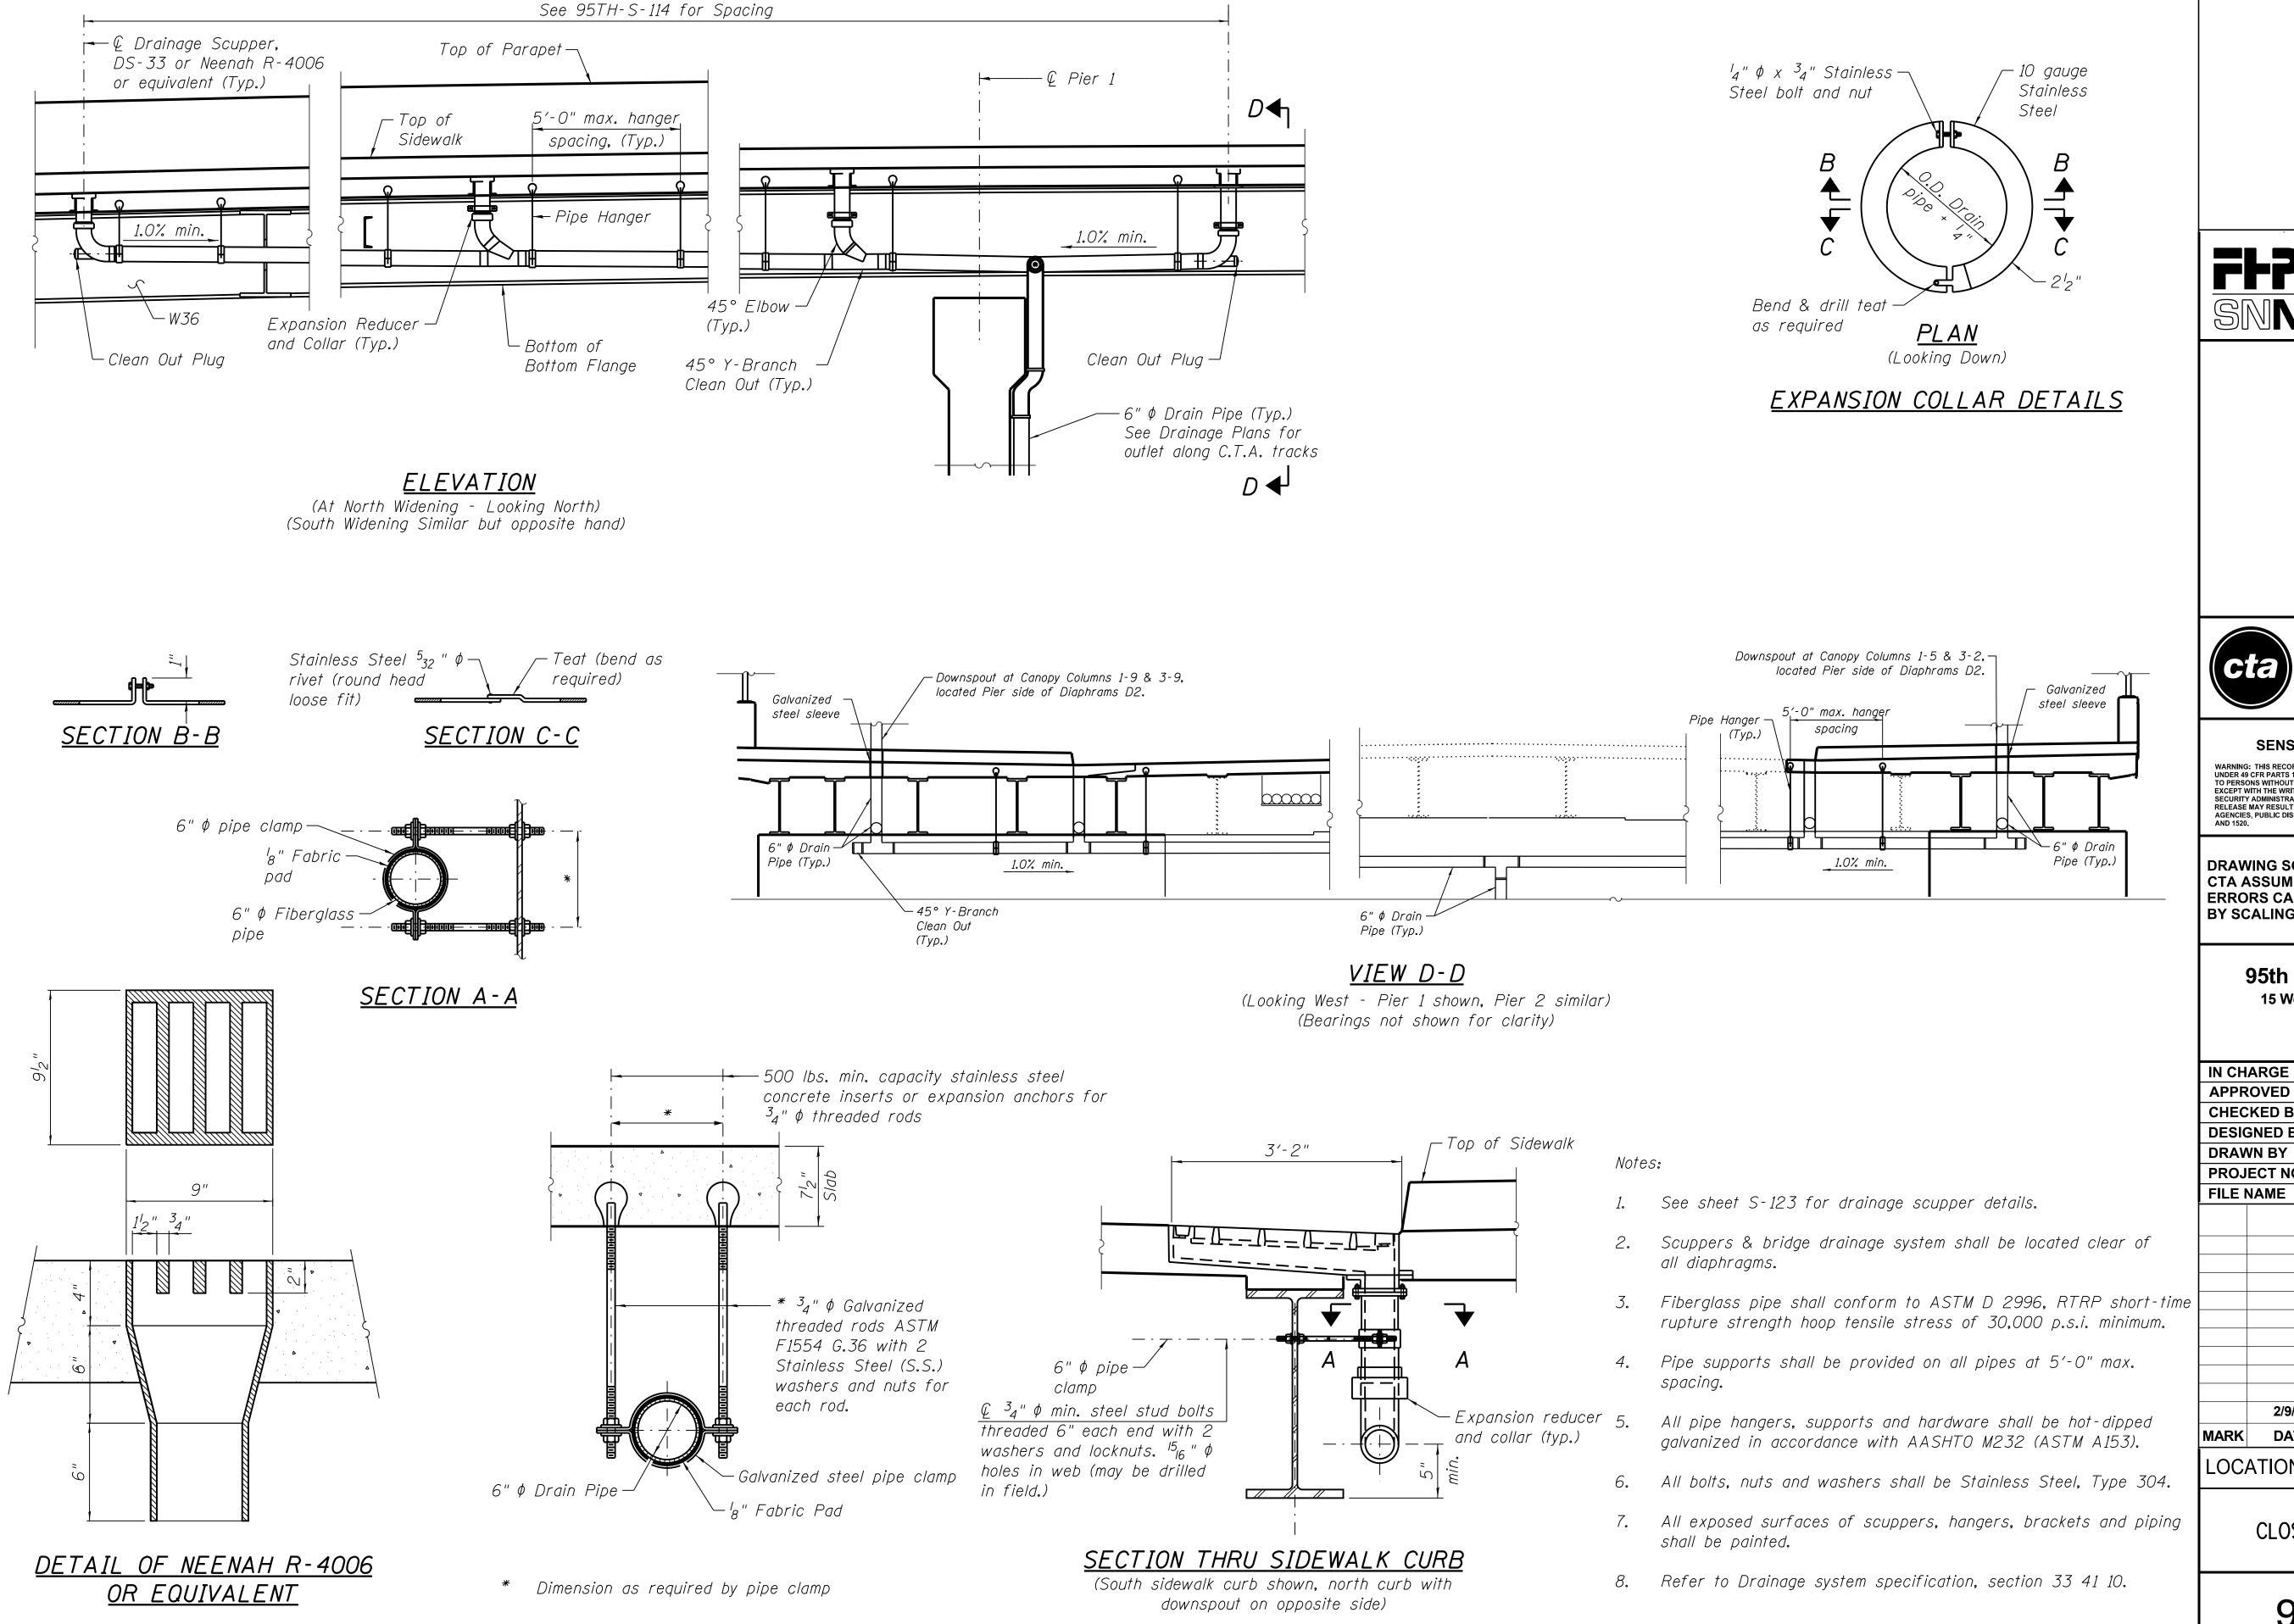

S-124.dgn

070\_DR095\_S 9/12/2016

II II

FILE NAME



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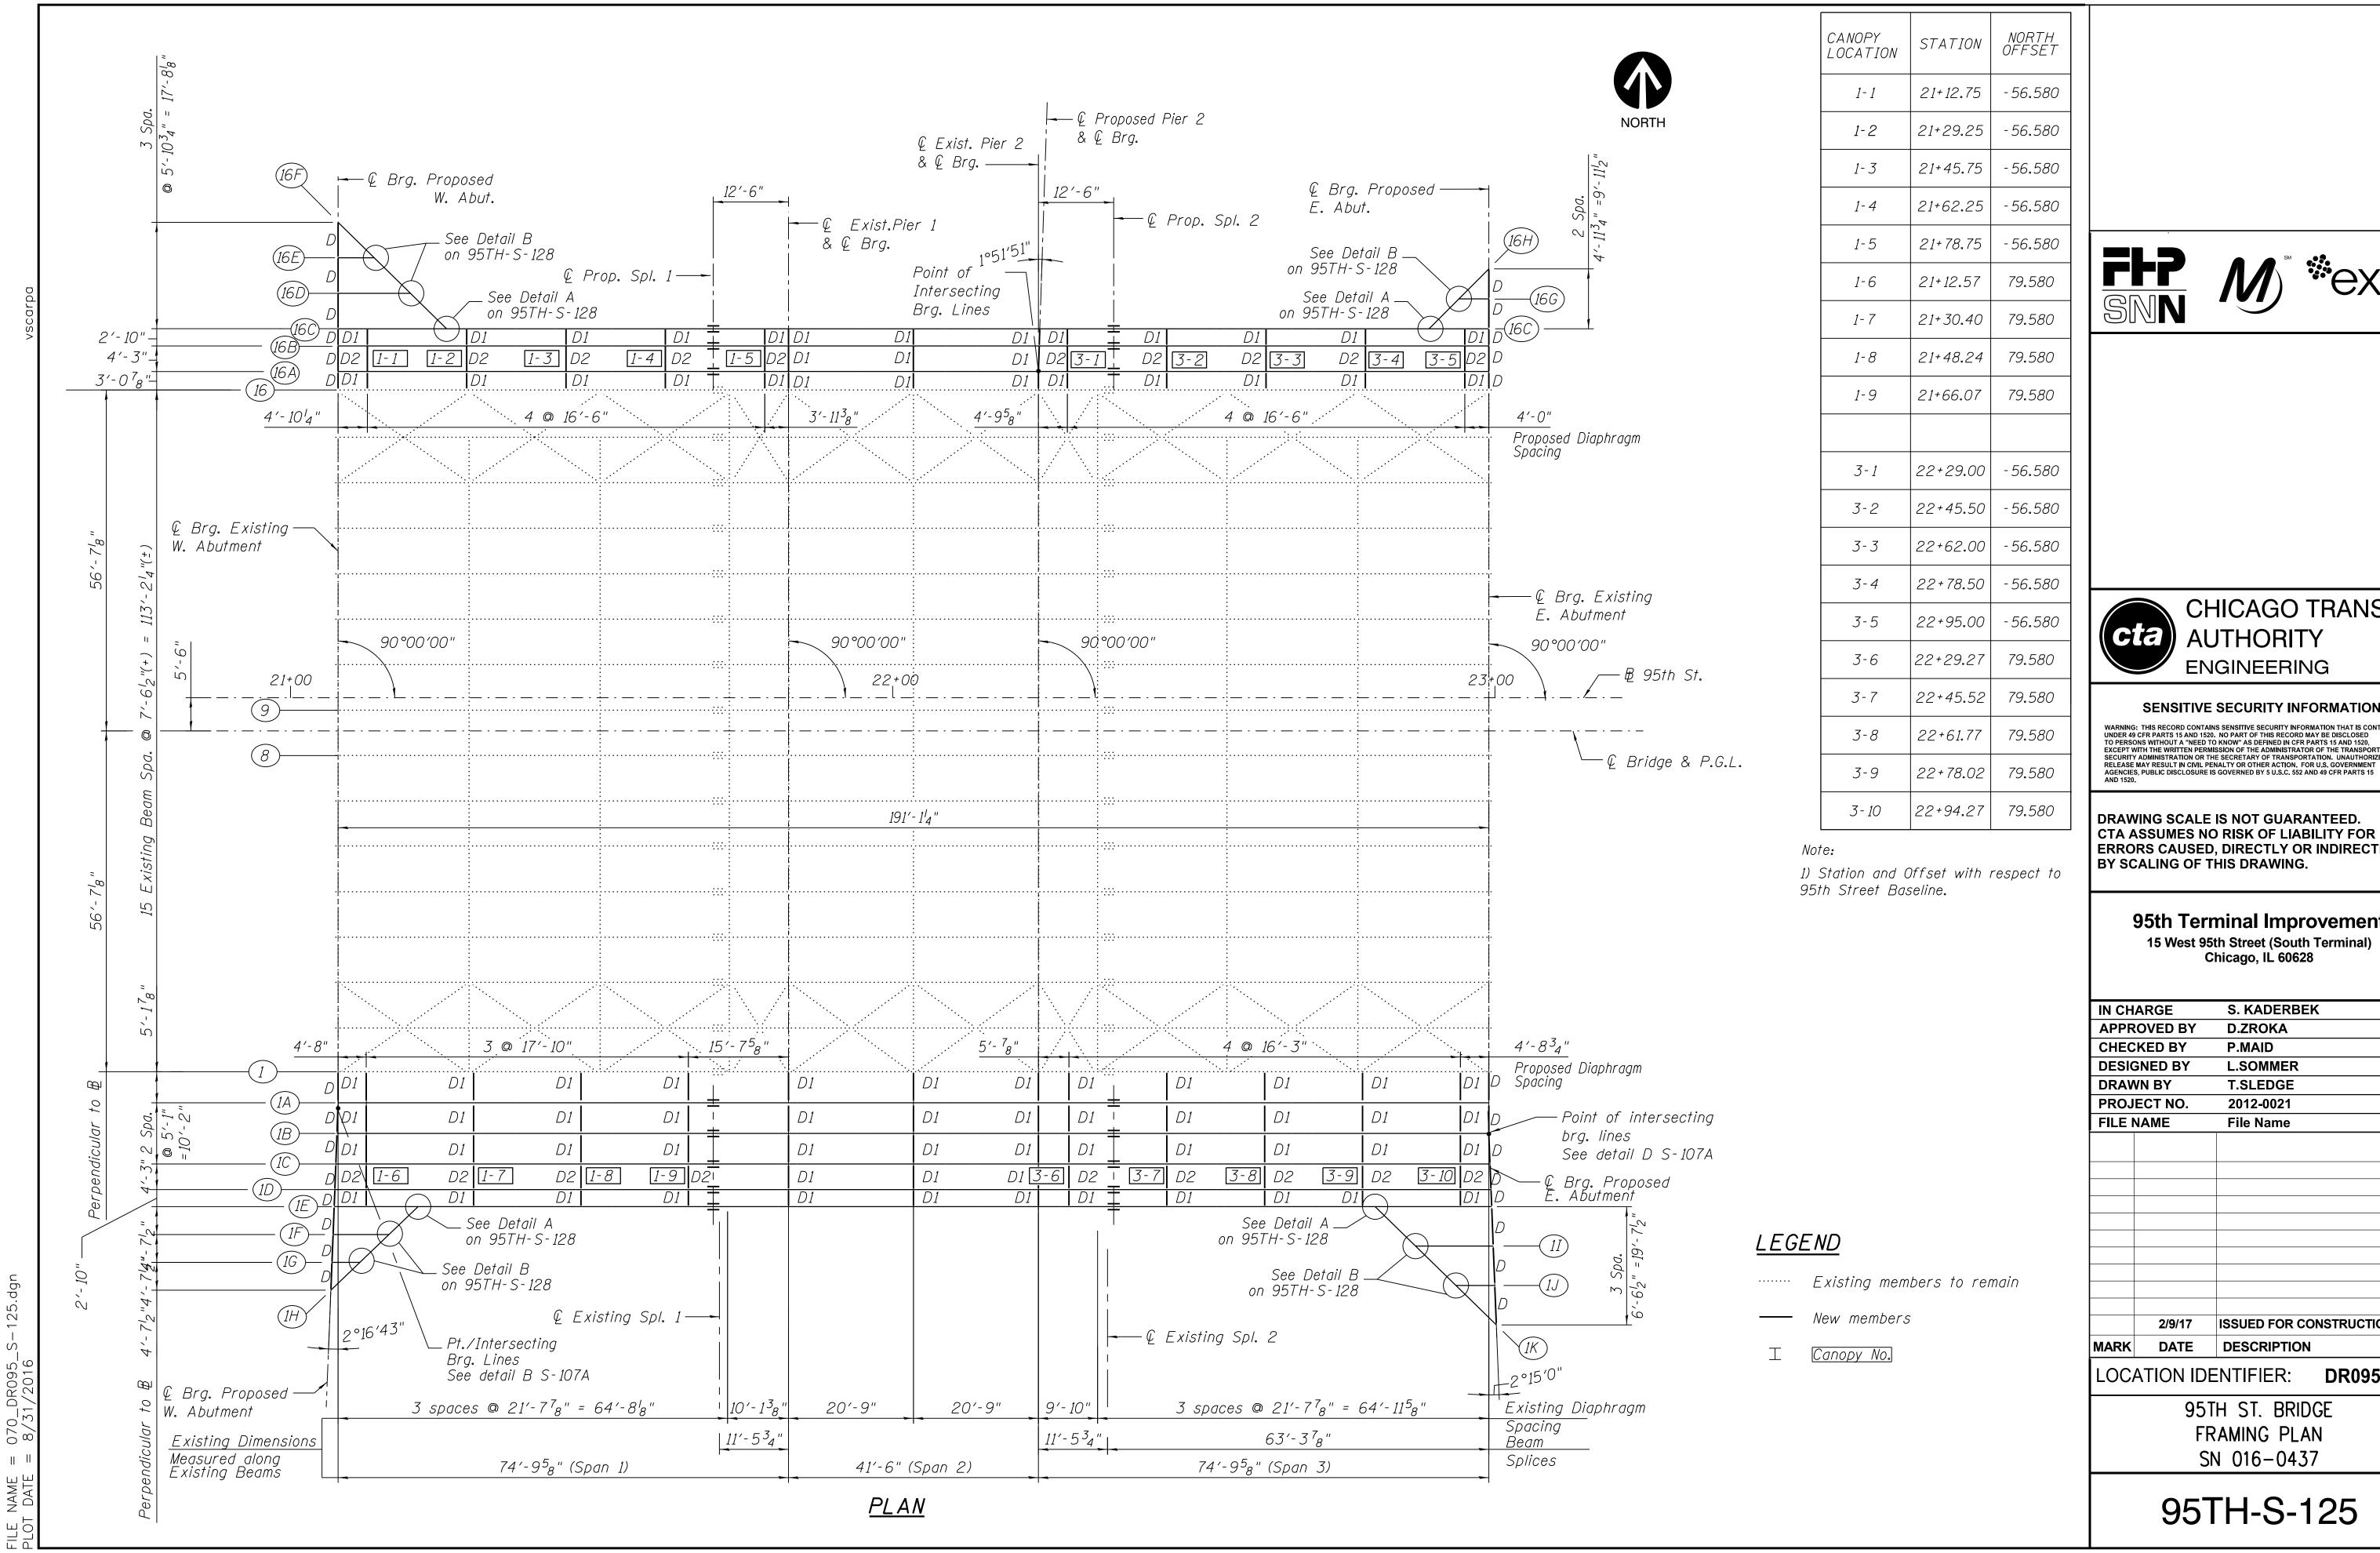
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### 95th Terminal Improvement

15 West 95th Street (South Terminal) Chicago, IL 60628

IN CH	ARGE	S. KADERBEI	<b>&lt;</b>
APPR	OVED BY	D.ZROKA	
CHEC	KED BY	P.MAID	
DESIG	GNED BY	L.SOMMER	
DRAV	VN BY	T.SLEDGE	
PROJ	ECT NO.	2012-0021	
FILE I	NAME	File Name	
	2/9/17	ISSUED FOR CC	NSTRUCTION
MARK	DATE	DESCRIPTION	
LOC	ATION ID	ENTIFIER:	DR095

95TH ST. BRIDGE CLOSED DRAINAGE SYSTEM SN 016-0437





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## 95th Terminal Improvement

S. KADERBEK

APPROVED BY		D.ZROKA	
CHEC	KED BY	P.MAID	
DESIG	GNED BY	L.SOMMER	
DRAV	VN BY	T.SLEDGE	
PROJ	ECT NO.	2012-0021	
FILE N	NAME	File Name	
	2/9/17	ISSUED FOR CONSTRUCTION	N
	<u> </u>	1330LD I OK CONSTRUCTIO	<b>'1</b>
MARK	DATE	DESCRIPTION	
		ENTIFIER DR095	

LOCATION IDENTIFIER: **DKU95** 

> FRAMING PLAN SN 016-0437

#### BEAM ELEVATION

(Beams 1A thru 1E, 16A thru 16C) Scale: N.T.S.

#### BEAM DIMENSIONS

Beam No.					Shear Stud Spacing		
	Α	В	С	D	Ε	F	G
1E	75′-5 <sup>5</sup> 8"	41′-6"	75′-3 <sup>1</sup> <sub>16</sub> "	192'-2"16"	104 sp @ 7" (-) = 60'-3 <sup>1</sup> 8"	105 sp @ 7" (-) = 61'-1"	103 sp @ 7" (-) = 60'-0 <sup>9</sup> 16"
1D	75'-4 <sub>16</sub> "	41'-6"	75'-1 <sup>15</sup> 16"	192′-0"	104 sp @ 7" (-) = 60'-19 <sub>16</sub> "	105 sp @ 7" (-) = 61'-1"	103 sp @ 7" (-) = 59'-11 <sup>7</sup> 16"
1C	75′-2"	41'-6"	74'-11 <sup>15</sup> 16"	191'- 7 <sup>15</sup> 16 "	102 sp @ 7" (-) = 59'-5 <sup>1</sup> 2"	103 sp @ 7" (-) = 60'-1"	102 sp @ 7" (-) = 59'-3 <sup>7</sup> 16"
1B	74′-11 <sup>9</sup> 16″	41′-6"	74′-9 <sup>9</sup> 16"	191'-3 <sup>1</sup> 8"	102 sp @ 7" (-) = 59'-3 <sub>16</sub> "	103 sp @ 7" (-) = 60'-1"	102 sp @ 7" (-) = 59'-1 <sub>16</sub> "
1A	74′-9 <sup>5</sup> 8"	41′-6"	74′-9 <sup>5</sup> 8"	191'-14"	103 sp @ 7" (-) = 59'-7 <sup>1</sup> 8"	105 sp @ 7" (-) = 61'-1"	103 sp @ 7" (-) = 59'-7 <sup>l</sup> 8"
16 A	74′-9 <sup>5</sup> 8"	41′-6"	74′-9 <sup>5</sup> 8"	191'-14"	102 sp @ 7" (-) = 59'-1 <sub>8</sub> "	103 sp @ 7" (-) = 60'-1"	102 sp @ 7" (-) = 59'-1 <sub>8</sub> "
16B	74′-9 <sup>5</sup> 8"	41'-7 <sup>5</sup> 8"	74′-8"	191'-14"	102 sp @ 7" (-) = 59'-1 <sub>8</sub> "	104 sp @ 7" (-) = 60'-2 <sup>5</sup> 8"	101 sp @ 7" (-) = 58'-11 <sup>1</sup> 2"
16C	74'-9 <sup>5</sup> 8"	41'-8 <sup>3</sup> 4"	74′-6 <sup>7</sup> 8"	191'-1'4"	103 sp @ 7" (-) = 59'-7' <sub>8</sub> "	106 sp @ 7" (-) = 61'-3 <sup>3</sup> 4"	102 sp @ 7" (-) = 59'-4 <sup>3</sup> 8"

All dimensions are measured along the centerline of beam.


### TOP OF BEAM ELEVATIONS

(For Fabrication only)

Beam No.	& Brg. W Abut.	© Field Splice #1	© Pier 1	© Pier 2	© Field Splice #2	€ Brg. E Abut.
1A	16.307	17.439	17.439	17.440	17.440	16.309
1B	16.257	17.394	17.394	17.395	17.395	16.264
1C	16.251	17.394	17.394	17.395	17.395	16.258
1D	16.247	17.394	17.394	17.395	17.395	16.253
1E	16.243	17.394	17.394	17.395	17.395	16.251
16 A	16.466	17.640	17.640	17.639	17.639	16.426
<i>16B</i>	16.466	17.640	17.639	17.638	17.638	16.426
16C	16.466	17.640	17.639	17.637	17.637	16.426

Beam No.	€ Brg. W Abut.	End
1F	16.238	16.488
1G	<i>16.233</i>	<i>1</i> 6. <i>3</i> 61
1H	<i>16.228</i>	16.607
16D	16.466	16.766
16E	16.466	<i>16.616</i>
16F	16.466	<i>1</i> 6.915

Beam No.	Start	€ Brg. E Abut.
11	16.582	16.243
1J	16.412	<i>16.236</i>
1K	<i>1</i> 6.739	<i>1</i> 6.229
16G	<i>1</i> 6.571	16.426
16H	16.708	16.426

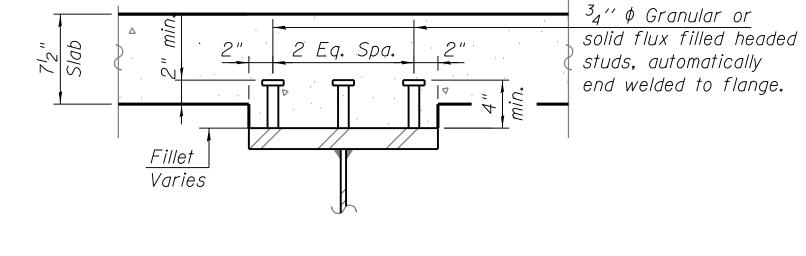

SECTION A-A

#### Notes:

- 1. Load carrying components designated "NTR" shall conform to the Impact Testing requirement, Zone 2.
- 2. Shear Studs shall not be placed on top of connection plate for diaphragm D2.





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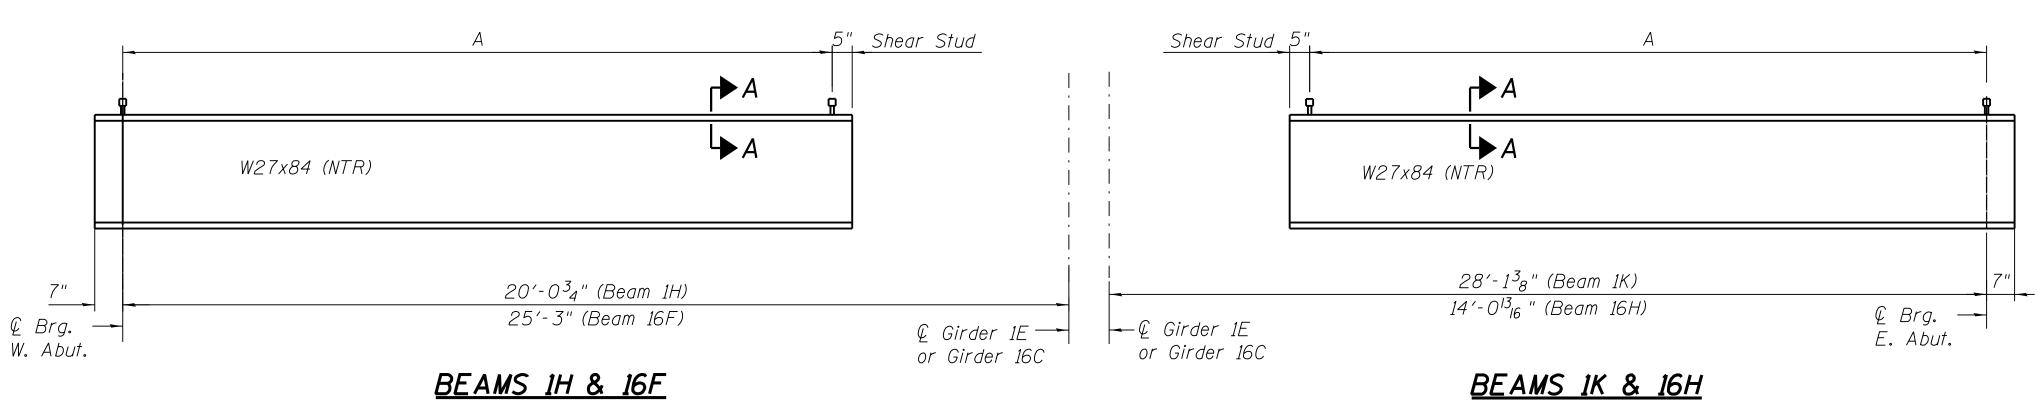
### 95th Terminal Improvement


15 West 95th Street (South Terminal) Chicago, IL 60628


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IIV CH	ARGE	S. KADERBEK
APPR	OVED BY	D.ZROKA
CHEC	KED BY	P.MAID
DESIG	SNED BY	L.SOMMER
DRAV	VN BY	T.SLEDGE
PROJ	ECT NO.	2012-0021
FILE N	NAME	File Name
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	2/9/17	ISSUED FOR CONSTRUCTION
MARK	DATE	DESCRIPTION
1.00		ENTIFIED. DDAGE


LOCATION IDENTIFIER: DR095


95TH ST. BRIDGE STRUCTURAL STEEL DETAILS (SHEET 1 OF 5) SN 016-0437



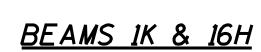

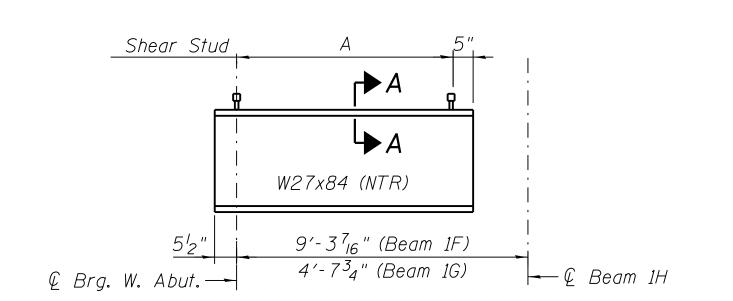

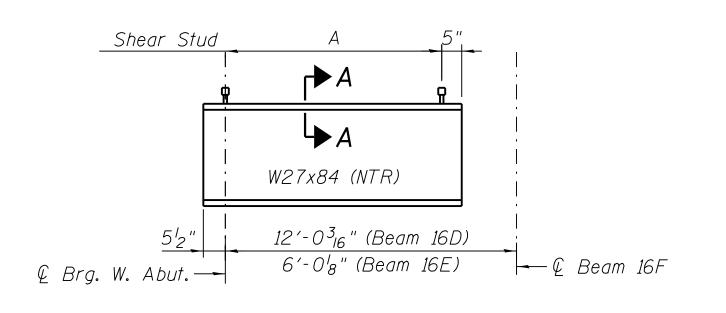

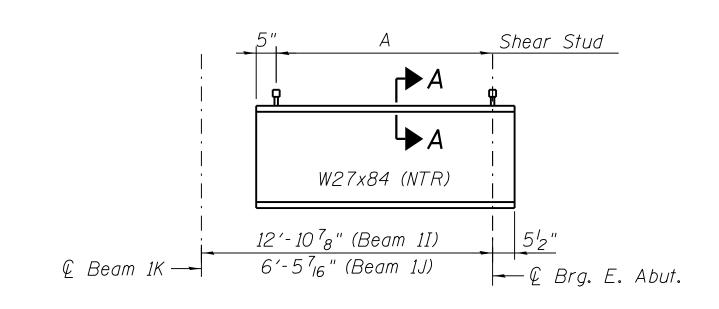


### BEAMS IF & IG

<u>BEAMS 16D & 16E</u>

BEAMS 11 & 1J


#### SHEAR STUD DIMENSIONS

Beam	А
16D	20 Spa. @ 6" (-)= 10′-0"
16E	8 Spa. @ 6" (-)= 3′-11 <sup>7</sup> 8"
16F	46 Spa. @ 6" (-)= 23′-1′ <sub>4</sub> "
16G	6 Spa. @ 6" (-)= 2′-11½"
<i>16H</i>	24 Spa. @ 6" (-)= 11′-11"
1F	15 Spa. @ 6" (-)= 7′-3"
1G	5 Spa. @ 6" (-)= 3′-8½"
1H	36 Spa. @ 6" (-)= 17′-10 <sup>3</sup> 4"
11	22 Spa. @ 6" (-)= 10′-10 <sup>5</sup> 8"
1J	9 Spa. @ 6" (-)= 4′-5½"
1K	52 Spa. @ 6" (-)= 25′-11 <sup>1</sup> 2"

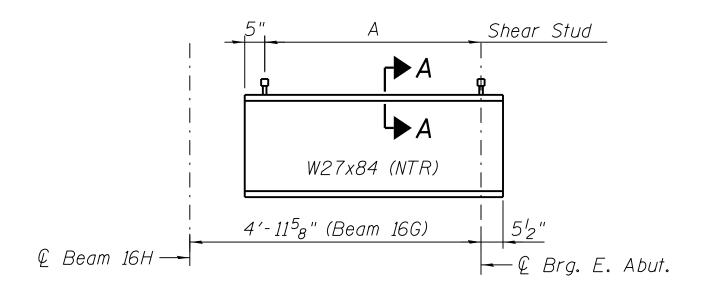

#### <u>BEAM 16G</u>

### BEAM ELEVATIONS

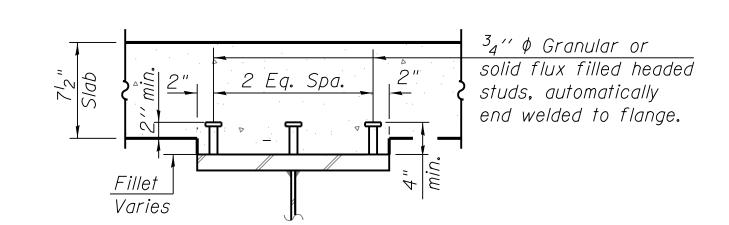

### SECTION A-A

#### *Note:*

1. Load carrying components designated "NTR" shall conform to the Impact Testing requirement, Zone 2.





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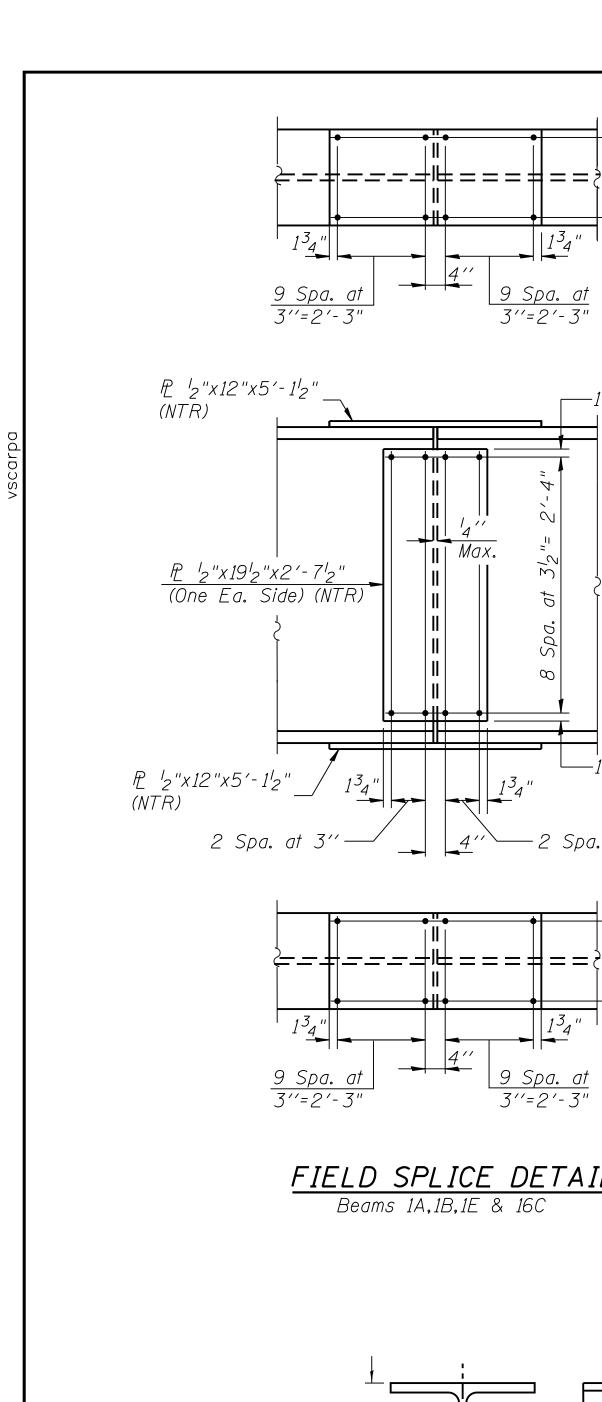
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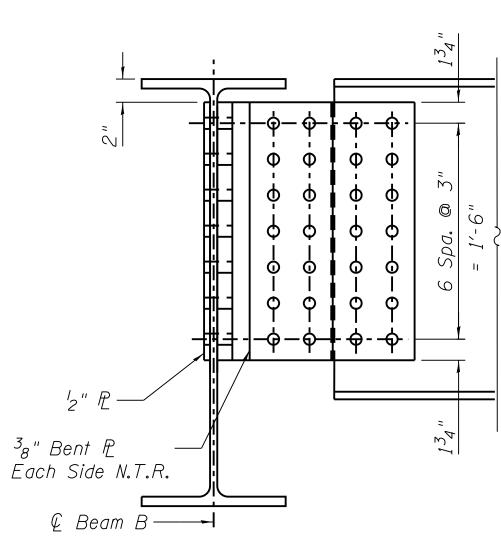
15 West 95th Street (South Terminal) Chicago, IL 60628

IN CH	ARGE	S. KADERBEK		
APPR	OVED BY	D.ZROKA		
CHEC	KED BY	P.MAID		
DESIGNED BY		L.SOMMER		
DRAV	VN BY	T.SLEDGE		
PROJ	ECT NO.	2012-0021		
FILE	NAME	File Name		
	0/0/47	ISSUED FOR CONSTRUCTION		
	2/9/17	ISSUED FOR CONSTRUCTION		
MARK	DATE	DESCRIPTION		
LOC	LOCATION IDENTIFIER: DR095			


95TH ST. BRIDGE STRUCTURAL STEEL DETAILS (SHEET 2 OF 5) SN 016-0437









SECTION C

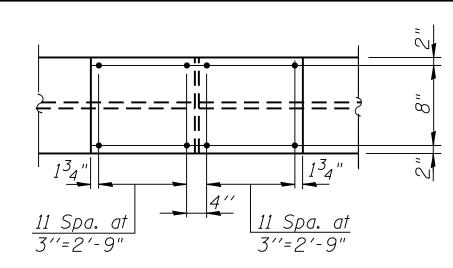


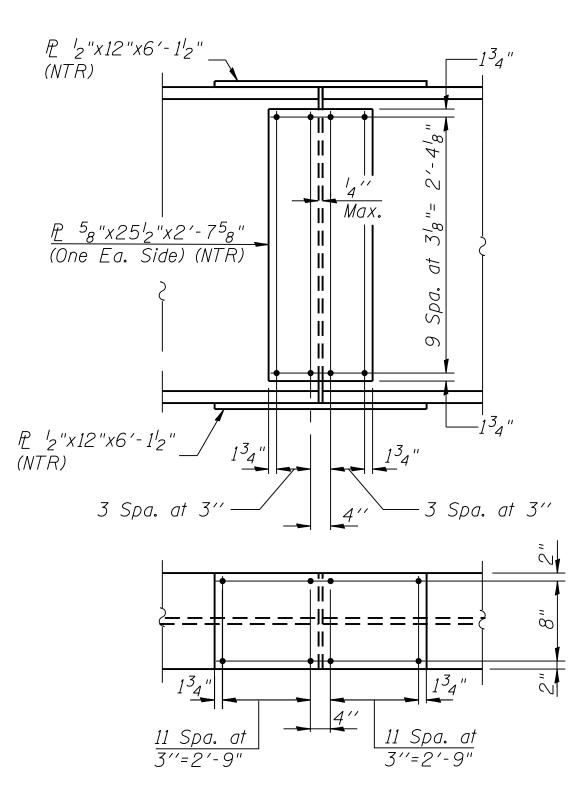


FIELD SPLICE DETAIL Beams 1C,1D,16A & 16B

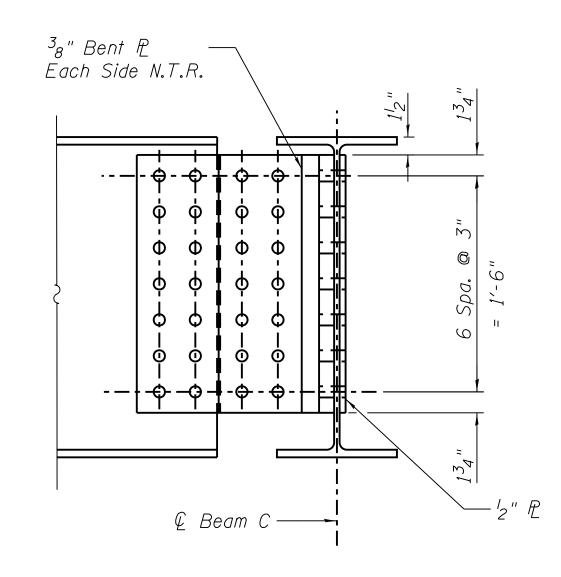

<u>SECTION D</u>

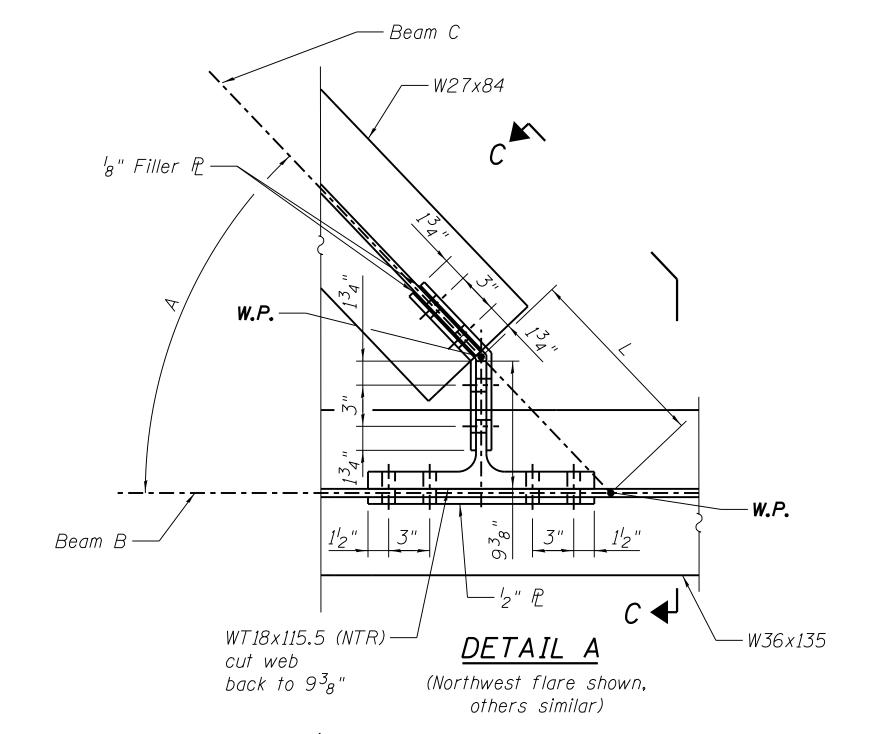

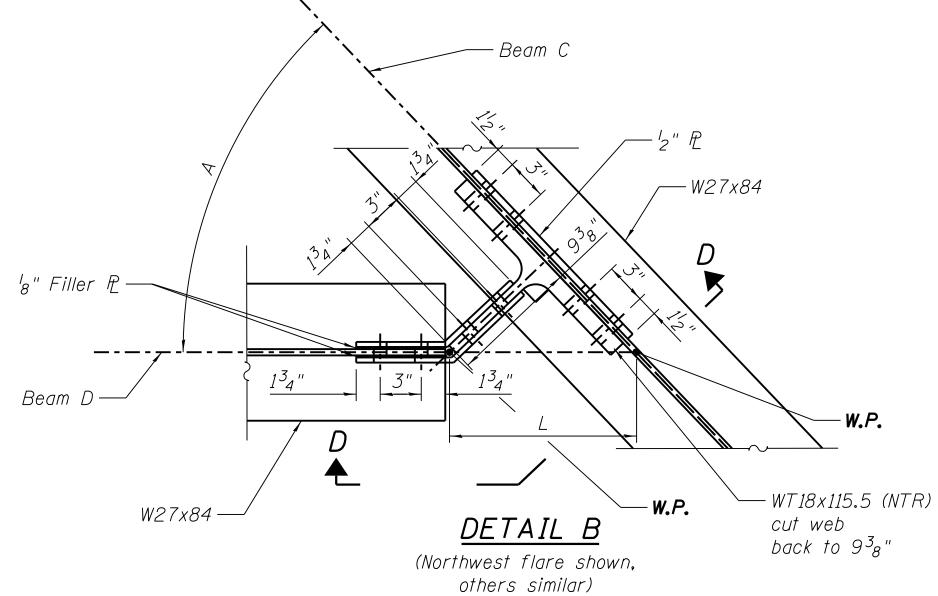

Beam B	Beam C	Beam D	Angle A	Length
			(degrees)	L
<i>16C</i>	16F	-	44.4592	1'-134"
-	<i>16F</i>	16E	44.4592	1'-134"
-	16F	16D	44.4592	1'-134"
<i>16C</i>	<i>16H</i>	-	45.0575	1'-1 <sup>5</sup> 8"
-	<i>16H</i>	16G	45.0575	1'-1 <sup>5</sup> 8"
1E	1H	-	43.7672	1'- 1 <sup>15</sup> 16 "
-	<i>1H</i>	1F	43.7672	1'- 1 <sup>15</sup> 16 "
-	1H	1G	43.7672	1'- 1 <sup>15</sup> 16 "
1E	1K	-	44.2706	1'-1 <sup>13</sup> 16 "
-	1K	11	44.2706	1'-1 <sup>13</sup> 16 "
-	1K	1J	44.2706	1'-1 <sup>13</sup> 16 "





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IN CHARGE		S. KADERBEK
APPROVED BY		D.ZROKA
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DESIG	NED BY	L.SOMMER
DRAW	'N BY	T.SLEDGE
PROJE	ECT NO.	2012-0021
FILE N	IAME	File Name
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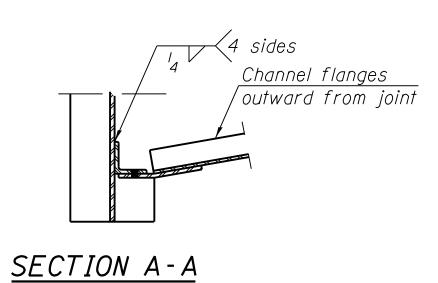
LOCATION IDENTIFIER: **DR095** 

> 95TH ST. BRIDGE STRUCTURAL STEEL DETAILS (SHEET 3 OF 5) SN 016-0437

END DIAPHRAGM, D

Two hardened washers required for each

set of oversized holes.



### INTERIOR DIAPHRAGM, DI

© 54 24"

- 6/4"

material acquisition. The alternative, if utilized,

Where new structural steel elements are connected to an existing steel member, all new fasteners shall be high strength bolts. Holes shall be subpunched or subdrilled  $^{II}_{16}$ " dia. and reamed in the field to  $^{I3}_{16}$ " dia. for  $^3_4$ " dia. bolts, unless otherwise noted. Holes shall be subpunched or subdrilled  $^{13}$ <sub>16</sub> " dia. and reamed in the field



L 6" x 4" x 12"

 $\frac{3_4}{15_{16}}$   $\phi$  H.S. Bolts Holes

Two hardened washers required for each set of oversized holes.

\*Alternate channels are permitted to facilitate shall be provided at no extra cost to the Authority.

to <sup>15</sup><sub>16</sub>" dia. for <sup>7</sup><sub>8</sub>" dia. bolts, unless noted otherwise.

For Diaphragm Supporting Canopy Column, D2, see Architectural Drawings.



\*£ C12x25

L 4" x 4" x ½"



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APPR	OVED BY	D.ZROKA
CHEC	KED BY	P.MAID
DESIG	GNED BY	L.SOMMER
DRAV	VN BY	T.SLEDGE
PROJ	ECT NO.	2012-0021
FILE I	NAME	File Name
	2/9/17	ISSUED FOR CONSTRUCTION
	_	
MARK	DATE	DESCRIPTION

LOCATION IDENTIFIER: **DR095** 

> 95TH ST. BRIDGE STRUCTURAL STEEL DETAILS (SHEET 4 OF 5) SN 016-0437

INTERIOR	GIRDER	MOMENT TABLE (BEAMS	1A, 1B, 1E,	<i>16C)</i>
		0.4 Sp. 1 or 0.6 Sp. 3	Pier	.5 Sp. 2
$I_{\mathcal{S}}$	(in <sup>4</sup> )	7,800	7,800	7,800
$I_{c}(n)$	(in <sup>4</sup> )	20,451	20,451	20,451
$I_c(3n)$	(in <sup>4</sup> )	14,908	14,908	14,908
Ss	(in <sup>3</sup> )	<i>43</i> 9	439	439
S <sub>c</sub> (n)	(in <sup>3</sup> )	641	641	641
Sc(3n)	(in <sup>3</sup> )	577	577	577
P	(k/')	.676	.676	.676
M P	('k)	333	301	148
s P	(k/')	.310	.310	.310
Ms 9	('k)	<i>153</i>	138	68
M Ł	('k)	373	298	170
M IM	('k)	94	80	51
<sup>5</sup> 3 [MŁ + <sub>I</sub> ]	('k)	778	630	368
$M_{a}$	('k)	1,643	1,390	759
$M_U$	('k)	<i>2,439</i>	-	-
$f_s$ $Q$ non-comp	(ksi)	9.3	8.4	4.1
$f_s$ $Q$ (comp)	(ksi)	<i>3.2</i>	<i>3.9</i>	1.9
$f_s$ $^53$ [M $_4$ + $M_I$ ]	(ksi)	14.6	17.5	10.3
$f_{\mathcal{S}}$ (Overload)	(ksi)	27.1	29.8	16.3
fs (Total)	(ksi)	-	<i>38.7</i>	21.2
VR	(k)	36	39.9	39.9

INTERIO	R GIRD	DER REACTION TAB	(BEA	AMS 1A,	1B,	1E,	16C)
		Abut.		ŀ	⊃ier		
R Q	(k)	31.8		6	3.7		
R4	(k)	27.5		-	35.4		
$R_I$	(k)	6.9		S	9.6		
R Total	(k)	66.2		1	08.7		

\* Compact section

	INTERIOR (	GIRDER	MOMENT TABLE (BEAMS	1C, 1D, 16A,	16B)
			0.4 Sp. 1 or 0.6 Sp. 3	Pier	.5 Sp. 2
$I_{\mathcal{S}}$		(in <sup>4</sup> )	<i>10,500</i>	10,500	10,500
$I_{c}(n)$		(in <sup>4</sup> )	22,678	22,678	22,678
$I_c(3n)$		(in <sup>4</sup> )	<i>16,323</i>	<i>16,323</i>	16,323
Ss		(in <sup>3</sup> )	580	580	580
S <sub>c</sub> (n)		(in <sup>3</sup> )	794	794	794
Sc(3n,	)	(in <sup>3</sup> )	706	706	706
P		(k/')	.642	.642	.642
M 2		('k)	709	578	439
s P		(k/')	.310	.310	.310
MsP		('k)	178	139	87
M4		('k)	194	207	137
$M_{W}$		('k)	883	643	639
Ms		('k)	602	437	435
1.3(5/3 /	MŁ)	('k)	420	449	297
	+ .5Ms	('k)	1,449	<i>1,054</i>	1,048
1.3 (M4	+.3Mw)+1.6Ms	('k)	<i>1,</i> 560	<i>1,21</i> 9	1,123
Ma		('k)	2,713	2.151	1.807
Mu		('k)	2,940	-	-
fs & no	on-comp	(ksi)	14.7	12.0	9.1
$f_{\mathcal{S}} \mathcal{P}$ (	(comp)	(ksi)	3.0	2.9	1.8
fs 4+s	;+W	(ksi)	<i>18.1</i>	19.4	17.9
fs (Ov	rerload)	(ksi)	<i>35.8</i>	34.3	28.8
	otal)	(ksi)	-	44.6	37.4
VR		(k)	37.8	47.2	47.2

L	INTERIOR	GIRL	DER REACTION TABLE (	(BEAMS 1C, 1D, 16A, 16B)
ſ			Abut.	Pier
	R Q	(k)	49.1	86.9
Ī	R4+.3W+S	(k)	61.2	95.7
	R Total	(k)	110.3	182.6

\* Compact section

 $I_s$ ,  $S_s$ : Non-composite moment of inertia and section modulus of the steel section used for computing  $f_s$  (Total and Overload) due to non-composite dead loads (in.4 and in.3).

 $I_c(n)$ ,  $S_c(n)$ : Composite moment of inertia and section modulus of the steel and deck based upon the modular ratio, "n", used for computing  $f_s$  (Total and Overload) due to short-term composite live loads (in.4 and in.3).

 $I_c(3n)$ ,  $S_c(3n)$ : Composite moment of inertia and section modulus of the steel and deck based upon 3 times the modular ratio, "3n", used for computing  $f_s$  (Total and Overload) due to long-term composite (superimposed) dead loads (in.4 and in. 3).

₽: Un-factored non-composite dead load (kips/ft.).

M 2: Un-factored moment due to non-composite dead load (kip-ft.).  $s\, Q:$  Un-factored long-term composite (superimposed) dead load (kips/ft.)

 $M_s \mathcal{Q}$ : Un-factored moment due to long-term composite (superimposed) dead load (kip-ft.).

Mt: Un-factored live load moment (kip-ft.).

MI: Un-factored moment due to impact (kip-ft.).

M<sub>4</sub>, M<sub>s</sub>, M<sub>w</sub>: Factored Moment due to Pedestrian Live Load, Snow Load, and Wind Load.

Ma: Factored design moment (kip-ft.).

1.3 [  $M_{\rm p}$  +  $M_{\rm s}$   $_{\rm p}$  +  $\frac{5}{3}$  ( $M_{\rm L}$  +  $M_{\rm I}$ )] OR 1.3 (  $M_{\rm p}$  +  $M_{\rm s}$   $_{\rm p}$  +  $M_{\rm w}$ ) + 0.5  $M_{\rm S}$  OR 1.3 (  $M_{\rm p}$  +  $M_{\rm s}$   $_{\rm p}$  +  $M_{\rm L}$  + .3 $M_{\rm w}$ ) + 1.6  $M_{\rm S}$   $M_{\rm u}$ : Compact composite moment capacity according to AASHTO LFD 10.50.1.1 or compact non-composite moment capacity according to AASHTO LFD 10.48.1 (kip-ft.).

 $f_s$  (Overload): Sum of stresses as computed from the moments below (ksi). MP +  $M_s$ P +  $\frac{5}{3}$  (M½ +  $M_I$ )

 $f_s$  (Total): Sum of stresses as computed from the moments below on non-compact section (ksi).

1.3 [M2 + Ms2 +  $\frac{5}{3}$  (M½ + M<sub>1</sub>)]

 $OR 1.3 (M_{\tilde{Q}} + M_{\tilde{S}} \tilde{Q} + M_{W}) + 0.5 M_{S}$ OR 1.3 ( $M_{p}^{\tau} + M_{s} p + M_{4}^{\tau} + .3M_{W}$ ) + 1.6  $M_{s}$ 

VR: Maximum 4 + impact shear range within the composite portion of the span for stud shear connector design (kips).

Moments in Span 2 are negative.





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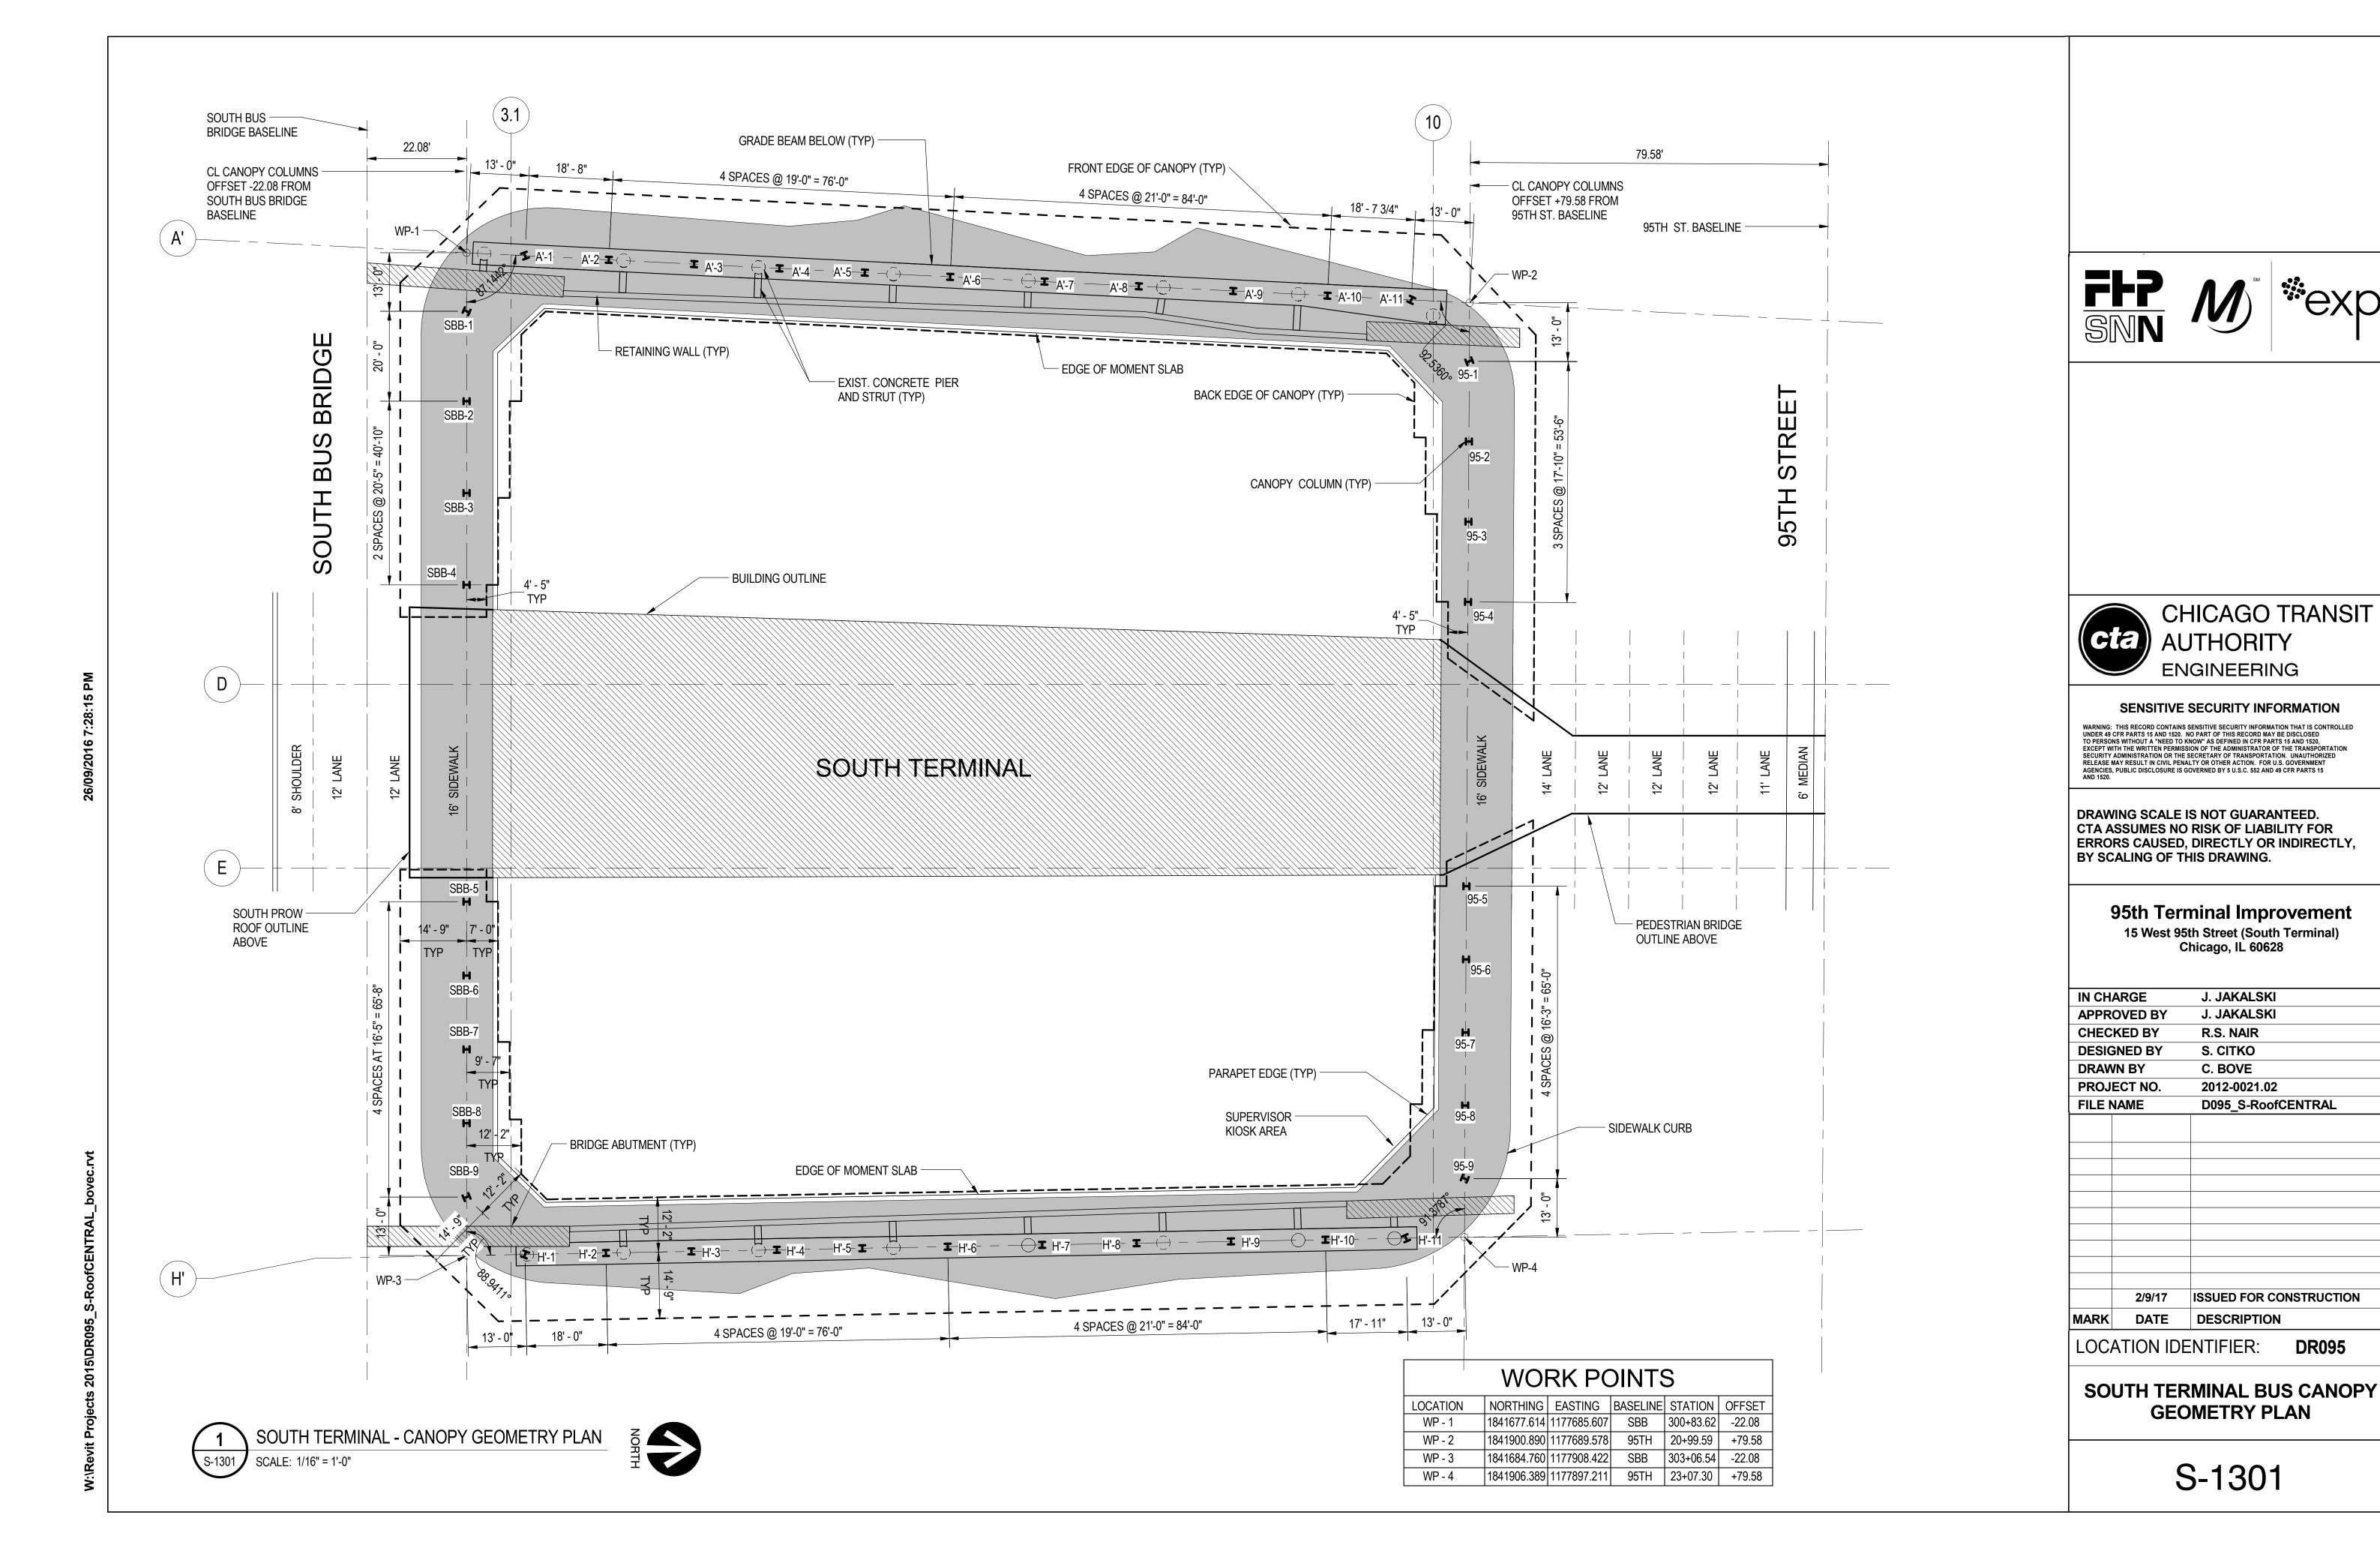
IN CH	ARGE	S. KADERBEK
APPROVED BY		D.ZROKA
CHECKED BY		P.MAID
DESIC	SNED BY	L.SOMMER
DRAV	VN BY	T.SLEDGE
PROJ	ECT NO.	2012-0021
FILE N	NAME	File Name
	0/0/4=	ISSUED FOR CONSTRUCTION
	2/9/17	ISSUED FOR CONSTRUCTION
IARK	DATE	DESCRIPTION
$\cap$ C	ATION IDE	NITICICO: DDAGE


LOCATION IDENTIFIER:

95TH ST. BRIDGE STRUCTURAL STEEL DETAILS (SHEET 5 OF 5) SN 016-0437

<sup>\*\*</sup> Braced non-compact and partially braced section

<sup>\*\*</sup> Braced non-compact and partially braced section



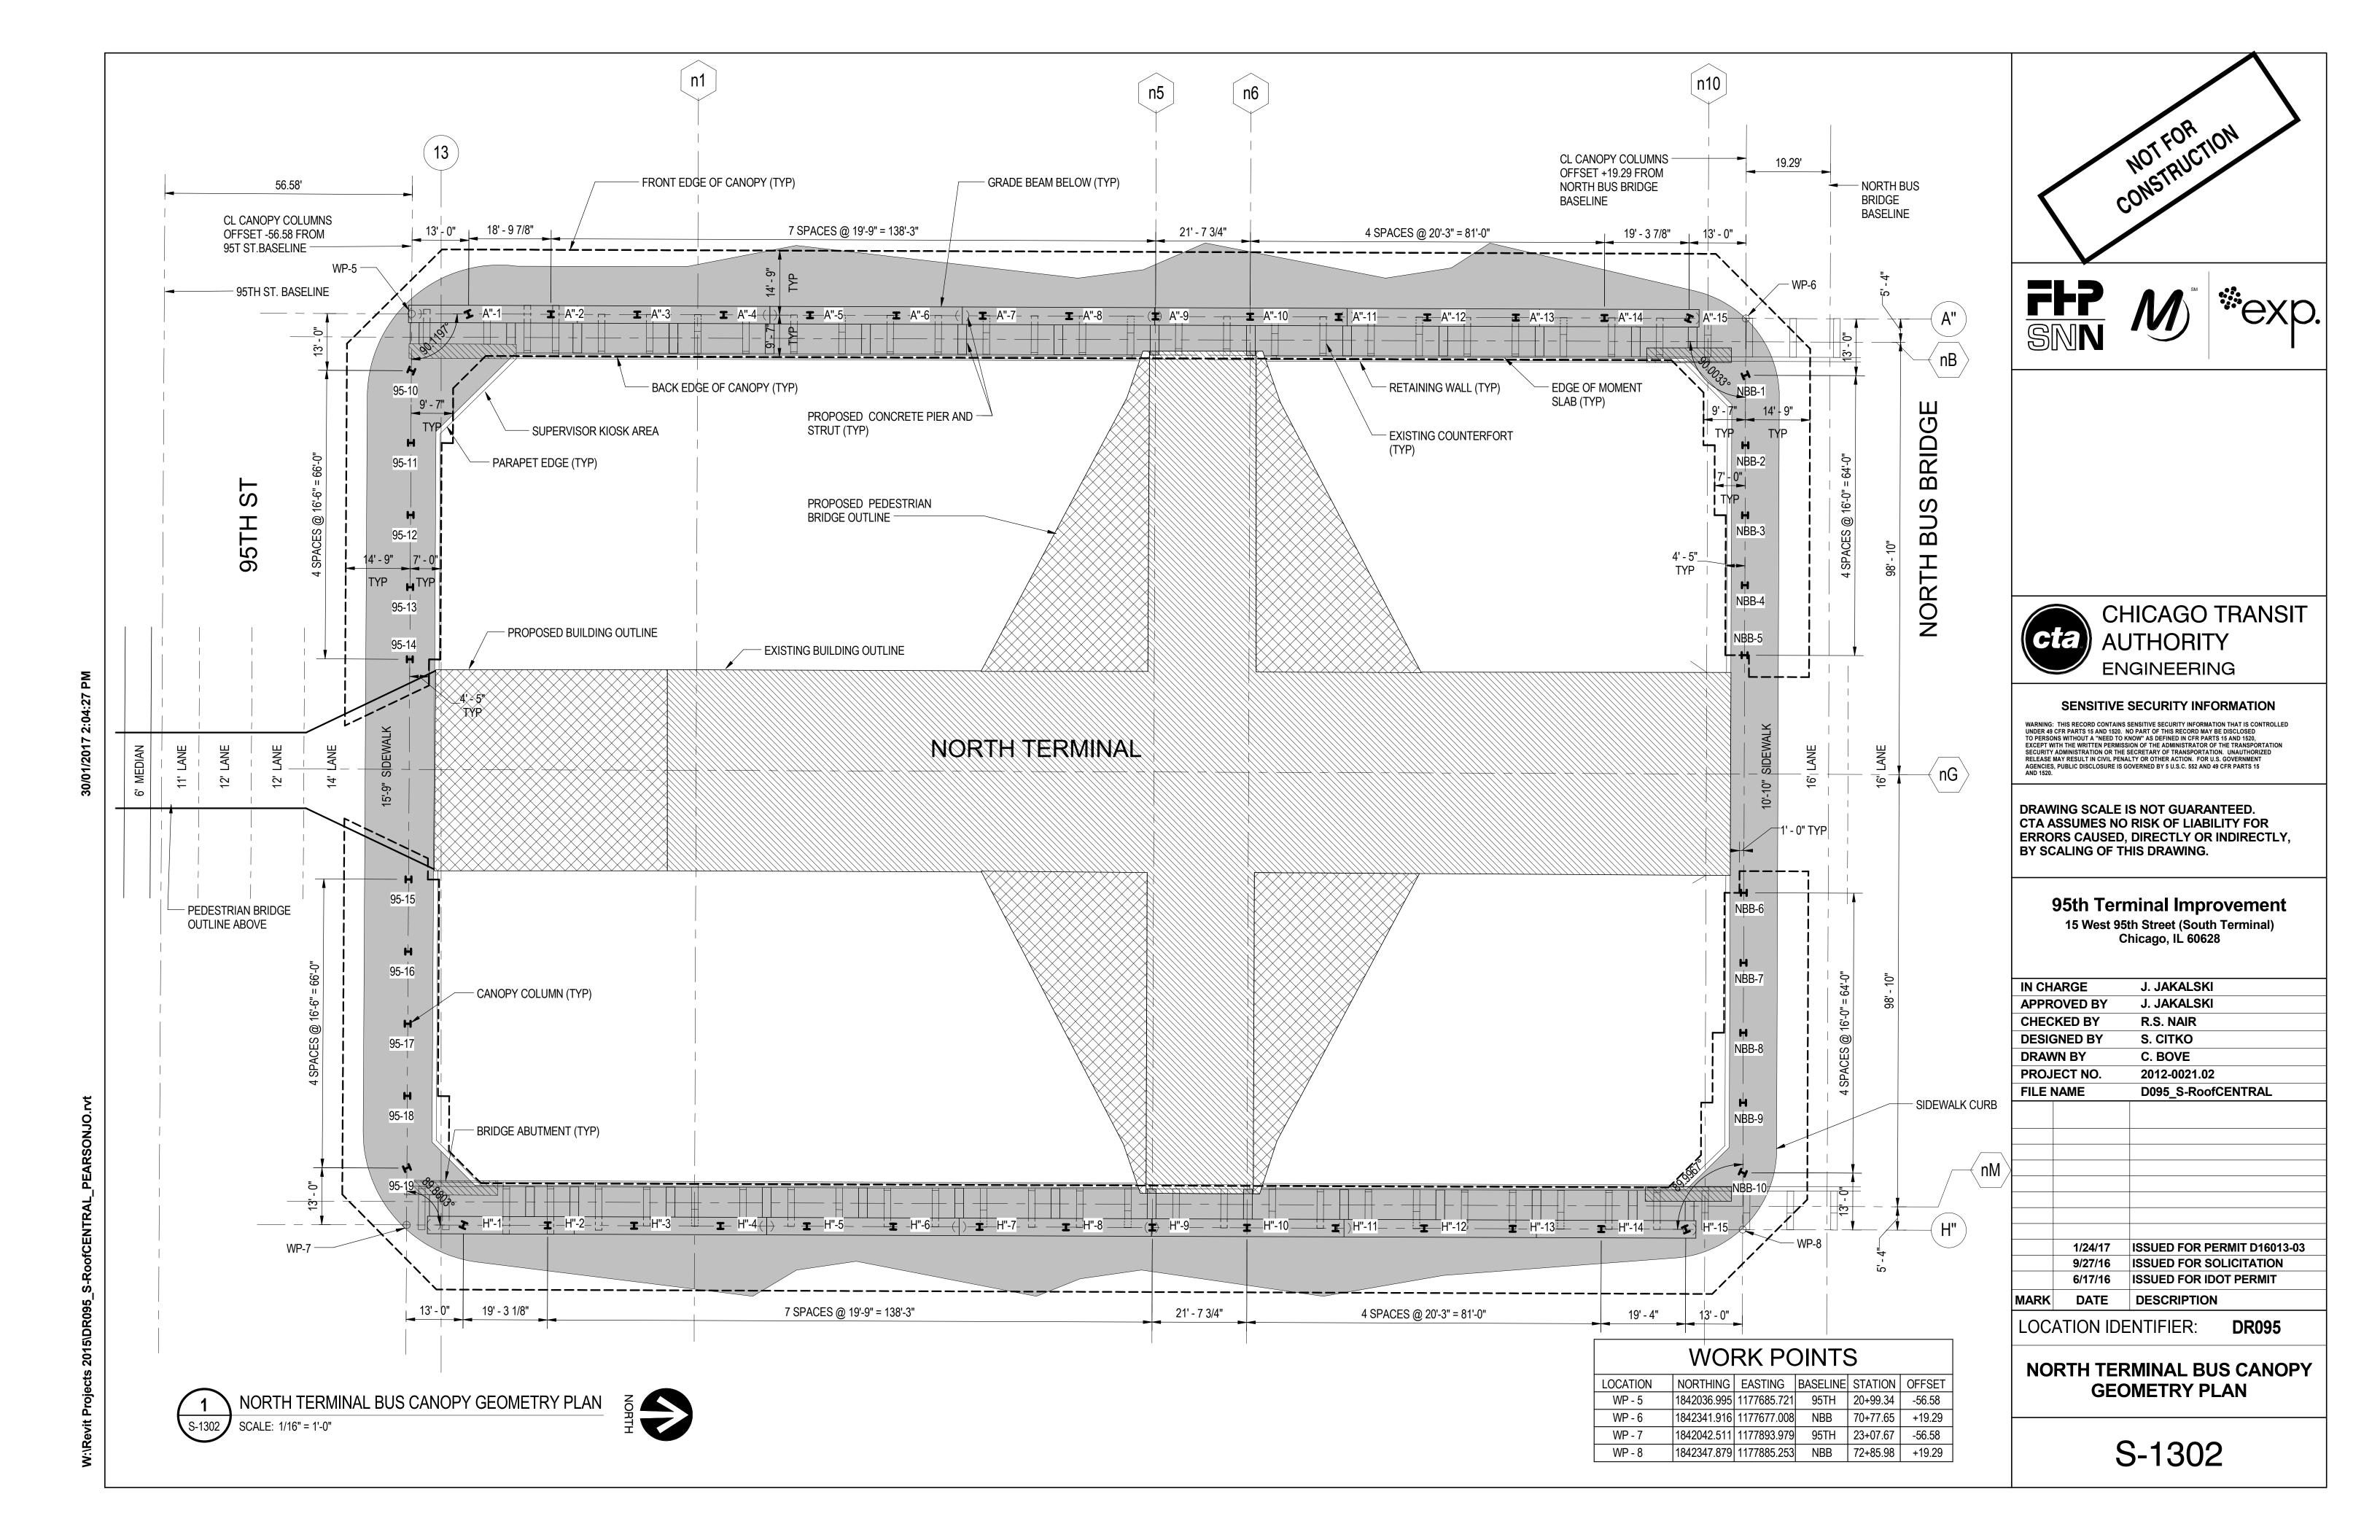

SECTION A-A BEARING ASSEMBLY

Fill plates and shim plates shall not be placed under Bearing Assembly.

³₄′′ ¢ Threaded Stud with flat washer &

6 Layers of <sup>l</sup>2"

Elastomer

5<sup>-</sup>/<sub>8</sub>" Steel Plates

hex nut. (4-Reqd.)

-P 1<sup>3</sup>4"x1'-0"x1'-6"

€ <sup>7</sup>8" ¢ Hole-1<sub>4</sub> " Stainless steel plate, A240, Type 304, No. 1 finish

SIDE RETAINER

will be allowed in lieu of welded plates.

Equivalent rolled angle with stiffeners

ELEVATION AT ABUT.


TYPE I ELASTOMERIC EXP. BRG.


EAST ABUTMENT BEARINGS

Bonded-


Beams 1C,1D,16A & 16B

At East Abutment, add  $\frac{3}{16}$ " x 1'-0" x 1'-6" fill plate for beam 16A

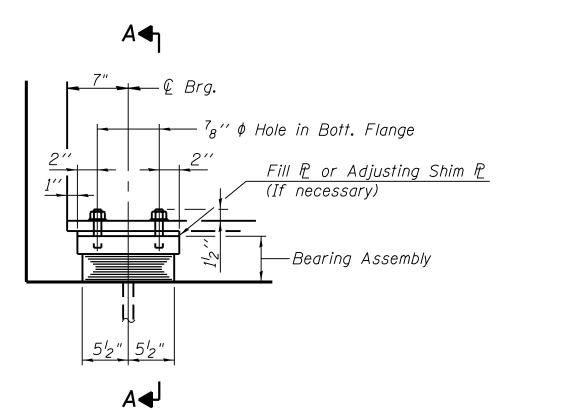

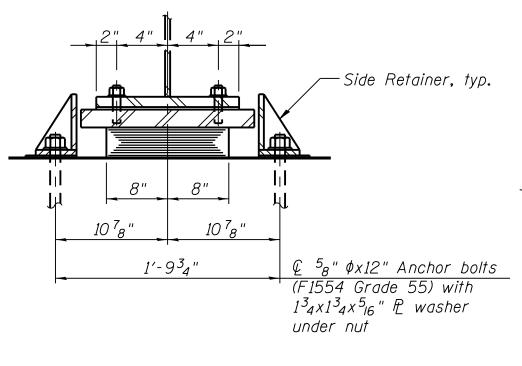


SECTION A-A

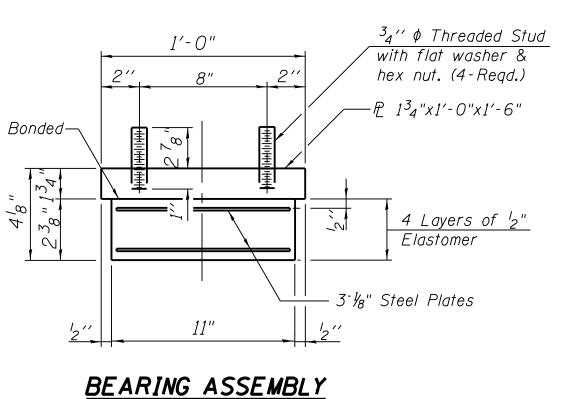

Fill plates and shim plates shall not

be placed under Bearing Assembly.

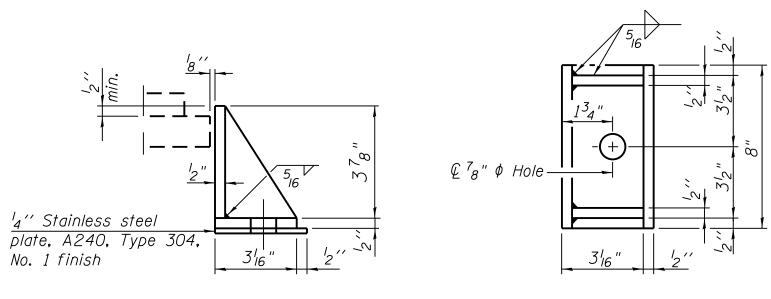

No. 1 finish

SIDE RETAINER Equivalent rolled angle with stiffeners will be allowed in lieu of welded plates.

ELEVATION AT ABUT.

TYPE I ELASTOMERIC EXP. BRG.

WEST ABUTMENT BEARINGS

Beams 1C,1D,16A & 16B

At West Abutment, Beam 16B add  $\frac{3}{16}$ " x 1'-0" x 1'-6" fill plate.

Anchor bolts shall be ASTM F1554 all-thread (or an Engineer-approved alternate material) of the grade(s) and diameter(s) specified. The corresponding specified grade of AASHTO M314 anchor bolts may be used in lieu of ASTM F1554.

Side retainers and other steel members required for the elastomeric bearing assembly shall be included in the cost of Elastomeric Bearing Assembly, Type I. Beams shall be braced for stability during erection and

remain braced until deck is poured and cured. Anchor bolts and side retainers at all supports shall be installed as each member is erected unless an

equivalent temporary means of lateral restraint is used.

**CHICAGO TRANSIT AUTHORITY ENGINEERING** 

**SENSITIVE SECURITY INFORMATION** 

WARNING: THIS RECORD CONTAINS SENSITIVE SECURITY INFORMATION THAT IS CONTROLLED UNDER 49 CFR PARTS 15 AND 1520. NO PART OF THIS RECORD MAY BE DISCLOSED TO PERSONS WITHOUT A "NEED TO KNOW" AS DEFINED IN CFR PARTS 15 AND 1520, EXCEPT WITH THE WRITTEN PERMISSION OF THE ADMINISTRATOR OF THE TRANSPORTATION EALER I WITH THE WRITTEN PERMISSION OF THE ADMINISTRATOR OF THE TRANSPOR SECURITY ADMINISTRATION OR THE SECRETARY OF TRANSPORTATION. UNAUTHORIX RELEASE MAY RESULT IN CIVIL PENALTY OR OTHER ACTION. FOR U.S. GOVERNMENT AGENCIES, PUBLIC DISCLOSURE IS GOVERNED BY 5 U.S.C. 552 AND 49 CFR PARTS 15 AND 1520.

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95th Terminal Improvement


15 West 95th Street (South Terminal) Chicago, IL 60628


IN CHARGE S. KADERBEK APPROVED BY D.ZROKA CHECKED BY P.MAID L.SOMMER **DESIGNED BY** DRAWN BY T.SLEDGE PROJECT NO. 2012-0021 FILE NAME File Name 2/9/17 ISSUED FOR CONSTRUCTION MARK DATE DESCRIPTION

LOCATION IDENTIFIER: **DR095** 

> 95TH ST. BRIDGE **BEARING DETAILS** (SHEET 1 OF 5) SN 016-0437



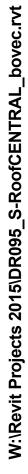

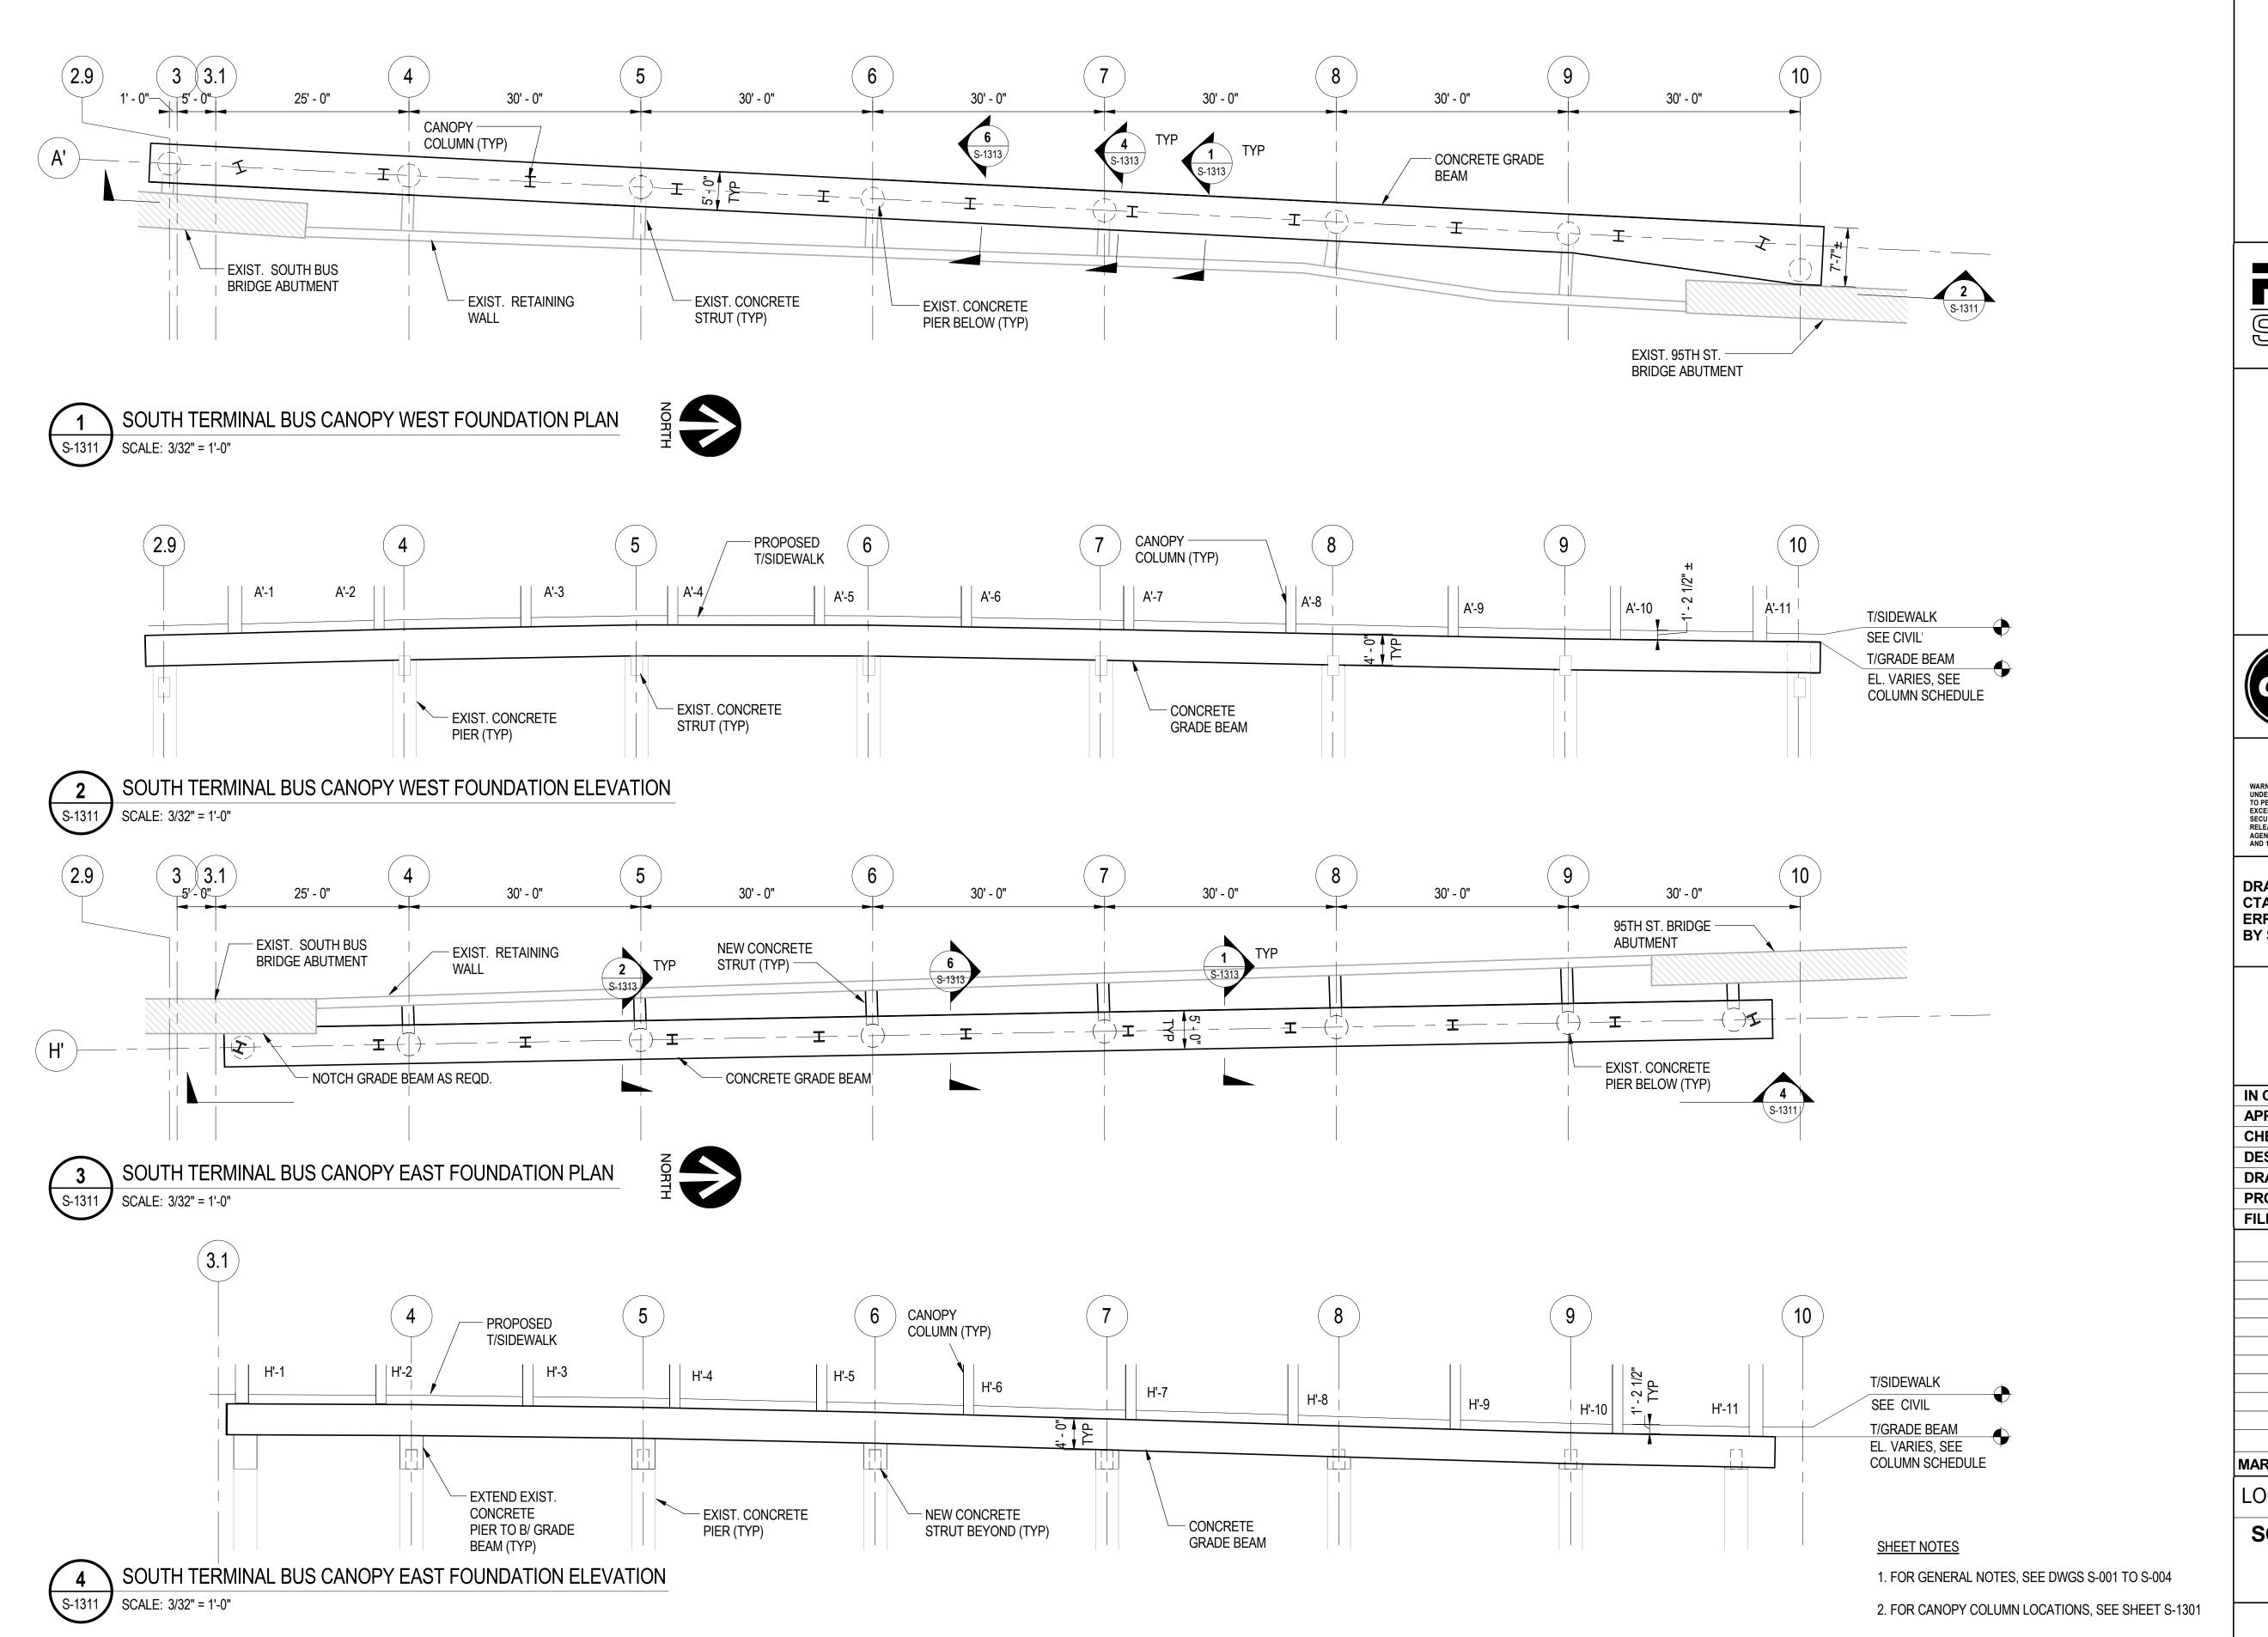

FFP M \*exp.



#### SENSITIVE SECURITY INFORMATION

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### 95th Terminal Improvement 15 West 95th Street (South Terminal)

15 West 95th Street (South Terminal) Chicago, IL 60628


MARK	DATE	DESCRIPTION
	2/9/17	ISSUED FOR CONSTRUCTION
FILE N	NAME	D095_S-RoofCENTRAL
PROJECT NO.		2012-0021.02
	/N BY	C. BOVE
DESIC	ENED BY	S. CITKO
CHEC	KED BY	R.S. NAIR
APPR	OVED BY	J. JAKALSKI
IN CH	ARGE	J. JAKALSKI

LOCATION IDENTIFIER: DR095

#### SOUTH TERMINAL BUS CANOPY FOUNDATION PLANS & ELEVATIONS






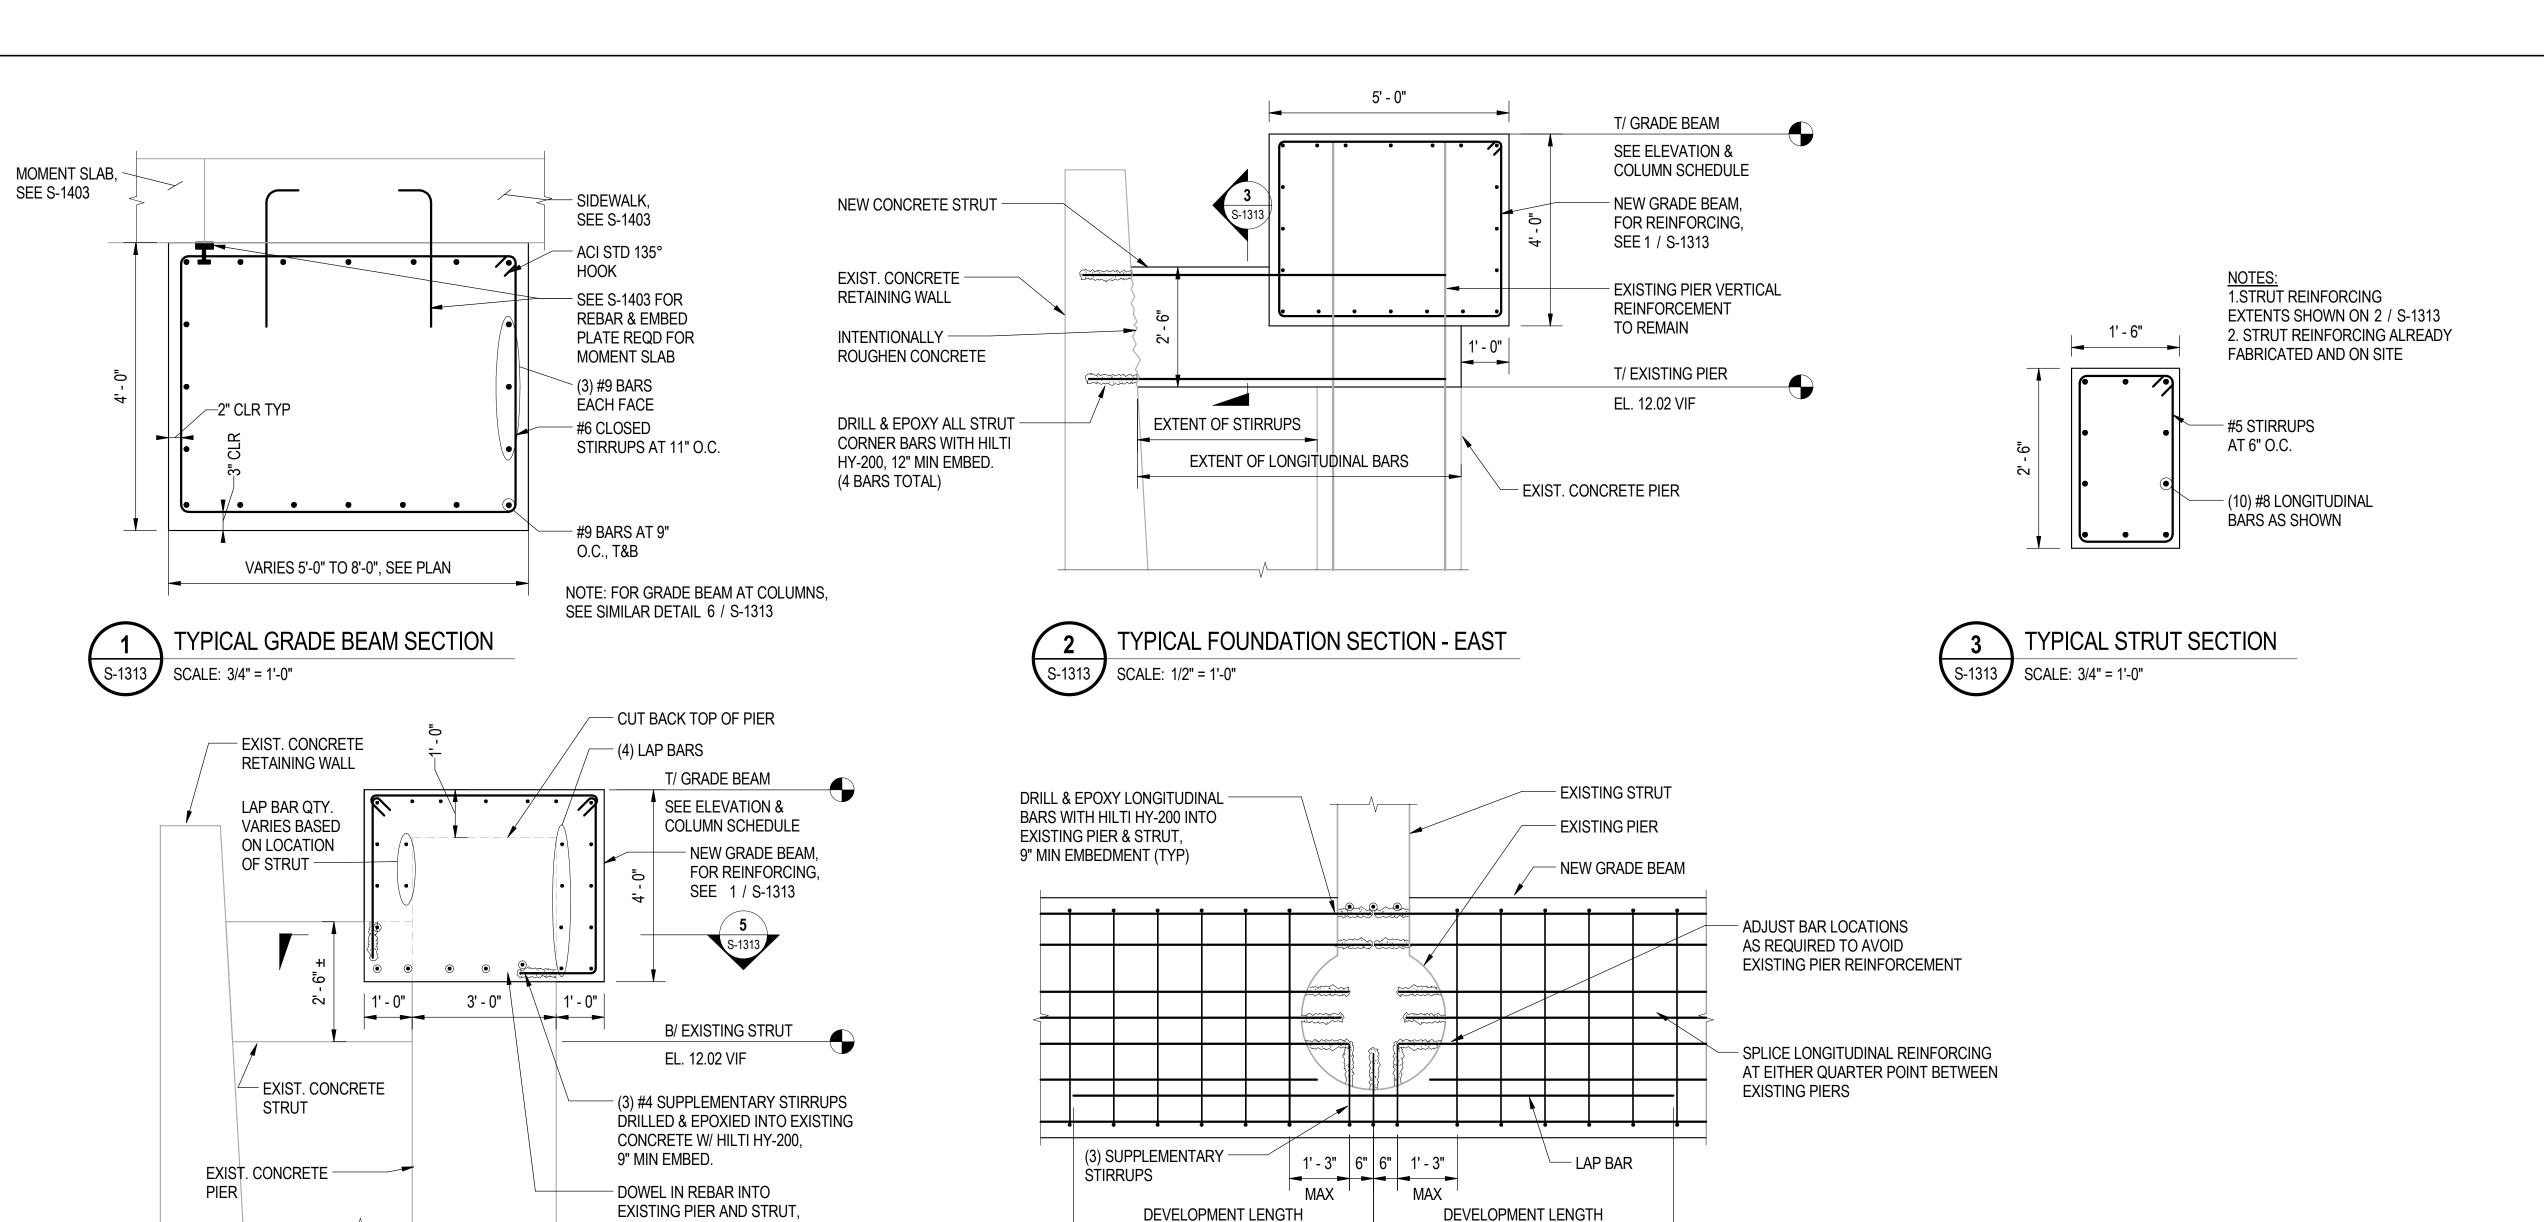

S-1313

TYPICAL FOUNDATION SECTION - WEST

SCALE: 1/2" = 1'-0"

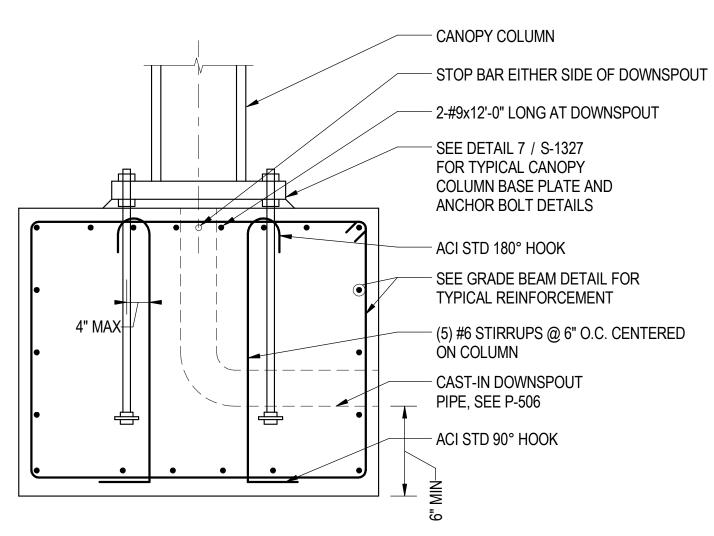

SEE 5 / S-1313<sub>TYP</sub>

REINFORCEMENT AT CANOPY COLUMN BASE PLATE S-1313 SCALE: 3/4" = 1'-0"

DETAIL- BOTTOM REINFORCEMENT PLAN S-1313 SCALE: 1/2" = 1'-0"

SHEET NOTES

1. FOR GENERAL NOTES, SEE DWGS S-001 TO S-004



cta

#### **SENSITIVE SECURITY INFORMATION**

**ENGINEERING** 

**AUTHORITY** 

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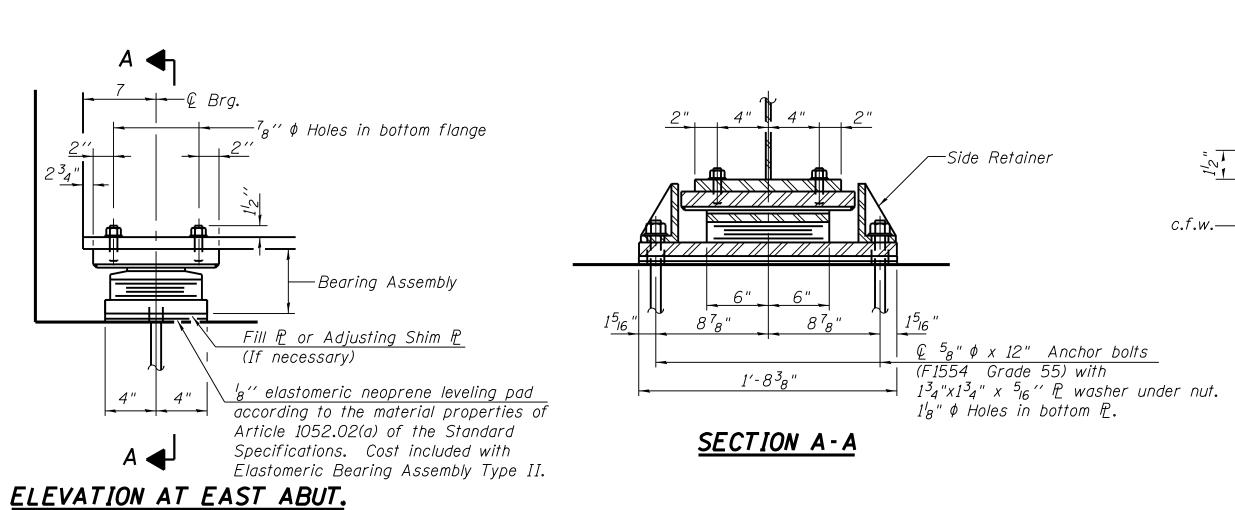
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### 95th Terminal Improvement

15 West 95th Street (South Terminal) Chicago, IL 60628

IN CH	ARGE	J. JAKALSKI
APPROVED BY		J. JAKALSKI
CHEC	KED BY	R.S. NAIR
DESIG	NED BY	S. CITKO
PROJECT NO.		C. BOVE
		2012-0021.02
FILE N	IAME	D095_S-RoofCENTRAL
	2/9/17	ISSUED FOR CONSTRUCTION
MARK	DATE	DESCRIPTION
	ATION IDI	ENTIFIER: <b>DR095</b>

**SOUTH TERMINAL BUS CANOPY FOUNDATION DETAILS** 




TYPE II ELASTOMERIC EXP. BRG.

SIDE RETAINER


will be allowed in lieu of welded plates.

Equivalent rolled angle with stiffeners

#### P 134"x812"x1'-2" 1/4" \$ Dimples on 1/2" centers .'' Max. s'' deep, or equivalent. 8" PTFE with dimpled, —′<sub>16</sub>′′ Stainless Steel unlubricated surface OOOOTOP BEARING ASSEMBLY PTFE Surface 000

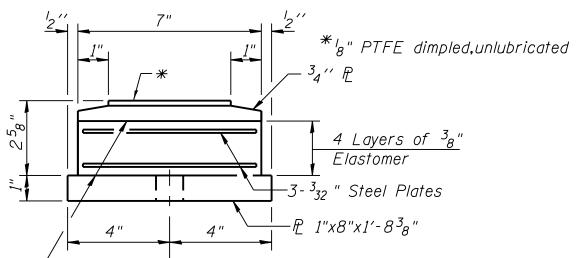



³₄′′ ¢ Threaded Stud with flat washer & hex. nut. (4 Reg'd.)

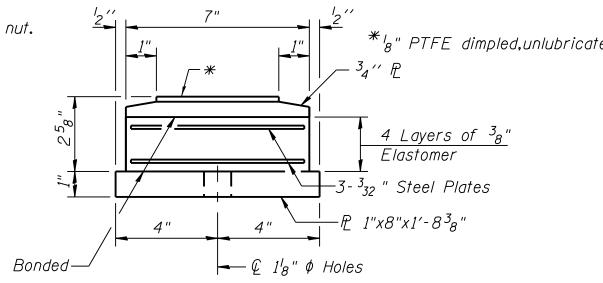



4/2"

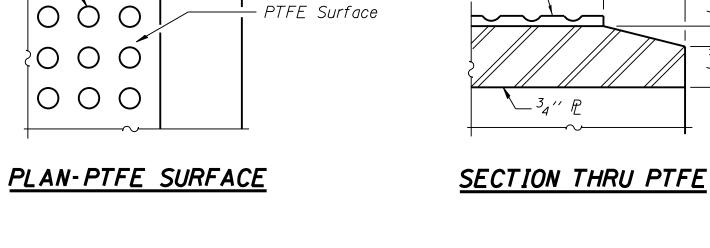

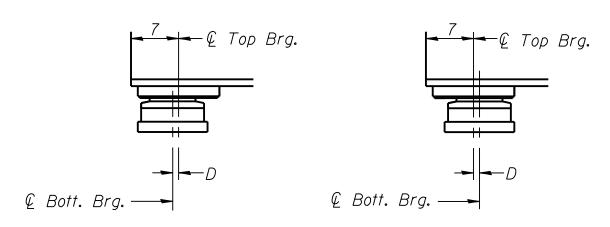

BELOW 50°F. ABOVE 50°F.  $D={}^{l}8$ " per each 100' of expansion for every 15° temp. change from the normal temp. of 50°F.

#### EXPANSION BEARING ORIENTATION


The above diagrams are for informational purposes only to show the amount of expected offset "D" for the current temperature in the field.

Anchor bolts shall be ASTM F1554 all-thread (or an Engineer-approved alternate material) of the grade(s) and diameter(s) specified. The corresponding specified grade of AASHTO M314 anchor bolts may be used in lieu of ASTM F1554.

Side retainers and other steel members required for the elastomeric bearing assembly shall be included in the cost of Elastomeric Bearing Assembly, Type I.

Beams shall be braced for stability during erection and remain braced until deck is poured and cured.

Anchor bolts and side retainers at all supports shall be installed as each member is erected unless an equivalent temporary means of lateral restraint is used. For steel extensions see sheet S-132.B.

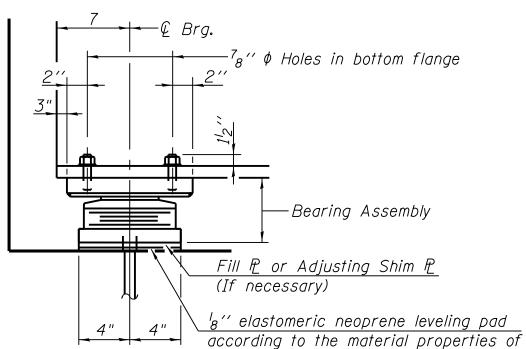


1<sub>4</sub> " Stainless steel

No. 1 finish

plate, A240, Type 304


Article 1052.02(a) of the Standard Specifications. Cost included with Elastomeric Bearing Assembly Type II.

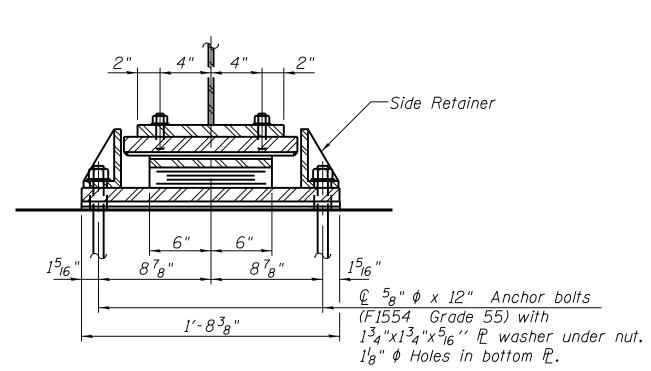

95th EAST ABUTMENT

SECTION A-A

#### TOP BEARING ASSEMBLY

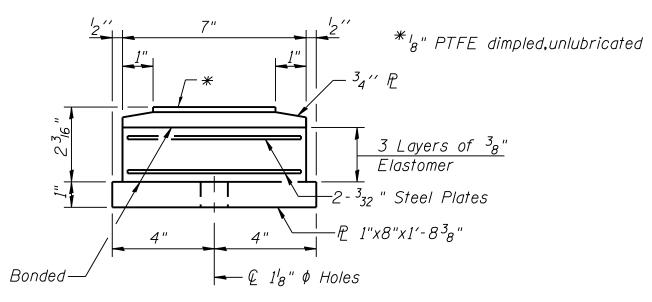

└─'<sub>16</sub>'' Stainless Steel

³₄′′ ¢ Threaded Stud

with flat washer &


hex. nut. (4 Reg'd.)

- ₱ 1³₄"x8"x1'-2"

BOTTOM BEARING ASSEMBLY



#### TYPE II ELASTOMERIC EXP. BRG.

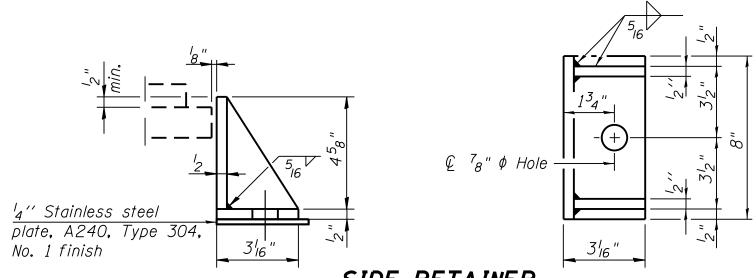

SIDE RETAINER Equivalent rolled angle with stiffeners will be allowed in lieu of welded plates.

> 95th WEST ABUTMENT Beams 1A, 1B, 1E, 1H, 16C & 16F

### FILL PLATE TABLE

Wes	t Abutment	East Abutment		
Beam		Beam		
1B	<sup>7</sup> <sub>16</sub> " x 8" x 1'-2"	1B	<sup>5</sup> <sub>16</sub> " x 8 <sup>1</sup> <sub>2</sub> " x 1'-2"	
1H	<sup>9</sup> 16" x 8" x 1'-2"	16C	<sup>5</sup> 8" x 8 <sup>1</sup> 2" x 1'-2"	
16F	<sup>1</sup> 2" x 8" x 1'-2"	16H	1 <sub>6</sub> " x 8 <sup>1</sup> 2" x 1'-2"	
	Beam 1B 1H	1B 7 <sub>16</sub> " x 8" x 1'-2" 1H 9 <sub>16</sub> " x 8" x 1'-2"	Beam       Beam         1B       7 <sub>16</sub> " x 8" x 1'-2"       1B         1H       9 <sub>16</sub> " x 8" x 1'-2"       16C	



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#### 95th Terminal Improvement

15 West 95th Street (South Terminal) Chicago, IL 60628


MARK	DATE	DESCRIPTION
	2/9/17	ISSUED FOR CONSTRUCTION
FILE N	NAME	File Name
PROJ	ECT NO.	2012-0021
DRAV	VN BY	T.SLEDGE
DESIC	SNED BY	L.SOMMER
CHEC	KED BY	P.MAID
APPR	OVED BY	D.ZROKA
IN CH	ARGE	S. KADERBEK

LOCATION IDENTIFIER: **DR095** 

> 95TH ST. BRIDGE **BEARING DETAILS** (SHEET 2 OF 5) SN 016-0437

95TH-S-132

FILE NAME

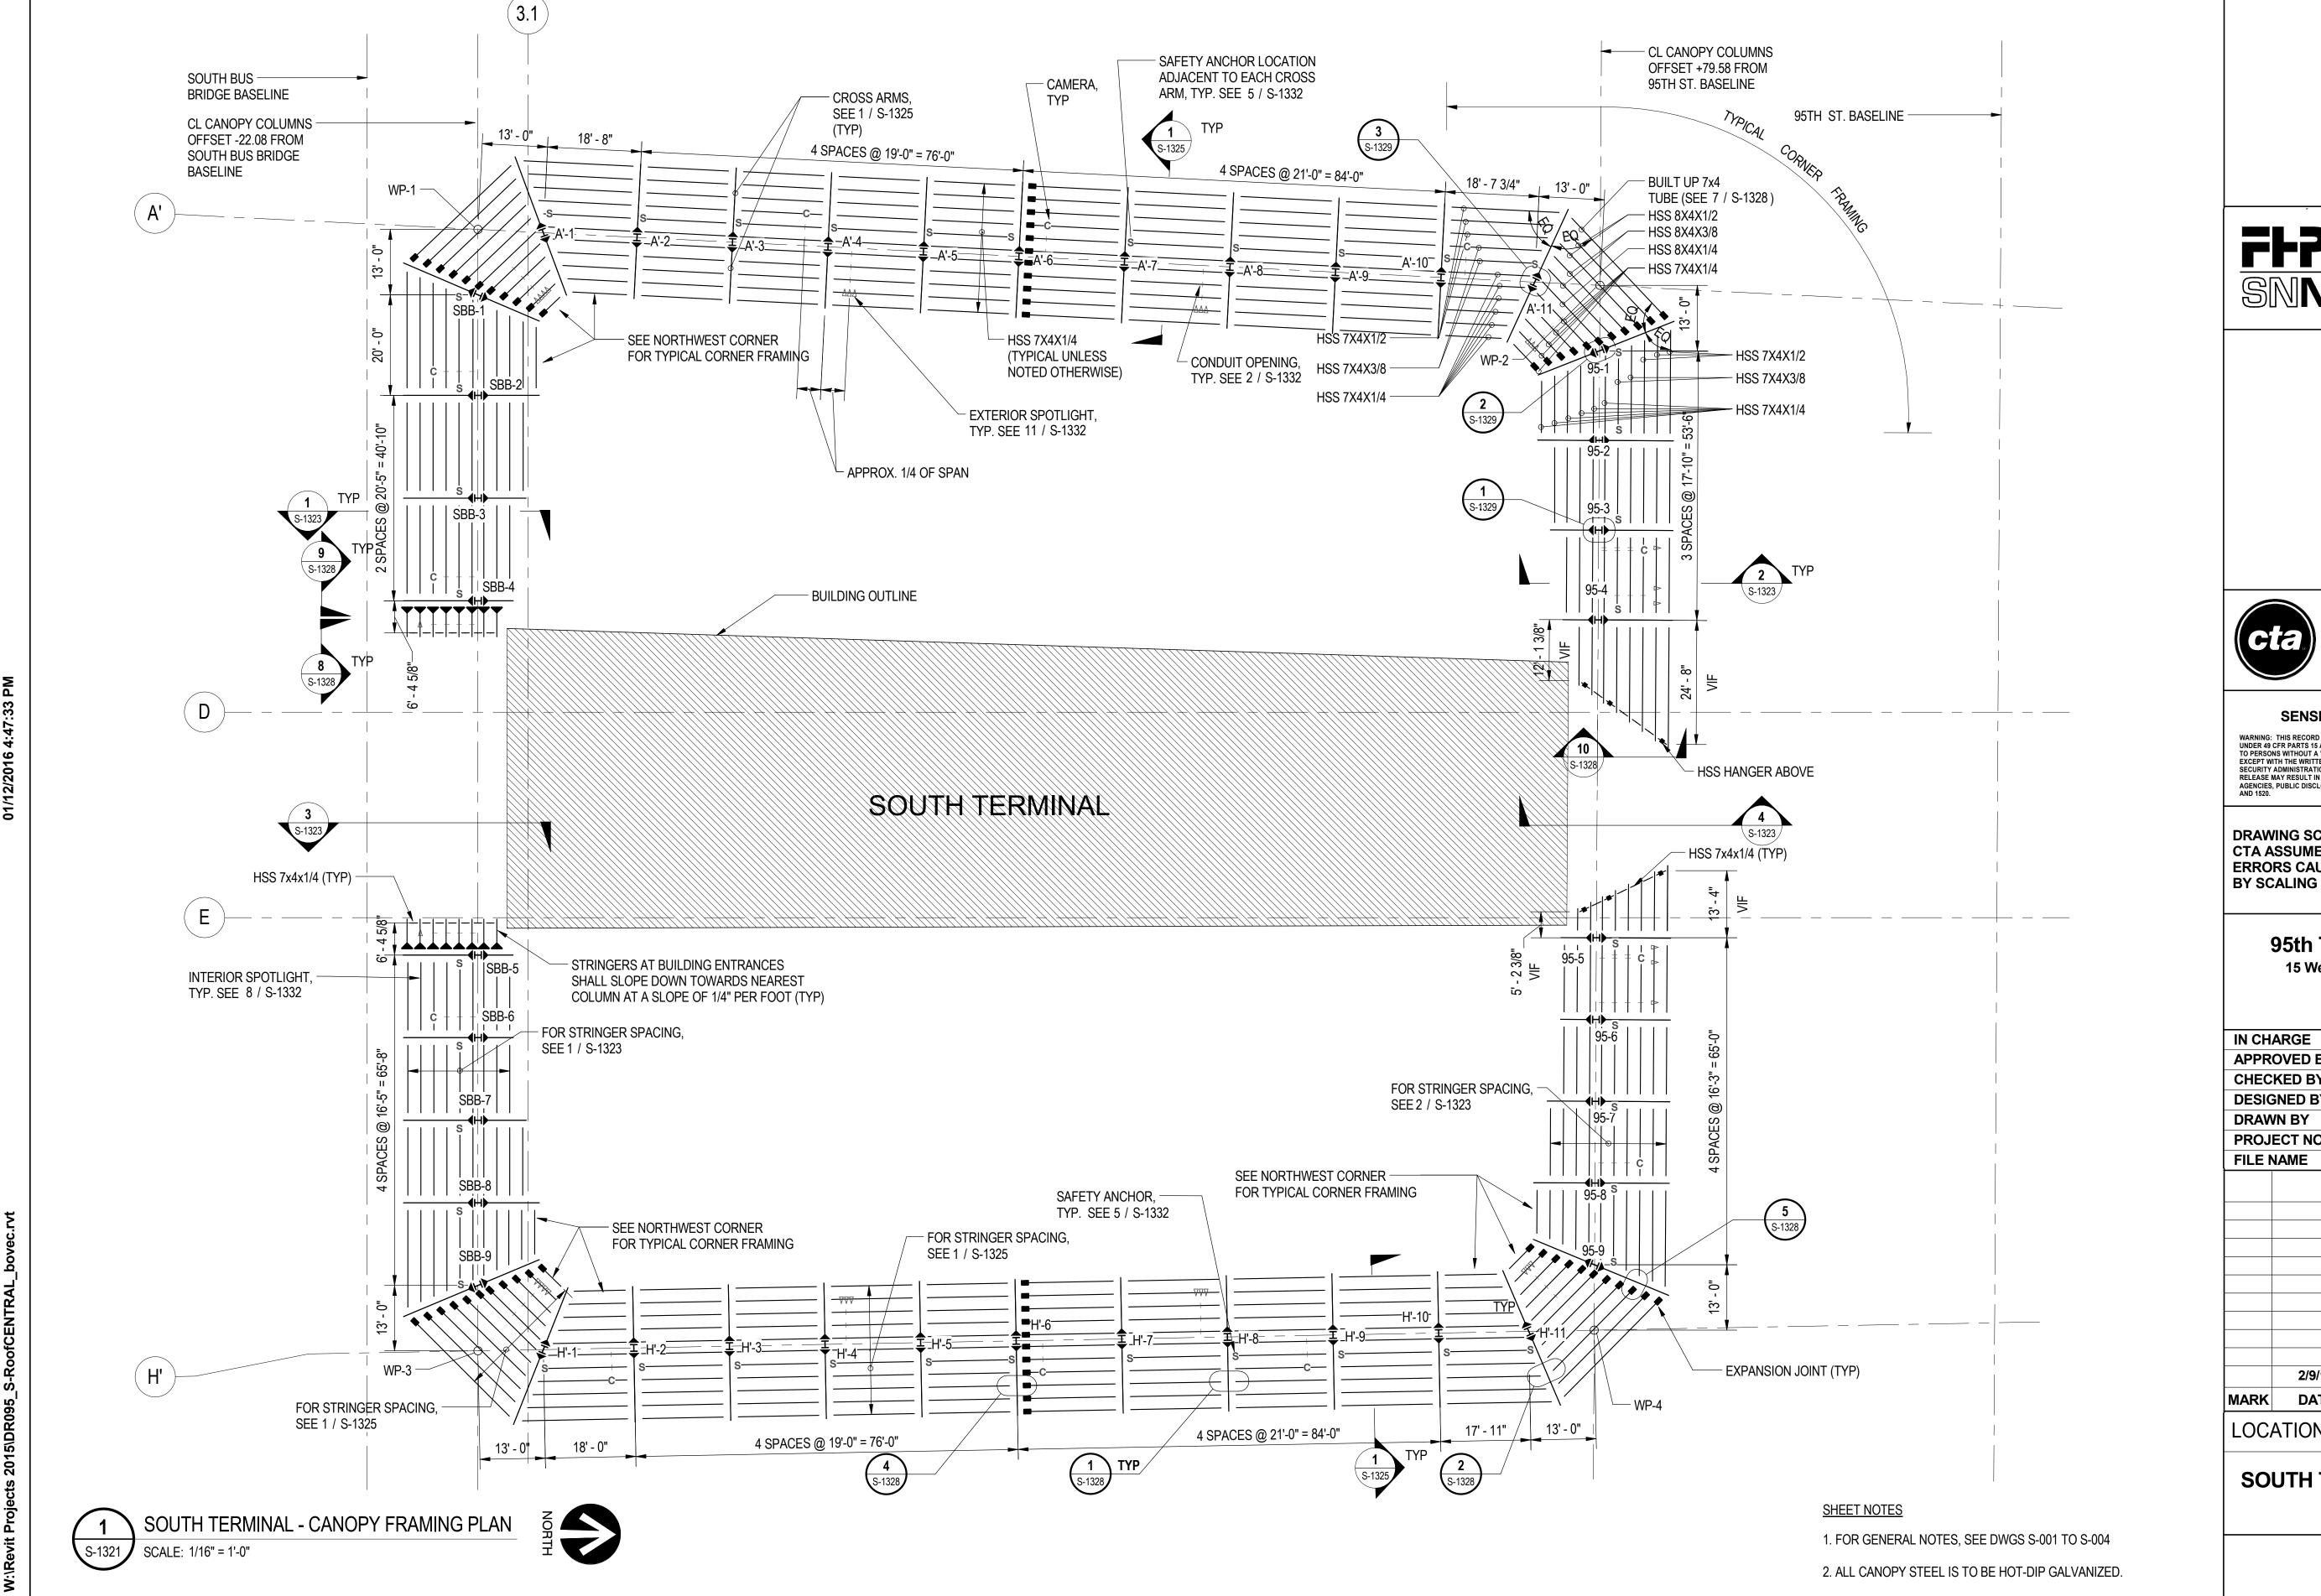





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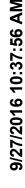
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### 95th Terminal Improvement 15 West 95th Street (South Terminal)


15 West 95th Street (South Terminal) Chicago, IL 60628

IN CH	ARGE	J. JAKALSKI
APPRO	OVED BY	J. JAKALSKI
CHEC	KED BY	R.S. NAIR
DESIG	NED BY	S. CITKO
DRAW	N BY	C. BOVE
PROJ	ECT NO.	2012-0021.02
FILE N	IAME	D095_S-RoofCENTRAL
	0/0/47	IOOUED FOR CONCERNATION
	2/9/17	ISSUED FOR CONSTRUCTION
MARK	DATE	DESCRIPTION

SOUTH TERMINAL BUS CANOPY FRAMING PLAN





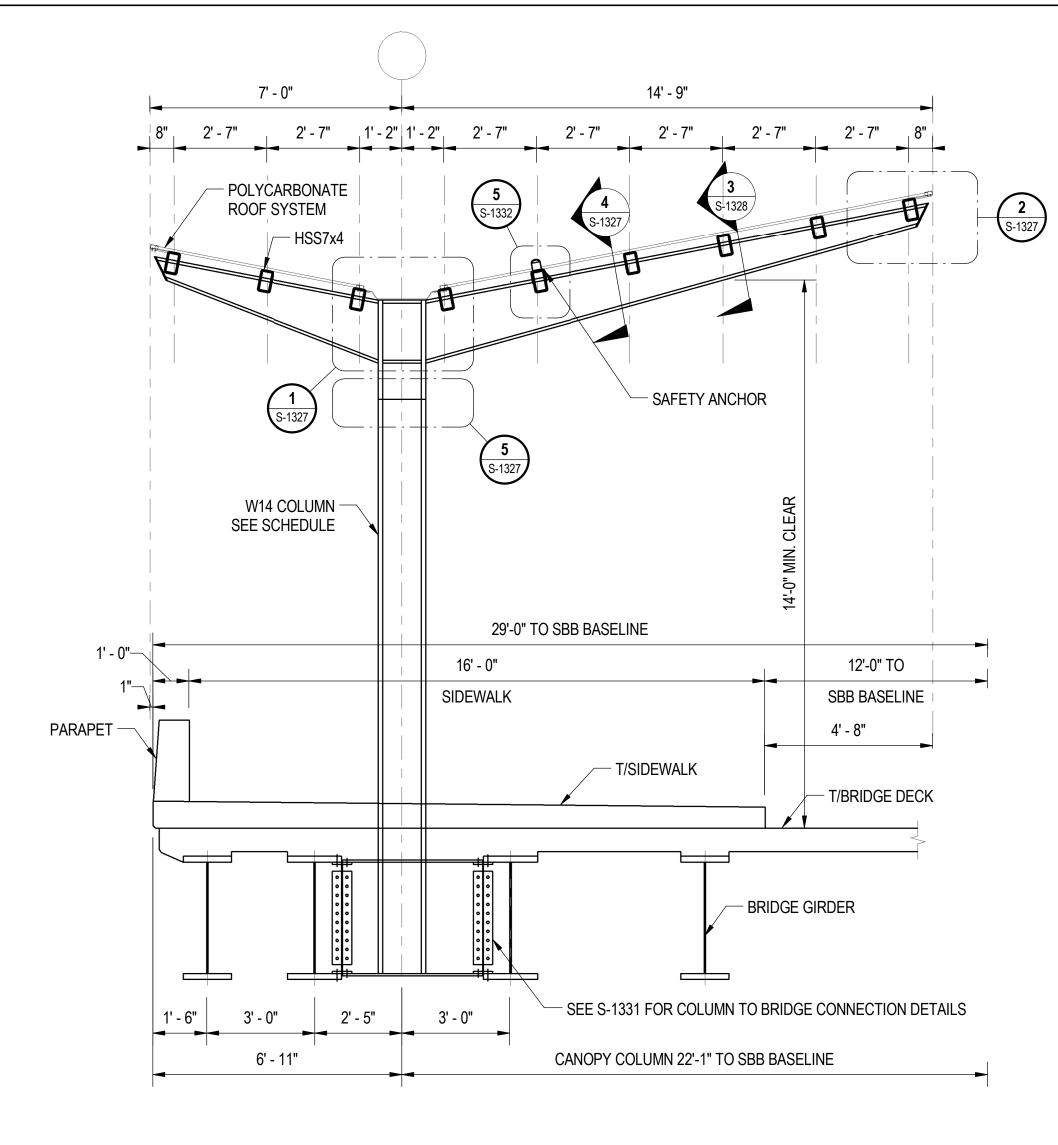



TYPICAL SECTION SOUTH BUS BRIDGE AT PARAPET

S-1323 SCALE: 3/8" = 1'-0"


TYPICAL SECTION SOUTH BUS BRIDGE AT ENTRY

SCALE: 3/8" = 1'-0"

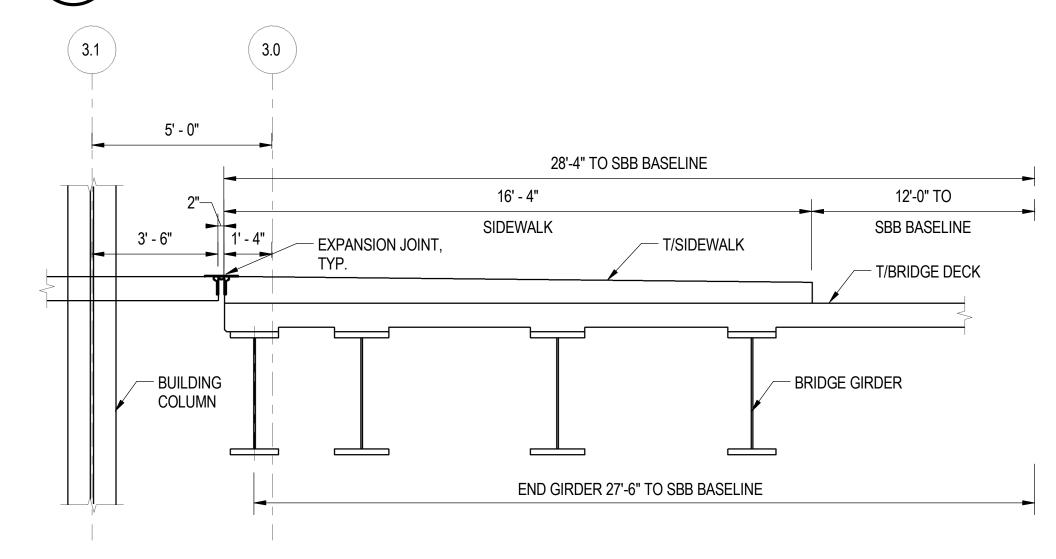

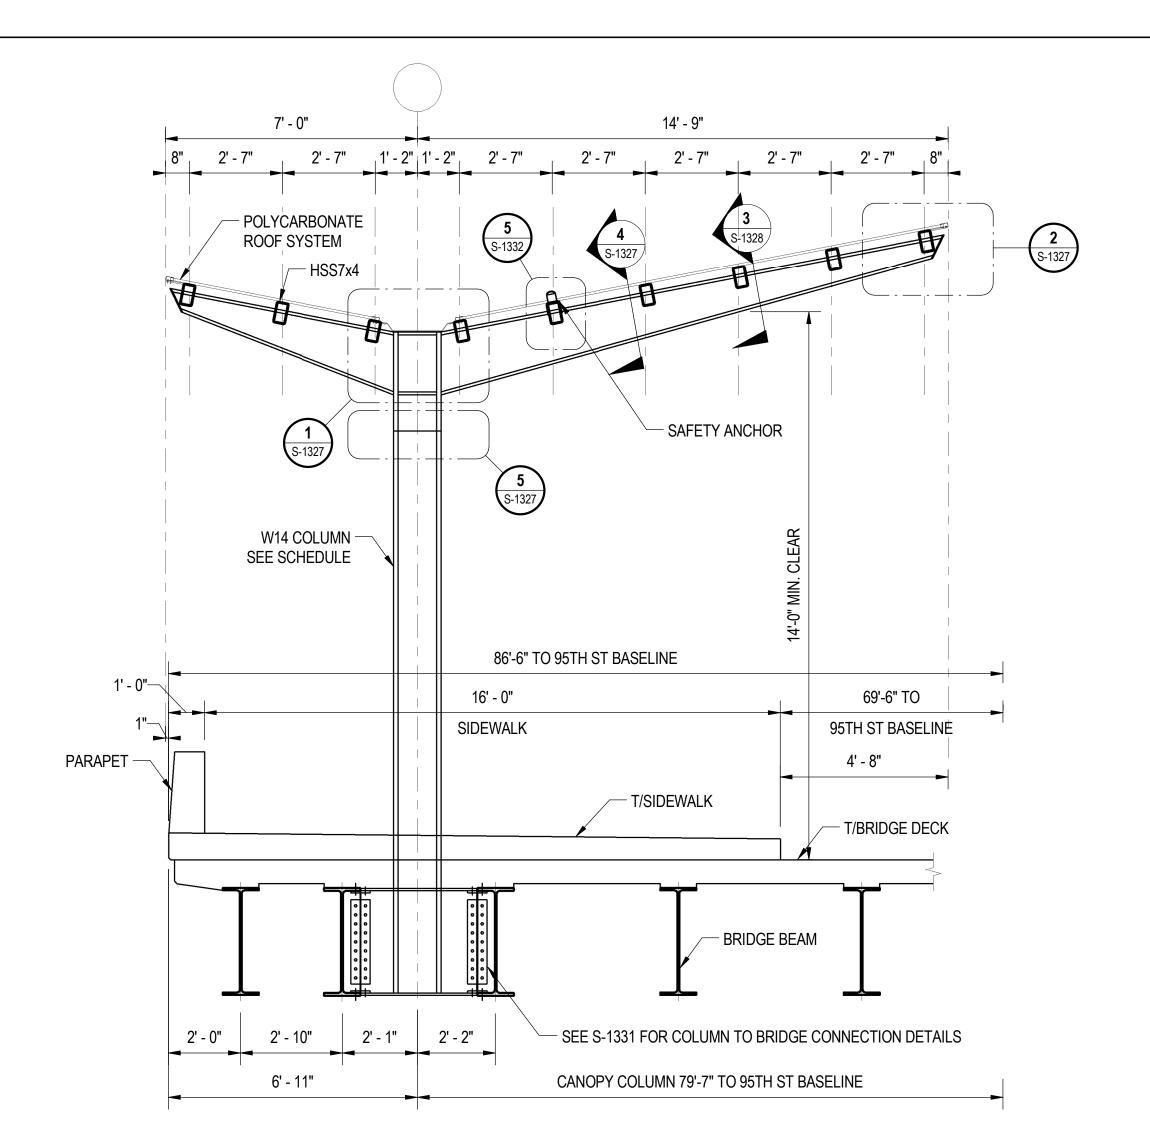

TYPICAL SECTION 95TH ST AND SOUTH TERMINAL AT PARAPET SCALE: 3/8" = 1'-0"

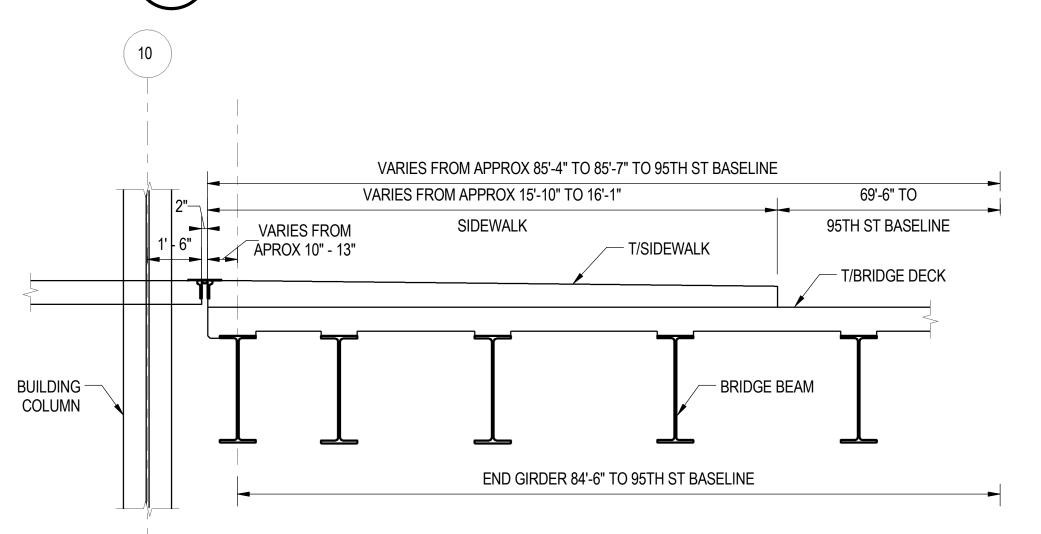

TYPICAL SECTION 95TH ST AND SOUTH TERMINAL AT ENTRY

S-1323 SCALE: 3/8" = 1'-0"

SHEET NOTES

1. FOR POLYCARBONATE ROOF SEE ARCHITECTURAL AS SERIES SHEETS.

2. FOR EXPANSION JOINTS SEE BRIDGE PLANS.





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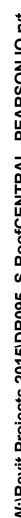
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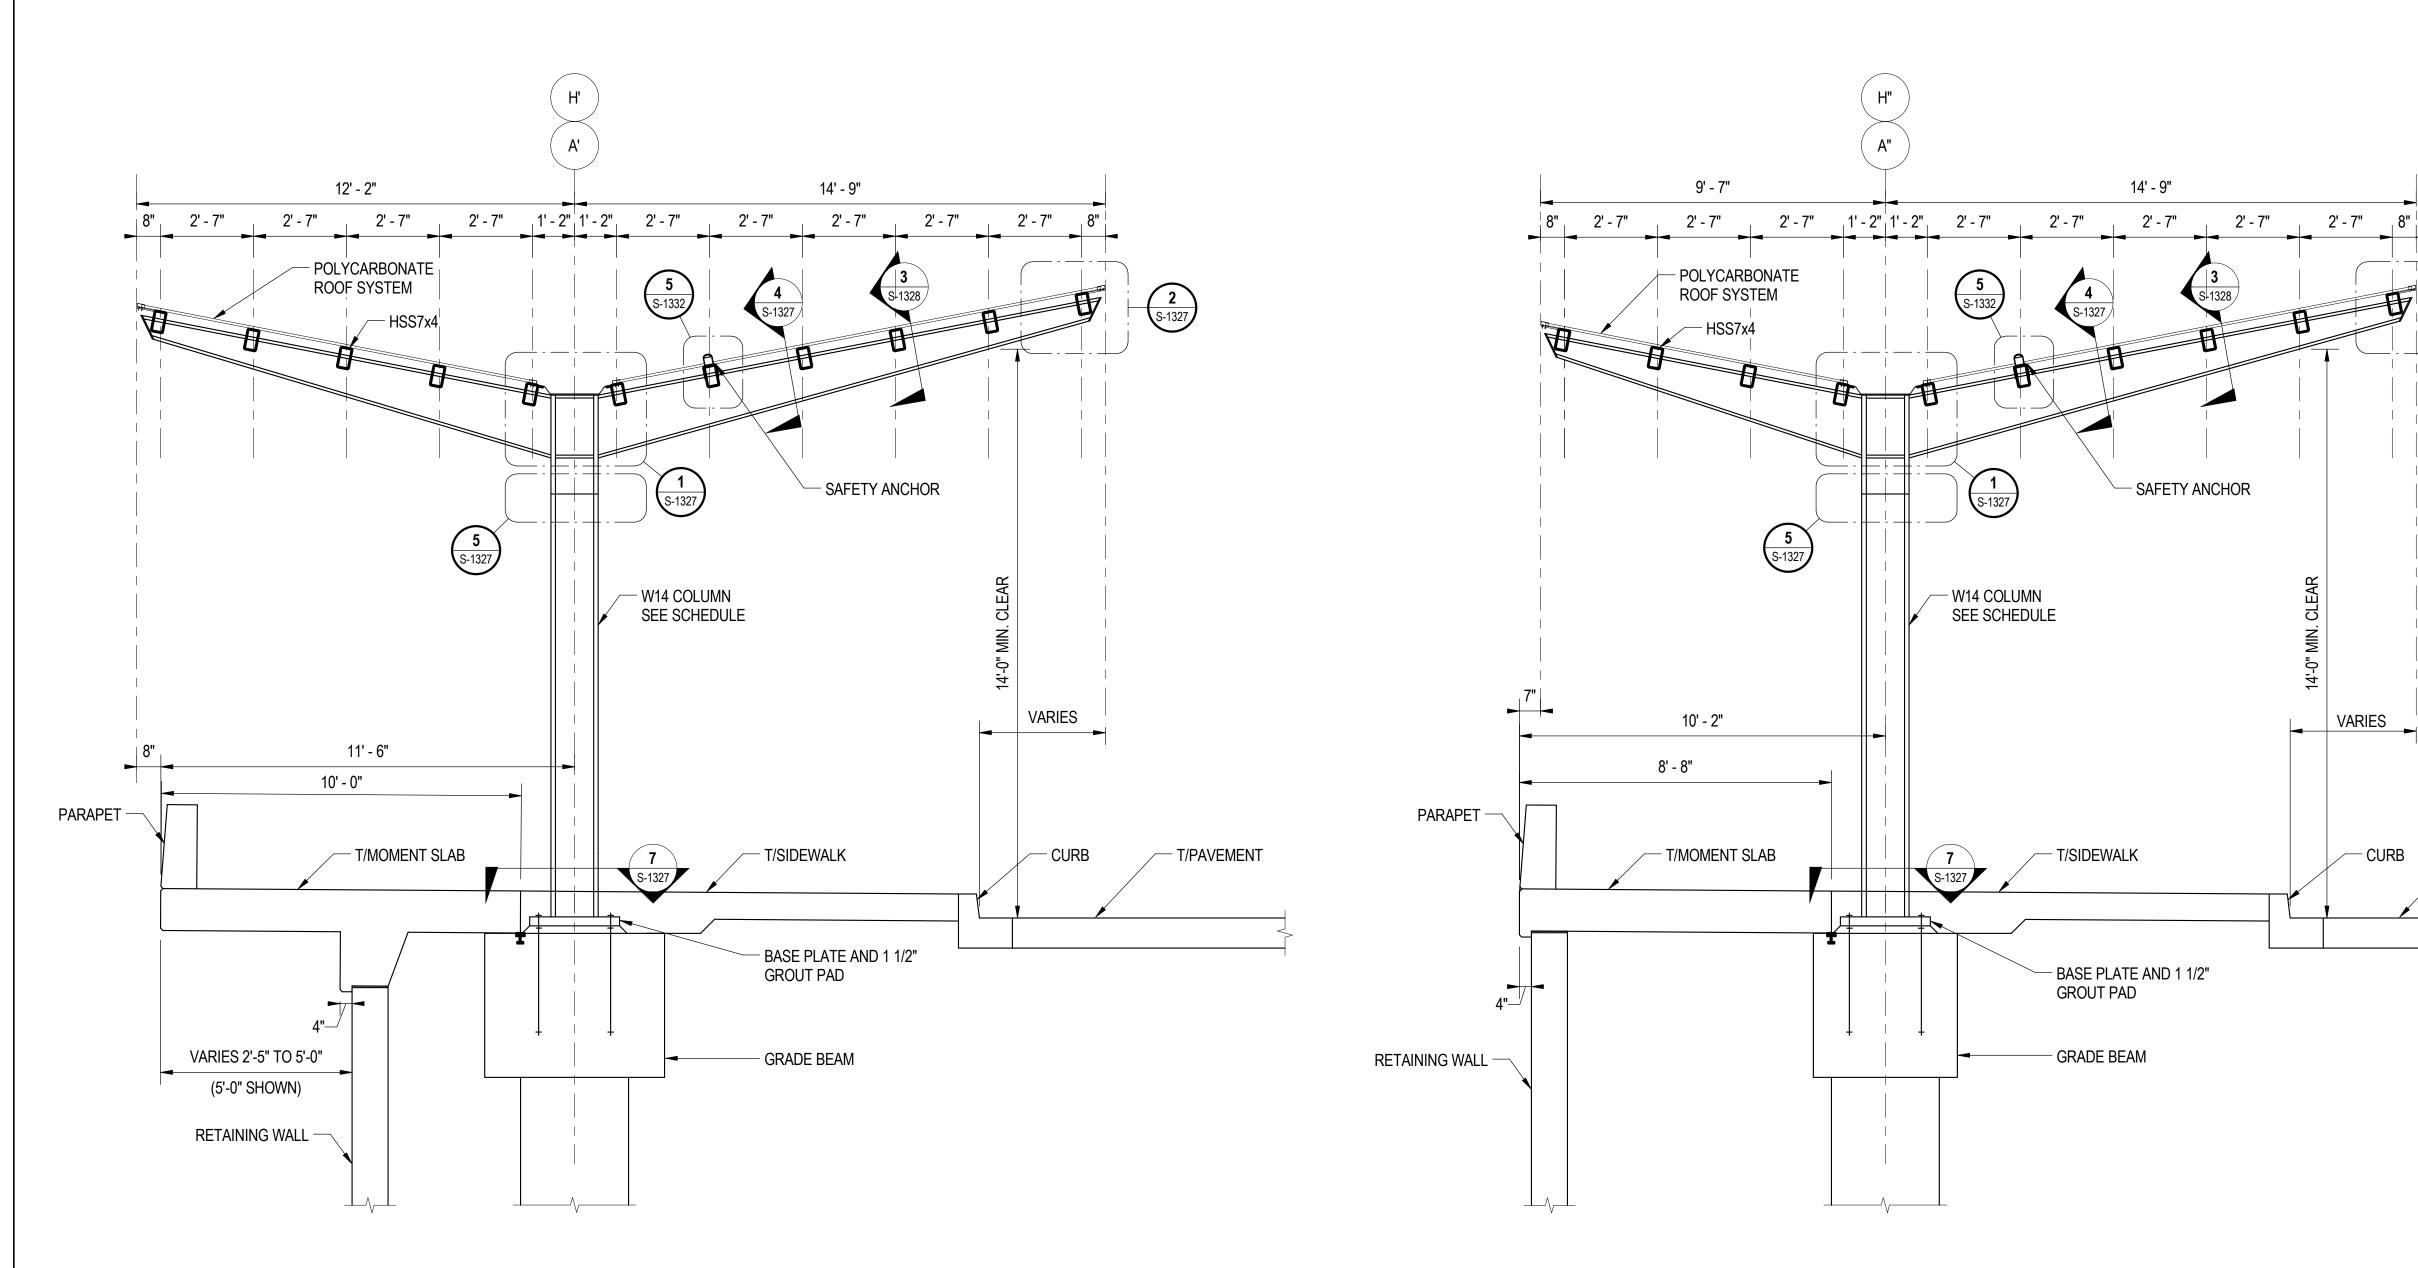
95th Terminal Improvement 15 West 95th Street (South Terminal) Chicago, IL 60628

IN CHARGE APPROVED BY		J. JAKALSKI
		J. JAKALSKI
CHEC	KED BY	R.S. NAIR
DESIC	ENED BY	S. CITKO
DRAV	VN BY	D. LALLY
PROJ	ECT NO.	2012-0021.02
FILE N	NAME	D095_S-RoofCENTRAL
	2/9/17	ISSUED FOR CONSTRUCTION
MARK	DATE	DESCRIPTION
1.00	ATIONID	ENTIFIED. BROSE
LUC	ATIONID	ENTIFIER: <b>DR095</b>

BUS CANOPY SECTIONS AT SOUTH TERMINAL







TYPICAL SECTION AT SOUTH TERMINAL RETAINING WALLS
S-1325 SCALE: 3/8" = 1'-0"



#### SHEET NOTES

1. FOR POLYCARBONATE ROOF SEE ARCHITECTURAL AS SERIES SHEETS.

2. FOR EXPANSION JOINTS SEE BRIDGE PLANS.





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/ T/PAVEMENT

95th Terminal Improvement
15 West 95th Street (South Terminal)
Chicago, IL 60628

IN CHARGE J. JAKALSKI
APPROVED BY J. JAKALSKI
CHECKED BY R.S. NAIR
DESIGNED BY S. CITKO
DRAWN BY D. LALLY
PROJECT NO. 2012-0021.02
FILE NAME D095\_S-RoofCENTRAL

2/9/17 ISSUED FOR CONSTRUCTION
MARK DATE DESCRIPTION

LOCATION IDENTIFIER: DR095

BUS CANOPY SECTIONS AT RETAINING WALLS

SOUTH CANOPY - WEST SIDE						
COLUMN LINE	COLUMN NUMBER	COLUMN SIZE	T/ COLUMN ELEVATION	BOTTOM ELEVATION	BOTTOM ELEVATION DESCRIPTION	
CDD		W/4 4 VO 4 4	24 201	40.70	T/ PDIDOE CIDDED	
SBB	3	W14X211	34.30'	19.70'	T/ BRIDGE GIRDER	
SBB		W14X211	34.45'	18.97'	T/ BRIDGE GIRDER	
SBB	2	W14X211	34.60'	18.15'	T/ BRIDGE GIRDER	
SBB	1	W14X257	34.75'	17.35'	T/ BRIDGE GIRDER	
A'	1	W14X257	34.60'	17.51'	T/ GRADE BEAM	
A'	2	W14X211	34.34'	17.88'	T/ GRADE BEAM	
A'	3	W14X211	34.08'	18.27'	T/ GRADE BEAM	
A'	4	W14X211	33.82'	18.49'	T/ GRADE BEAM	
A'	5	W14X211	33.56'	18.48'	T/ GRADE BEAM	
A'	6	W14X211	33.30'	18.25'	T/ GRADE BEAM	
A'	7	W14X211	33.02'	17.82'	T/ GRADE BEAM	
A'	8	W14X211	32.73'	17.39'	T/ GRADE BEAM	
A'	9	W14X211	32.44'	16.96'	T/ GRADE BEAM	
A'	10	W14X211	32.16'	16.53'	T/ GRADE BEAM	
A'	11	W14X257	31.90'	15.67'	T/ GRADE BEAM	
95	1	W14X257	32.05'	16.34'	T/ BRIDGE GIRDER	
95	2	W14X211	31.90'	16.67'	T/ BRIDGE GIRDER	
95	3	W14X211	31.75'	16.99'	T/ BRIDGE GIRDER	
95	4	W14X211	31.60'	17.32'	T/ BRIDGE GIRDER	

COLUMN LINE	COLUMN NUMBER	COLUMN SIZE	T/ COLUMN ELEVATION	BOTTOM ELEVATION	BOTTOM ELEVATION DESCRIPTION
05	1.1	W44V044	24 00'	17.64	T/ PDIDCE CIDDED
95	14	W14X211	31.80'	17.64'	T/ BRIDGE GIRDER
95	13	W14X211	31.91'	17.49'	T/ BRIDGE GIRDER
95	12	W14X211	32.03'	17.18'	T/ BRIDGE GIRDER
95	11	W14X211	32.14'	16.87'	T/ BRIDGE GIRDER
95	10	W14X257	32.25'	16.56'	T/ BRIDGE GIRDER
A"	1	W14X257	32.10'	15.95'	T/ GRADE BEAM
A"	2	W14X211	32.31'	16.75'	T/ GRADE BEAM
A"	3	W14X211	32.52'	17.04'	T/ GRADE BEAM
Α"	4	W14X211	32.74'	17.35'	T/ GRADE BEAM
Α"	5	W14X211	32.95'	17.64'	T/ GRADE BEAM
Α"	6	W14X211	33.17'	17.94'	T/ GRADE BEAM
Α"	7	W14X211	33.38'	18.18'	T/ GRADE BEAM
Α"	8	W14X211	33.60'	18.32'	T/ GRADE BEAM
Α"	9	W14X211	33.46'	18.35'	T/ GRADE BEAM
A"	10	W14X211	33.31'	18.32'	T/ GRADE BEAM
A"	11	W14X211	33.16'	18.22'	T/ GRADE BEAM
A"	12	W14X211	33.02'	17.99'	T/ GRADE BEAM
A"	13	W14X211	32.88'	17.79'	T/ GRADE BEAM
A"	14	W14X211	32.74'	17.46'	T/ GRADE BEAM
A"	15	W14X257	32.60'	17.13'	T/ GRADE BEAM
NBB	1	W14X257	32.75'	TBD	T/ BRIDGE GIRDER
NBB	2	W14X211	32.64'	TBD	T/ BRIDGE GIRDER
NBB	3	W14X211	32.53'	TBD	T/ BRIDGE GIRDER
NBB	4	W14X211	32.41'	TBD	T/ BRIDGE GIRDER
NBB	5	W14X211	32.30'	TBD	T/ BRIDGE GIRDER

NORTH CANOPY - WEST SIDE

SOUTH CANOPY - EAST SIDE						
COLUMN LINE	COLUMN NUMBER	COLUMN SIZE	T/ COLUMN ELEVATION	BOTTOM ELEVATION	BOTTOM ELEVATION DESCRIPTION	
	1					
SBB	5	W14X211	34.30'	20.21'	T/ BRIDGE GIRDER	
SBB	6	W14X211	34.66'	20.28'	T/ BRIDGE GIRDER	
SBB	7	W14X211	35.03'	20.35'	T/ BRIDGE GIRDER	
SBB	8	W14X211	35.39'	20.42'	T/ BRIDGE GIRDER	
SBB	9	W14X257	35.75'	20.49'	T/ BRIDGE GIRDER	
H'	1	W14X257	35.60'	20.50'	T/ GRADE BEAM	
H'	2	W14X211	35.43'	20.43'	T/ GRADE BEAM	
H'	3	W14X211	35.25'	20.25'	T/ GRADE BEAM	
H'	4	W14X211	35.06'	19.97'	T/ GRADE BEAM	
H'	5	W14X211	34.88'	19.58'	T/ GRADE BEAM	
H'	6	W14X211	34.70'	19.08'	T/ GRADE BEAM	
H'	7	W14X211	34.12'	18.46'	T/ GRADE BEAM	
H'	8	W14X211	33.55'	17.83'	T/ GRADE BEAM	
H'	9	W14X211	32.97'	17.24'	T/ GRADE BEAM	
H'	10	W14X211	32.39'	16.76'	T/ GRADE BEAM	
H'	11	W14X257	31.90'	16.14'	T/ GRADE BEAM	
95	9	W14X257	32.05'	16.35'	T/ BRIDGE GIRDER	
95	8	W14X211	31.94'	16.64'	T/ BRIDGE GIRDER	
95	7	W14X211	31.83'	16.94'	T/ BRIDGE GIRDER	
95	6	W14X211	31.71'	17.23'	T/ BRIDGE GIRDER	
95	5	W14X211	31.60'	17.39'	T/ BRIDGE GIRDER	

NORTH CANOPY - EAST SIDE						
COLUMN LINE	COLUMN NUMBER	COLUMN SIZE	T/ COLUMN ELEVATION	BOTTOM ELEVATION	BOTTOM ELEVATION DESCRIPTION	
95	15	W14X211	31.80'	17.64'	T/ BRIDGE GIRDER	
95	16	W14X211	31.91'	17.47'	T/ BRIDGE GIRDER	
95	17	W14X211	32.03'	17.15'	T/ BRIDGE GIRDER	
95	18	W14X211	32.14'	16.83'	T/ BRIDGE GIRDER	
95	19	W14X257	32.25'	16.50'	T/ BRIDGE GIRDER	
H"	1	W14X257	32.10'	16.04'	T/ GRADE BEAM	
H"	2	W14X211	32.31'	16.75'	T/ GRADE BEAM	
H"	3	W14X211	32.52'	17.04'	T/ GRADE BEAM	
H"	4	W14X211	32.74'	17.34'	T/ GRADE BEAM	
H"	5	W14X211	32.95'	17.64'	T/ GRADE BEAM	
H"	6	W14X211	33.17'	17.94'	T/ GRADE BEAM	
H"	7	W14X211	33.38'	18.16'	T/ GRADE BEAM	
H"	8	W14X211	33.60'	18.30'	T/ GRADE BEAM	
H"	9	W14X211	33.46'	18.34'	T/ GRADE BEAM	
H"	10	W14X211	33.31'	18.32'	T/ GRADE BEAM	
H"	11	W14X211	33.16'	18.21'	T/ GRADE BEAM	
H"	12	W14X211	33.02'	18.01'	T/ GRADE BEAM	
H"	13	W14X211	32.88'	17.73'	T/ GRADE BEAM	
H"	14	W14X211	32.74'	17.43'	T/ GRADE BEAM	
H"	15	W14X257	32.60'	17.24'	T/ GRADE BEAM	
NBB	10	W14X257	32.75'	TBD	T/ BRIDGE GIRDER	
NBB	9	W14X211	32.64'	TBD	T/ BRIDGE GIRDER	
NBB	8	W14X211	32.53'	TBD	T/ BRIDGE GIRDER	
NBB	6	W14X211	32.41'	TBD	T/ BRIDGE GIRDER	
NBB	7	W14X211	32.30'	TBD	T/ BRIDGE GIRDER	









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## 95th Terminal Improvement


15 West 95th Street (South Terminal) Chicago, IL 60628


IN CH	ARGE	J. JAKALSKI	
APPROVED BY		J. JAKALSKI	
CHEC	KED BY	R.S. NAIR	
DESIG	ENED BY	S. CITKO	
DRAW	/N BY	C. BOVE	
PROJ	ECT NO.	2012-0021.02	
FILE N	NAME	D095_S-Roof	CENTRAL
	2/9/17	ISSUED FOR C	ONSTRUCTION
MARK	DATE	DESCRIPTION	ı
100	ATIONUDI		DDOOF
LUC	ATION IDE	ENTIFIER:	DR095

#### SHEET NOTES

- 1. BOTTOM ELEVATIONS ARE APPROXIMATE. VERIFY IN FIELD ACTUAL GRADE BEAM AND BRIDGE GIRDER ELEVATIONS
- 2. ERECTING COLUMN TO CORRECT T/COL. ELEVATION IS IMPORTANT FOR PROPER DRAINAGE OF CANOPY SYSTEM

**BUS CANOPY COLUMN** SCHEDULE

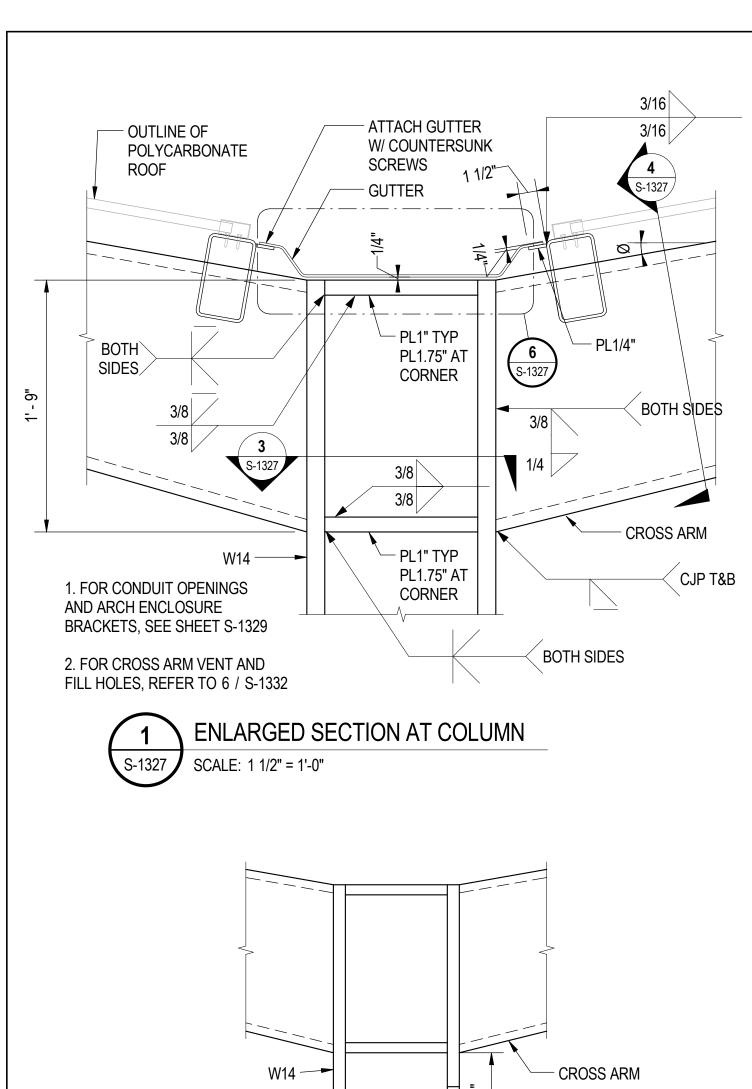

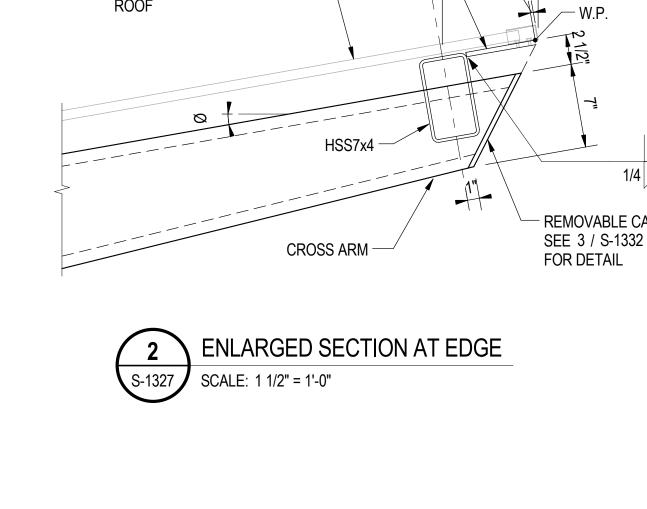

COLUMN -

WASHER

1 1/2" GROUT

LEVELING NUT

1 1/4" Ø ANCHOR

CONTINUOUS -

**ANCHOR NUT** 


ANCHOR

PL4x22x1/2

3" PL

BOLT

3/8" WELDED PLATE

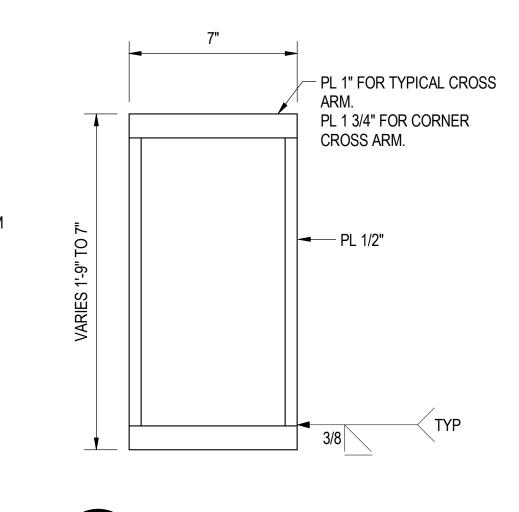





COLUMN Ø 11.0000 **TYPICAL** 10.0646 CORNER OUTLINE OF POLYCARBONATE  $\neg$ PL 3/8" CANOPY TYPICAL COLUMN PL 1" ROOF CORNER COLUMN PL 1.75" - CROSS ARM REMOVABLE CAP PL SEE 3 / S-1332


SCALE: 1 1/2" = 1'-0"


11 3/4" 3/16" GALV. STEEL GUTTER TYP GUTTER

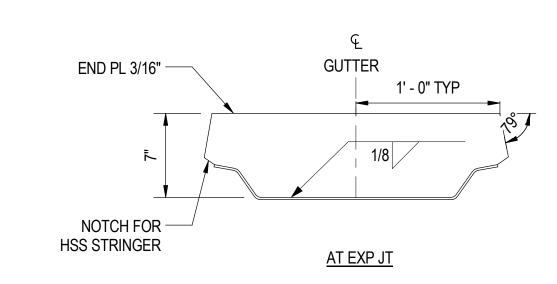


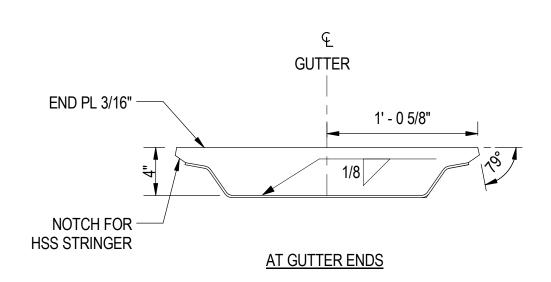



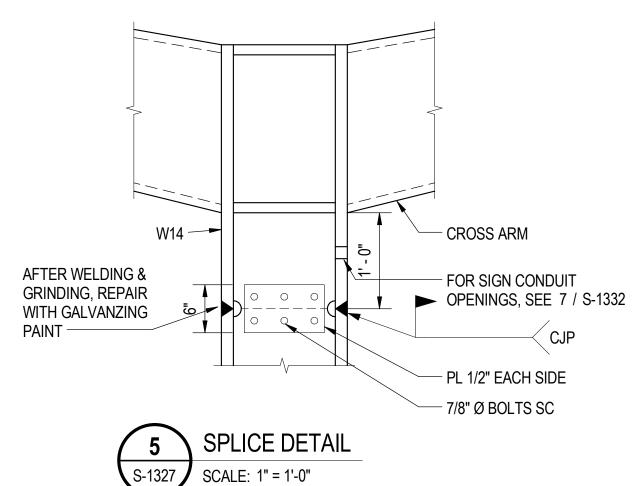

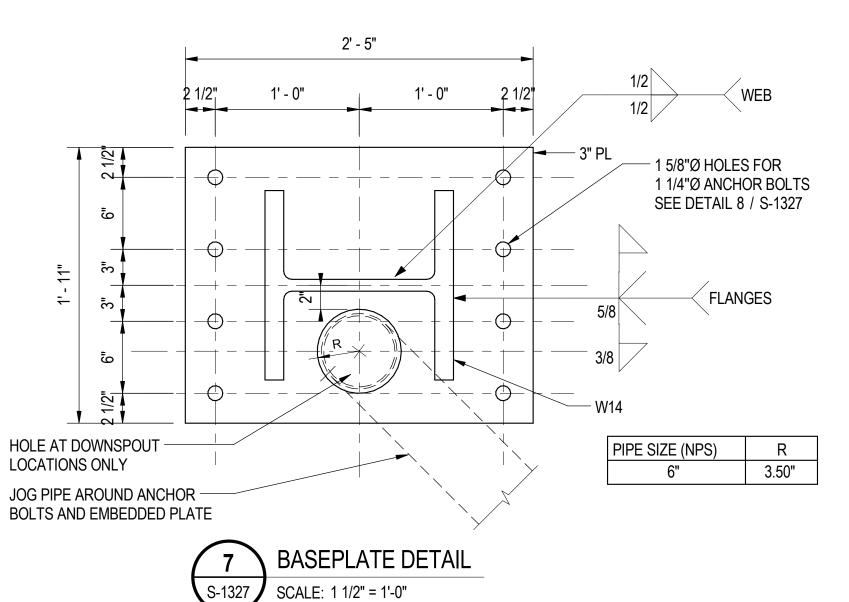

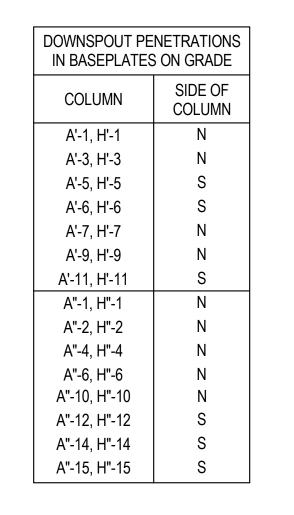

**ANCHOR BOLT DETAIL** 

SCALE: 1" = 1'-0"

SHEET NOTES

1. FOR GENERAL NOTES, SEE DWGS S-001 TO S-004

2. ALL CANOPY STEEL IS TO BE HOT-DIP GALVANIZED.

3. RECOMMENDED ERECTION SEQUENCE a. COMPLETE WELDED COLUMN SPLICE BEFORE ERECTING STRINGERS b. ERECT STRINGERS PRIOR TO GROUTING BASE PLATE AND WELDING WELD PLATES

c. GROUT BASE PLATE AND WELD WELD PLATE BEFORE POLYCARBONATE ROOF INSTALLATION



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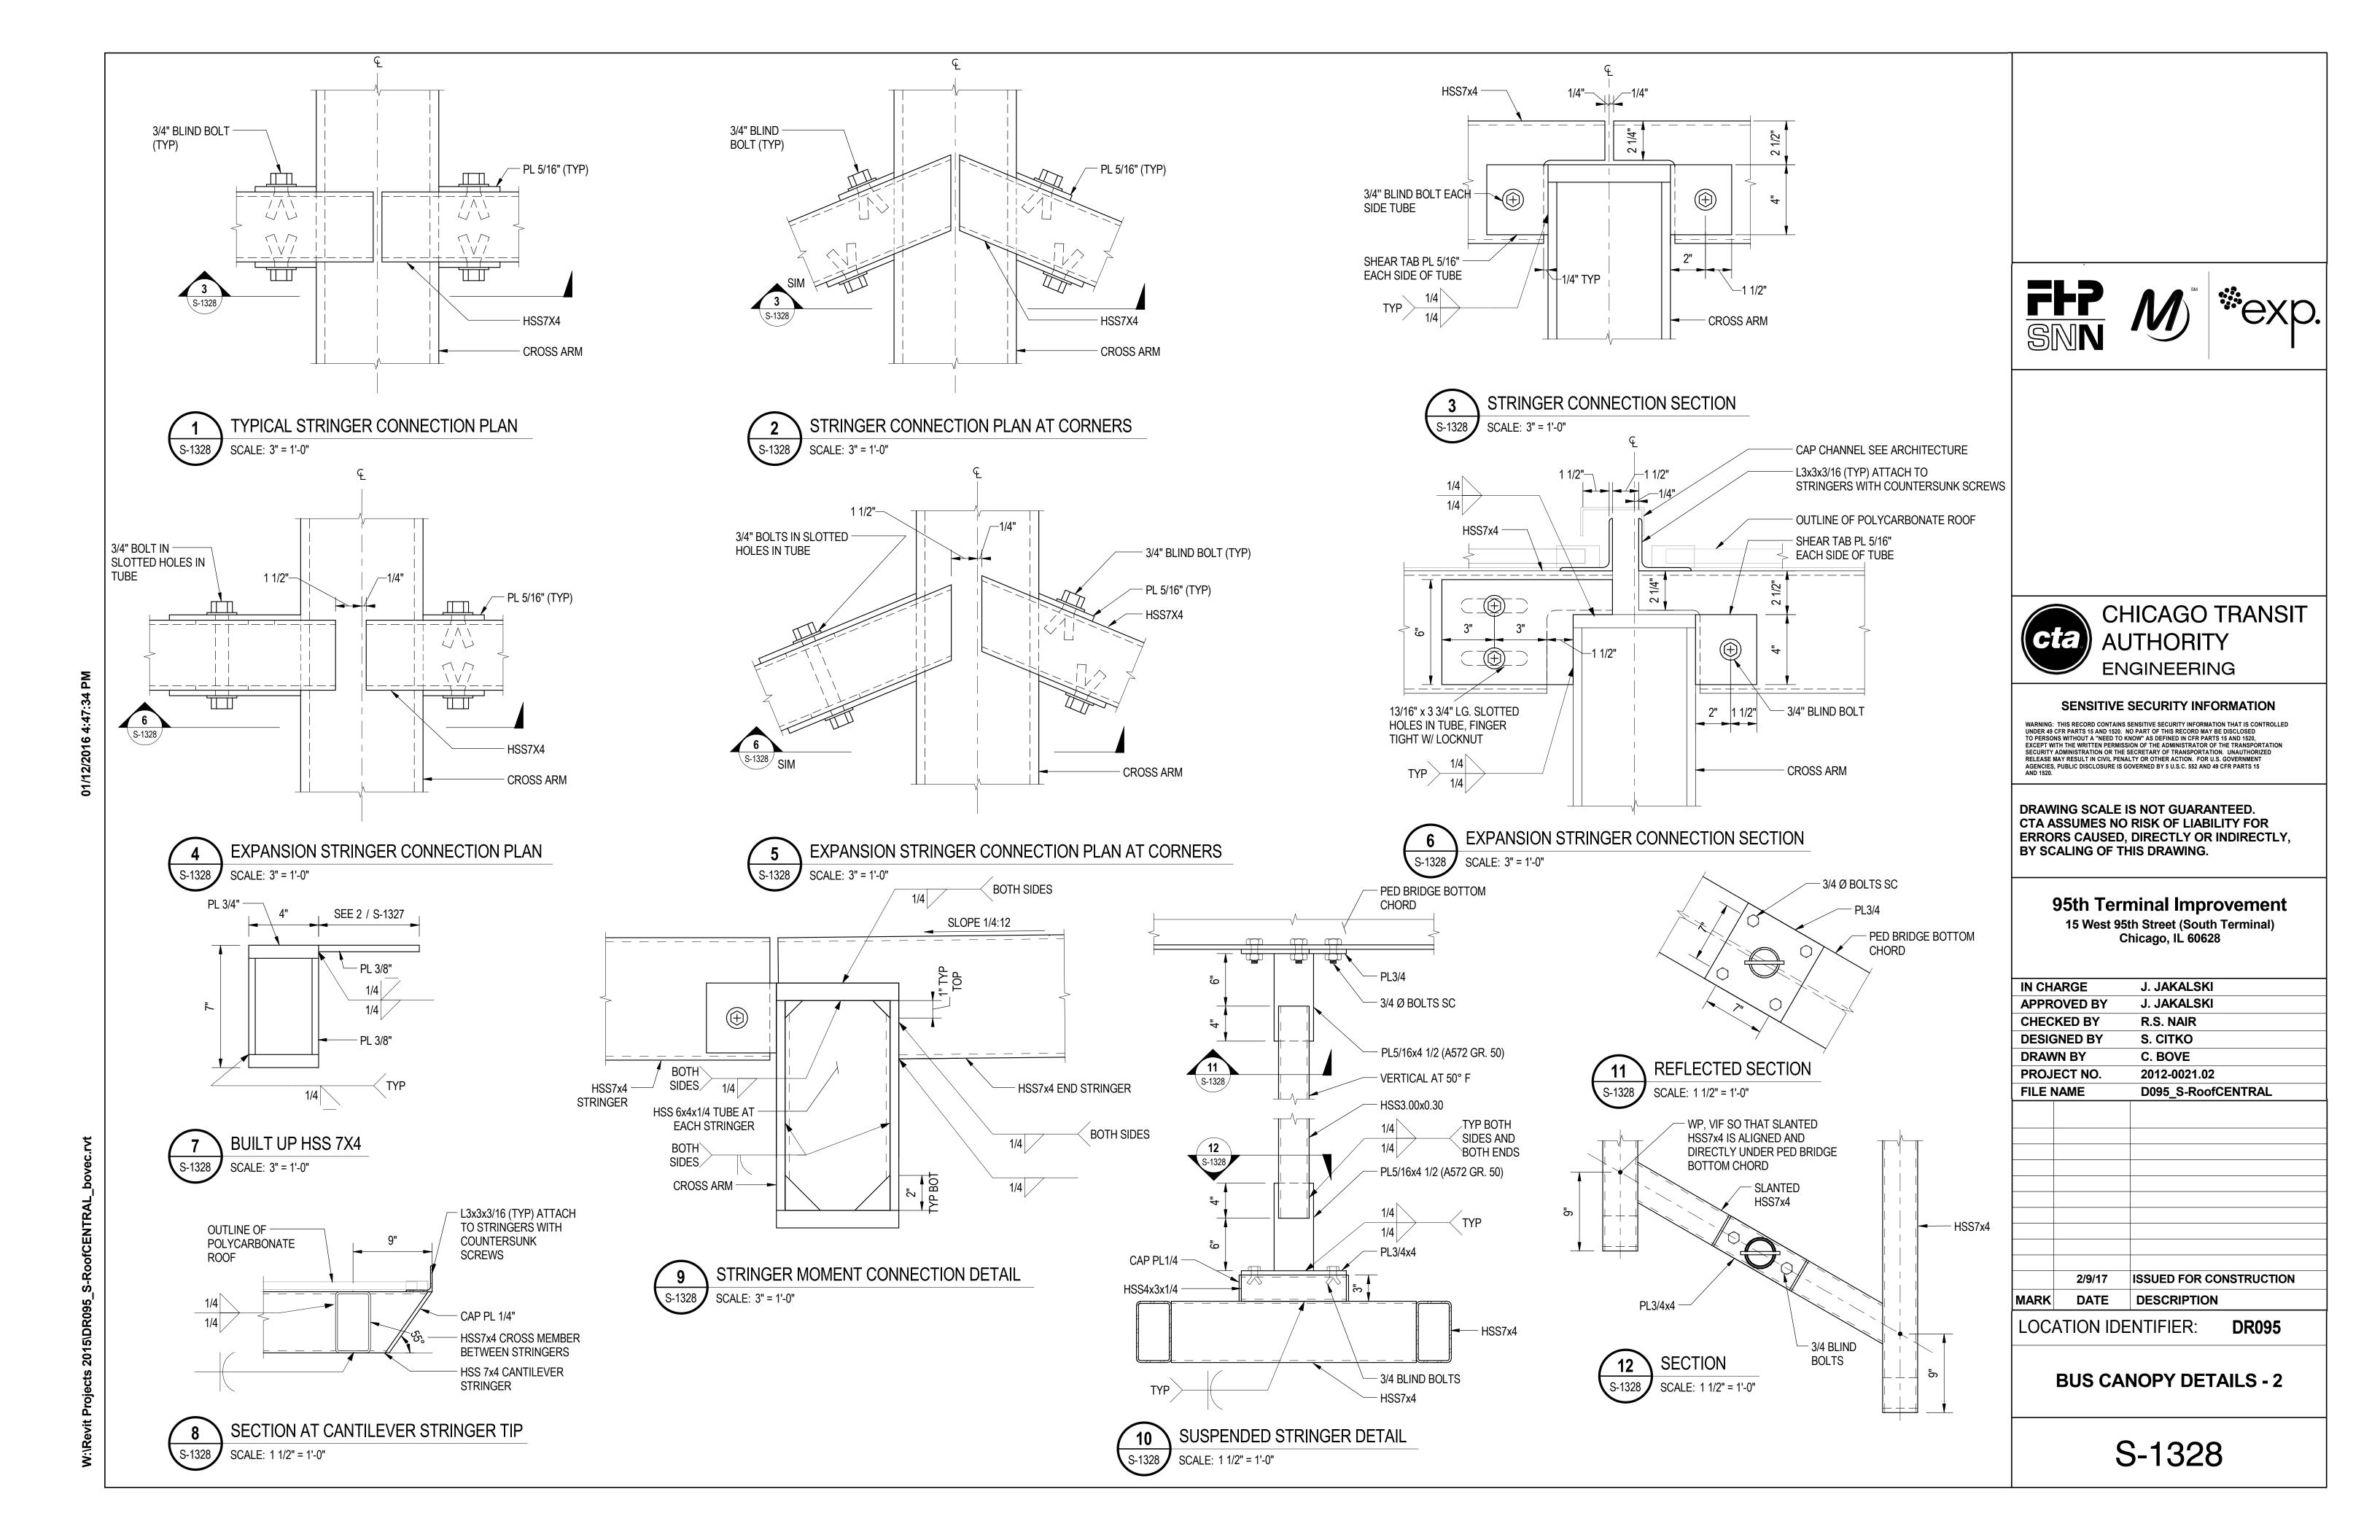
> 95th Terminal Improvement 15 West 95th Street (South Terminal) Chicago, IL 60628

J. JAKALSKI **IN CHARGE** J. JAKALSKI **APPROVED BY CHECKED BY** R.S. NAIR S. CITKO **DESIGNED BY** C. BOVE **DRAWN BY** 2012-0021.02 PROJECT NO. D095\_S-RoofCENTRAL **FILE NAME** 


2/9/17 ISSUED FOR CONSTRUCTION DESCRIPTION MARK DATE

LOCATION IDENTIFIER: **DR095** 


**BUS CANOPY DETAILS - 1** 







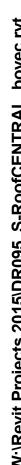


S-1329

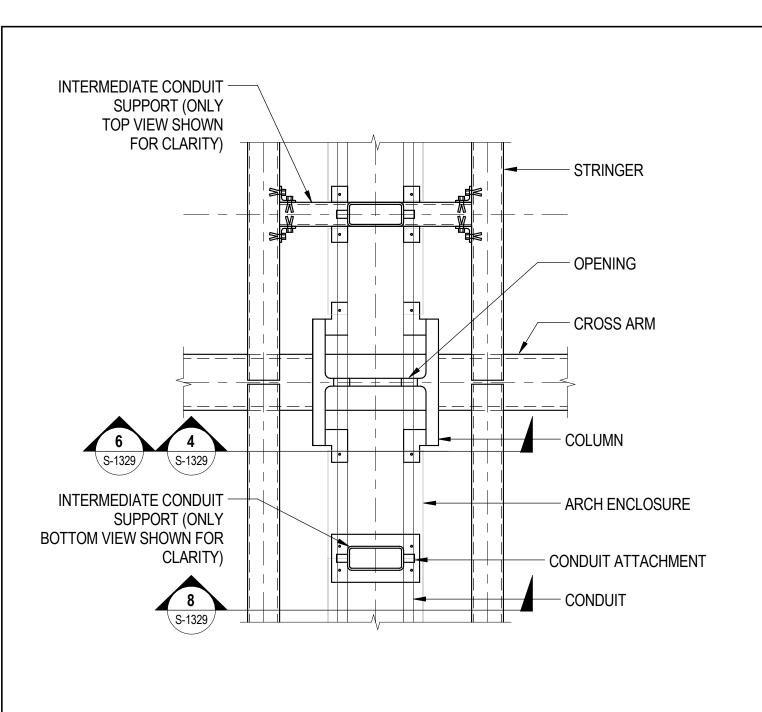

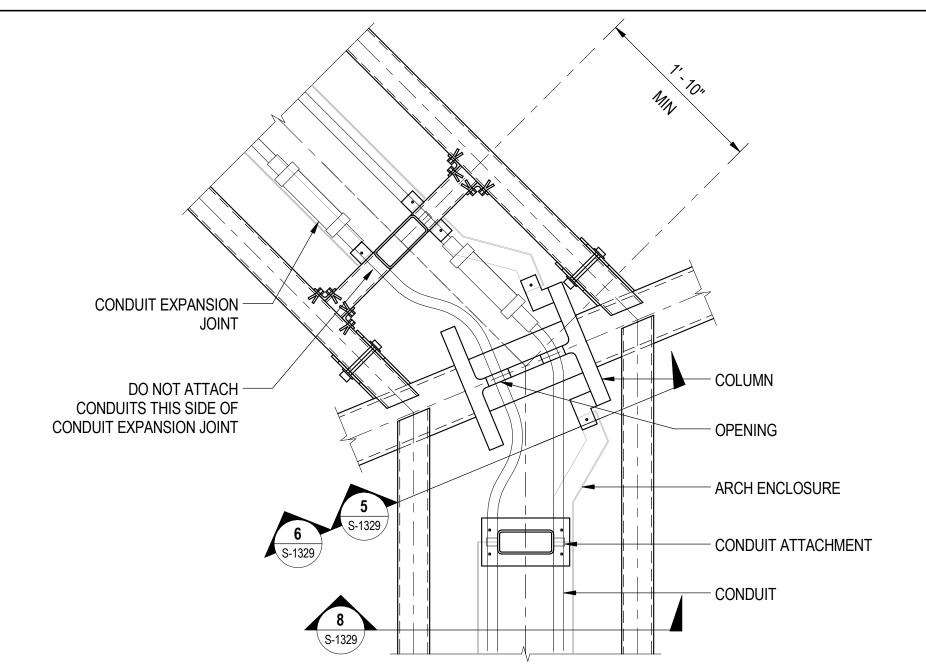


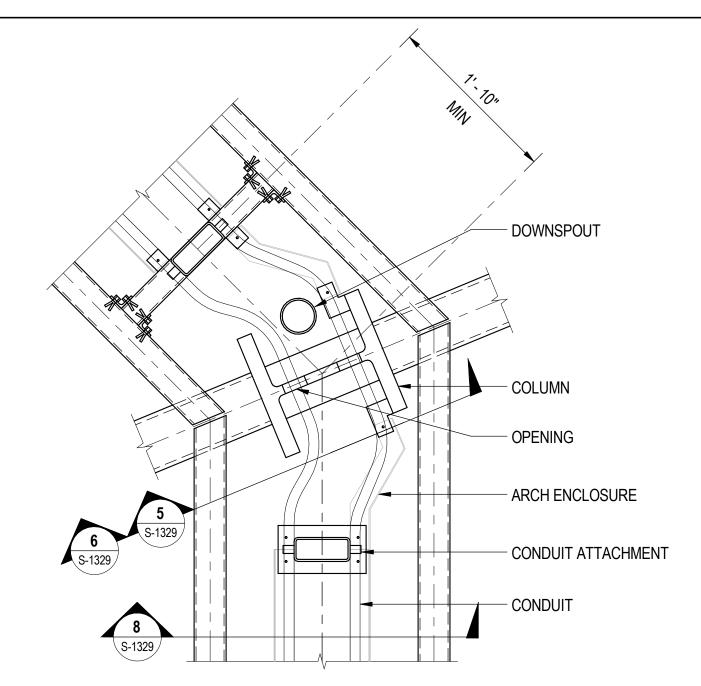


CONDUIT PLAN AT CORNER COLUMN WITH DOWNSPOUT

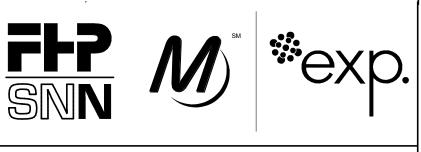

CONDUIT PLAN AT TYPICAL COLUMN

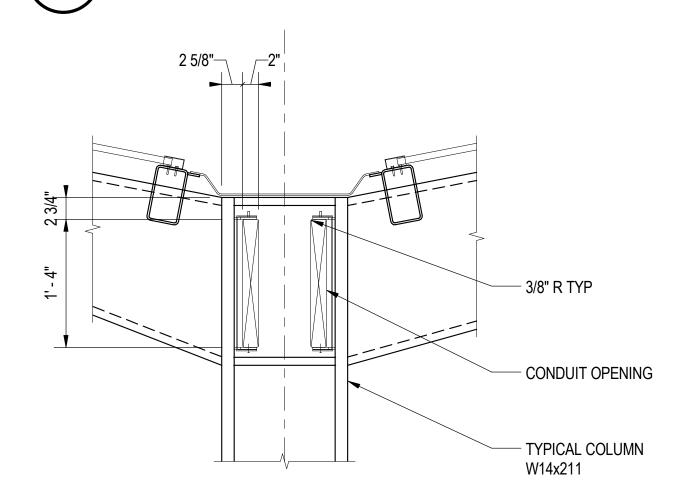

CONDUIT PLAN AT CORNER COLUMN WITH EXP JT

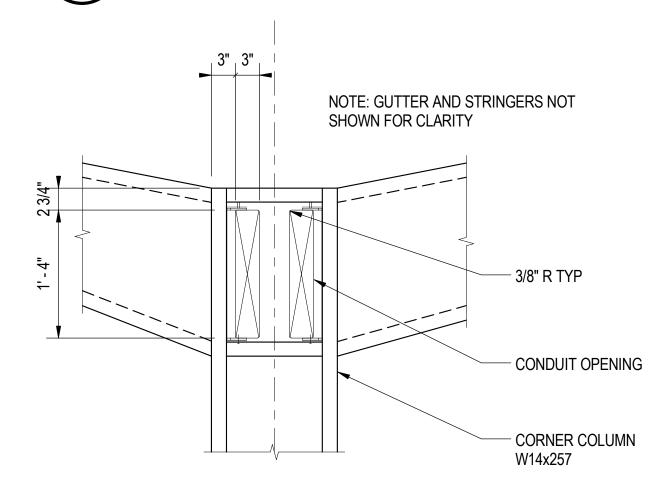

CONDUIT OPENINGS AT CORNER COLUMN

S-1329

SCALE: 1" = 1'-0"


- CONDUIT OPENING OUTLINE OF ARCH ENCLOSURE - ENCLOSURE ATTACHMENT BRACKET

SHEET NOTES

**ENCLOSURE SUPPORT AT COLUMN** S-1329 SCALE: 1" = 1'-0"

SCALE: 1" = 1'-0"

CONDUIT OPENINGS AT TYPICAL COLUMN S-1329 SCALE: 1" = 1'-0"

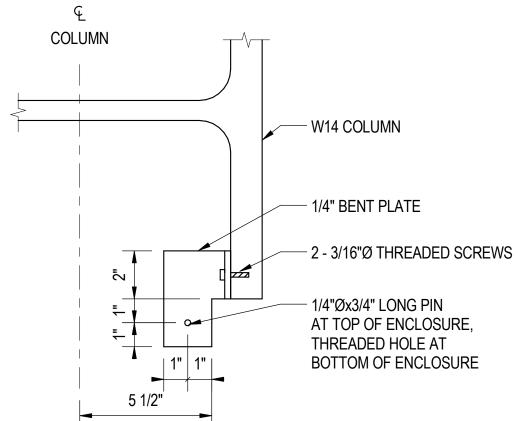

**ENCLOSURE ATTACHMENT AT COLUMN** INTERMEDIATE CONDUIT SUPPORT SCALE: 3" = 1'-0" S-1329 SCALE: 1" = 1'-0"

BENT PL 1/4 EACH -SIDE OF TUBE 5/8 BLIND BOLT -TYP - PL 1/4x2 NOTE: INTERMEDIATE CONDUIT SUPPORT IS PROVIDED AT END OF LED FIXTURES
APPROXIMATELY 4'-0" APART. COORDINATE WITH ELECTRICAL AND ARCHITECTURE. .- | T&B <del>| 3/16</del> | - HSS3x3x3/16 - HSS7x3x3/16 - CONDUITS TYP SCREW OUTLINE OF ARCH ENCLOSURE OUTLINE OF LED PL 1/4x6x11 FIXTURE

1. FOR GENERAL NOTES, SEE SWGS S-001 TO S-004 2. ALL CANOPY STEEL IS TO BE HOT-DIP GALVANIZED. 3. FOR CONDUITS REFER TO ELECTRICAL AND TELECOM SHEETS. 4. FOR LIGHT FIXTURES REFER TO ELECTRICAL SHEETS.

5. FOR ARCHITECTURAL ENCLOSURES REFER TO AS SERIES SHEETS.

CHICAGO TRANSIT **AUTHORITY ENGINEERING** 

**SENSITIVE SECURITY INFORMATION** 

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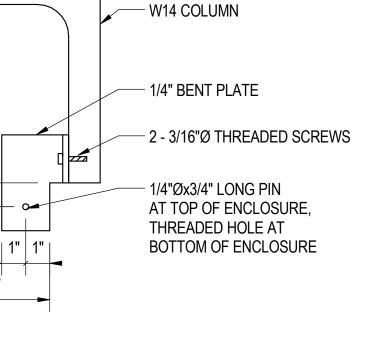
95th Terminal Improvement 15 West 95th Street (South Terminal) Chicago, IL 60628


J. JAKALSKI **IN CHARGE** J. JAKALSKI **APPROVED BY CHECKED BY** R.S. NAIR **DESIGNED BY** S. CITKO D. LALLY **DRAWN BY** PROJECT NO. 2012-0021.02 D095\_S-RoofCENTRAL **FILE NAME** 2/9/17 ISSUED FOR CONSTRUCTION MARK DATE DESCRIPTION


**BUS CANOPY DETAILS - 3** 


**DR095** 


LOCATION IDENTIFIER:



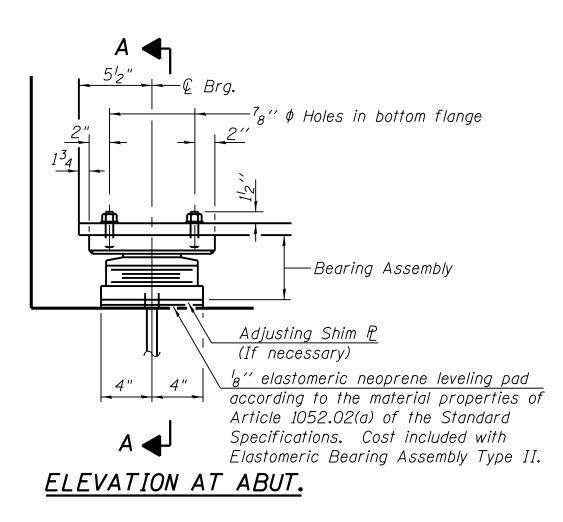

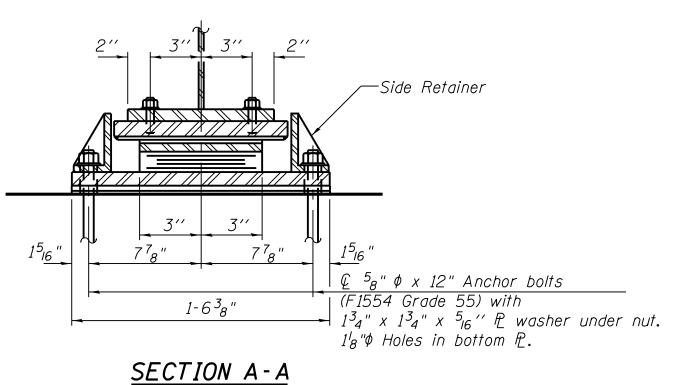

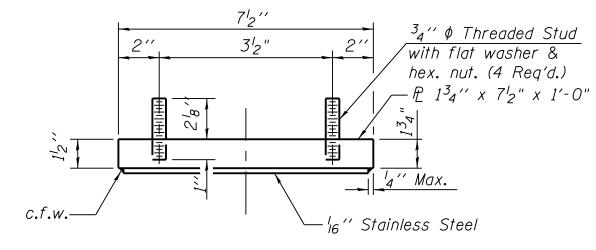

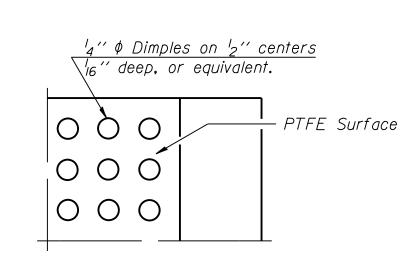


PLAN-PTFE SURFACE


TOP BEARING ASSEMBLY



Beams 1F, 1G, 1I, 1J, 16D, 16E, & 16G

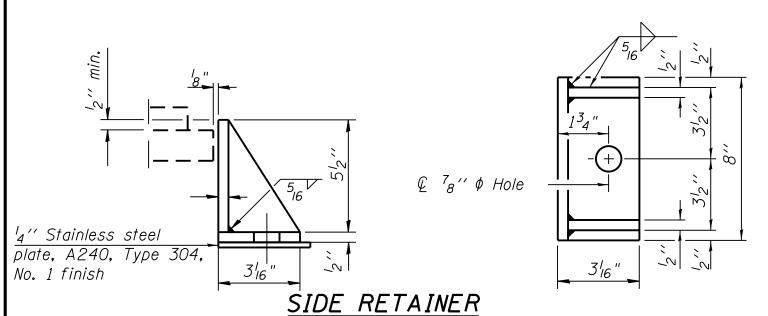




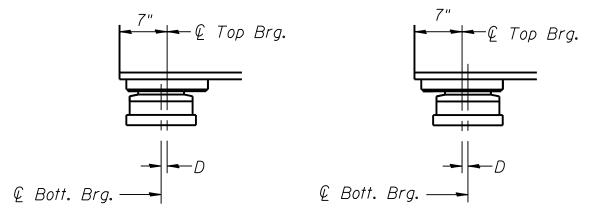

BELOW 50°F. ABOVE 50°F.  $D={}^{l}8$ " per each 100' of expansion for every 15° temp. change from the normal temp. of 50°F.

#### EXPANSION BEARING ORIENTATION

The above diagrams are for informational purposes only to show the amount of expected offset "D" for the current temperature in the field.

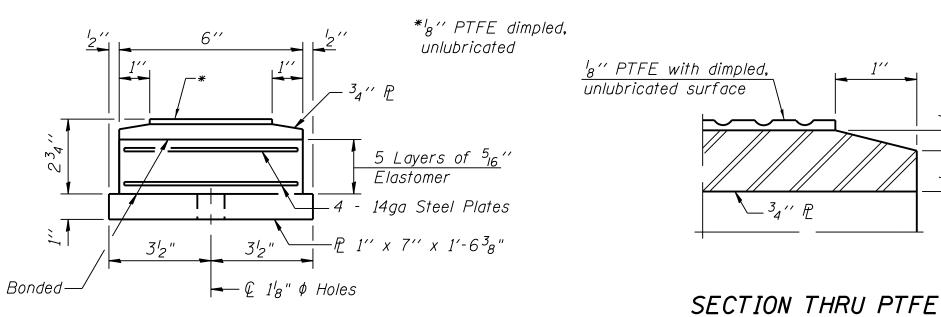

BOTTOM BEARING ASSEMBLY

Anchor bolts shall be ASTM F1554 all-thread (or an Engineer-approved alternate material) of the grade(s) and diameter(s) specified. The corresponding specified grade of AASHTO M314 anchor bolts may be used in lieu of ASTM F1554.

Side retainers and other steel members required for the elastomeric bearing assembly shall be included in the cost of Elastomeric Bearing Assembly, Type I. Beams shall be braced for stability during erection and

remain braced until deck is poured and cured. Anchor bolts and side retainers at all supports shall be installed as each member is erected unless an equivalent temporary means of lateral restraint is used. For Steel Extensions, see Sheet S-132B.



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#### 95th Terminal Improvement

15 West 95th Street (South Terminal) Chicago, IL 60628

S. KADERBEK
D.ZROKA
P.MAID
L.SOMMER
T.SLEDGE
2012-0021
File Name
ISSUED FOR CONSTRUCTION
DESCRIPTION
NTIFIER DR095


LOCATION IDENTIFIER:

95TH ST. BRIDGE **BEARING DETAILS** (SHEET 3 OF 5) SN 016-0437

95TH-S-132A

#### ELEVATION AT SOUTH ABUTMENT WIDENING


(Beams 1F, 1I, 1J & 1K)

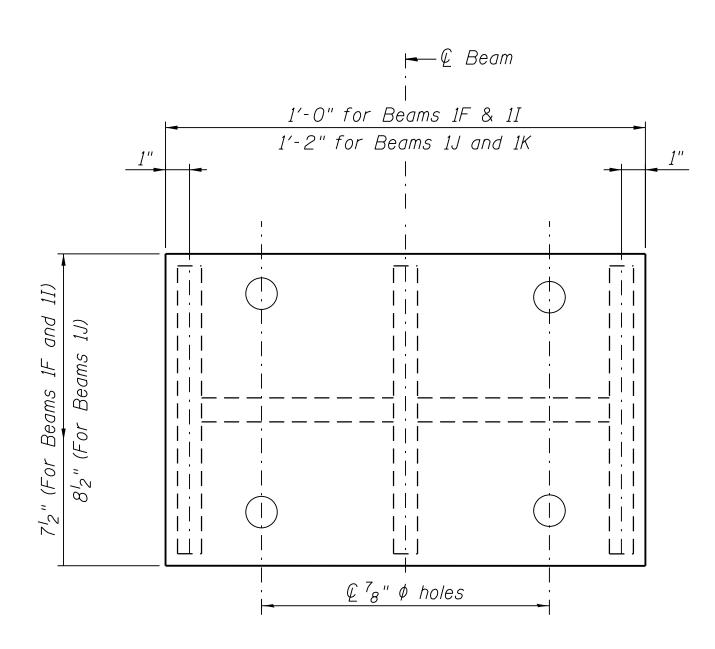


#### PLAN TALL STEEL EXTENSION


#### TABLE OF TALL EXTENSION HEIGHTS

Girder Number	Height
1F	10 <sup>13</sup> 16 "
<i>1J</i>	10 <sup>3</sup> 4"
1K	10 <sup>13</sup> 16 ''

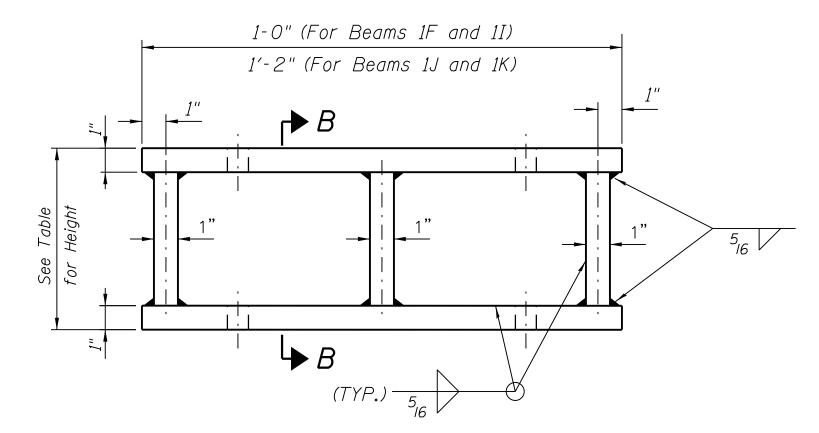


#### ELEVATION TALL STEEL EXTENSION

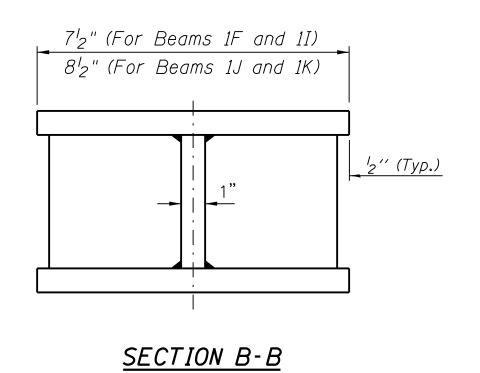

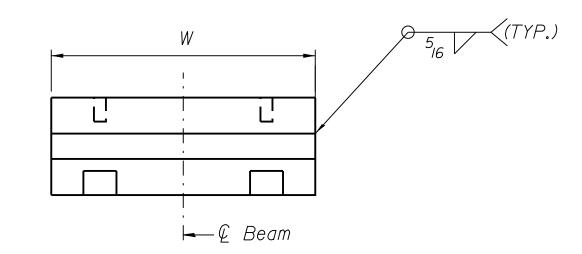

#### END VIEW SHORT STEEL EXTENSION

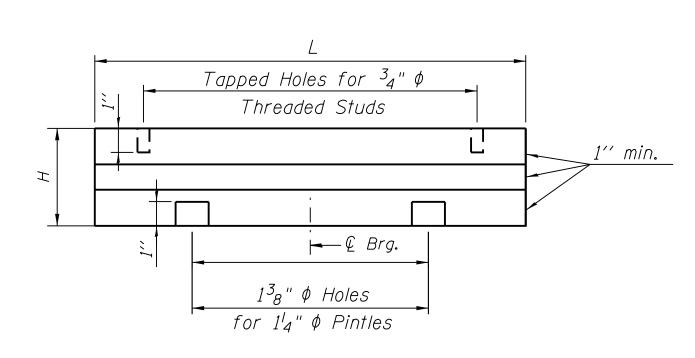

#### ELEVATION SHORT STEEL EXTENSION

#### TABLE OF SHORT EXTENSION DIMENSIONS

Girder Number	L	W	Н
West Abutment			
1C	1'-6"	1'-0"	2 <sup>15</sup> 16 "
1D	1'-6"	1'-0"	2 <sup>7</sup> 8"
1E	1'-2"	8"	29 <sub>16</sub> "
<i>16A</i>	1′-6"	1'-0"	1 <sup>7</sup> 8"
East Abutment			
1C	1'-6"	1'-0"	1 <sup>3</sup> 4"
1D	1'-6"	1'-O"	1/16"
1E	1'-2"	8½"	21/4"

#### Notes:

Prior to ordering any materials, the Contractor shall verify in the field all bearing height and shim thickness dimensions.





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ERRORS CAUSED, DIRECTLY OR INDIRECTLY,
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### 95th Terminal Improvement

15 West 95th Street (South Terminal) Chicago, IL 60628


IN CH	ARGE	S. KADERBEK
APPR	OVED BY	D.ZROKA
CHEC	KED BY	P.MAID
DESIG	SNED BY	L.SOMMER
DRAV	VN BY	T.SLEDGE
PROJ	ECT NO.	2012-0021
FILE	NAME	File Name
	2/9/17	ISSUED FOR CONSTRUCTION
MARK	DATE	DESCRIPTION
		NTIFIER DROS


| LOCATION IDENTIFIER: DR095

95TH ST. BRIDGE BEARING DETAILS (SHEET 4 OF 5) SN 016-0437

95TH-S-132B



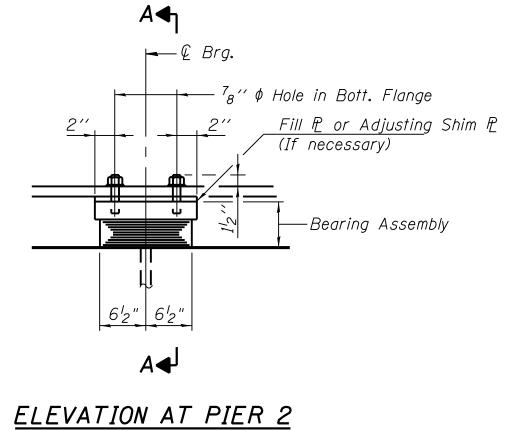

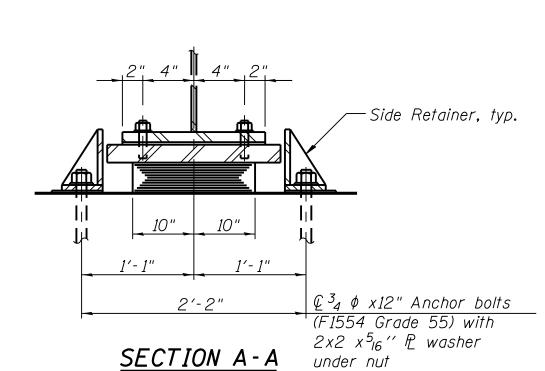


#### 

#### ELEVATION AT PIER 1


SECTION B-B

#### FIXED BEARING

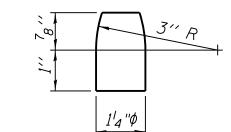

<u>PINTLE</u>

### TYPE I ELASTOMERIC EXP. BRG.

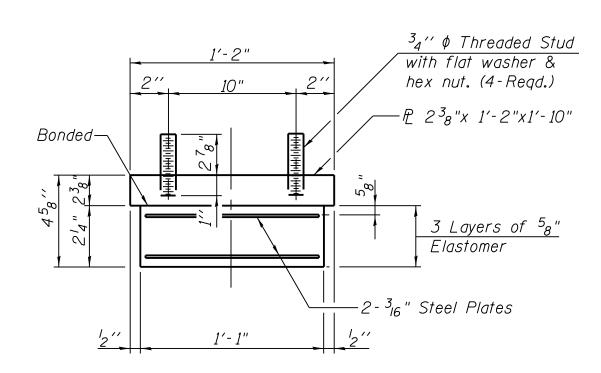

#### BEARING ASSEMBLY

Note:

l<sub>4</sub>'' Stainless steel plate, A240, Type 304, No. 1 finish

Fill plates and shim plates shall not be placed under Bearing Assembly.

#### Notes:


Anchor bolts shall be ASTM F1554 all-thread (or an Engineer-approved alternate material) of the grade(s) and diameter(s) specified. The corresponding specified grade of AASHTO M314 anchor bolts may be used in lieu of ASTM F1554.

Side retainers and other steel members required for the elastomeric bearing assembly shall be included in the cost of Elastomeric Bearing Assembly, Type I.

Beams shall be braced for stability during erection and

remain braced until deck is poured and cured.

Anchor bolts and side retainers at all supports shall be installed as each member is erected unless an equivalent temporary means of lateral restraint is used.

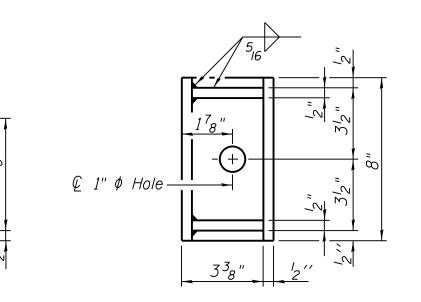

SIDE RETAINER

Equivalent rolled angle with stiffeners
will be allowed in lieu of welded plates.

## FILL PLATE TABLE

Beam No.	Pier 1	Pier 2
1A	1 <sub>8</sub> " x 9" x 1'-9 <sub>4</sub> "	1'4" x 1'-2" x 1'-10"
1B	<sup>5</sup> 8" x 9" x 1'-9 <sup>1</sup> 4"	<sup>9</sup> <sub>16</sub> " x 1'-2" x 1'-10"
1E	<sup>5</sup> 8" x 9" x 1'-9 <sup>1</sup> 4"	<sup>9</sup> <sub>16</sub> " x 1'-2" x 1'-10"
16C	" <sub>16"</sub> x 9"-x 1'-9 <sub>4</sub> "	<sup>9</sup> 16" x 1'-2" x 1'-10"



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#### 95th Terminal Improvement

15 West 95th Street (South Terminal) Chicago, IL 60628

IN CH	ARGE	S. KADERBEK
APPR	OVED BY	D.ZROKA
CHEC	KED BY	P.MAID
DESIG	ENED BY	L.SOMMER
DRAV	VN BY	T.SLEDGE
PROJ	ECT NO.	2012-0021
FILE N	NAME	File Name
	2/9/17	ISSUED FOR CONSTRUCTION
MARK	DATE	DESCRIPTION
LOCATION IDENTIFIER: DR095		

LOCATION IDENTIFIER: DR095


95TH ST. BRIDGE BEARING DETAILS (SHEET 5 OF 5) SN 016-0437

95TH-S-133

FILE NAME =  $070_DR095_S-133.dgn$ PLOT DATE = 8/31/2016





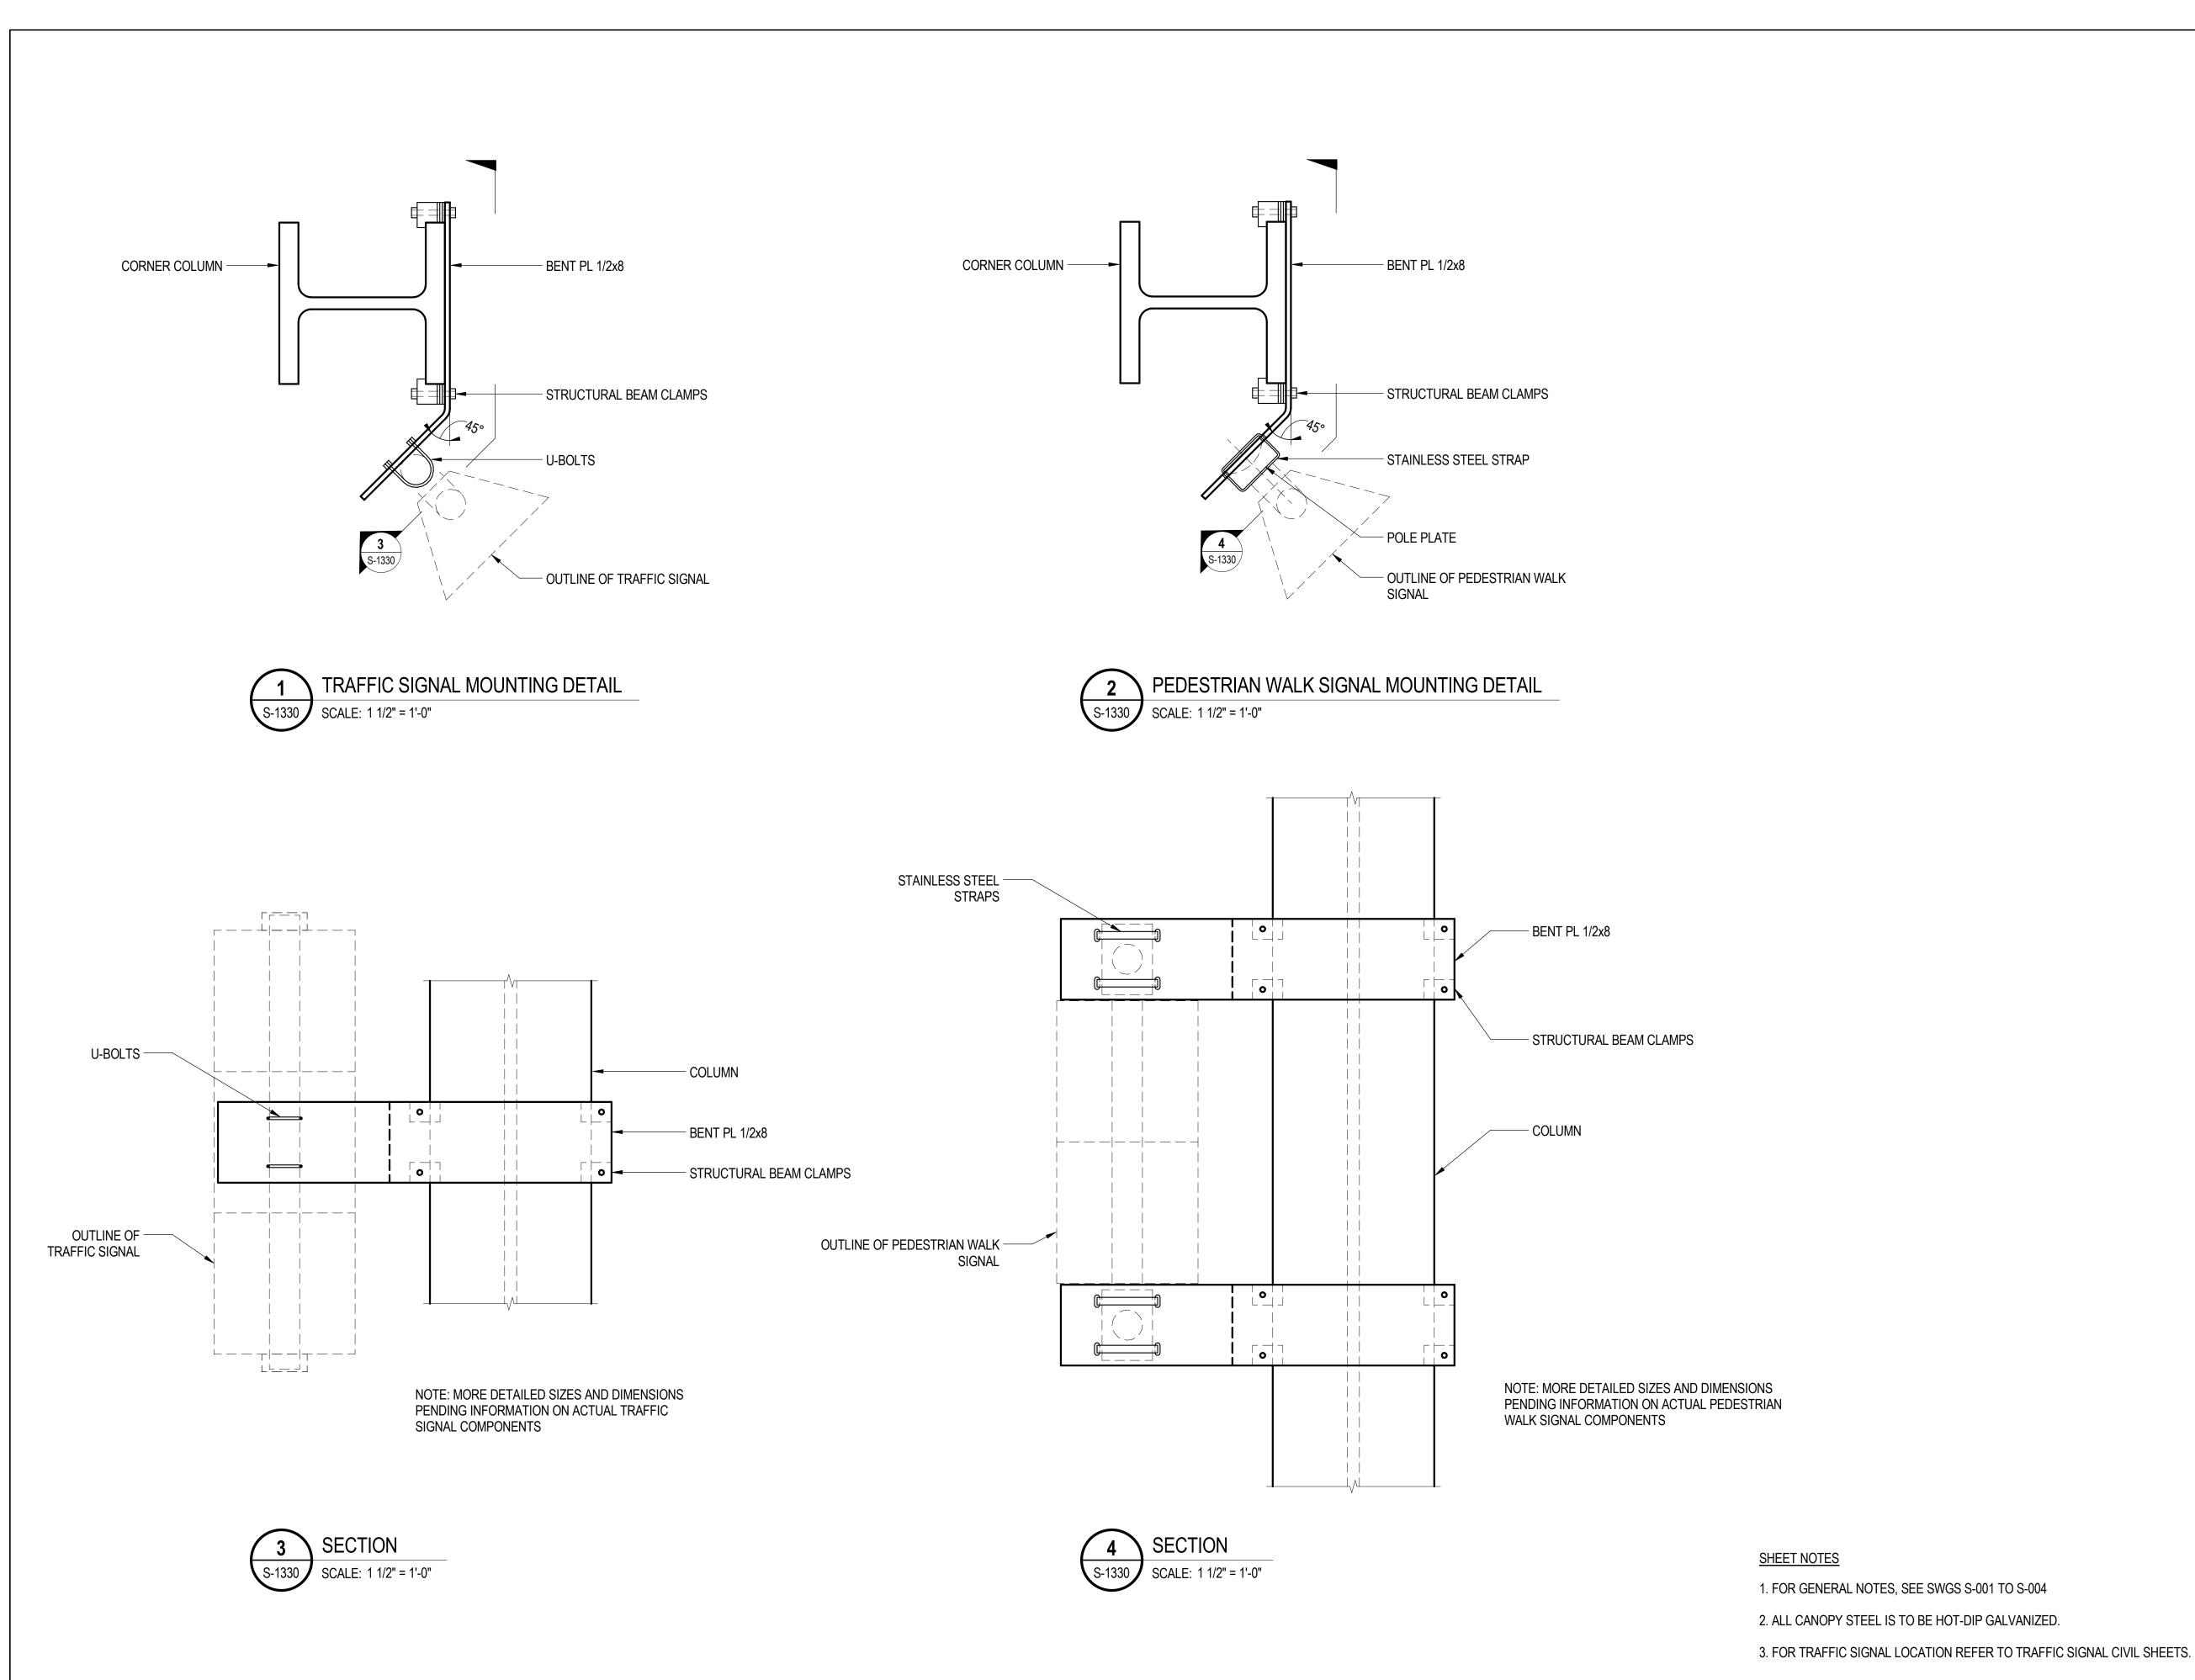





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### 95th Terminal Improvement 15 West 95th Street (South Terminal)


15 West 95th Street (South Terminal) Chicago, IL 60628


MARK	DATE	DESCRIPTION
	2/9/17	ISSUED FOR CONSTRUCTION
FILE NAME		D095 S-RoofCENTRAL
CHECKED BY DESIGNED BY DRAWN BY PROJECT NO.		2012-0021.02
		D. LALLY
		S. CITKO
		R.S. NAIR
APPROVED BY		J. JAKALSKI
IN CH	ARGE	J. JAKALSKI


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**BUS CANOPY DETAILS - 4** 







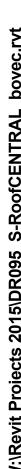


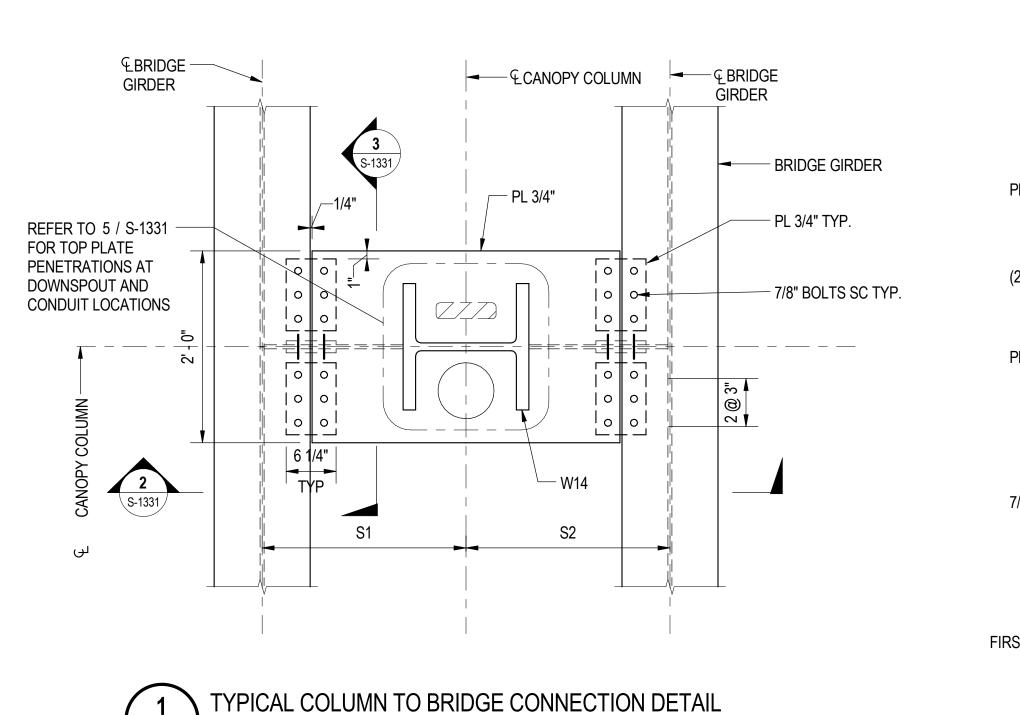


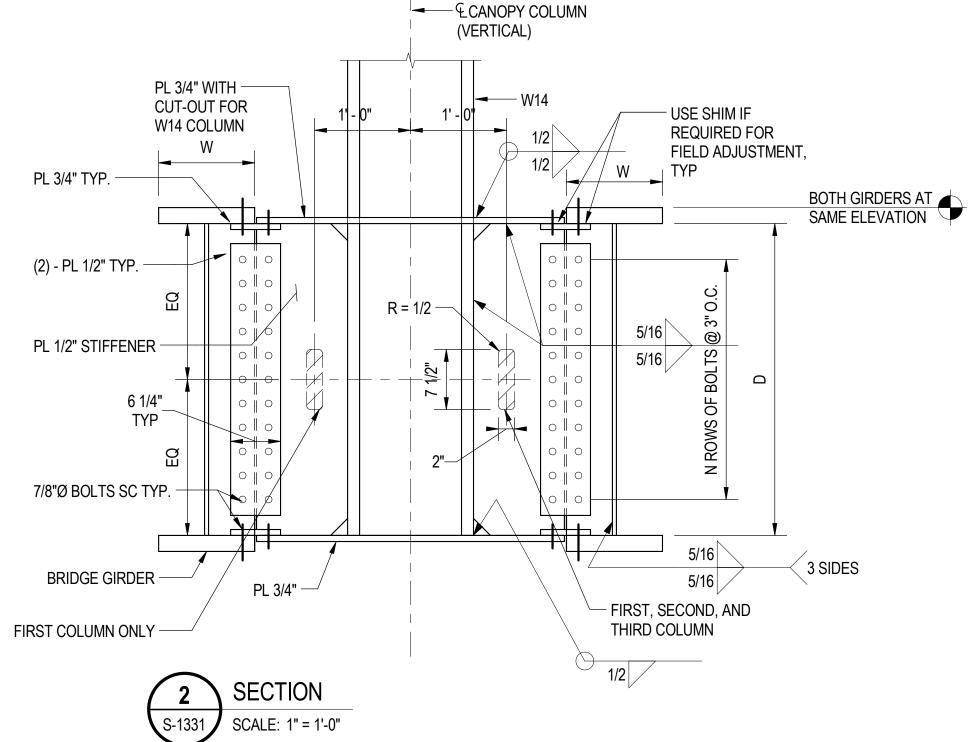_	YPIC CON		<del>-</del>	_	
BRIDGE	D	W	S1	S2	N
SBB	39"	18"	2'-5"	3'-0"	9
95TH-S	34"	12"	2'-1"	2'-2"	8
95TH-N	34"	12"	1'-10"	2'-5"	8
NBB	TBD	TBD	2'-1 1/2"	1'-10 1/2"	9

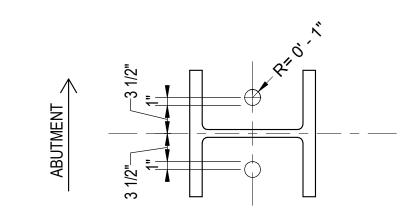

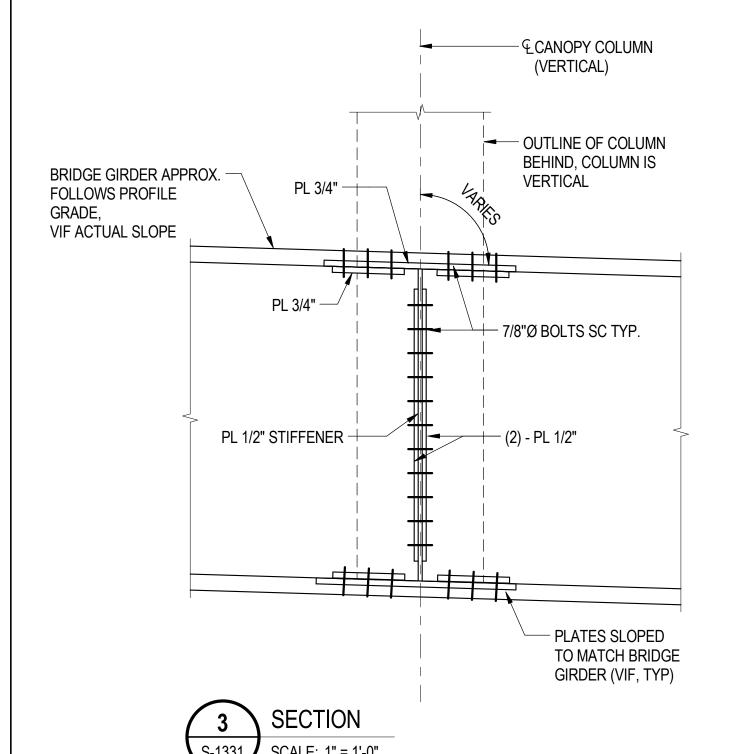

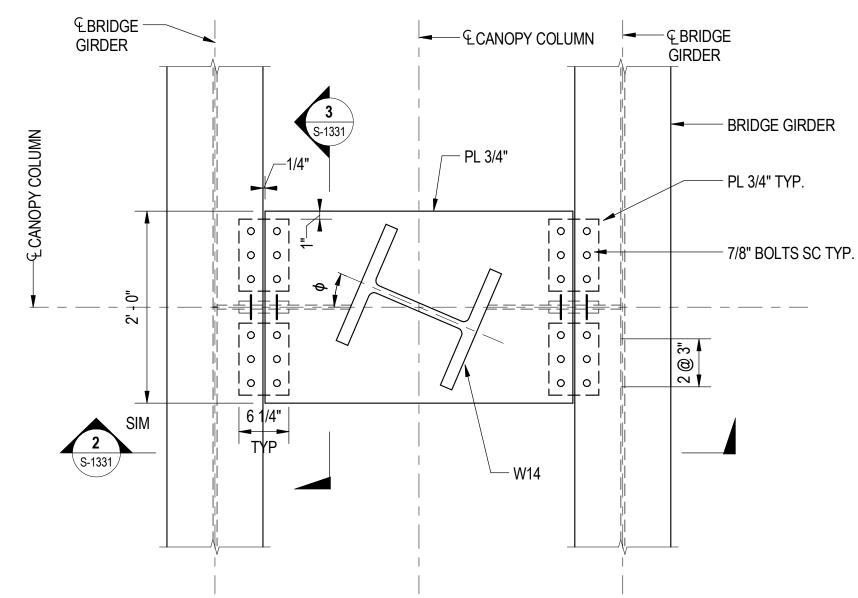

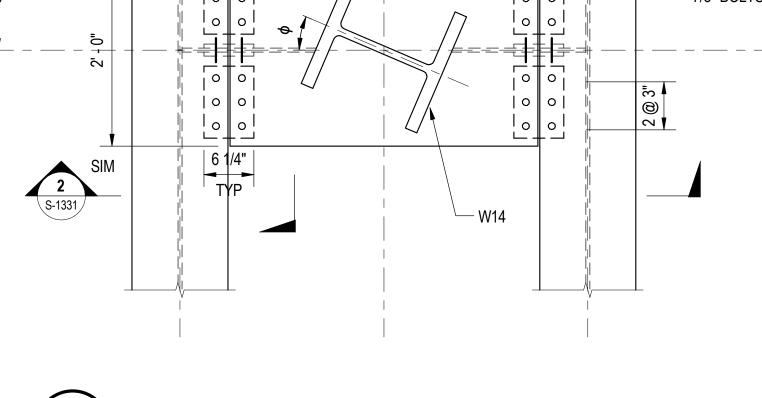

TYPICAL CORNER COLUMN TO BRIDGE CONNECTION DETAIL

#### THIRD COLUMN **CORNER BRIDGE** CONNECTIONS ANGLE $(\phi)$ S,W,D,N 23.2° SEE TYP 22.8° SEE TYP 21.9° SEE TYP 22.1° SEE TYP 22.5° SEE TYP 22.5° SEE TYP

SBB-9

95-9

95-10

95-19

NBB-1

NBB-10

22.5°

22.5°

SEE TYP

SEE TYP

NOTE: FIRST COLUMN IS ONE CLOSEST TO TERMINAL BUILDING FIRST COLUMN

SECOND COLUMN

DOWNSPOUT AND CONDUIT PENETRATIONS IN TOP PLATE SCALE: 1" = 1'-0"

### SHEET NOTES

1. FOR GENERAL NOTES, SEE DWGS S-001 TO S-004

2. ALL CANOPY STEEL IS TO BE HOT-DIP GALVANIZED.





**SENSITIVE SECURITY INFORMATION** 


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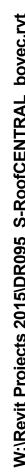
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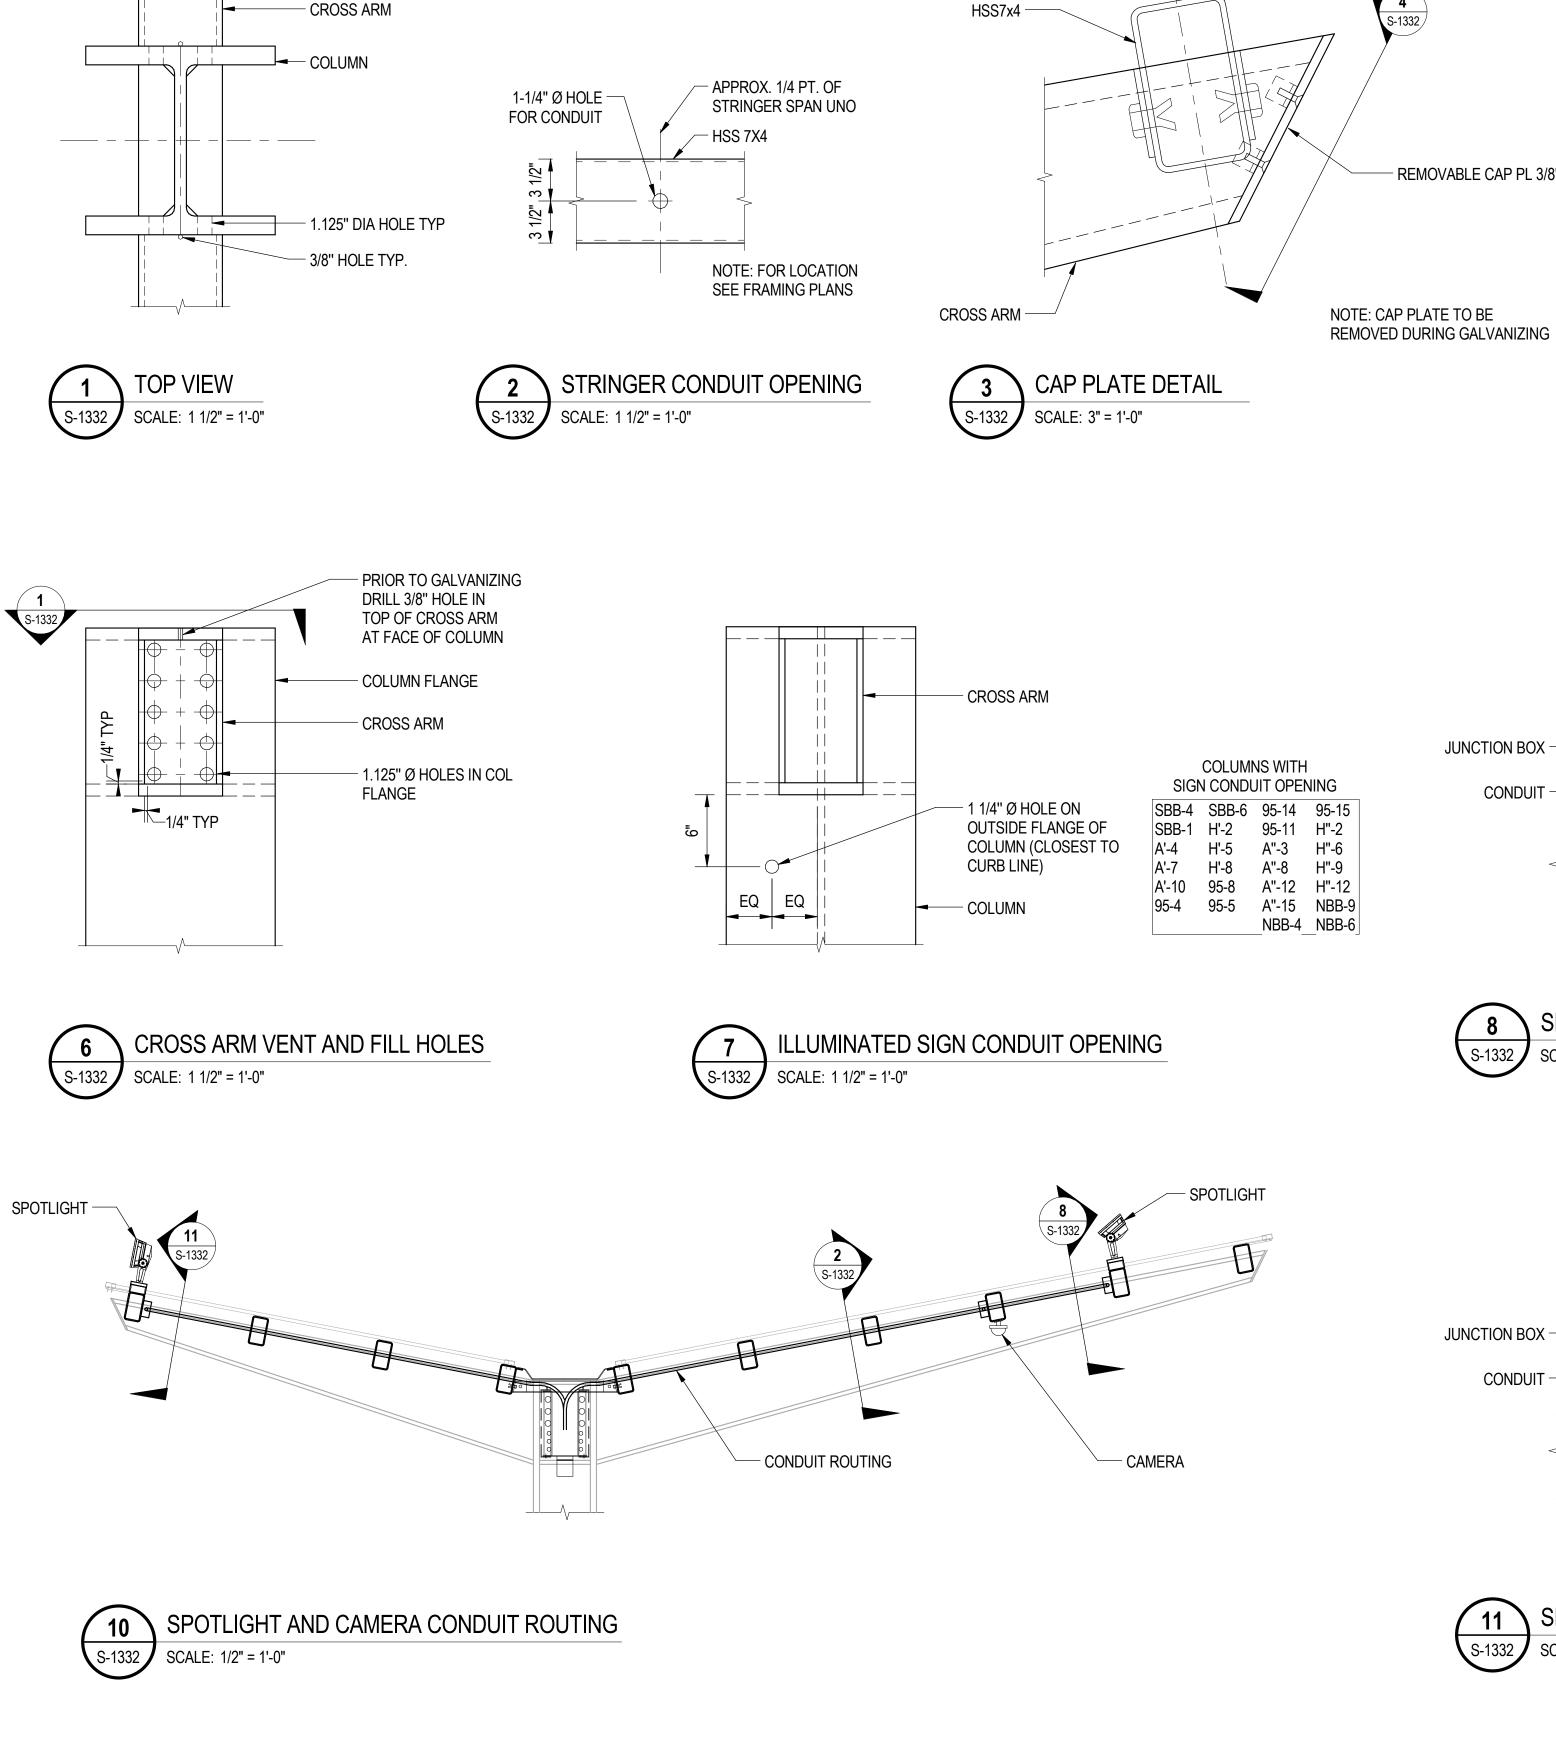
## 95th Terminal Improvement 15 West 95th Street (South Terminal) Chicago, IL 60628


IN CH	ARGE	J. JAKALSKI	
APPR	OVED BY	J. JAKALSKI	
CHEC	KED BY	R.S. NAIR	
DESIG	SNED BY	S. CITKO	
DRAV	VN BY	C. BOVE	
PROJ	ECT NO.	2012-0021.02	
FILE	NAME	D095_S-Roof	CENTRAL
	2/9/17	ISSUED FOR CO	ONSTRUCTION
MARK	DATE	DESCRIPTION	J
LOC	ATION ID	ENTIFIER:	DR095

**BUS CANOPY DETAILS - 5** 





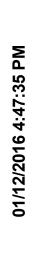

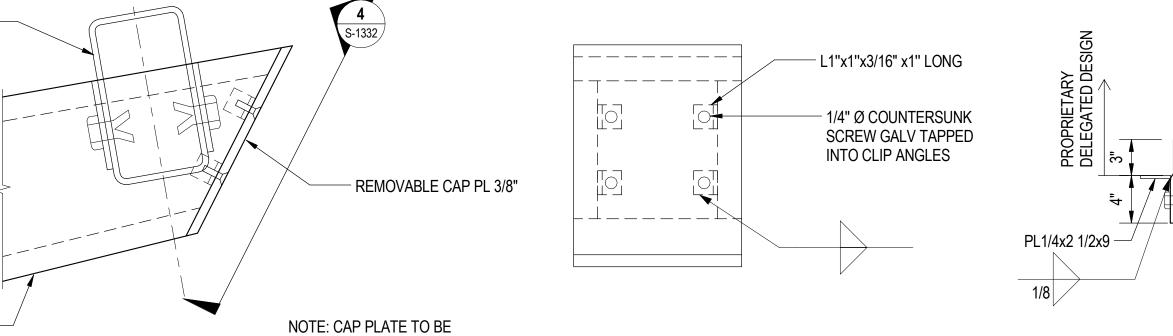


JUNCTION BOX -

S-1332

SCALE: 1 1/2" = 1'-0"

CONDUIT

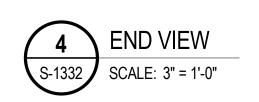


1/4" Ø BOLTS WITH LOCK


WASHERS TAPPED INTO


PLATE TYP.


1/2" NOTCH IN ONE CORNER FOR CABLE


SPOTLIGHT BRACKET - INTERIOR STRINGER

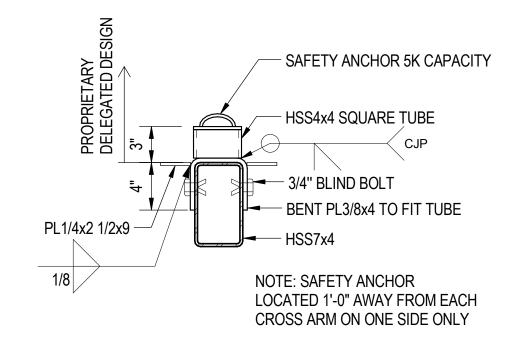


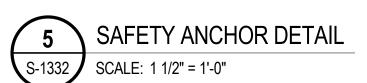

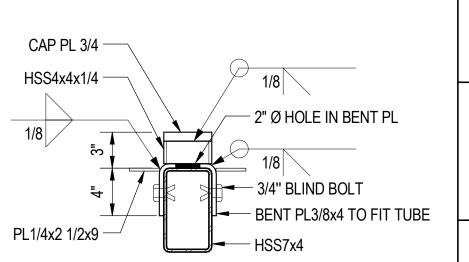


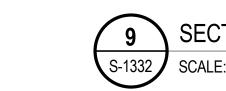

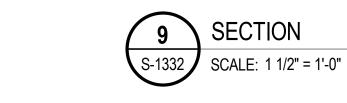

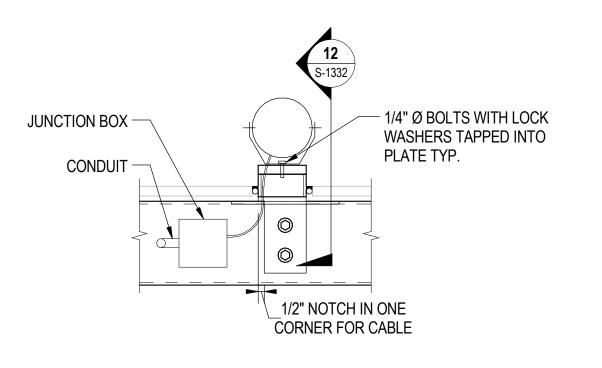



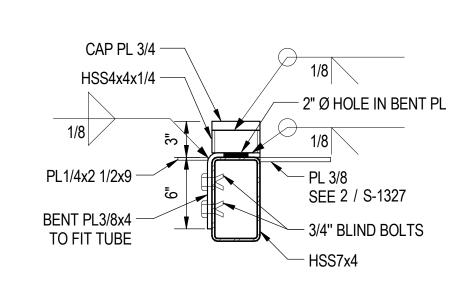





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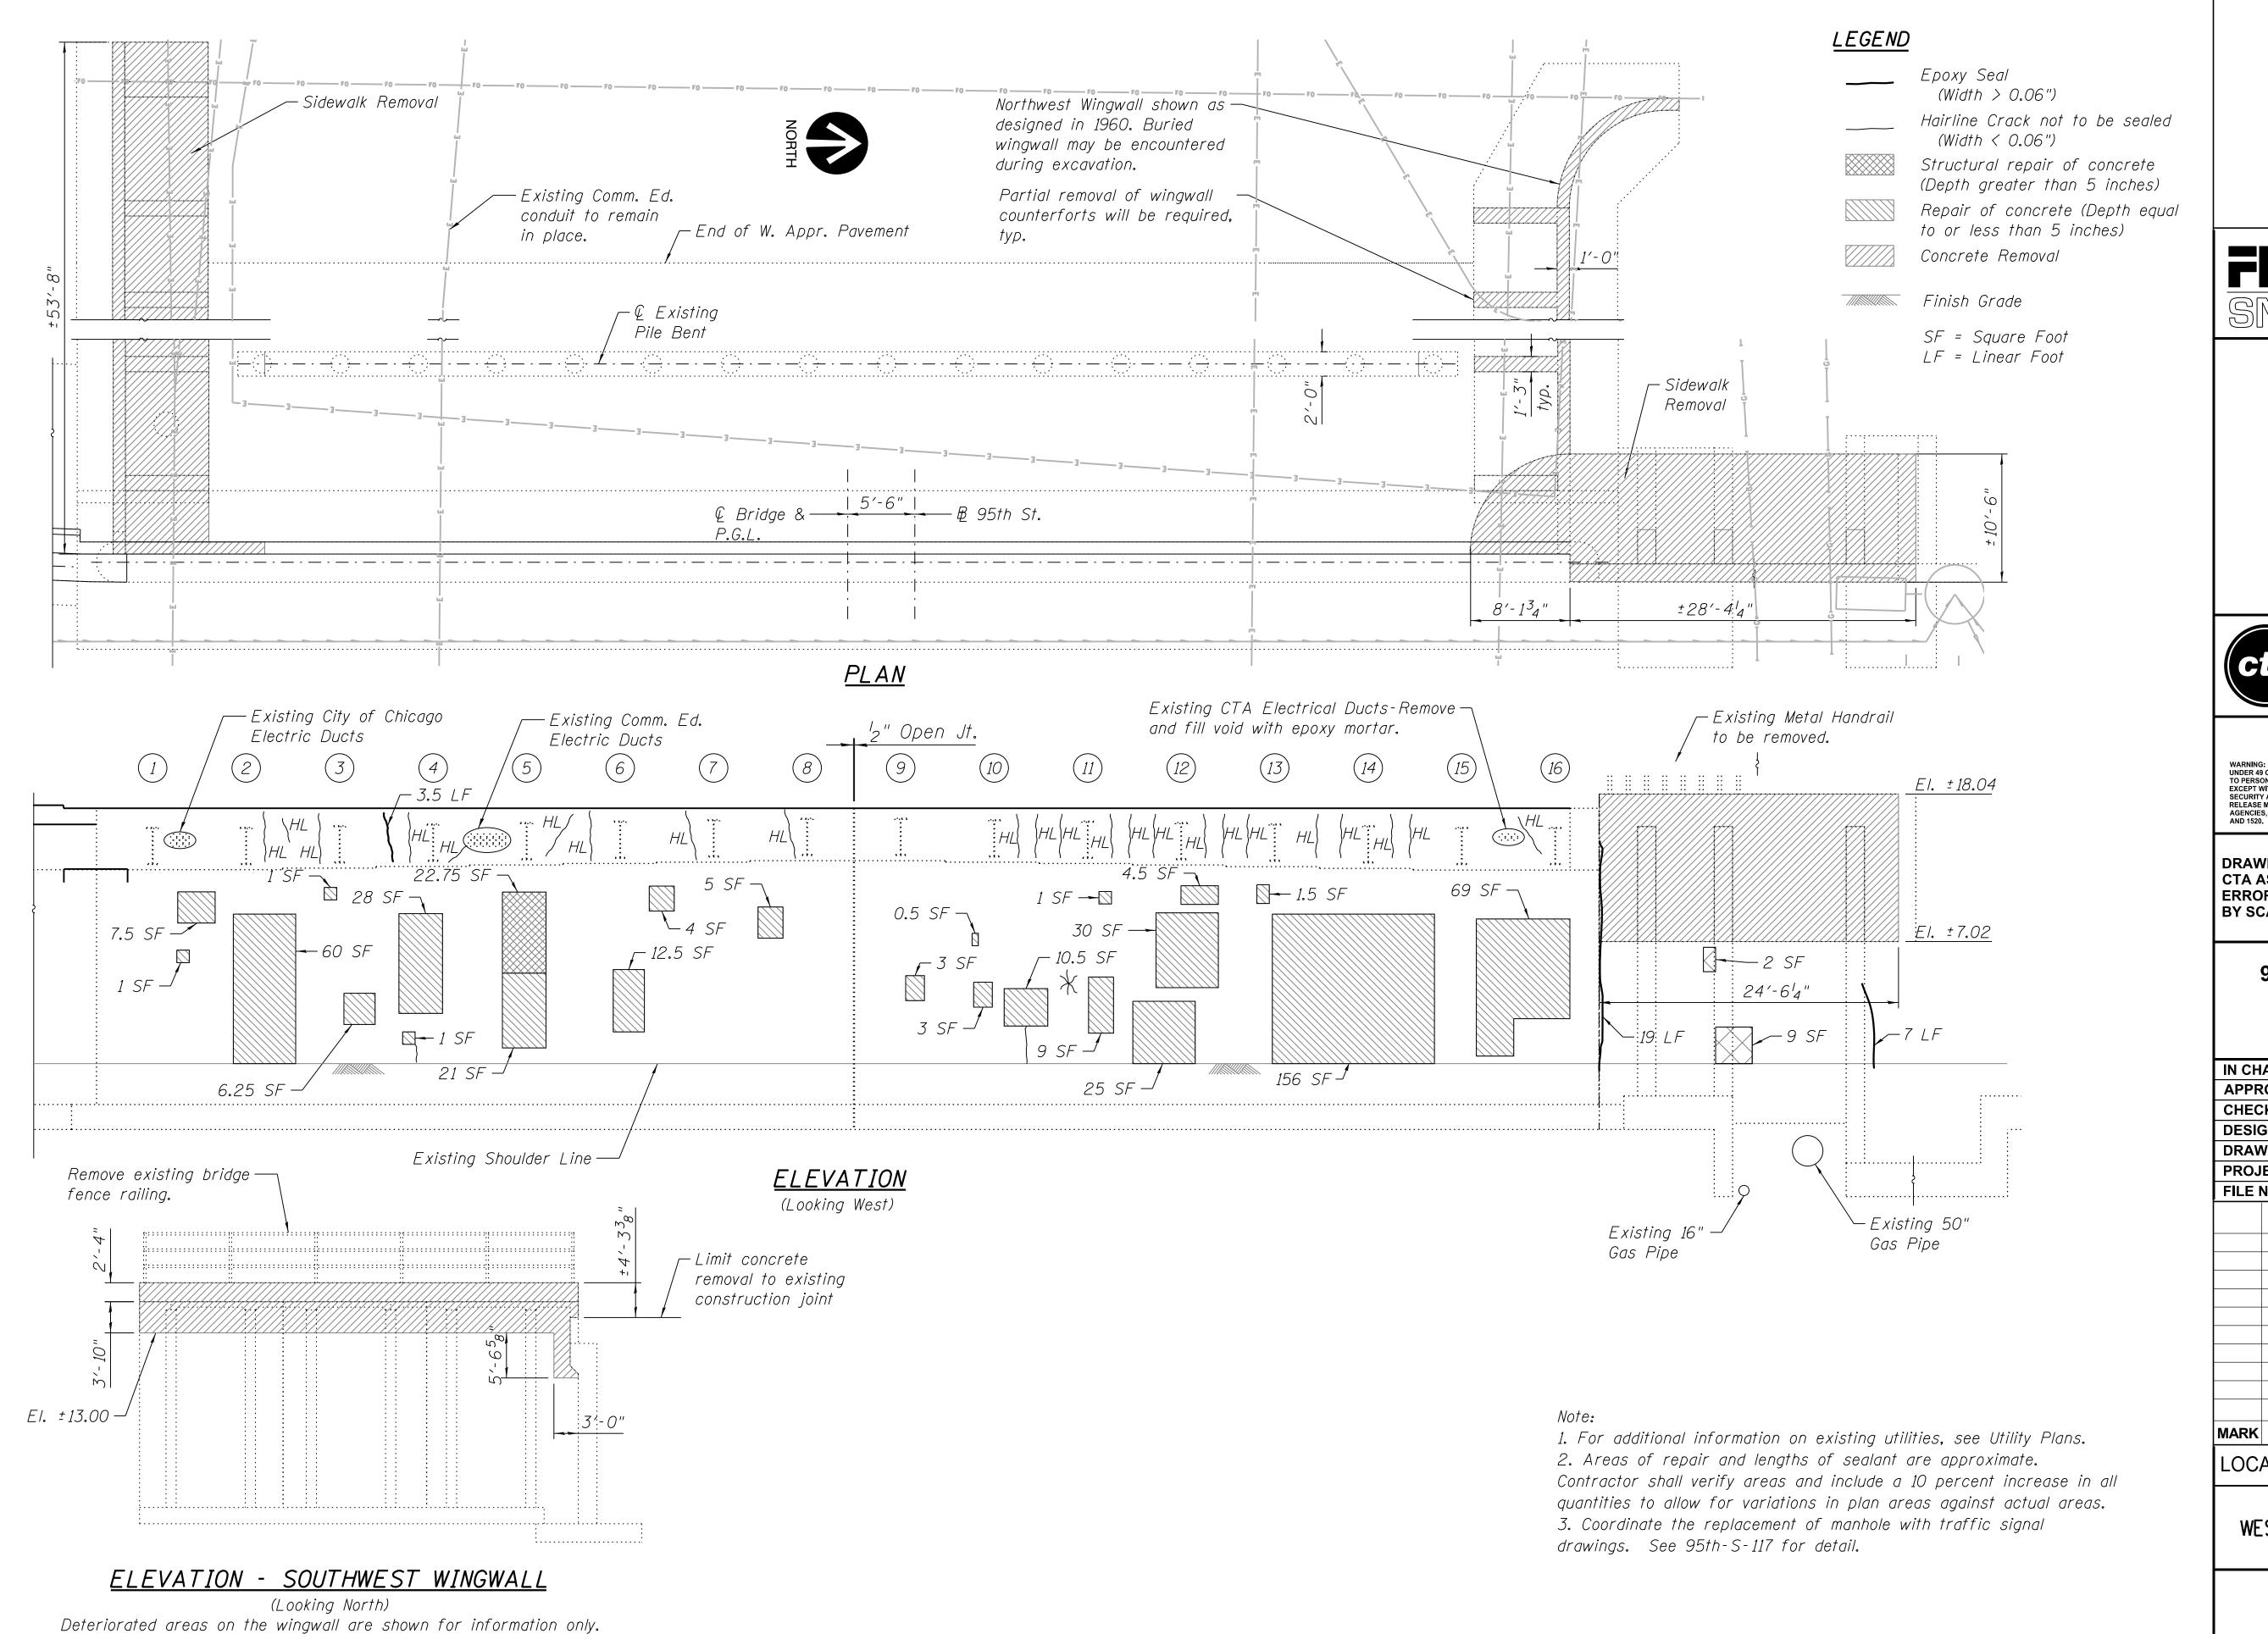
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## 95th Terminal Improvement

15 West 95th Street (South Terminal) Chicago, IL 60628

IN CH	ARGE	J. JAKALSKI	
APPR	OVED BY	J. JAKALSKI	
CHECKED BY		R.S. NAIR	
DESIGNED BY	S. CITKO		
DRAWN BY		D. LALLY	
PROJECT NO.	2012-0021.02		
FILE N	NAME	D095_S-Roof	<b>FCENTRAL</b>
	2/9/17	ISSUED FOR C	ONSTRUCTION
MARK	DATE	DESCRIPTION	N
		•	

**BUS CANOPY DETAILS - 6** 



070\_DR095\_S-134 8/31/2016

FILE NAME



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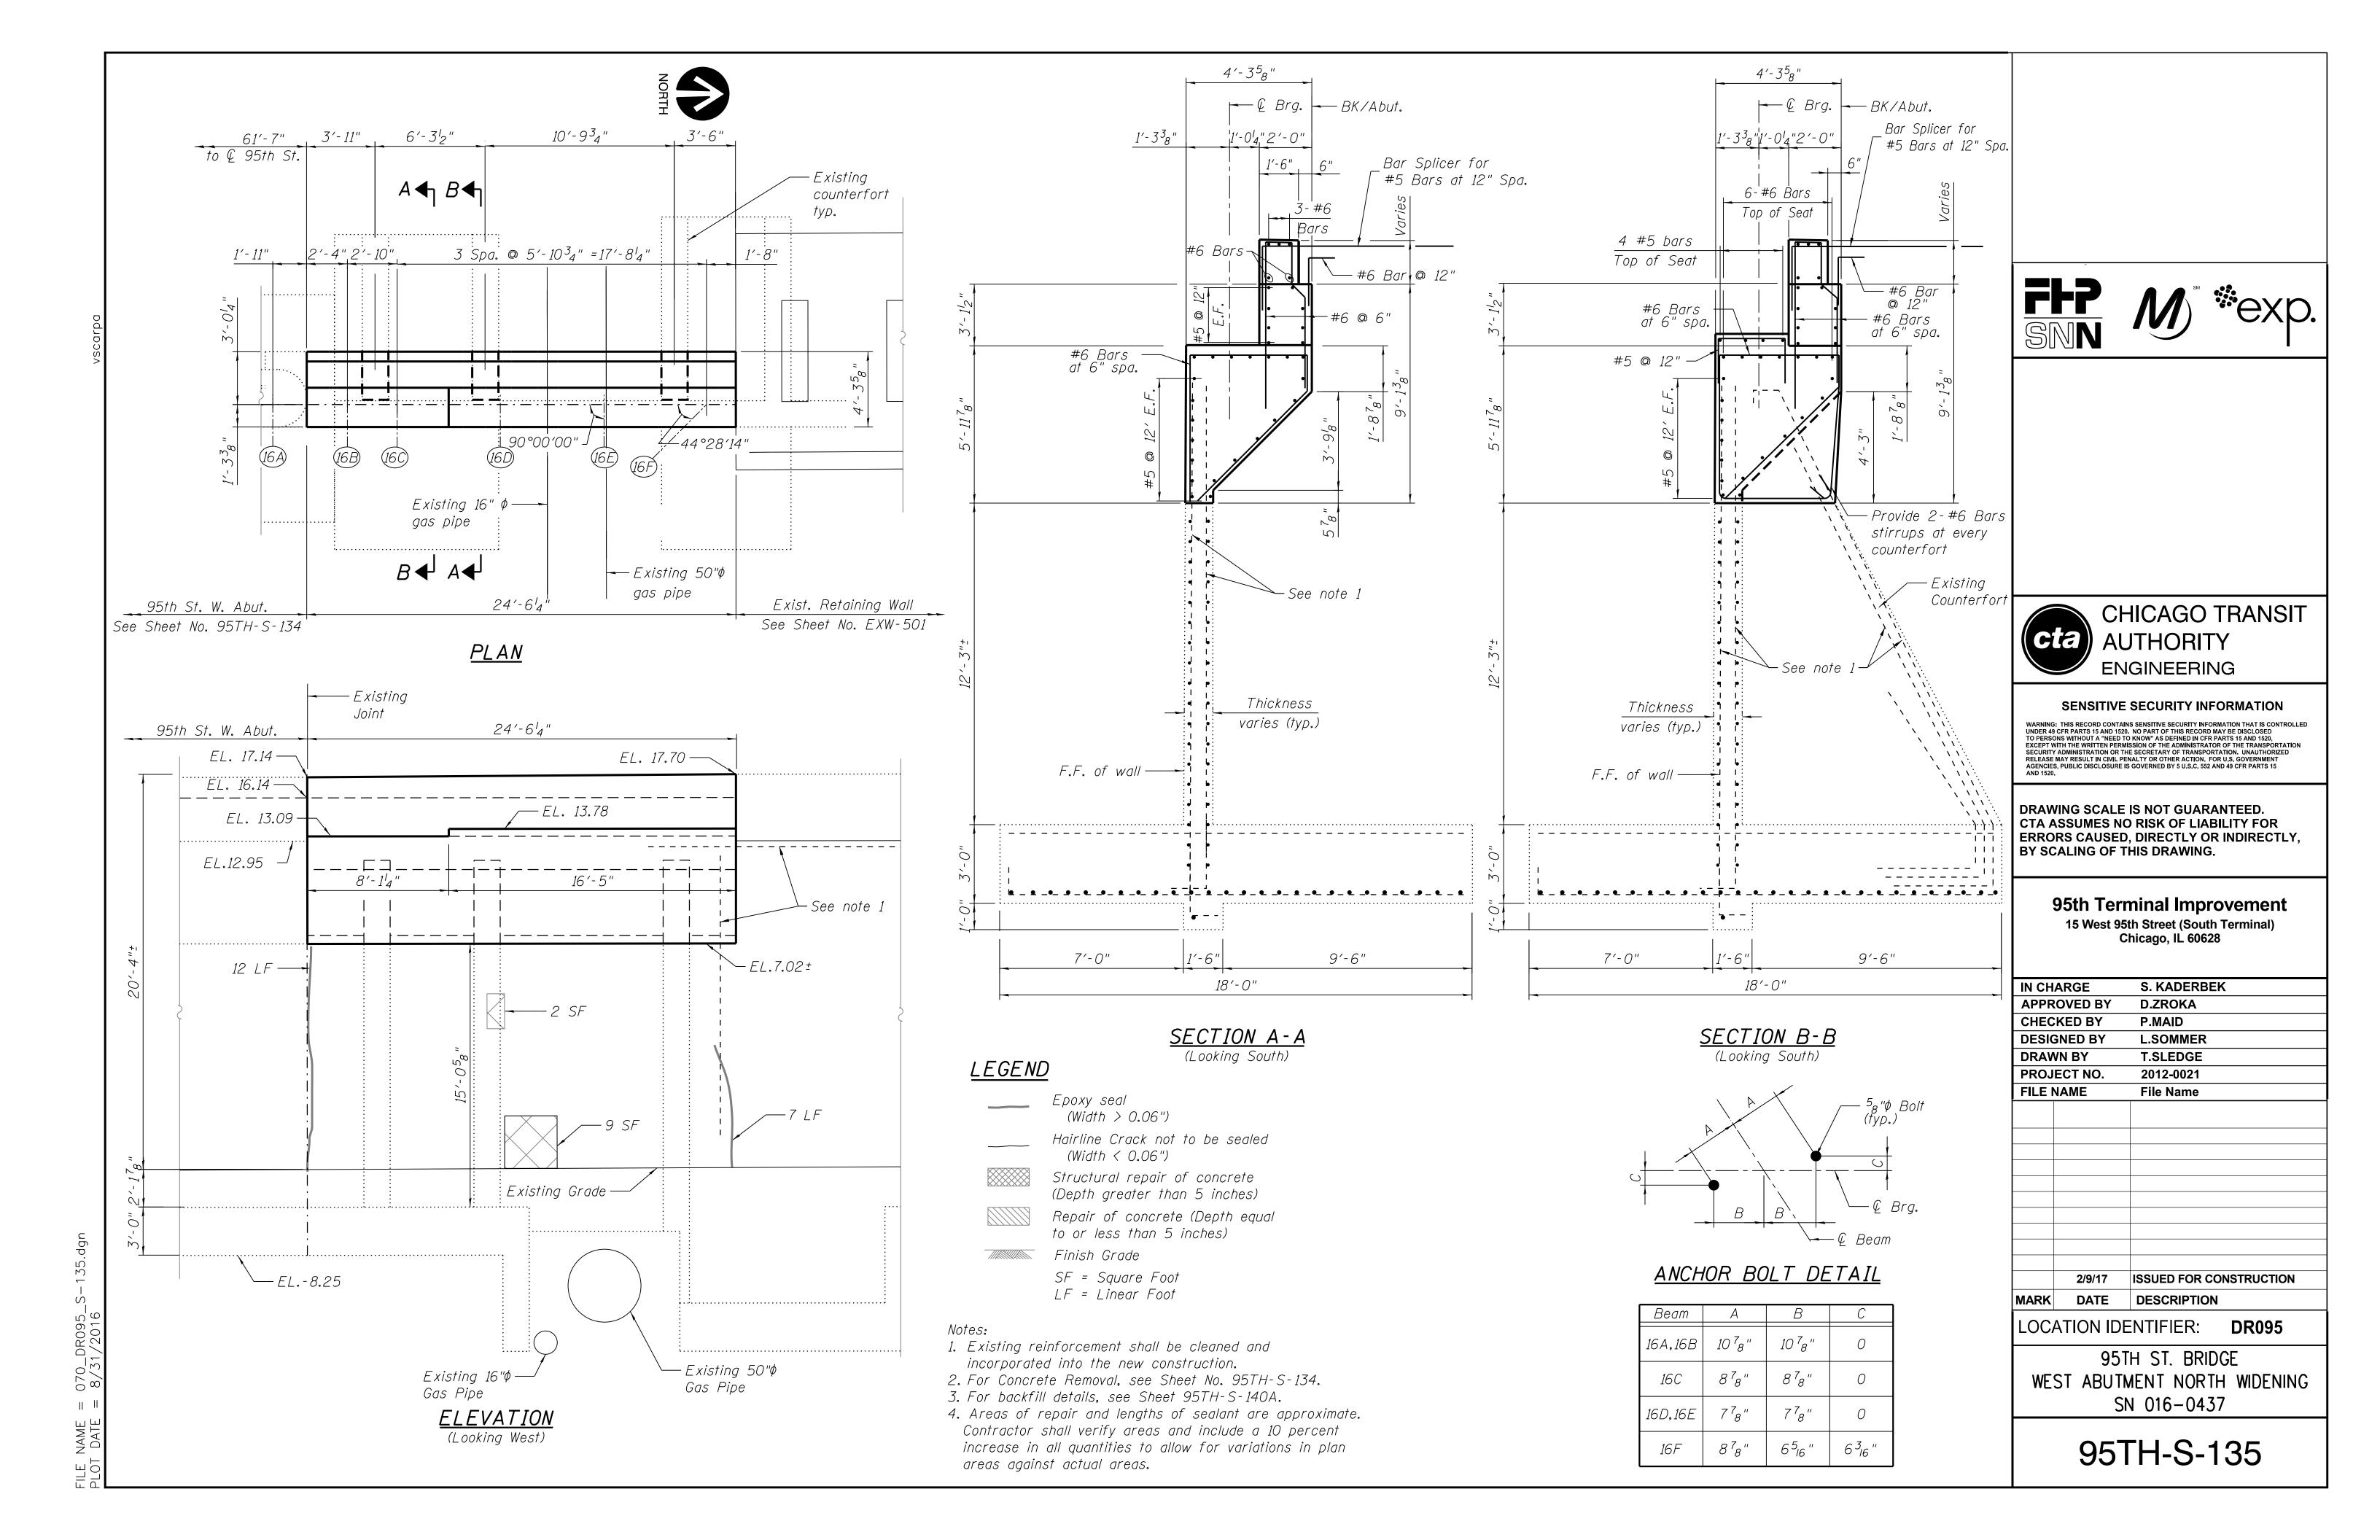
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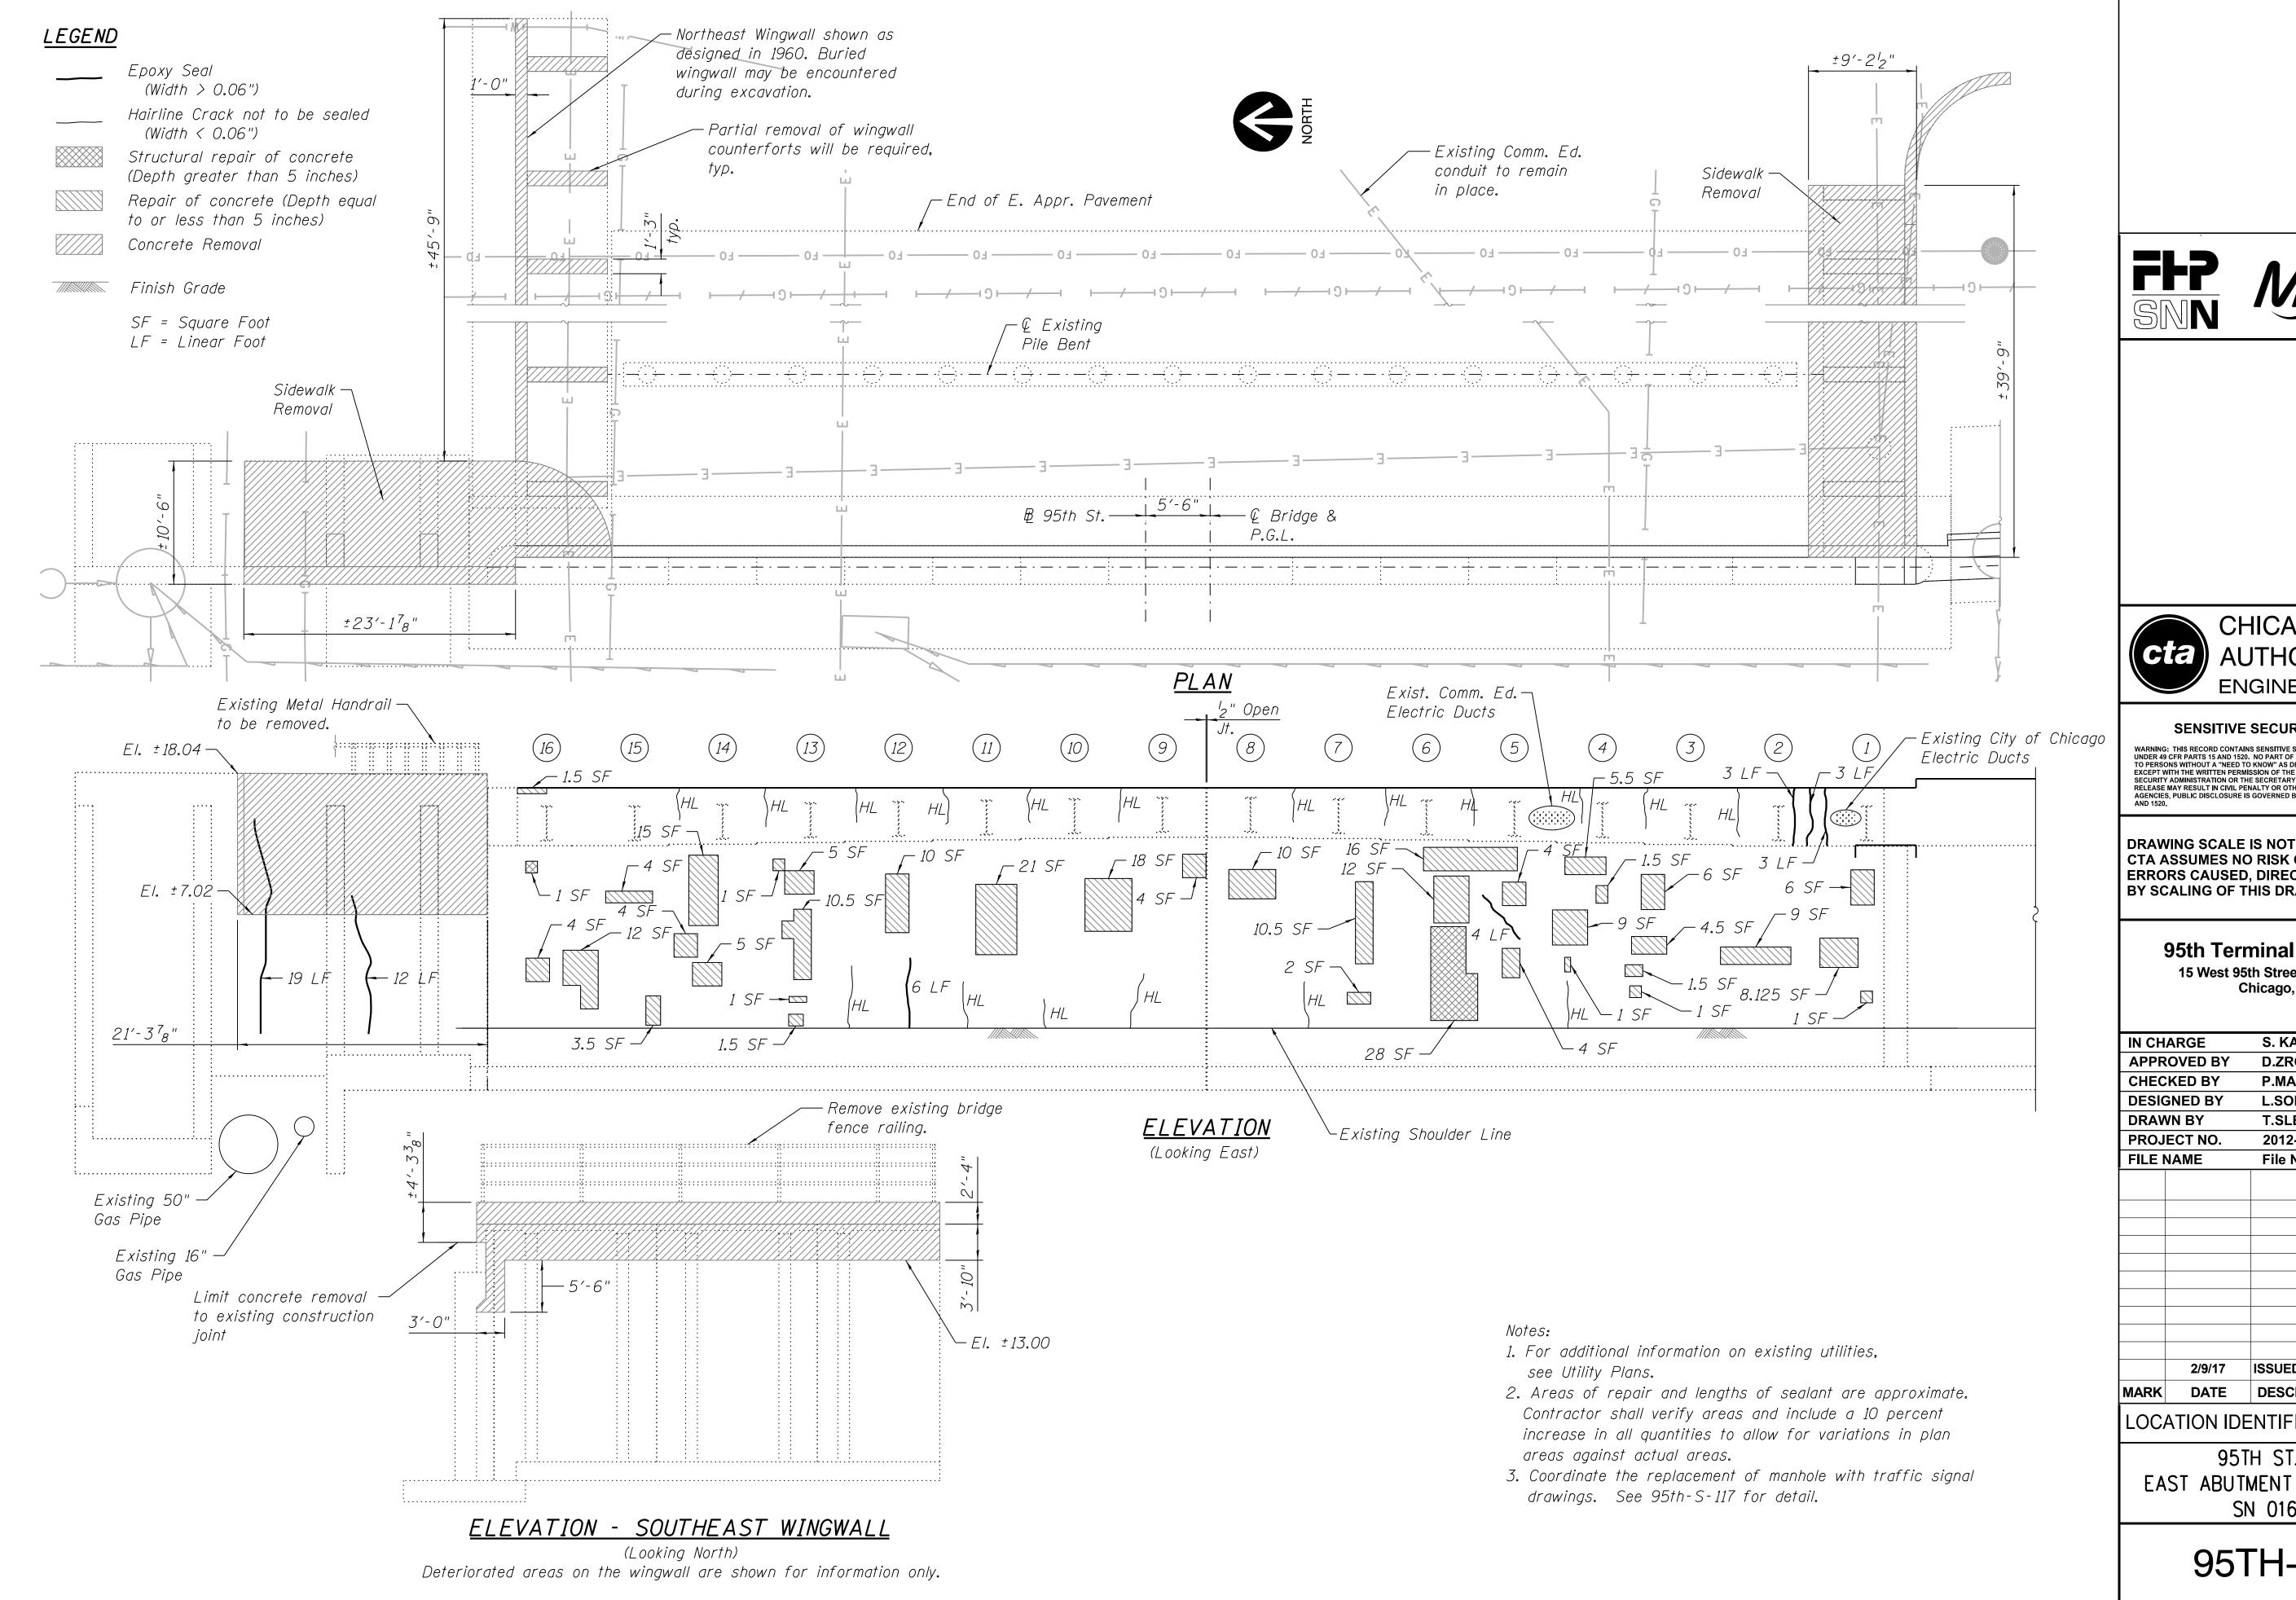
## 95th Terminal Improvement

15 West 95th Street (South Terminal) Chicago, IL 60628

IN CH	ARGE	S. KADERBEK
APPR	OVED BY	D.ZROKA
CHEC	KED BY	P.MAID
DESIG	ENED BY	L.SOMMER
DRAV	VN BY	T.SLEDGE
PROJ	ECT NO.	2012-0021
FILE 1	NAME	File Name
		+
	2/9/17	ISSUED FOR CONSTRUCTION
MARK	DATE	DESCRIPTION
LOC	ATION IDE	ENTIFIER: <b>DR095</b>

95TH ST. BRIDGE WEST ABUTMENT REPAIR DETAILS SN 016-0437









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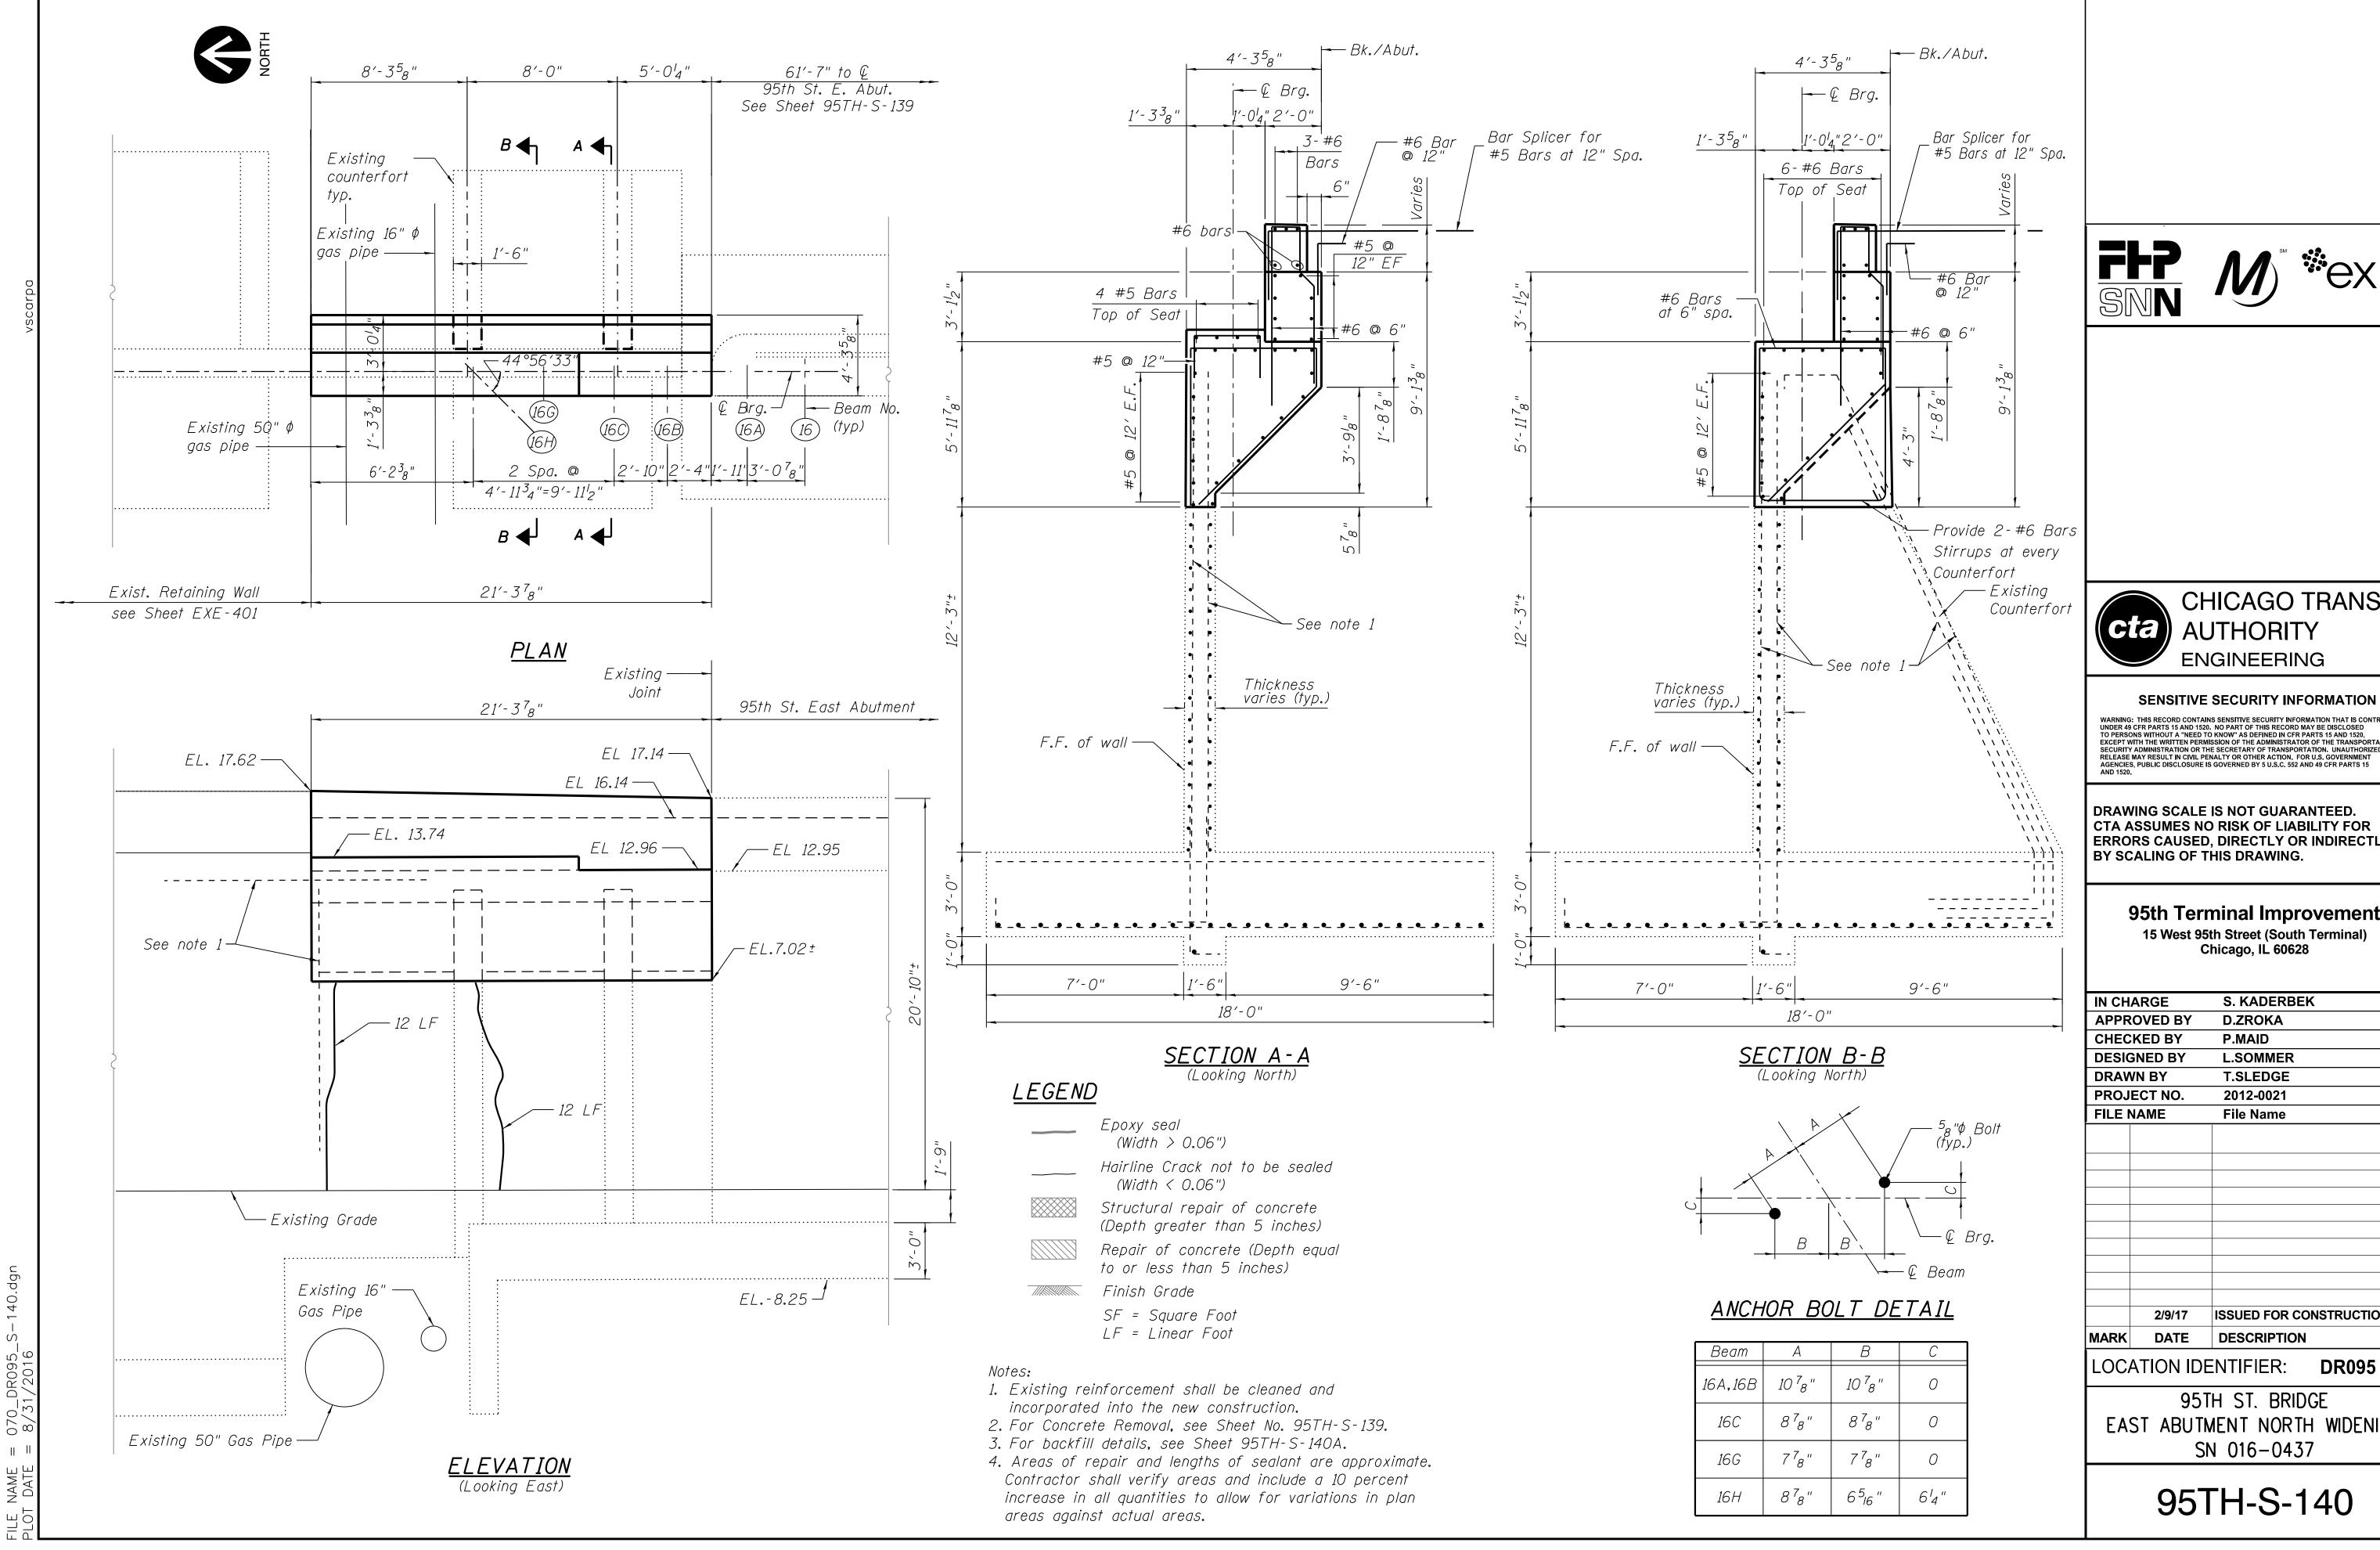
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## **95th Terminal Improvement**

15 West 95th Street (South Terminal) Chicago, IL 60628

IN CH	ARGE	S. KADERBEK	
APPR	OVED BY	D.ZROKA	
CHEC	KED BY	P.MAID	
DESIC	SNED BY	L.SOMMER	
DRAV	VN BY	T.SLEDGE	
PROJ	ECT NO.	2012-0021	
FILE N	NAME	File Name	
	2/9/17	ISSUED FOR CO	NSTRUCTION
MARK	DATE	DESCRIPTION	
LOC	ATION IDE	NTIFIER:	DR095

95TH ST. BRIDGE EAST ABUTMENT REPAIR DETAILS SN 016-0437





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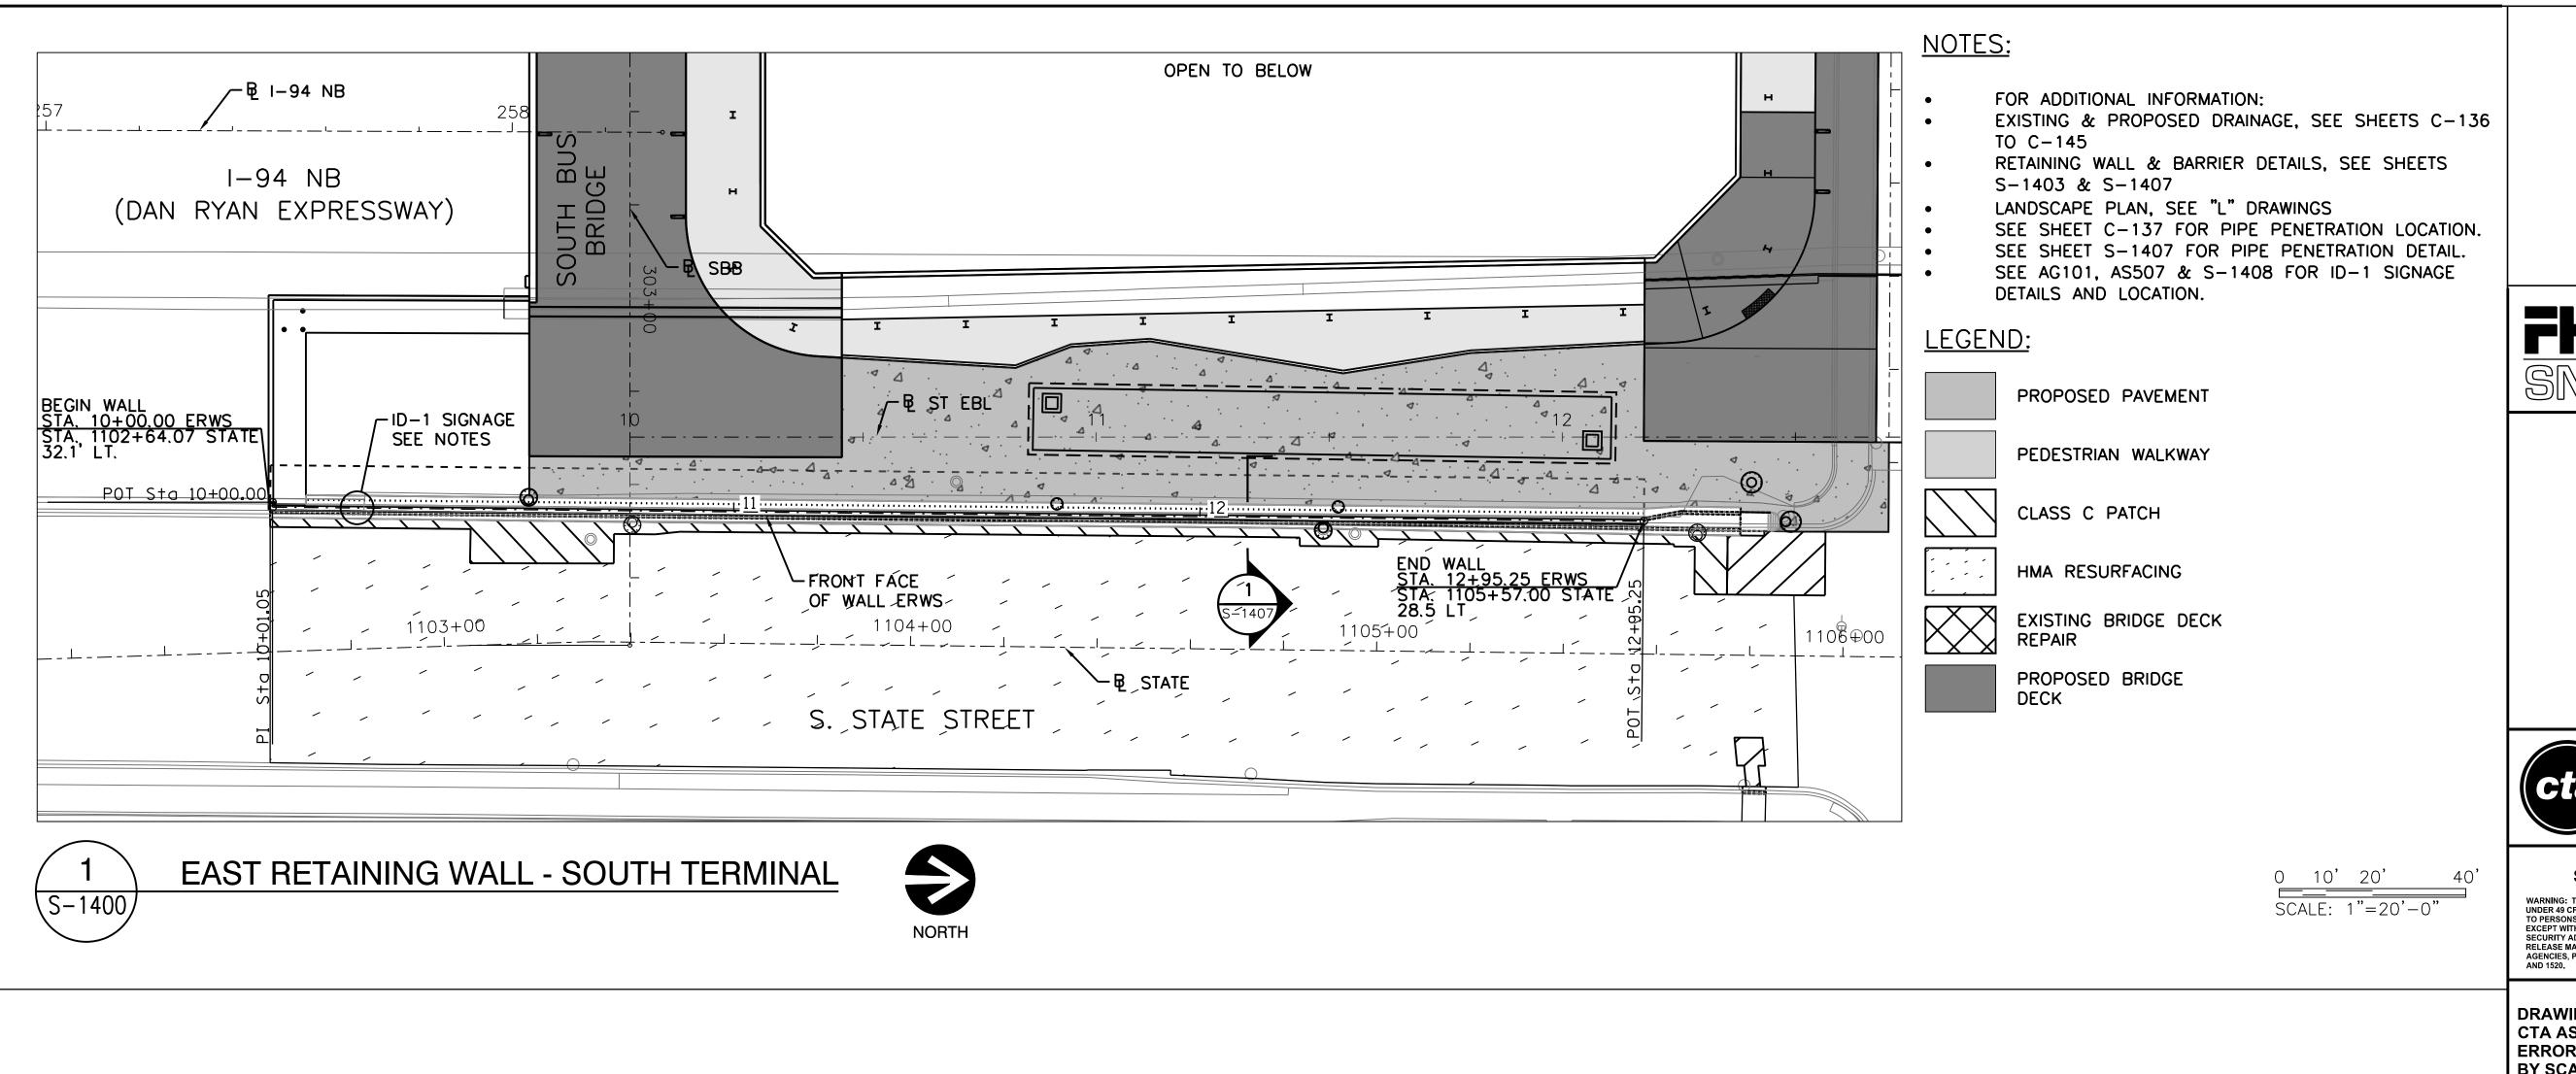
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## **95th Terminal Improvement**

15 West 95th Street (South Terminal) Chicago, IL 60628

IN CH	AKGE	S. NADERBEN
APPROVED BY		D.ZROKA
CHECKED BY		P.MAID
DESIG	GNED BY	L.SOMMER
DRAWN BY PROJECT NO.		T.SLEDGE
		2012-0021
FILE I	NAME	File Name
	2/0/47	ISSUED FOR CONSTRUCTION
	2/9/17	ISSUED FOR CONSTRUCTION
MARK	DATE	DESCRIPTION
LOC	ATION IDE	ENTIFIER: <b>DR095</b>

EAST ABUTMENT NORTH WIDENING



# CHICAGO TRANSIT AUTHORITY ENGINEERING

### SENSITIVE SECURITY INFORMATION

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## 95th Terminal Improvement


15 West 95th Street (South Terminal) Chicago, IL 60628

IN CH	ARGE	S. KADERBEK
APPR	OVED BY	D.ZROKA
CHEC	KED BY	P.MAID
DESIG	SNED BY	L.SOMMER
DRAV	VN BY	T.SLEDGE
PROJ	ECT NO.	2012-0021
FILE I	NAME	File Name
	2/9/17	ISSUED FOR CONSTRUCTION
		DESCRIPTION

LOCATION IDENTIFIER: DR095

PLAN & PROFILE SOUTH TERMINAL EAST RETAINING WALL

S-1400

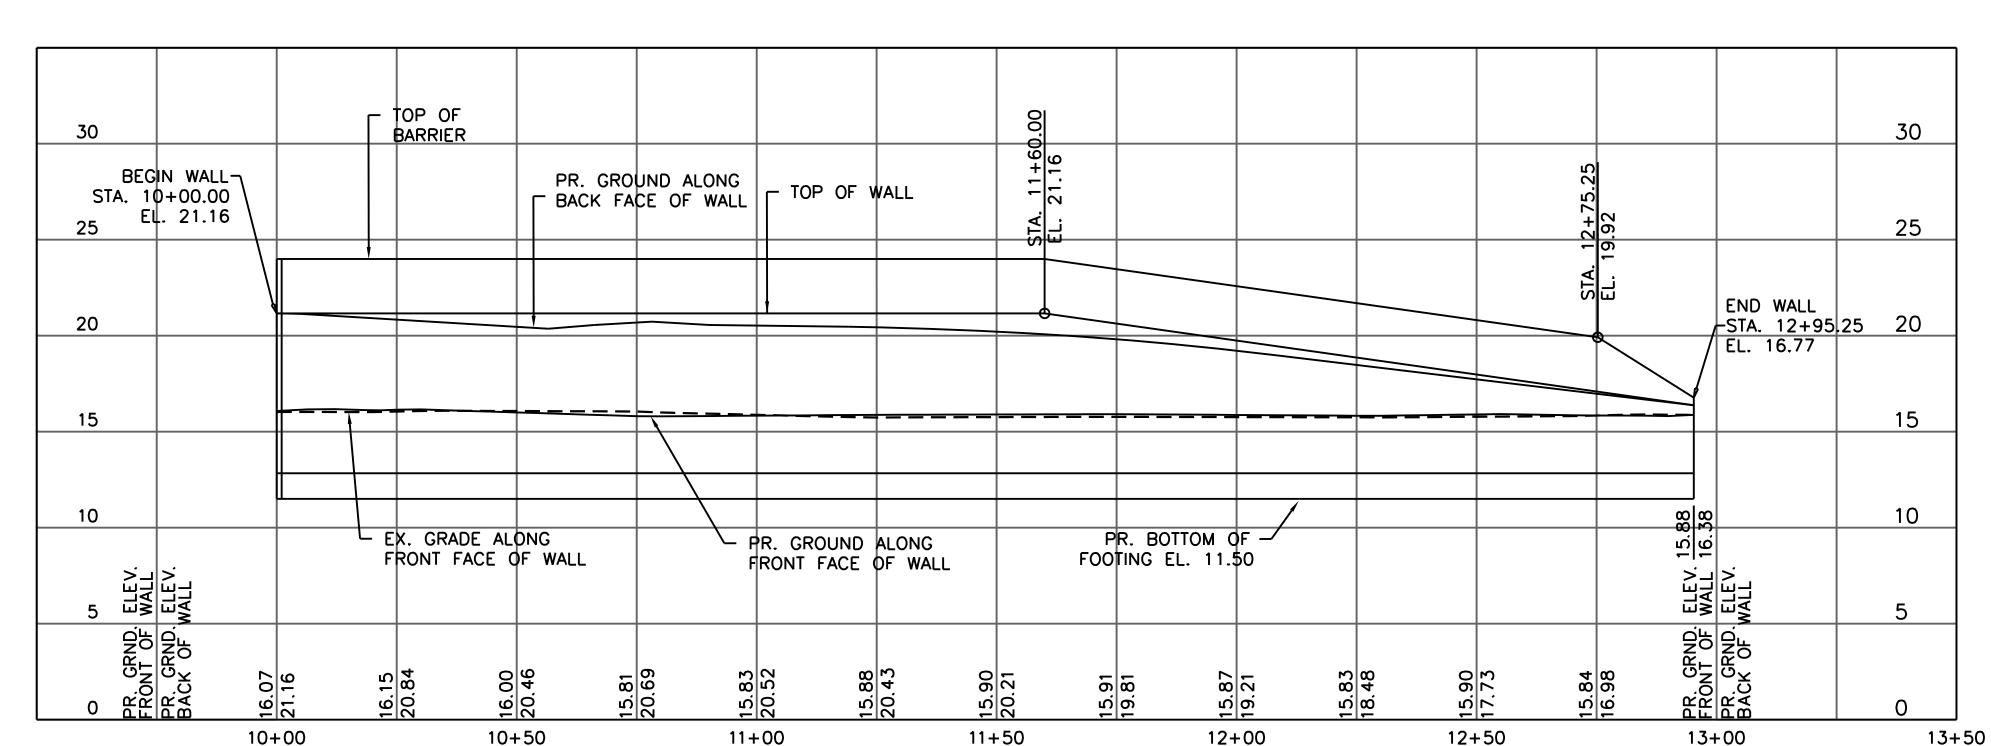

EAST RETAINING WALL PROFILE - SOUTH TERMINAL


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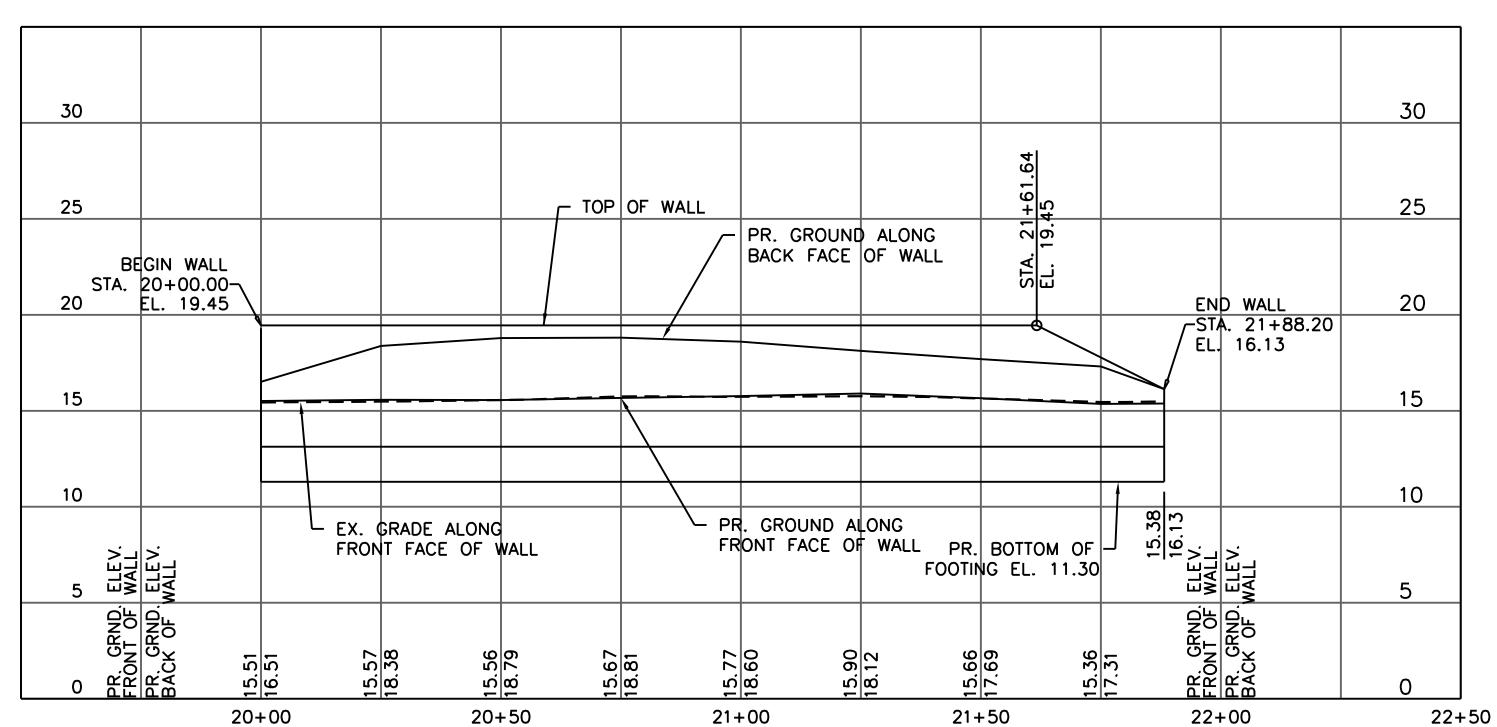
S-1400

0 10' 20' 40' SCALE: 1"=20'-0"

<u>VERTICAL</u>

<u>HORIZONTAL</u>



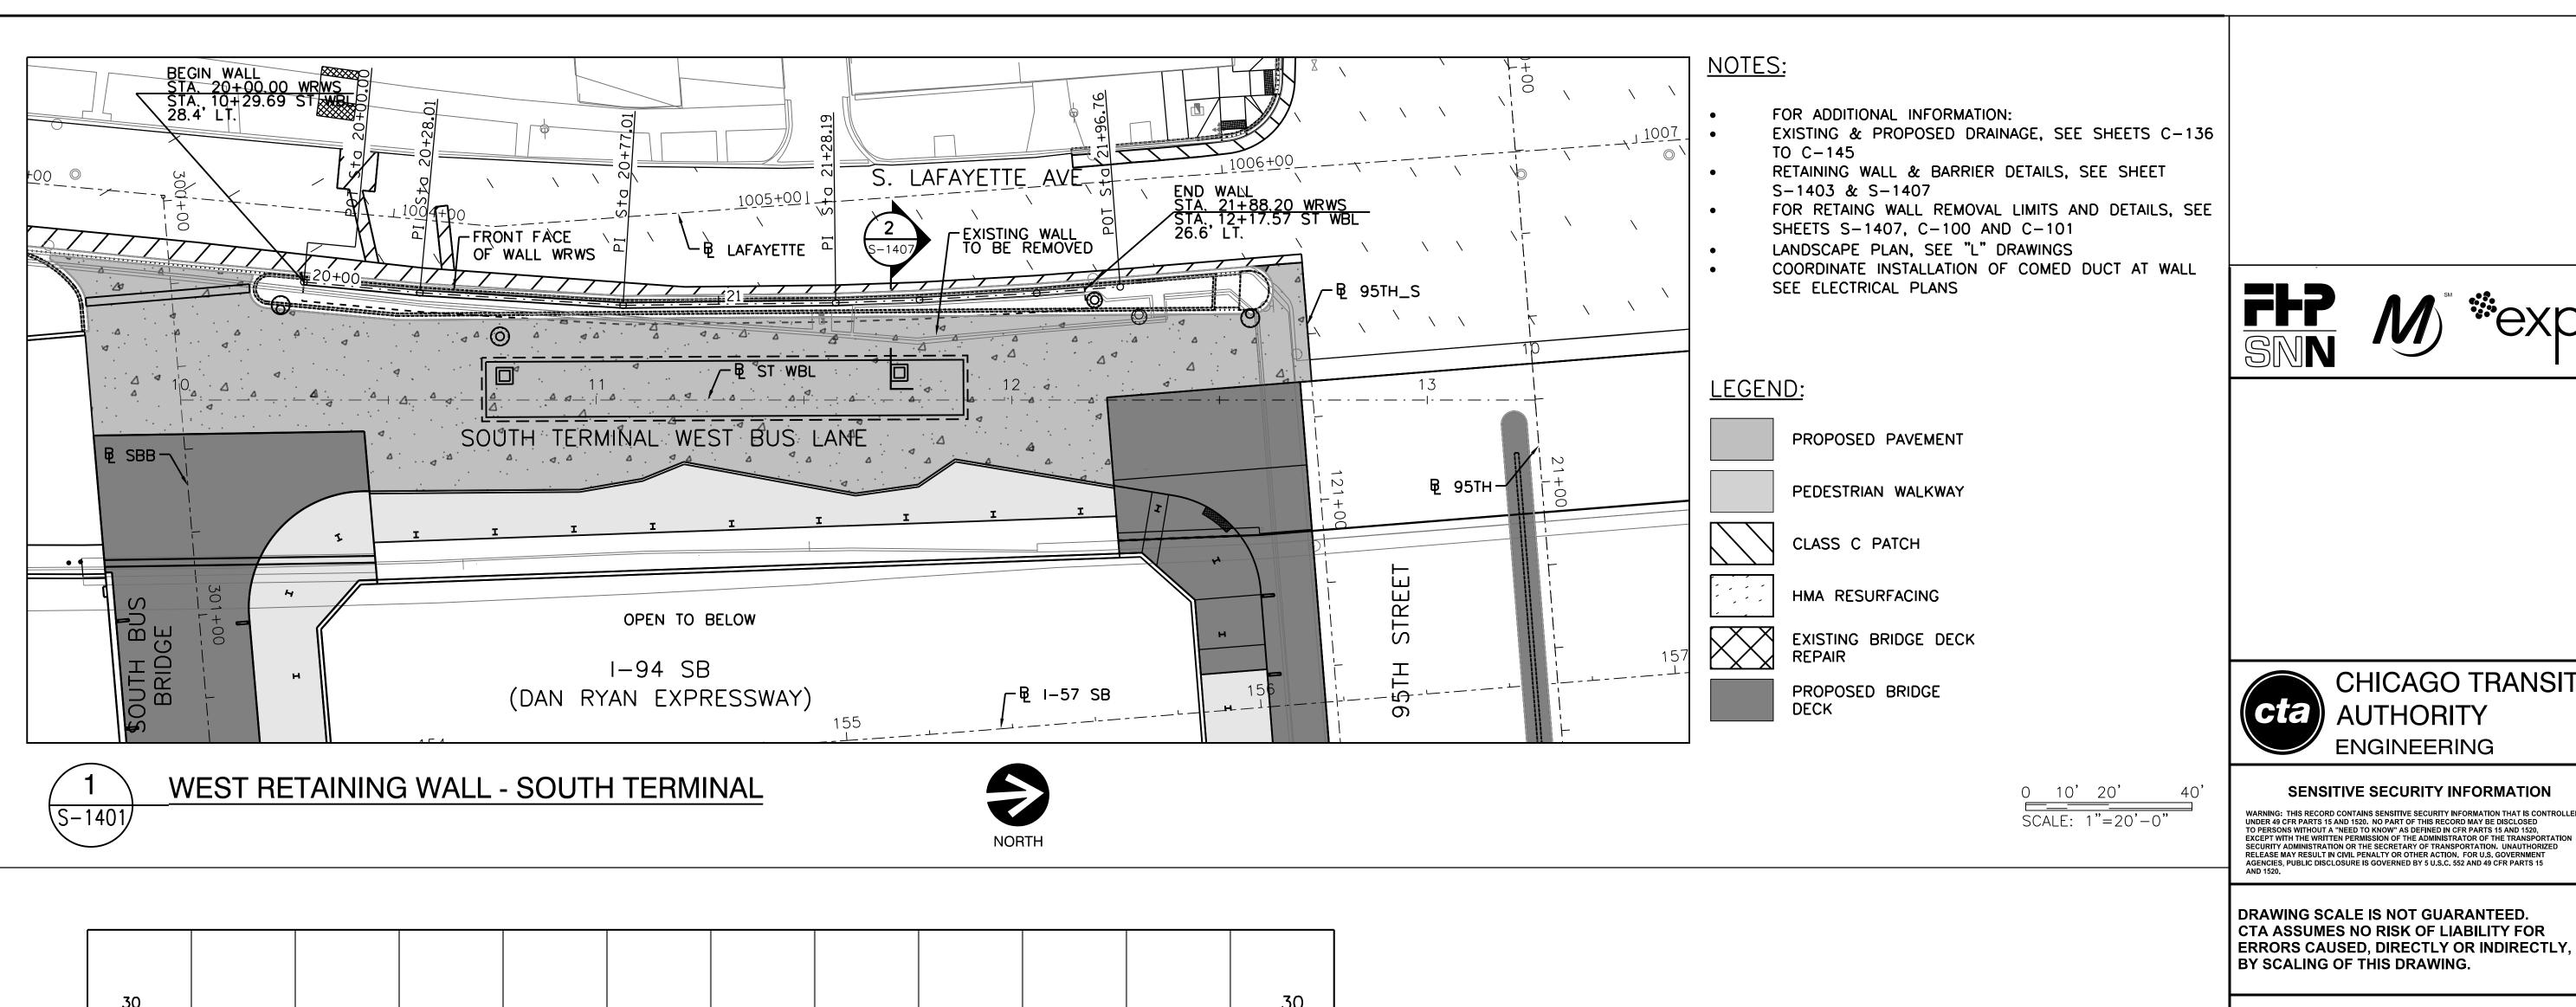

<u>VERTICAL</u>

<u>HORIZONTAL</u>

0 10' 20' 40' SCALE: 1"=20'-0"

PLAN & PROFILE SOUTH TERMINAL WEST RETAINING WALL

LOCATION IDENTIFIER:

DATE

S-1401

2/9/17 ISSUED FOR CONSTRUCTION

**DR095** 

DESCRIPTION

CHICAGO TRANSIT

**AUTHORITY** 

**ENGINEERING** 

95th Terminal Improvement

15 West 95th Street (South Terminal) Chicago, IL 60628

D.ZROKA

L.SOMMER

T.SLEDGE

2012-0021

File Name

P.MAID

S. KADERBEK

IN CHARGE

APPROVED BY

CHECKED BY

DESIGNED BY

DRAWN BY PROJECT NO.


FILE NAME

MARK

S-1401

070\_DR095\_S-1401.dgn 12/14/2016

WEST RETAINING WALL PROFILE - SOUTH TERMINAL

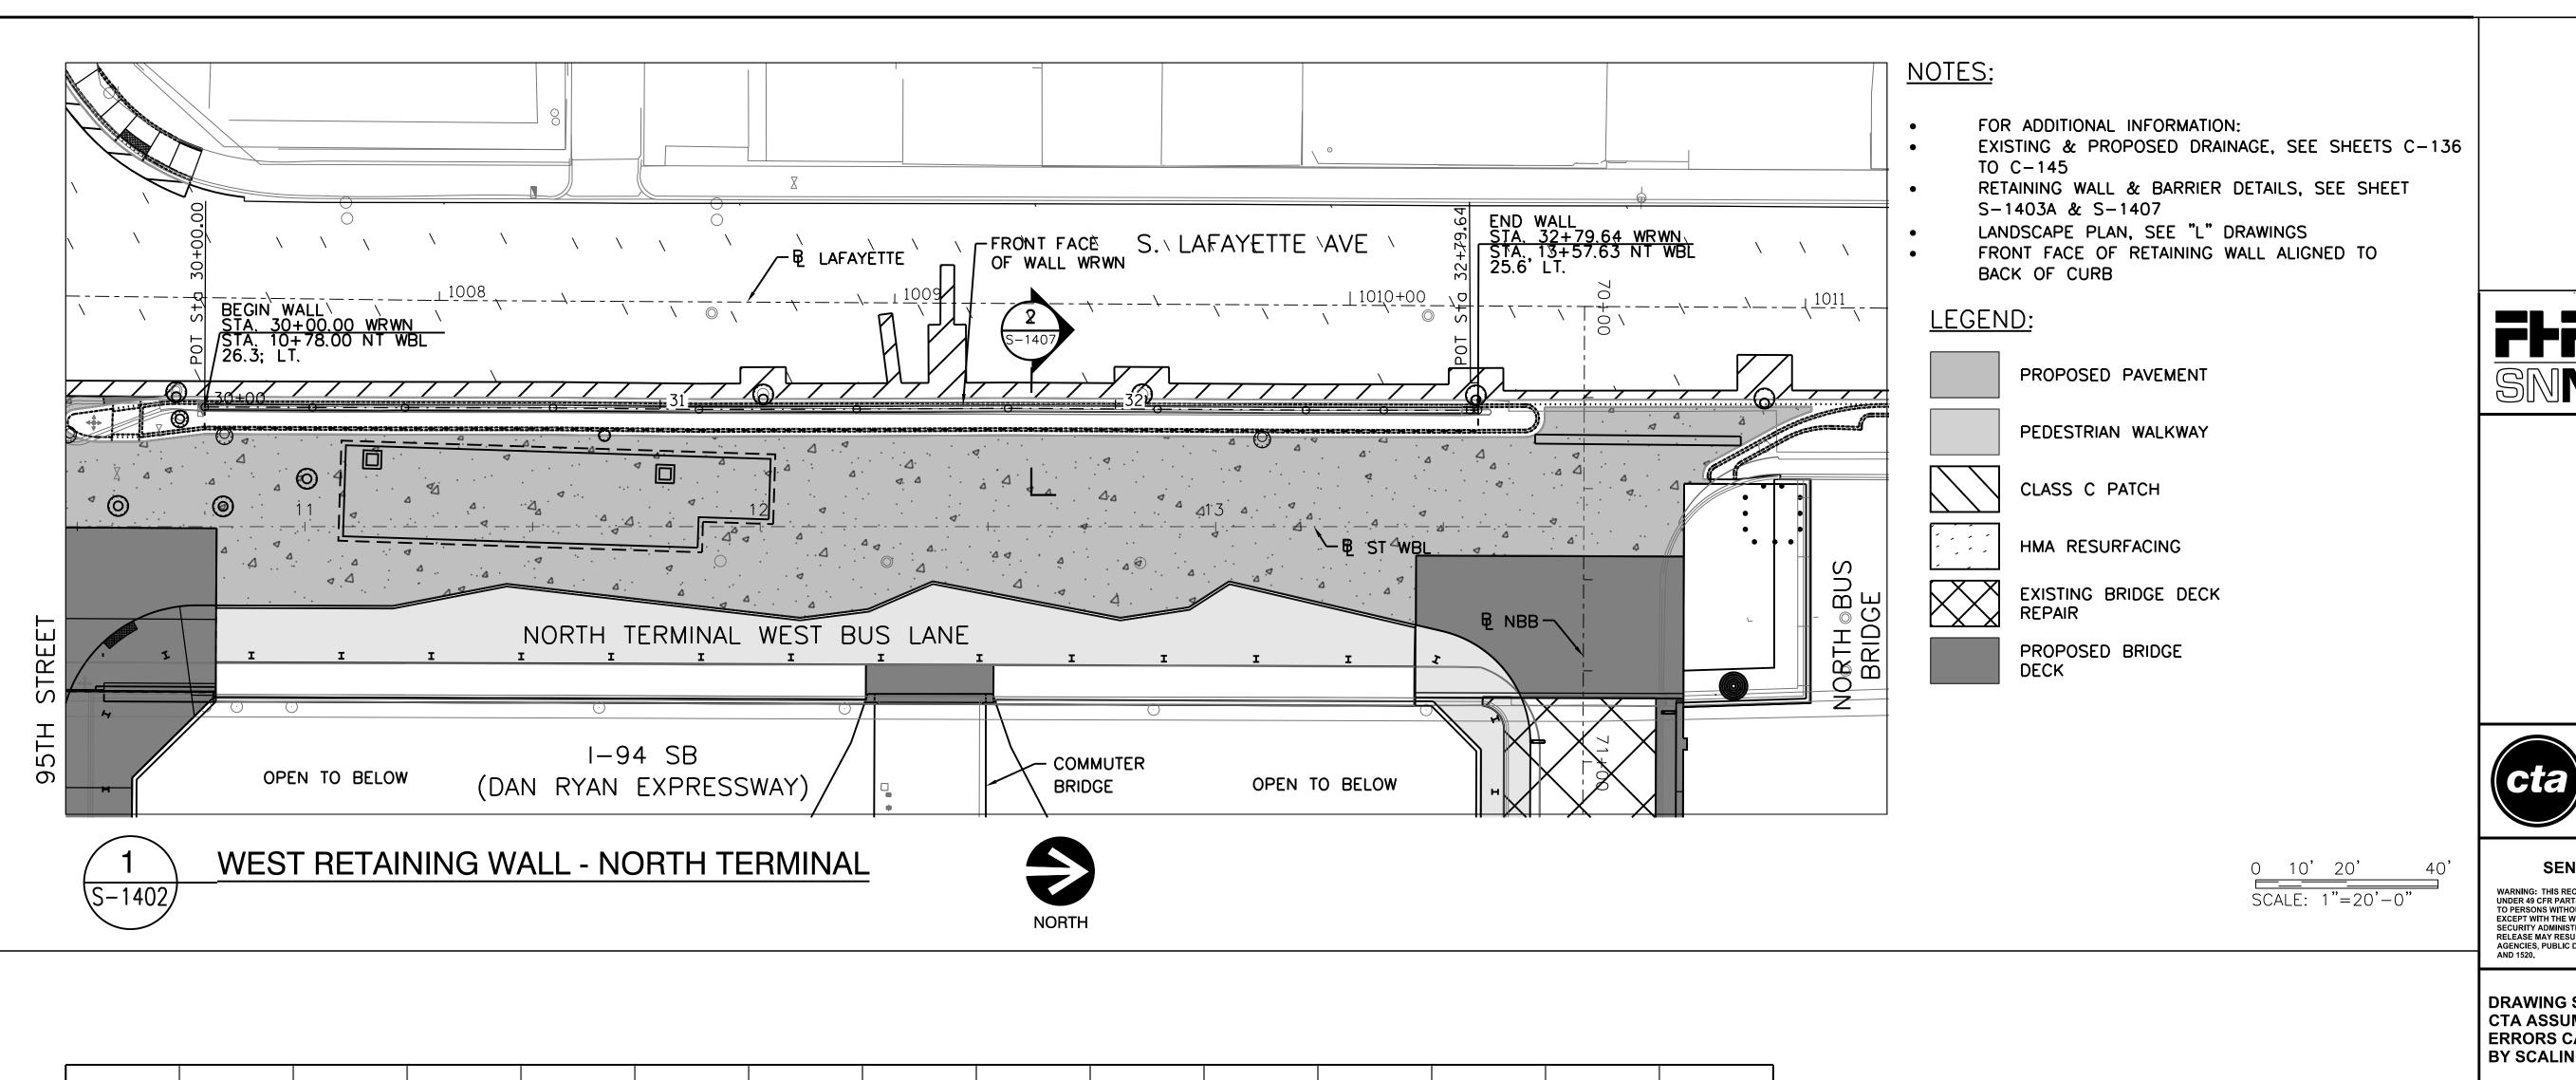

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95th Terminal Improvement 15 West 95th Street (South Terminal) Chicago, IL 60628

IN CHARGE S. KADERBEK APPROVED BY D.ZROKA CHECKED BY P.MAID DESIGNED BY L.SOMMER T.SLEDGE DRAWN BY 2012-0021 PROJECT NO. FILE NAME File Name 2/9/17 ISSUED FOR CONSTRUCTION MARK DATE DESCRIPTION **DR095** 

LOCATION IDENTIFIER:


<u>VERTICAL</u>

<u>HORIZONTAL</u>

0 10' 20' SCALE: 1"=20'-0"

PLAN & PROFILE NORTH TERMINAL WEST RETAINING WALL


S-1402

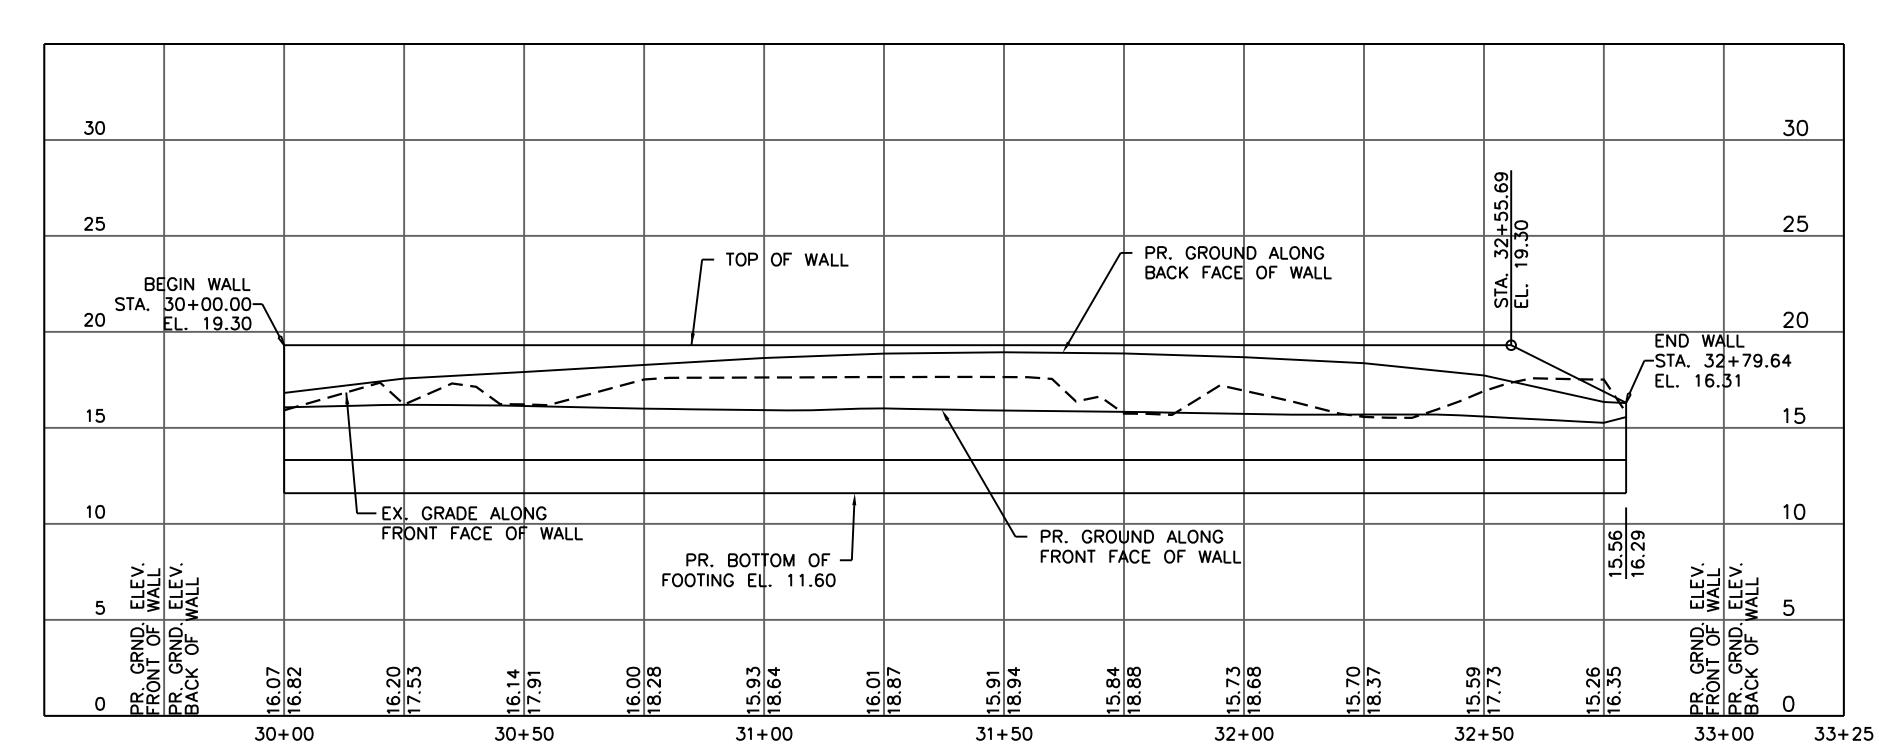


WEST RETAINING WALL PROFILE - NORTH TERMINAL

070\_DR095\_S-1402.DGN 12/14/2016

S-1402/

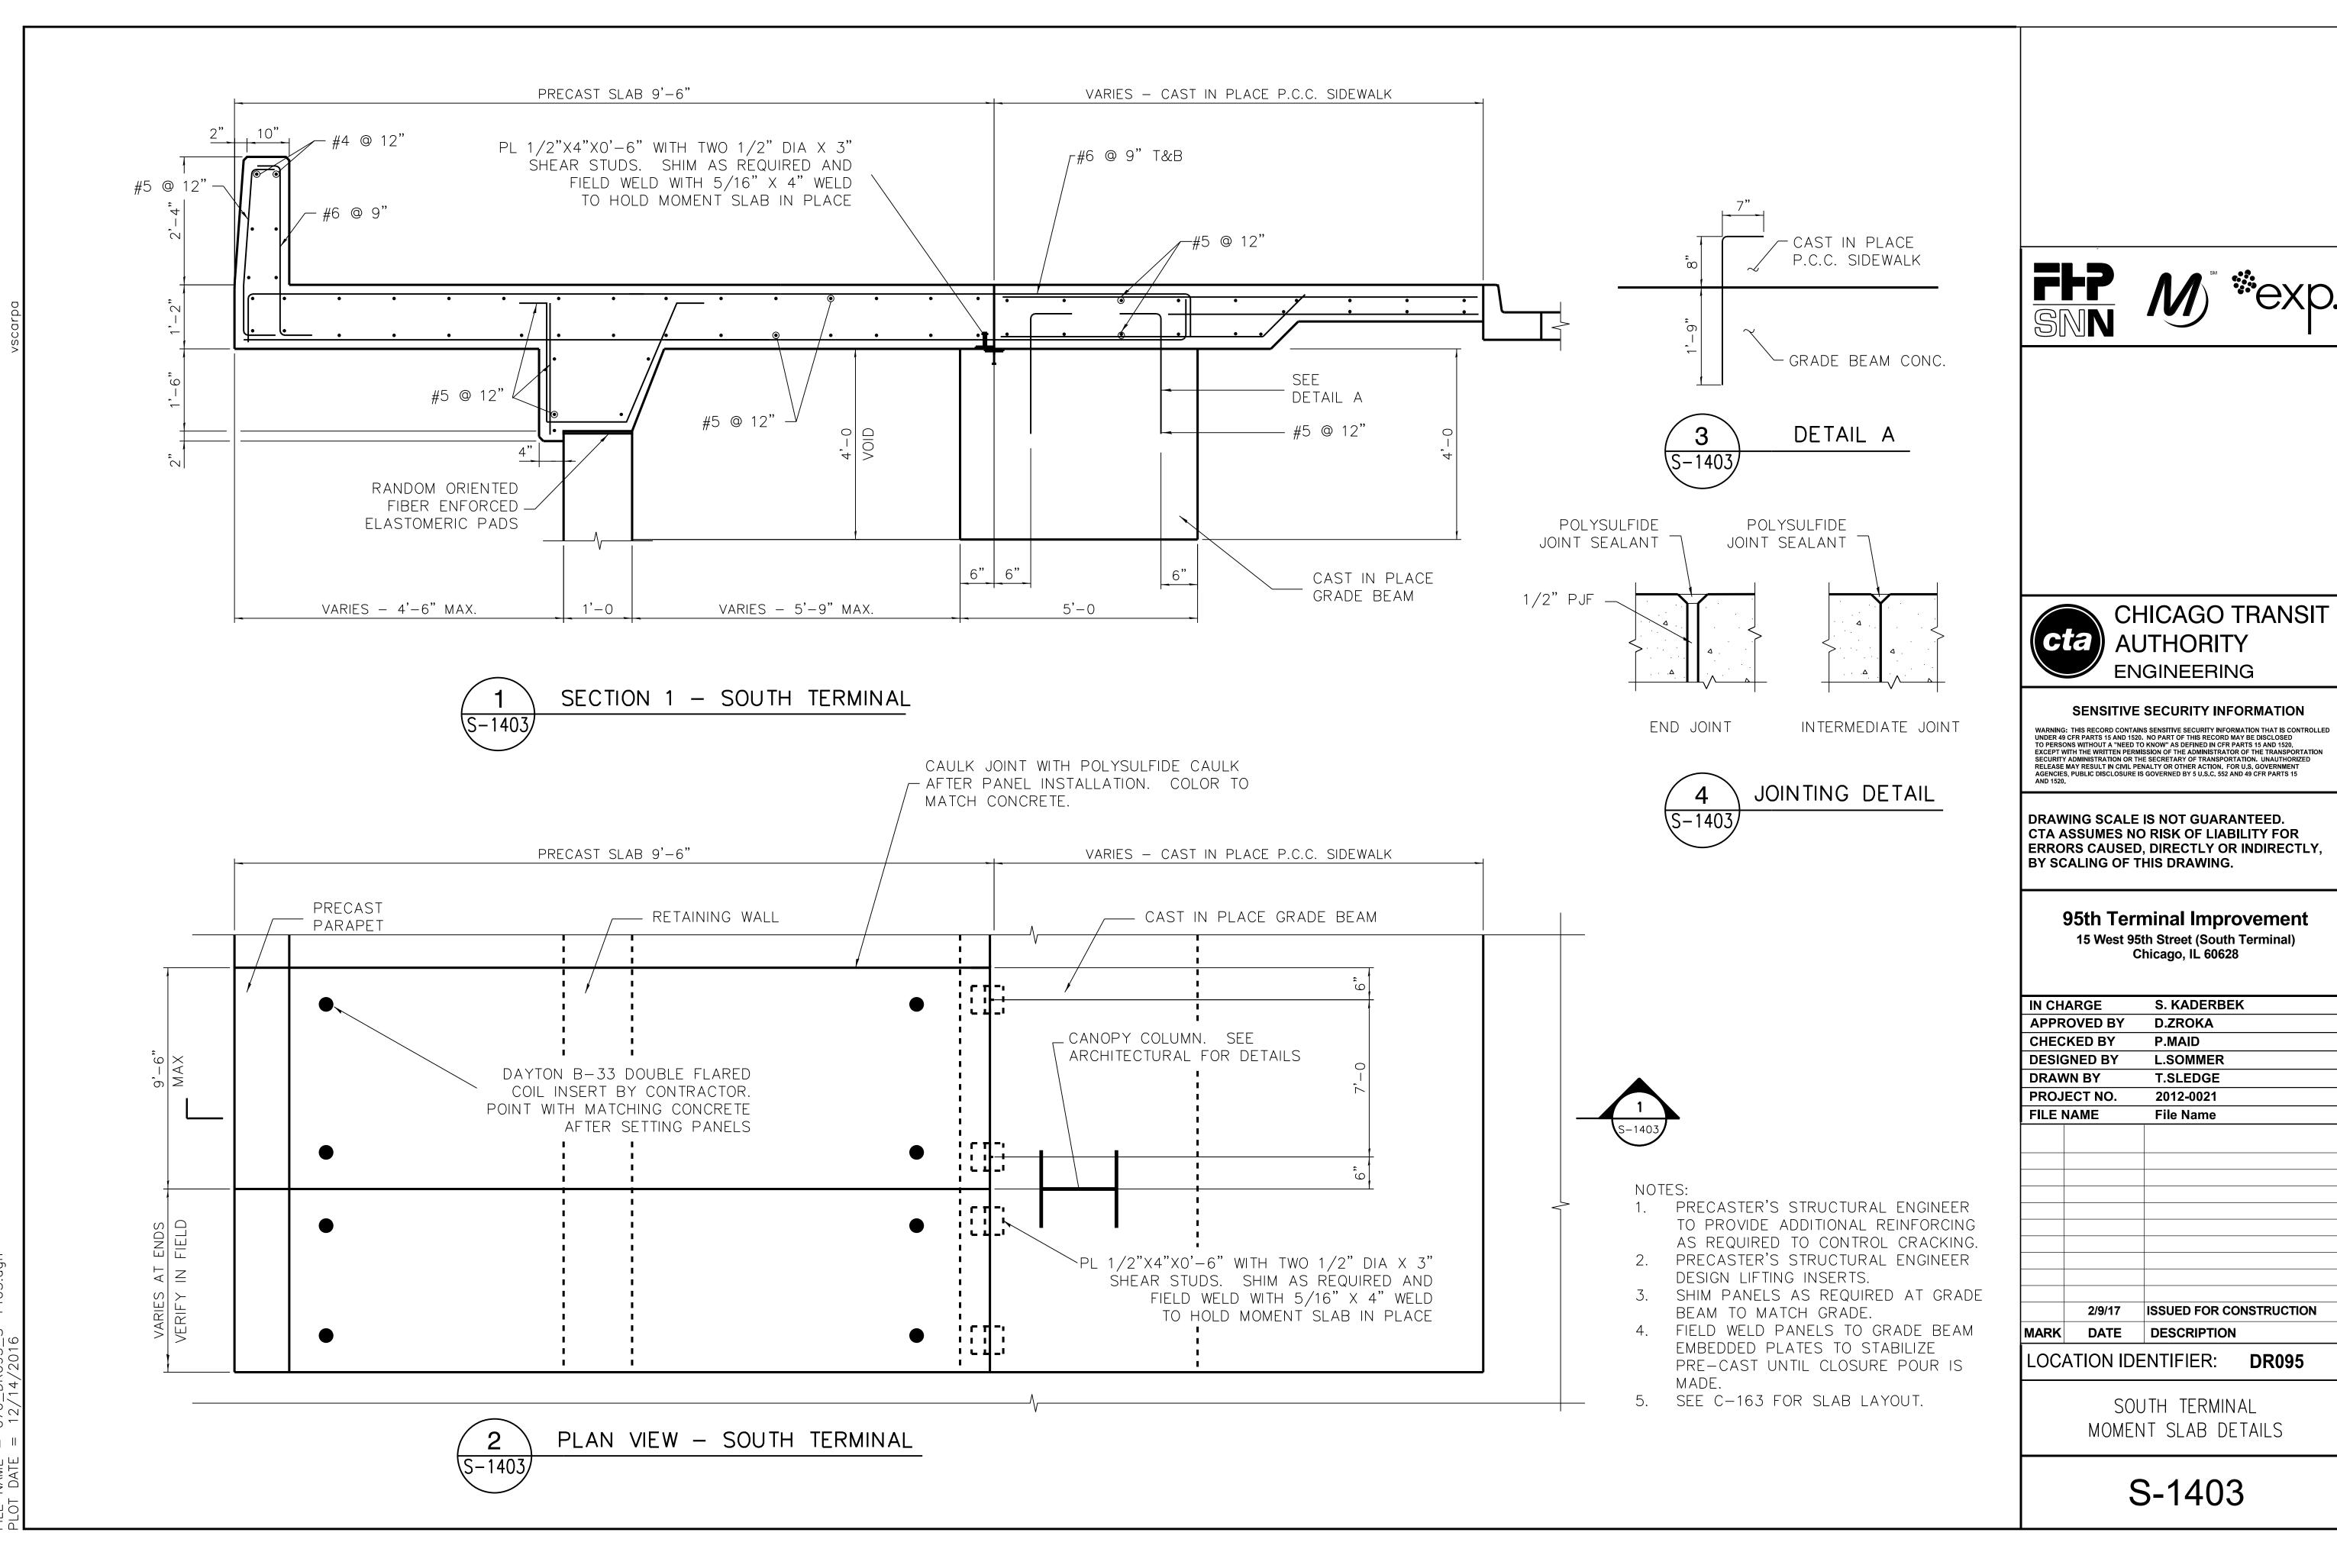

AMF = 070 DR095 S-1403 dan

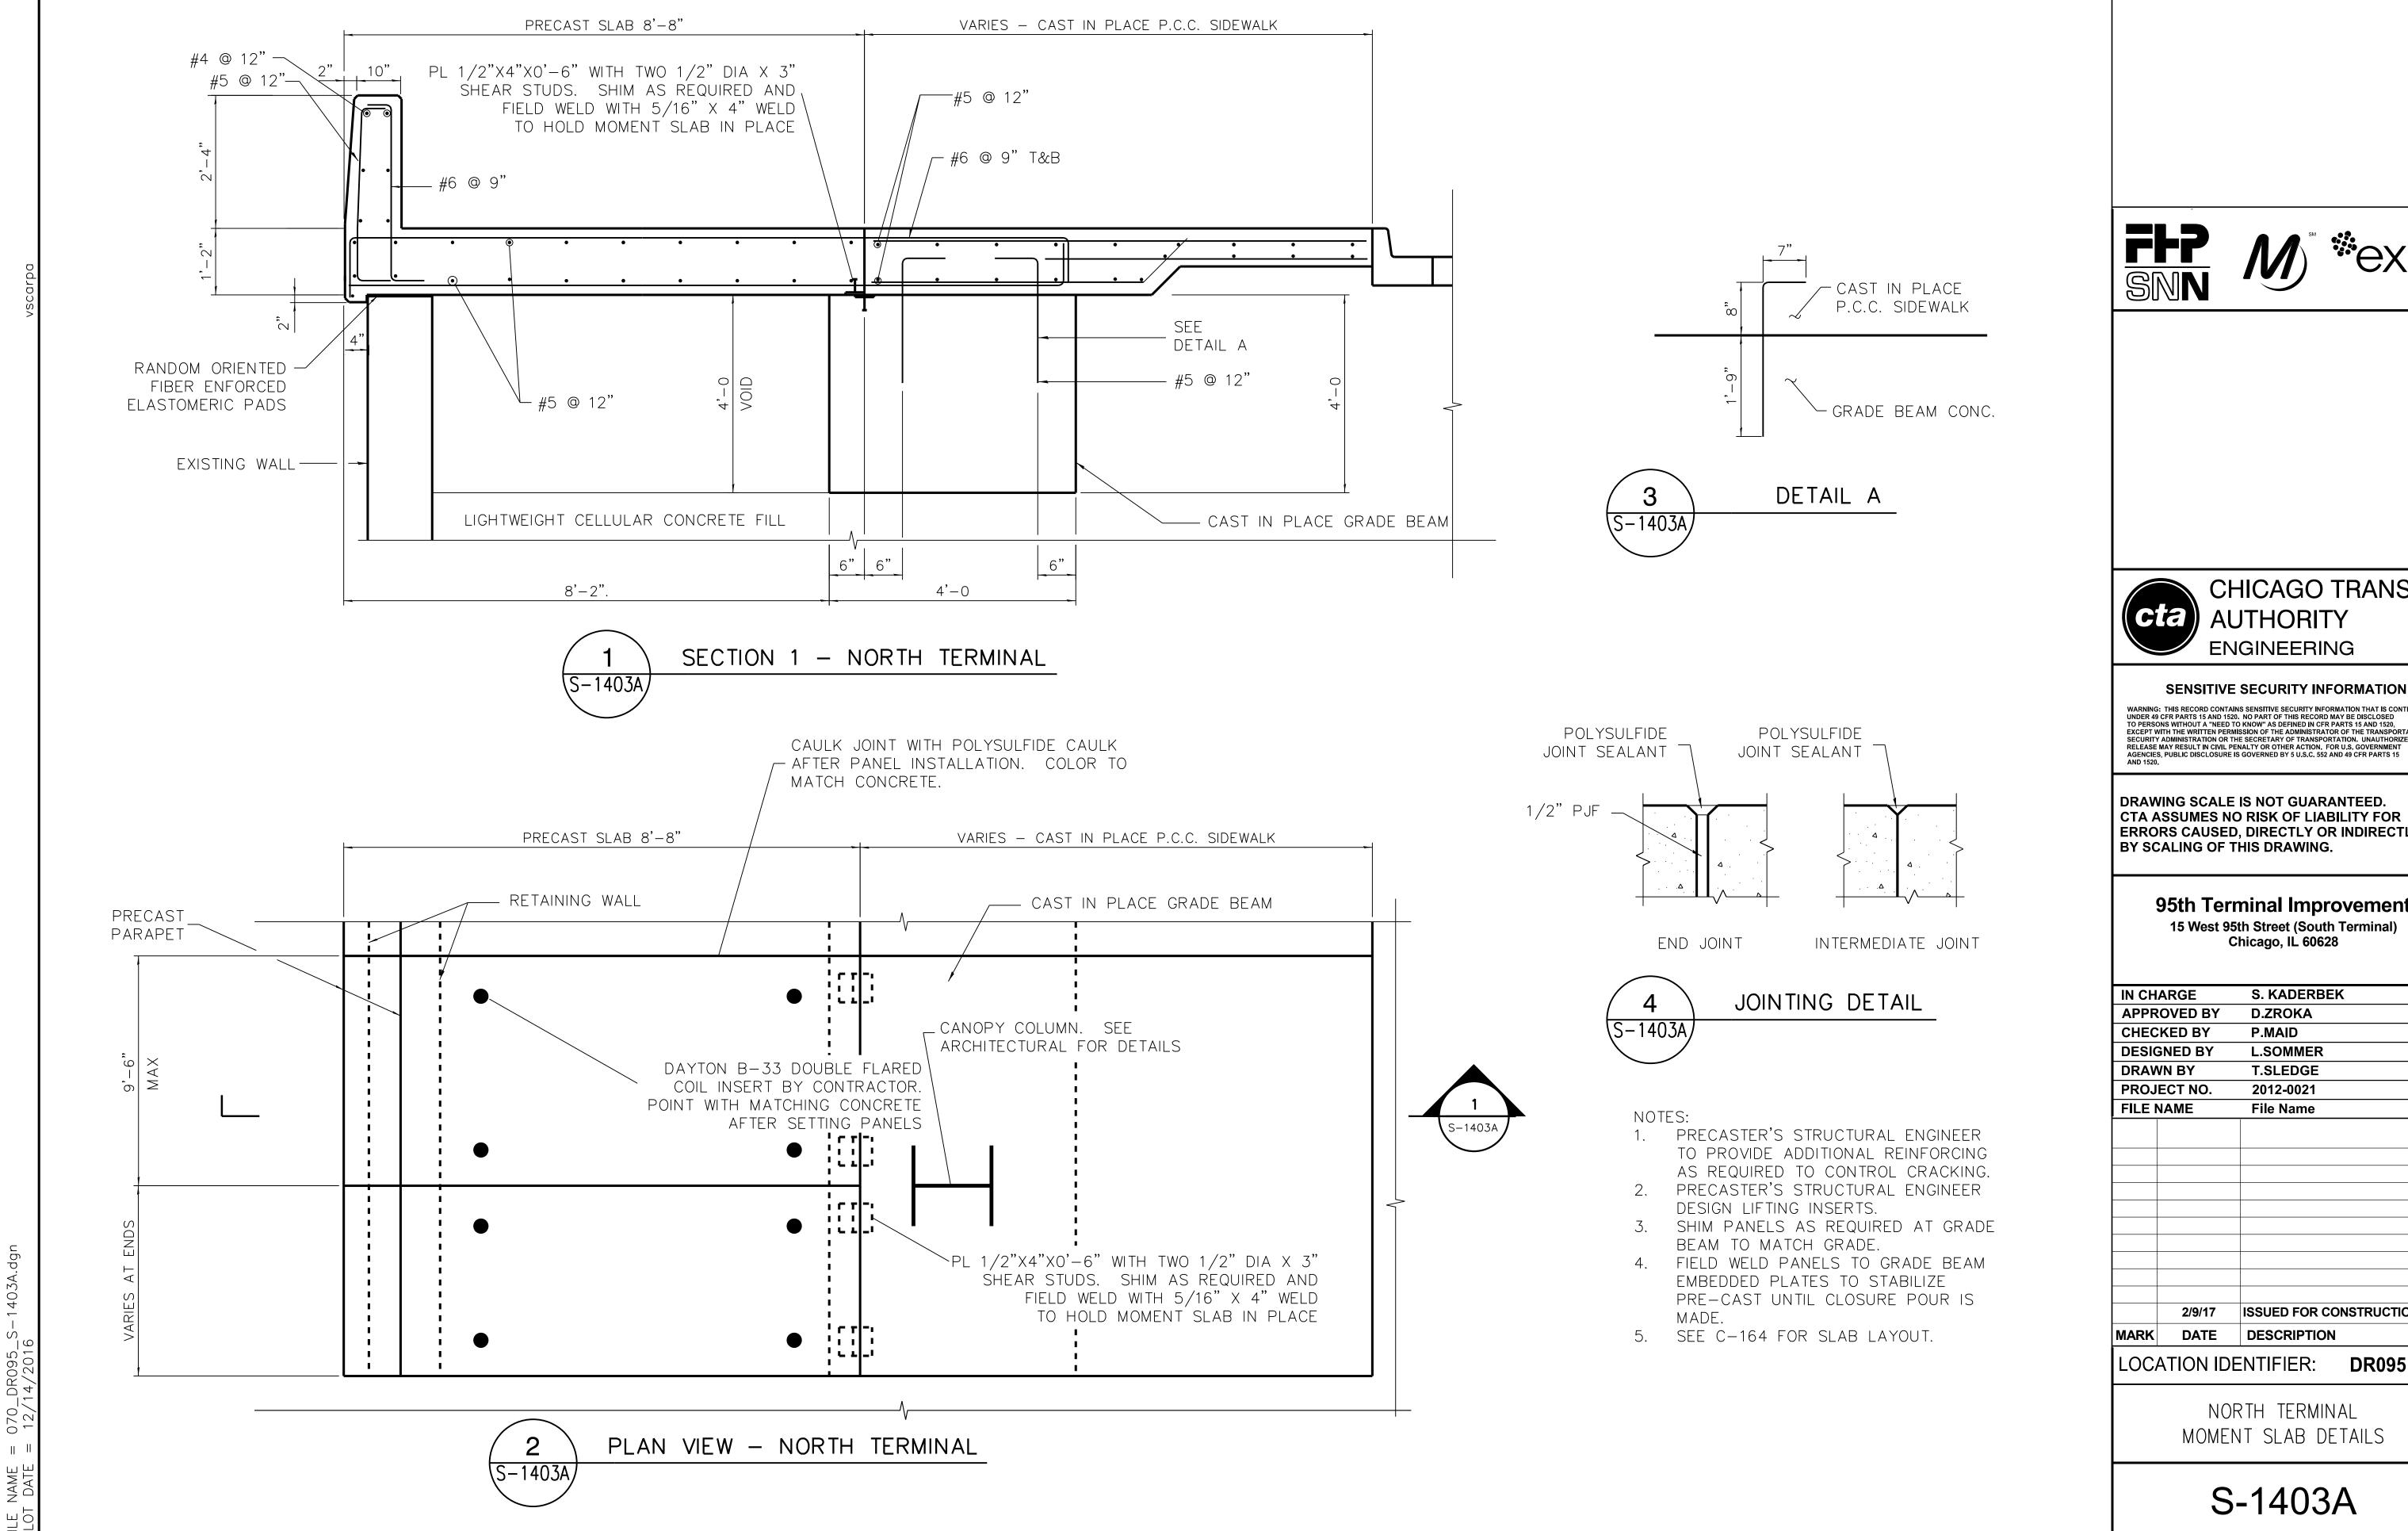



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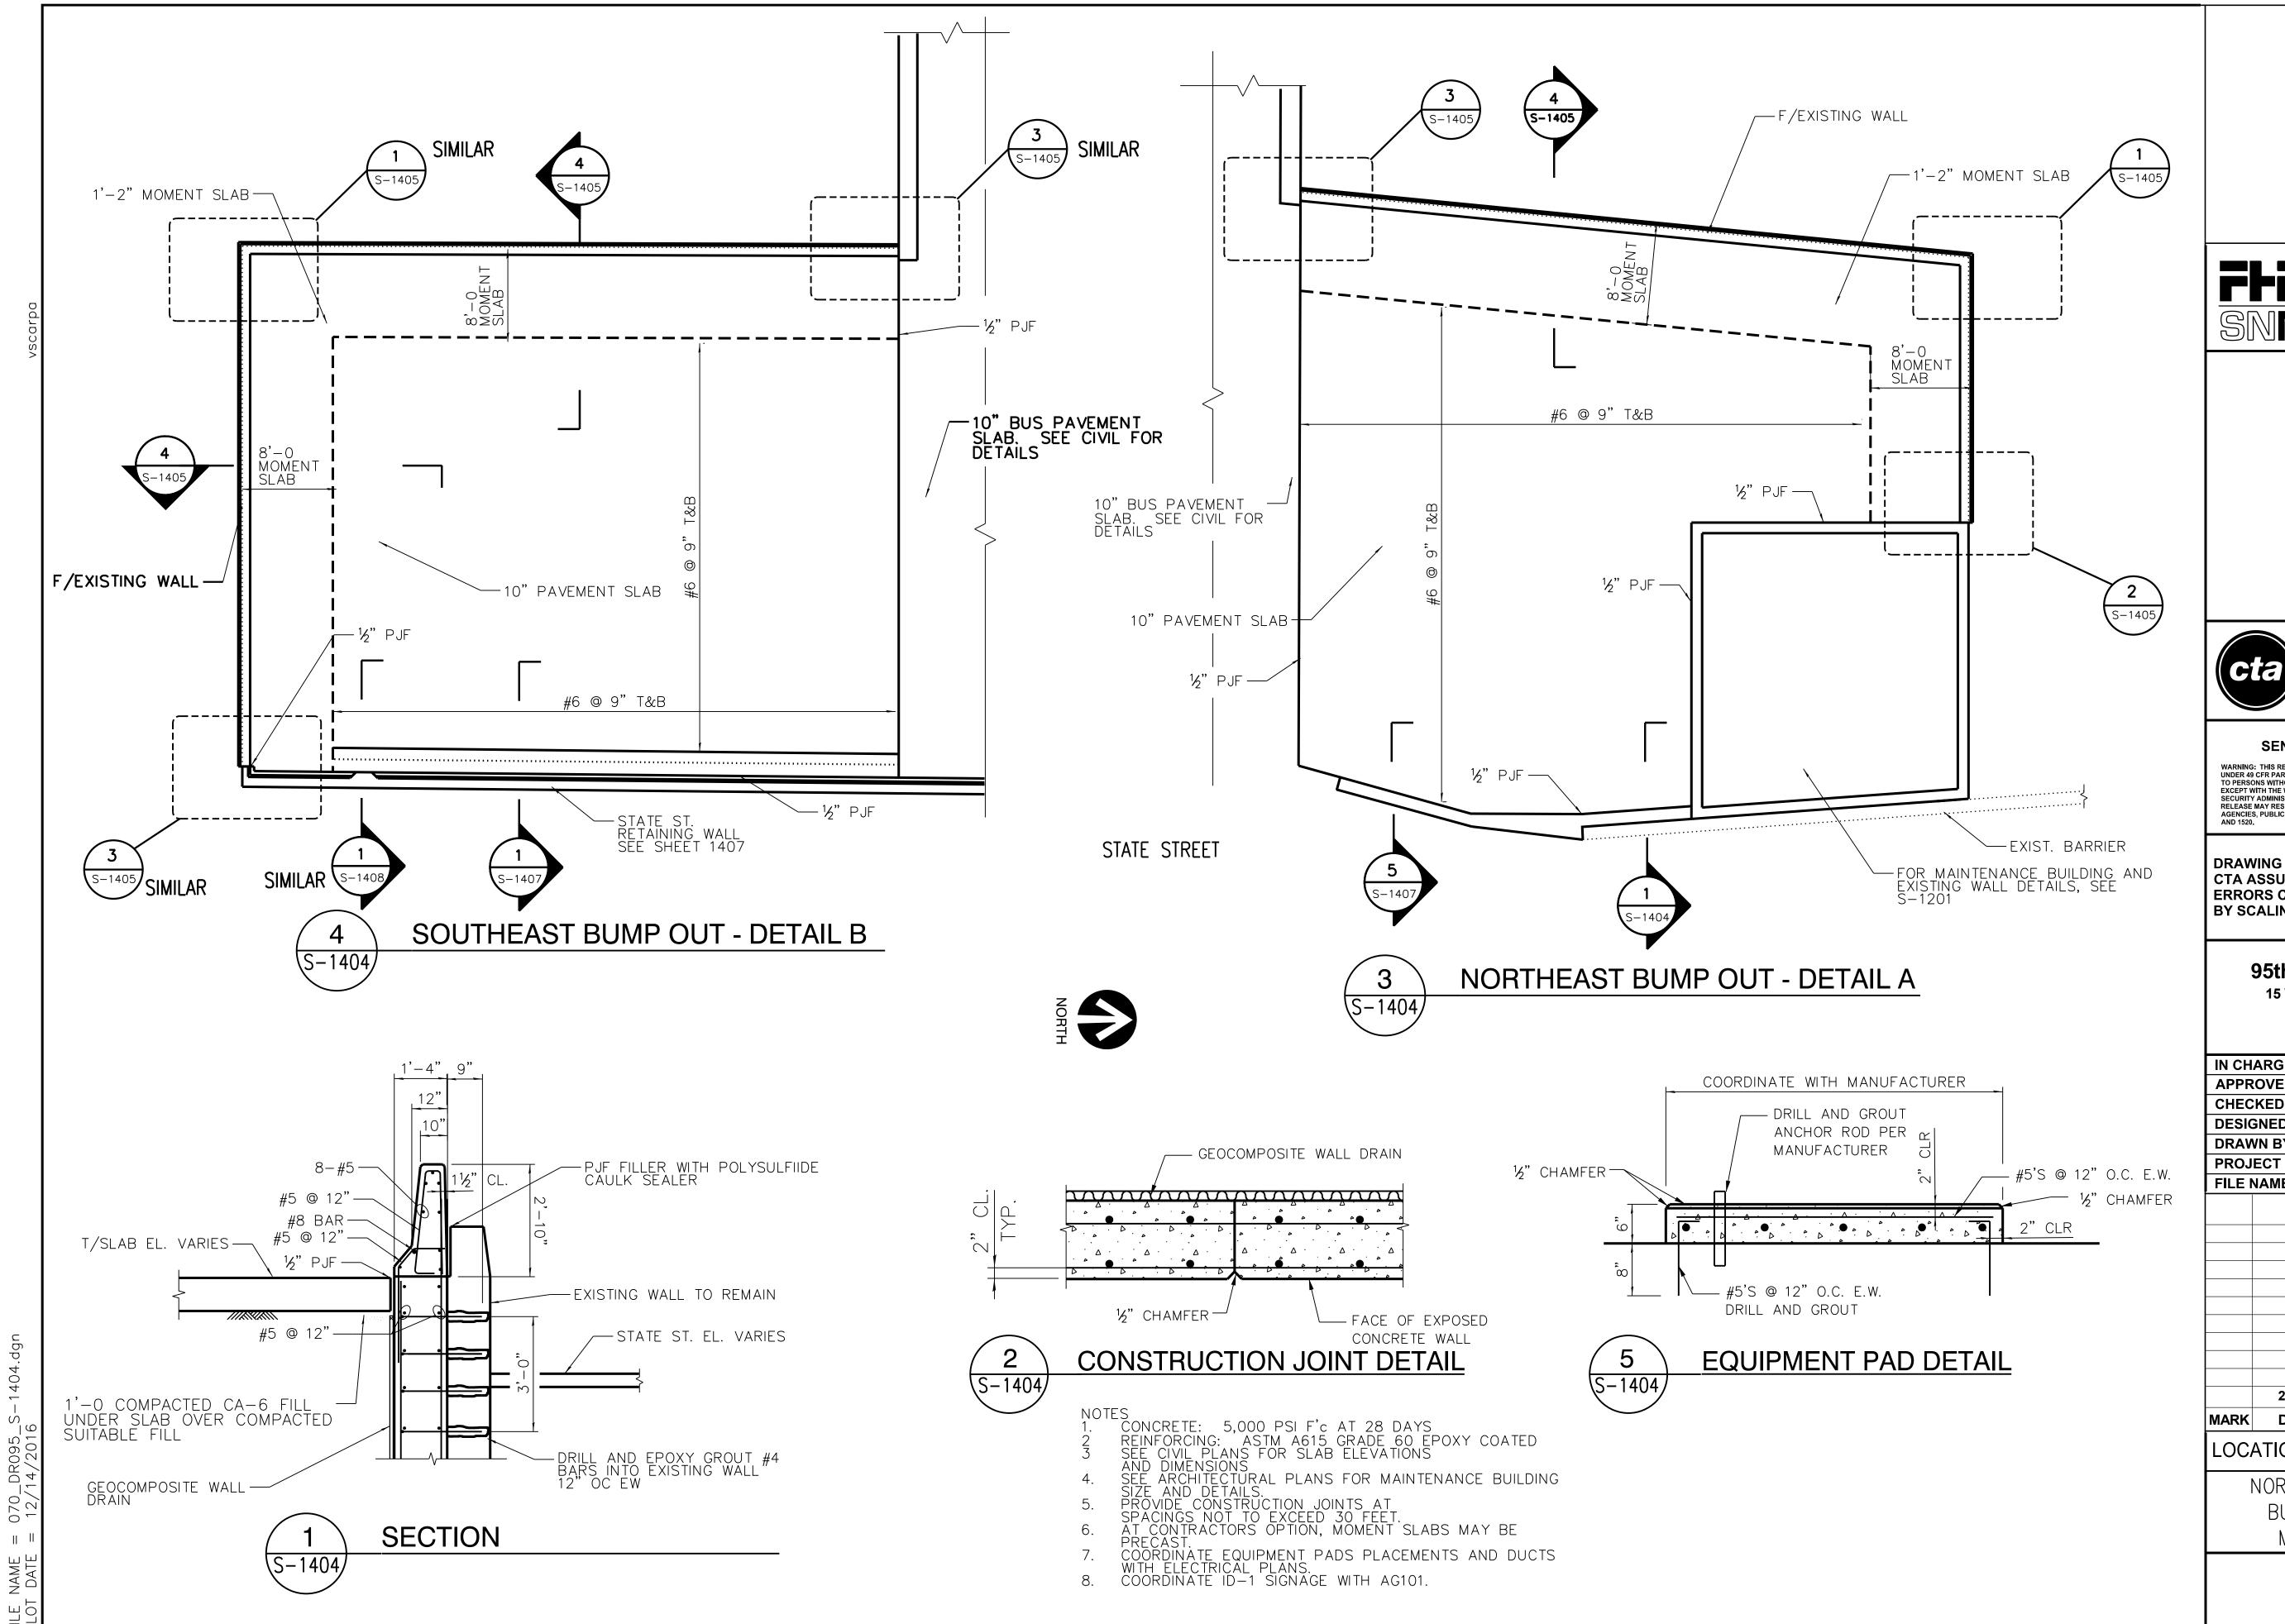
DRAWING SCALE IS NOT GUARANTEED. CTA ASSUMES NO RISK OF LIABILITY FOR ERRORS CAUSED, DIRECTLY OR INDIRECTLY,

## 95th Terminal Improvement

IN CH	ARGE	S. KADERBEK
APPROVED BY		D.ZROKA
CHEC	KED BY	P.MAID
DESIGNED BY DRAWN BY PROJECT NO. FILE NAME		L.SOMMER
		T.SLEDGE
		2012-0021
FILE	NAME	File Name
		T. Company of the Com
	2/9/17	ISSUED FOR CONSTRUCTION

| LOCATION IDENTIFIER: DR095

MOMENT SLAB DETAILS



FFP SIN \*\*exp



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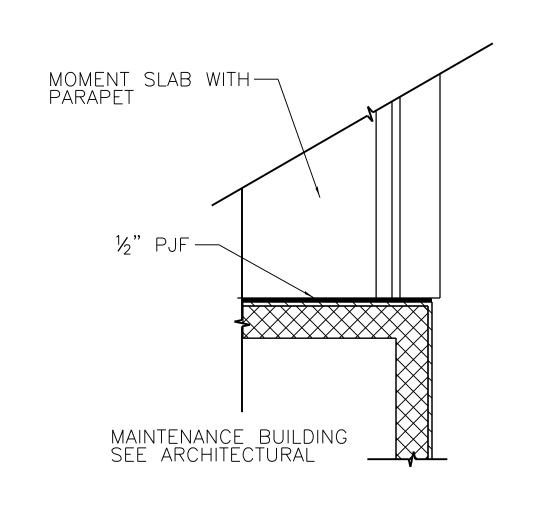
DRAWING SCALE IS NOT GUARANTEED.
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BY SCALING OF THIS DRAWING.


## 95th Terminal Improvement


15 West 95th Street (South Terminal) Chicago, IL 60628

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APPR	OVED BY	D.ZROKA	
CHEC	KED BY	P.MAID	
DESIG	ENED BY	L.SOMMER	
DRAV	N BY	T.SLEDGE	
PROJ	ECT NO.	2012-0021	
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NORTHEAST AND SOUTHEAST BUMP-OUTS, PLANS AND MOMENT SLAB DETAILS





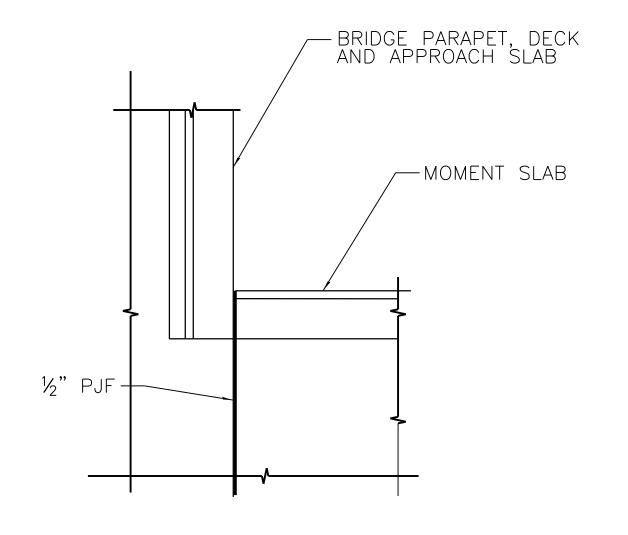


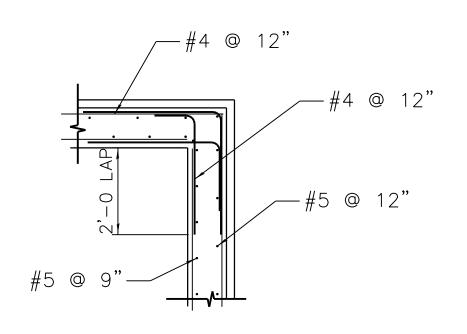S-1405


**DETAIL** 

3 DETAIL 5-1405



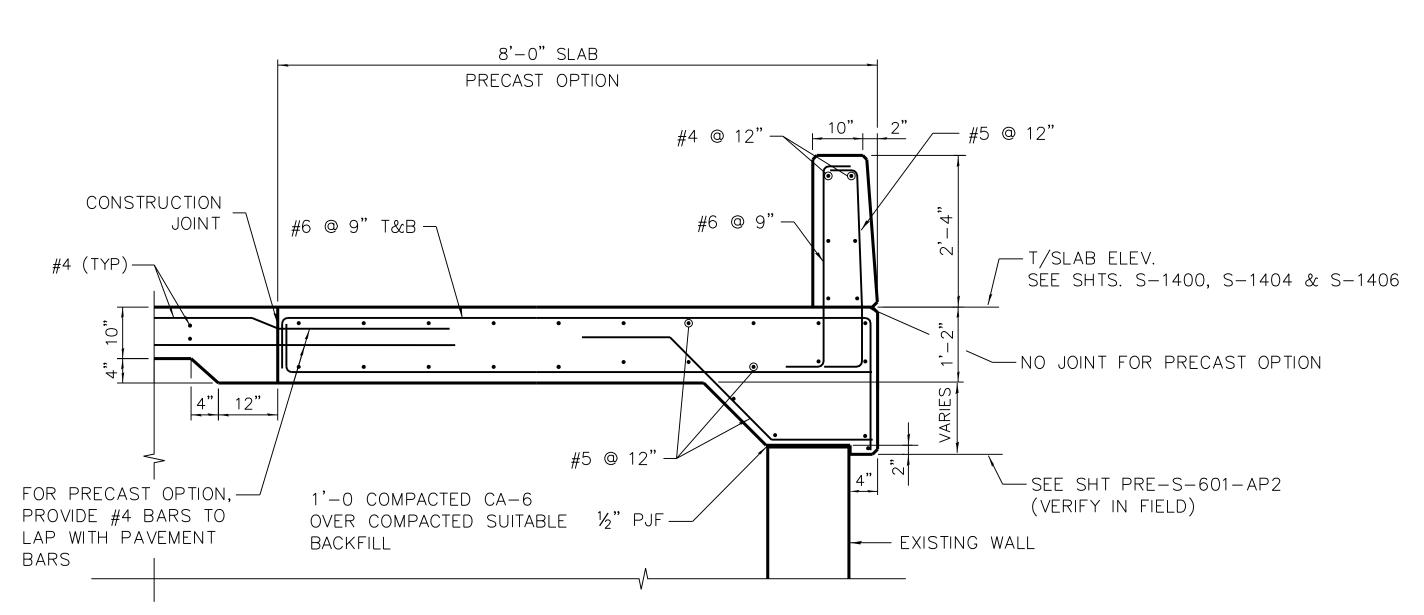



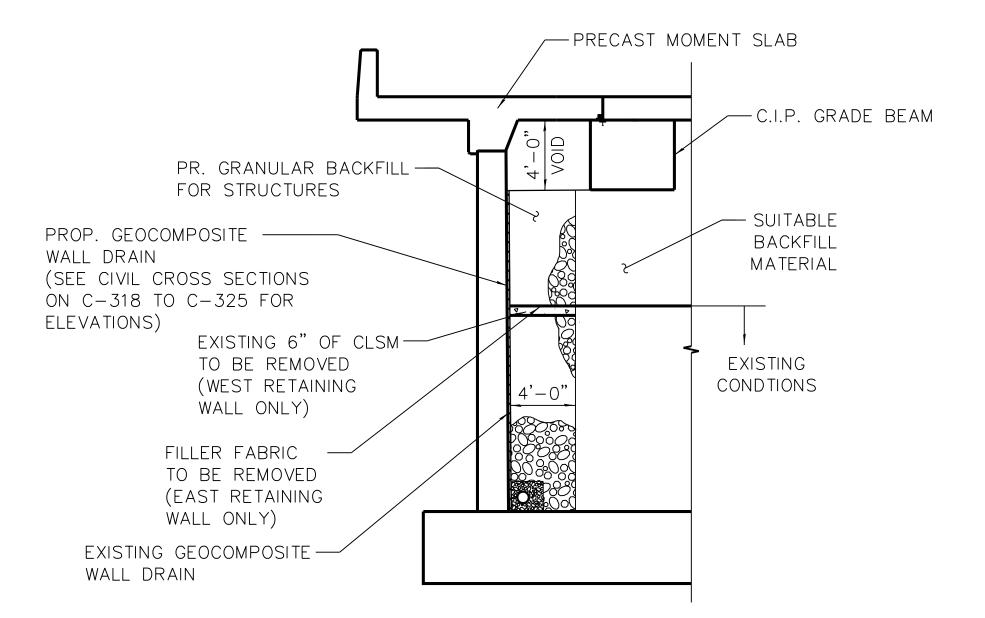

5 S-1405

SOUTH TERMINAL RETAINING WALL BACKFILL





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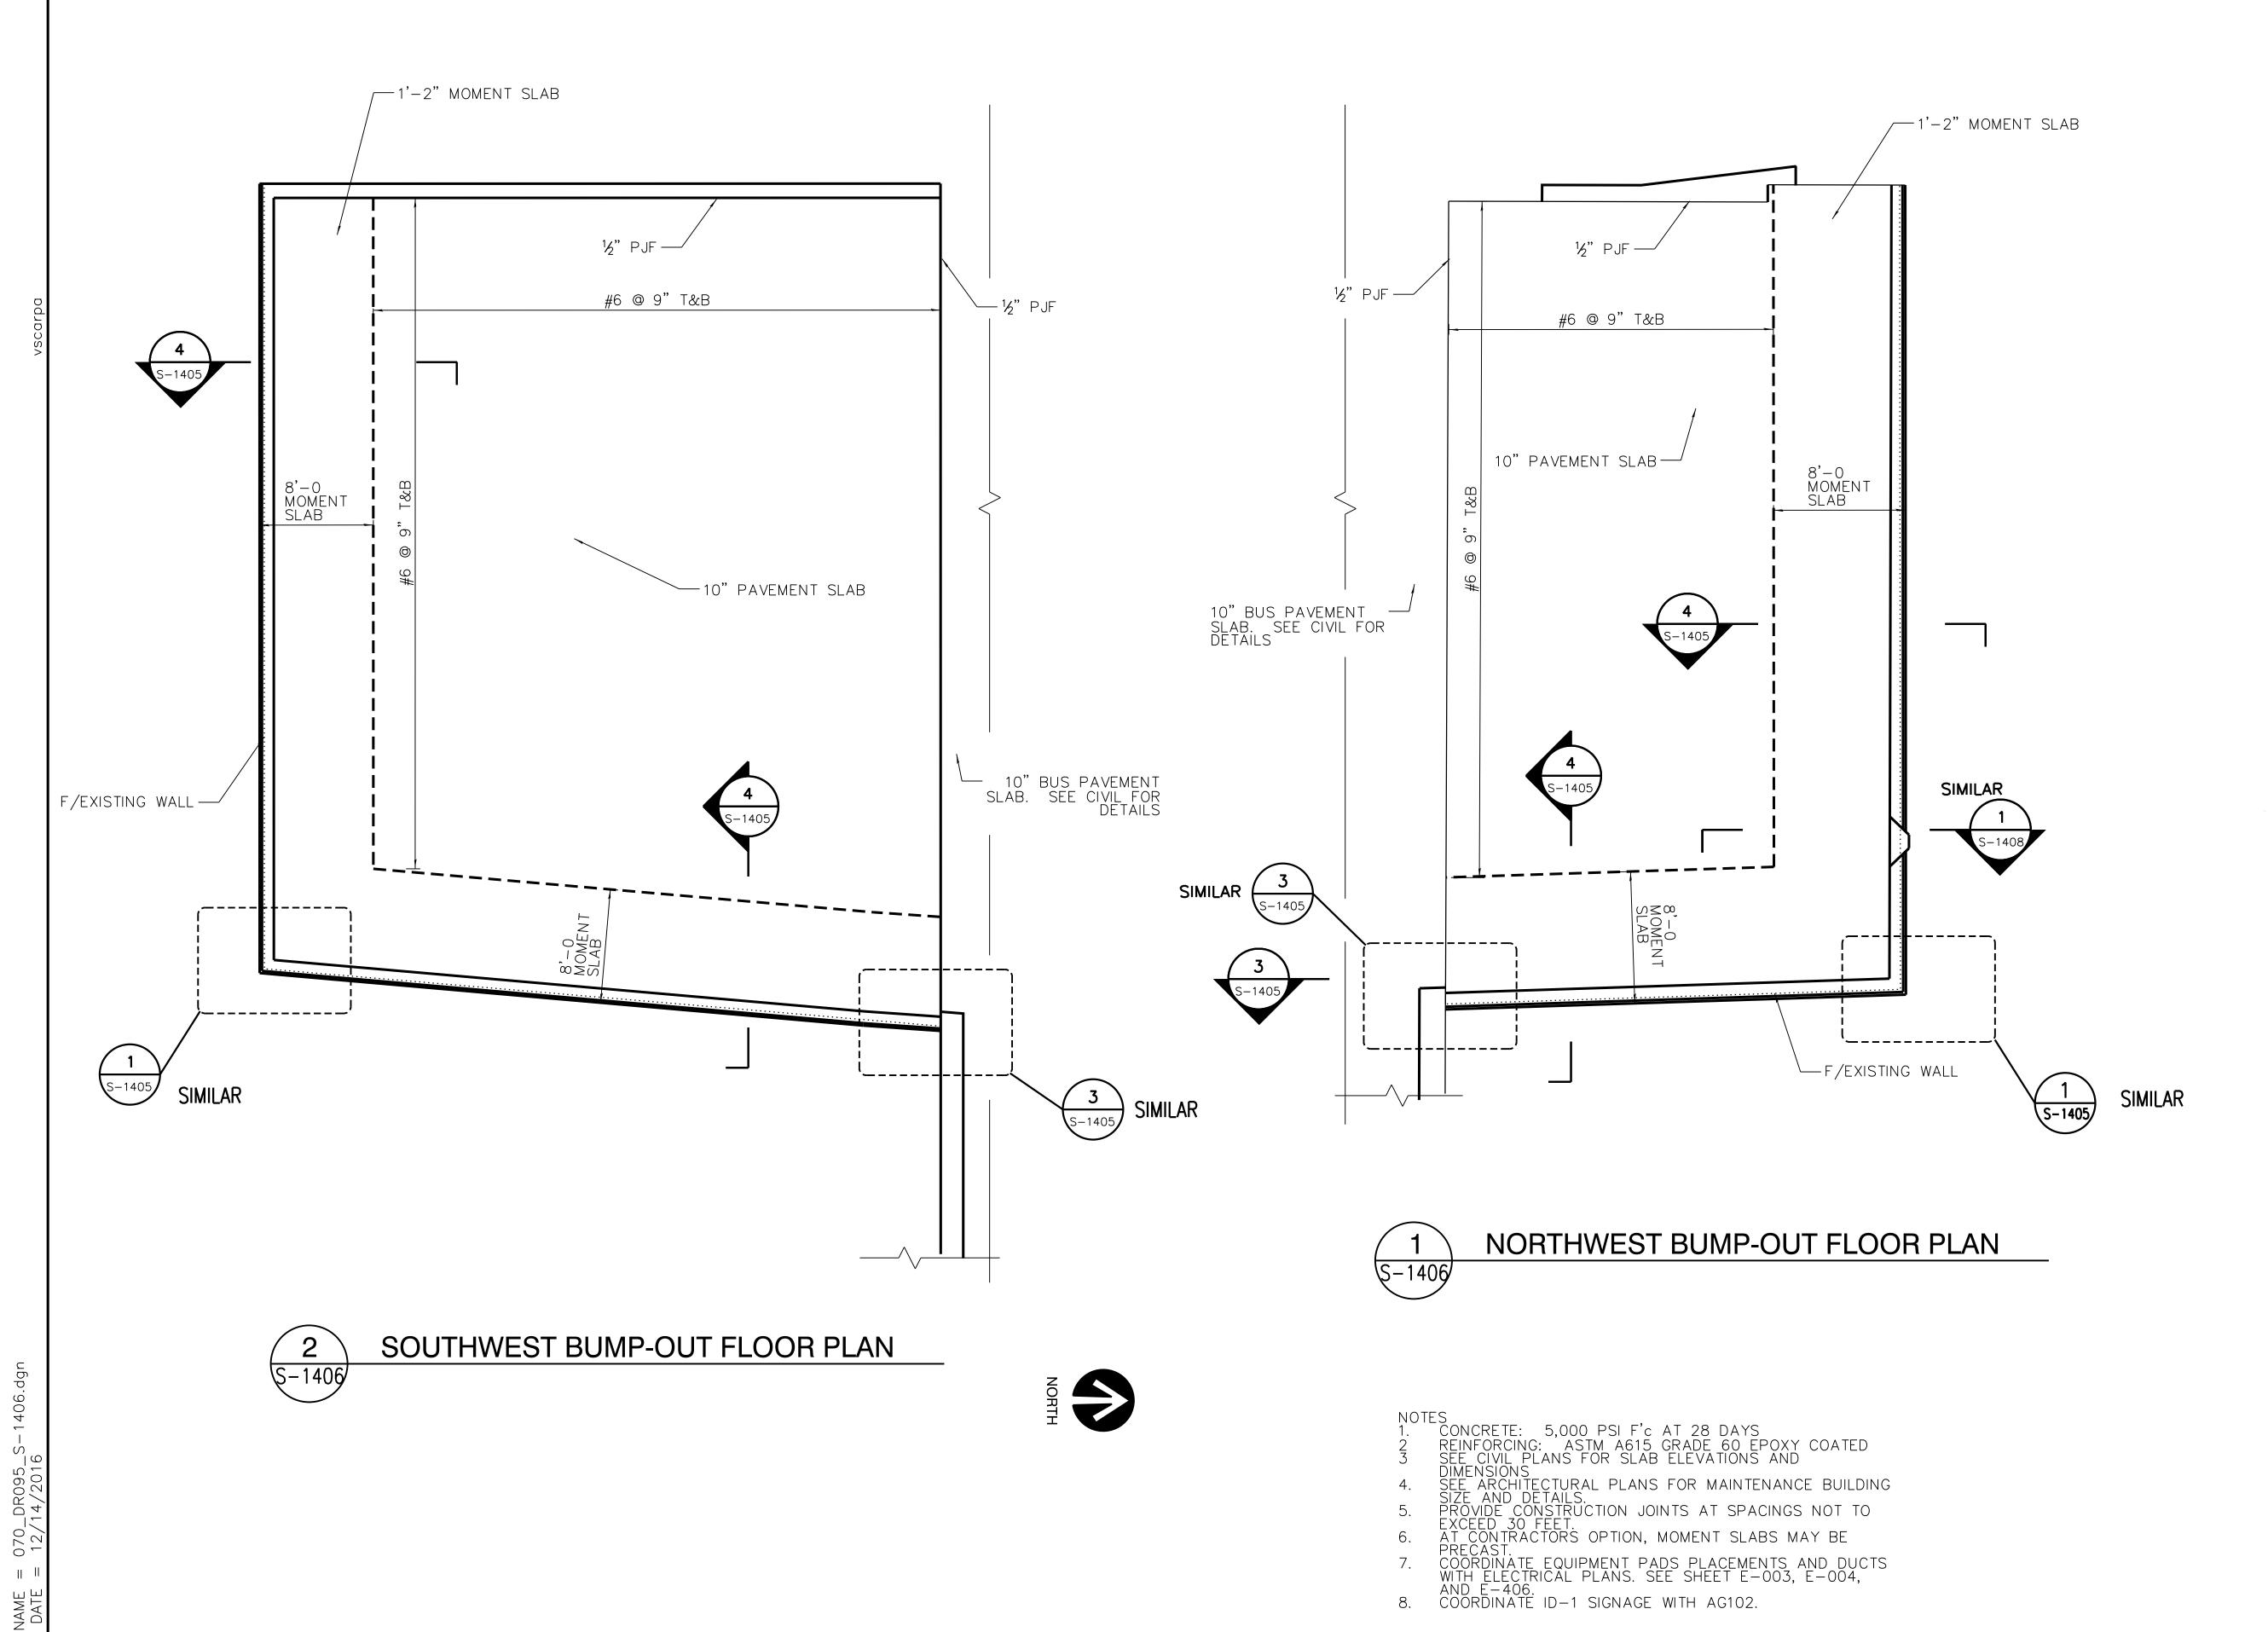
# 95th Terminal Improvement 15 West 95th Street (South Terminal) Chicago, IL 60628

IN CHARGE S. KADERBEK
APPROVED BY D.ZROKA

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APPR	OVED BY	D.ZROKA
CHEC	KED BY	P.MAID
DESIG	ENED BY	L.SOMMER
DRAV	VN BY	T.SLEDGE
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FILE	NAME	File Name
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LOC	ATION IDI	ENTIFIER: <b>DR095</b>

LOCATION IDENTIFIER: DR095

BUMP-OUTS, MOMENT SLABS AND MISC. DETAILS







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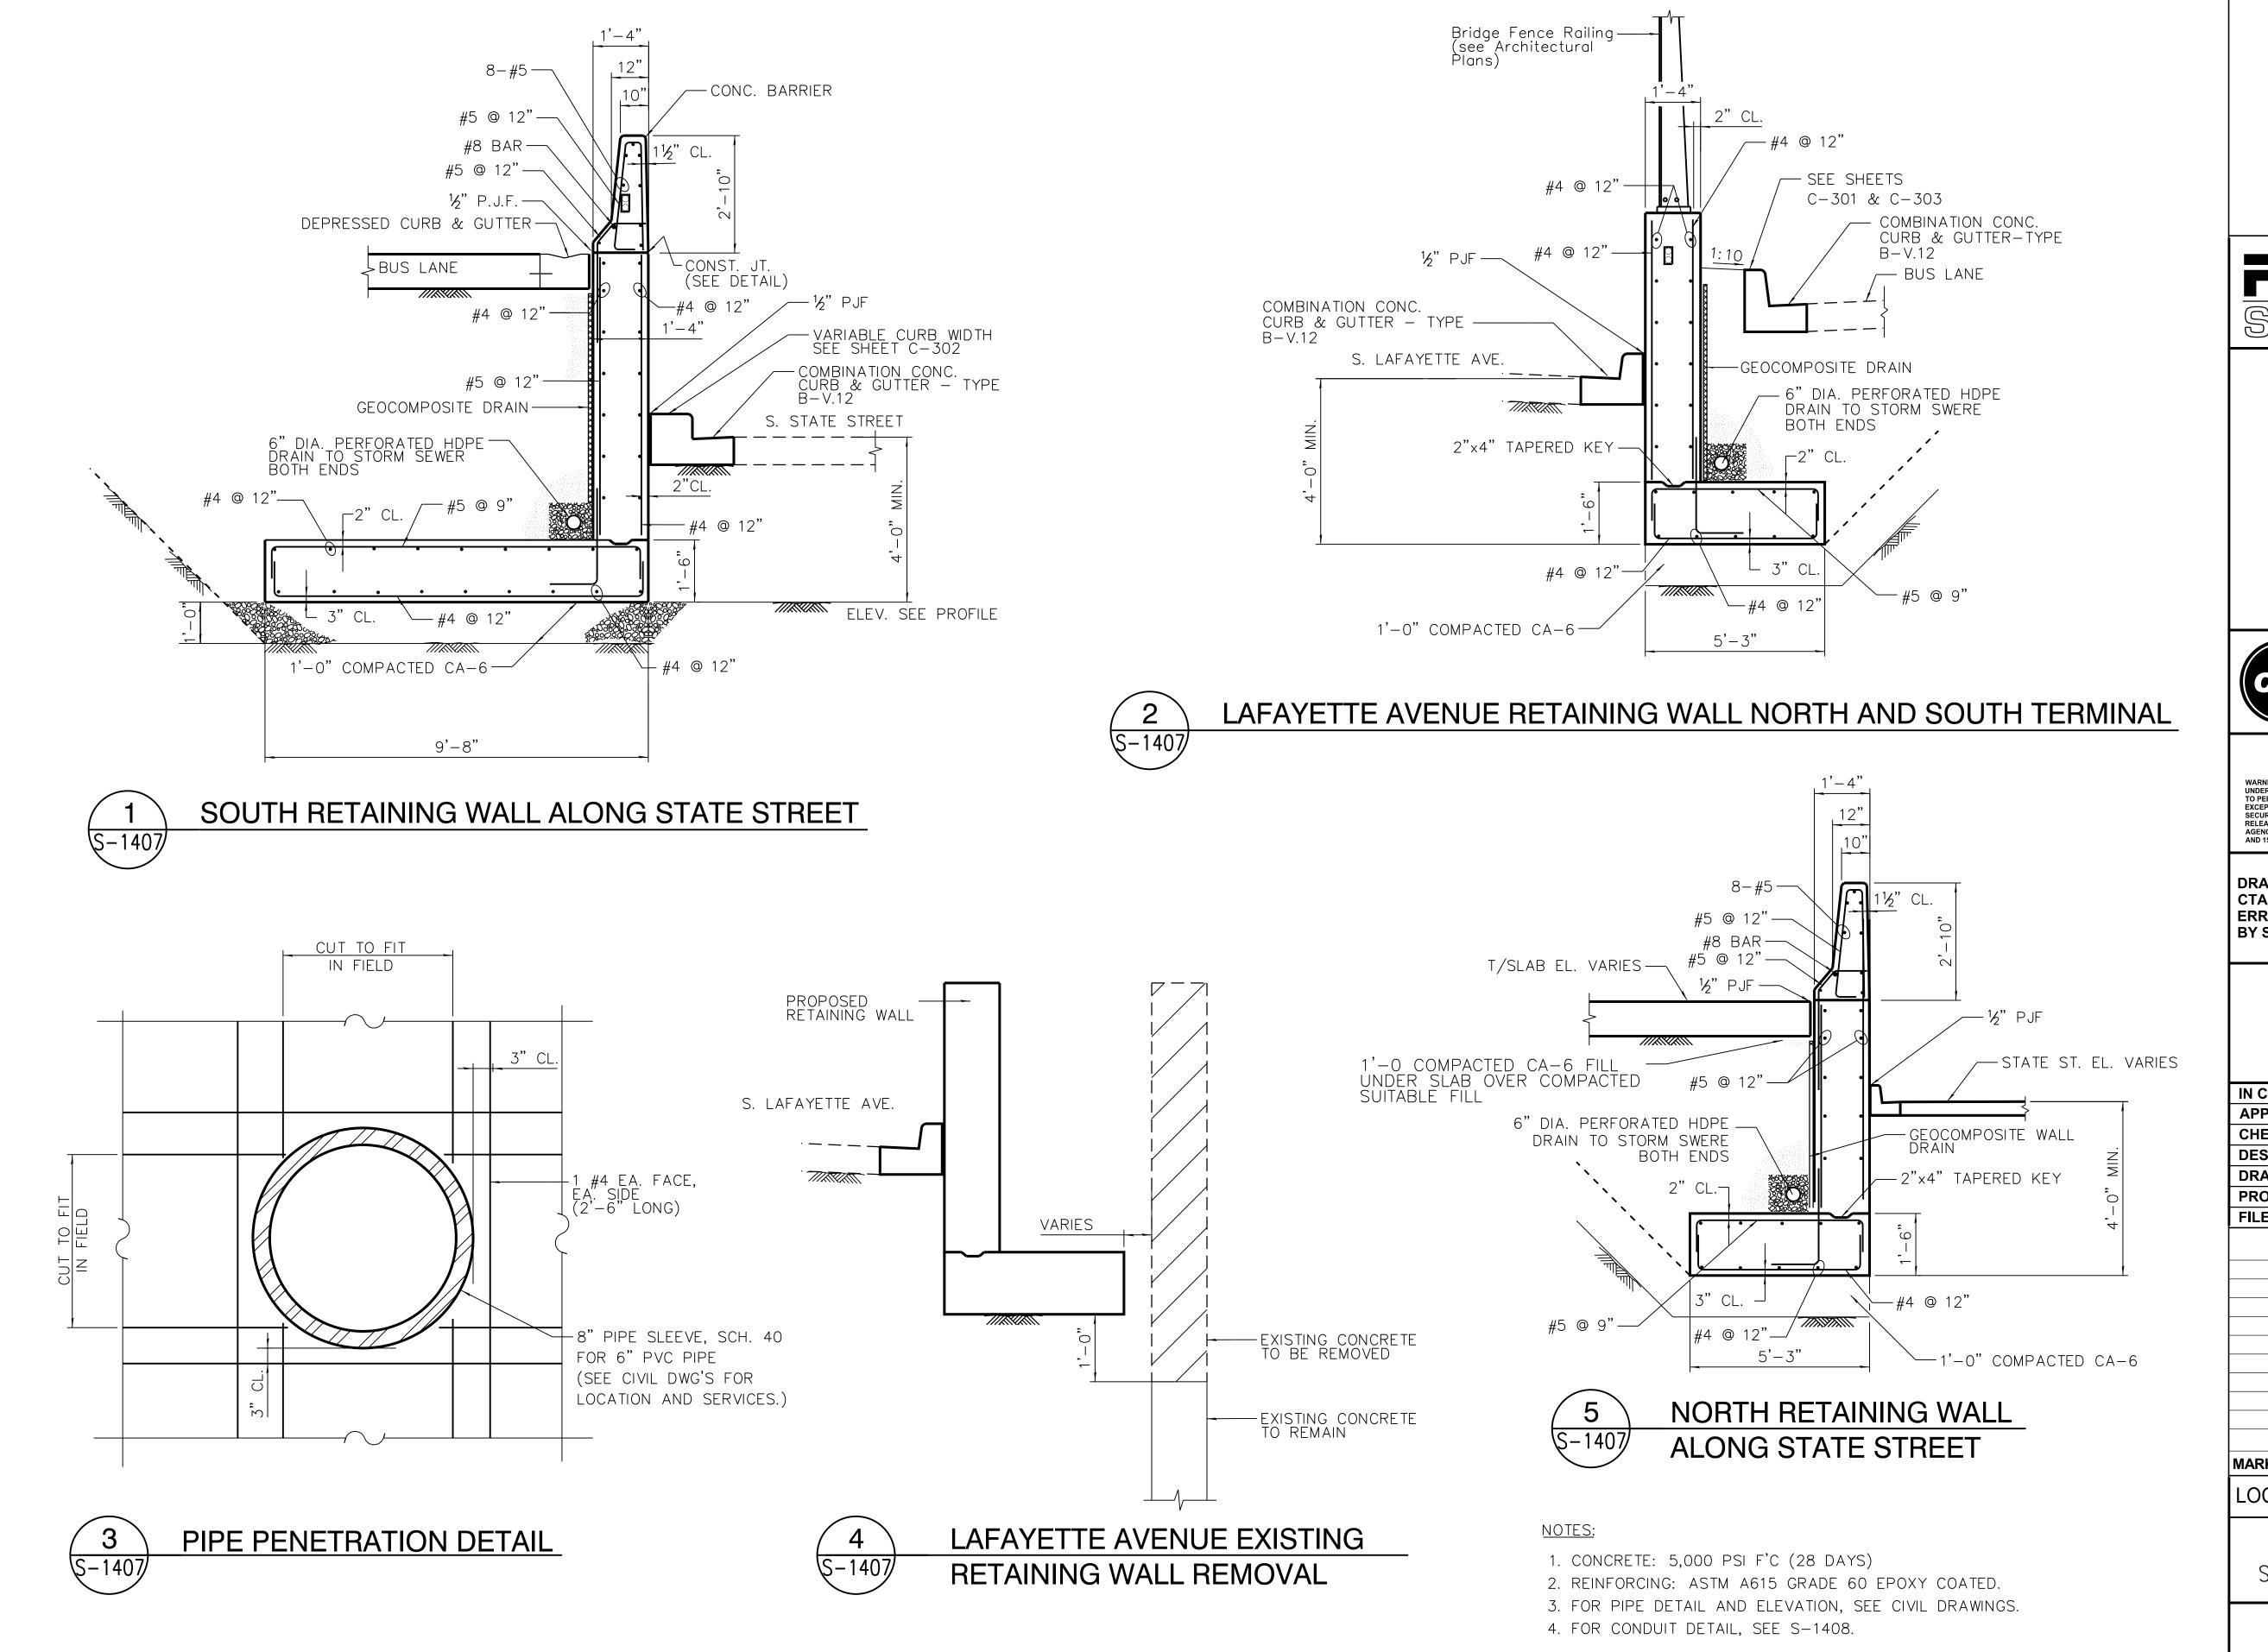
## 95th Terminal Improvement

15 West 95th Street (South Terminal) Chicago, IL 60628

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PROJ	ECT NO.	2012-0021
DRAV	VN BY	T.SLEDGE
DESIGNED BY		L.SOMMER
CHEC	KED BY	P.MAID
APPR	OVED BY	D.ZROKA
IN CH	ARGE	S. KADERBEK

LOCATION IDENTIFIER: DR095

UTILITY ENCLOSURE PLANS -



-1407.dgn

 $= 070_DR095_S - 10/21/2016$ 

FILE NAME

FFP SIN \*exp.



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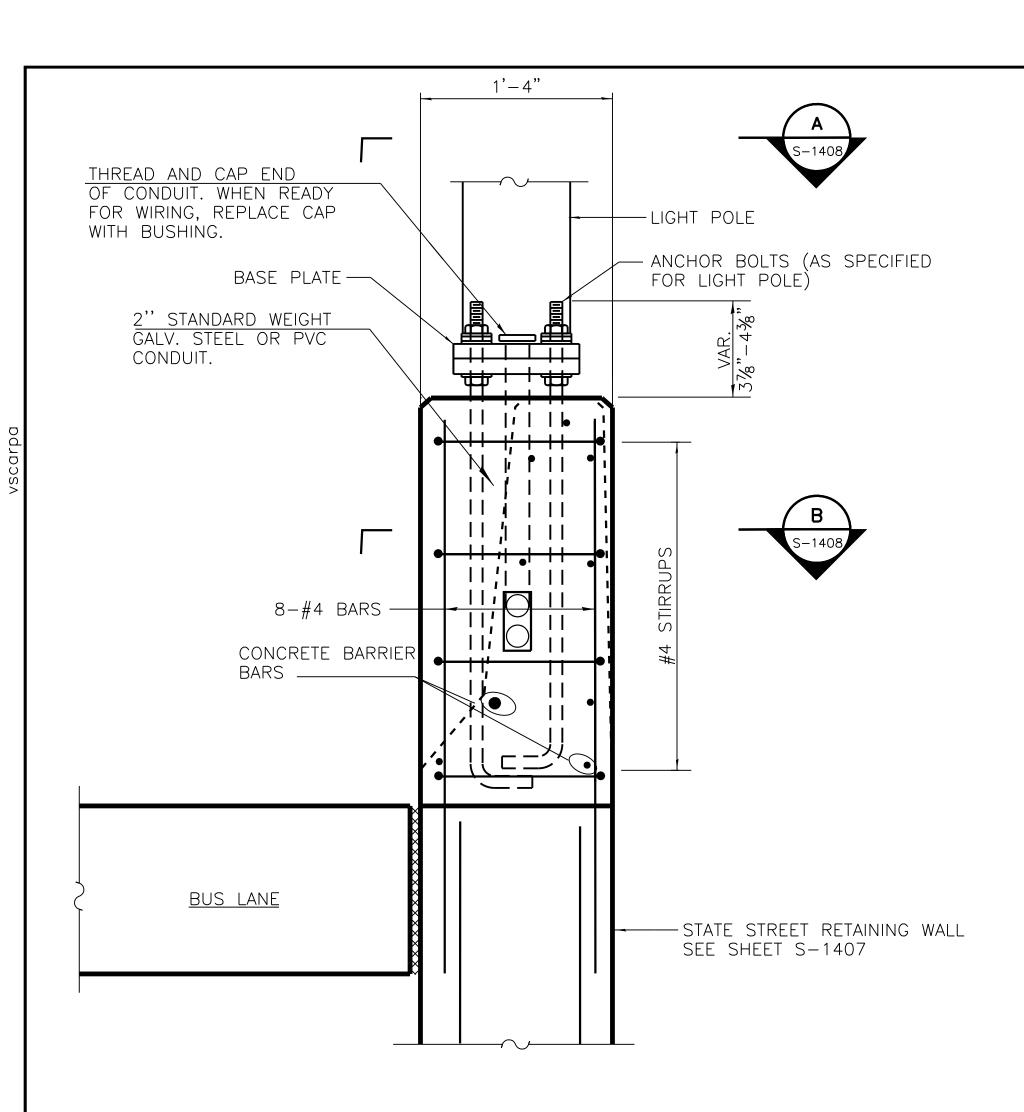
## 95th Terminal Improvement 15 West 95th Street (South Terminal)


15 West 95th Street (South Terminal) Chicago, IL 60628

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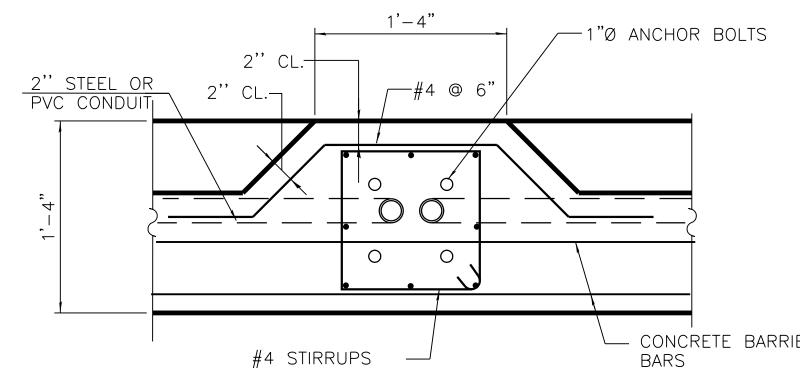
LOCATION IDENTIFIER: DR095


LAFAYETTE AVENUE AND STATE STREET RETAINING WALLS



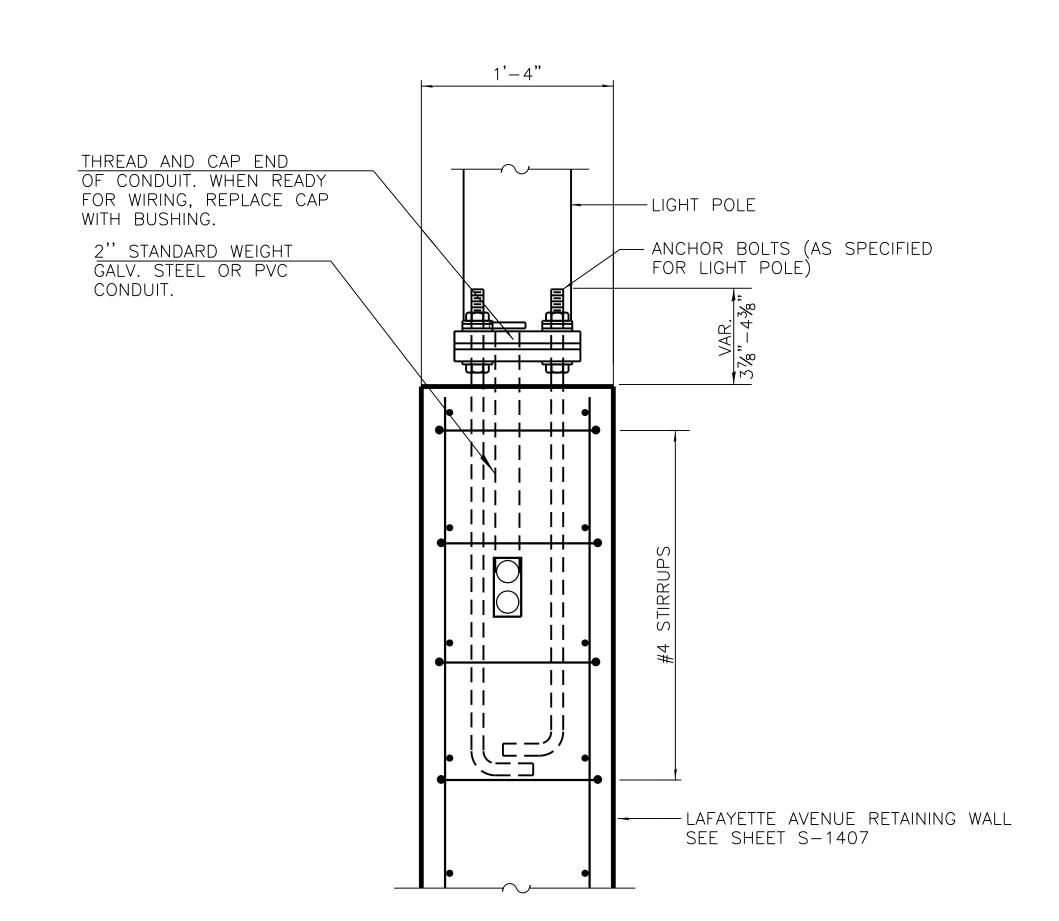

## LIGHT STANDARD DETAIL S-1408 AT BARRIER



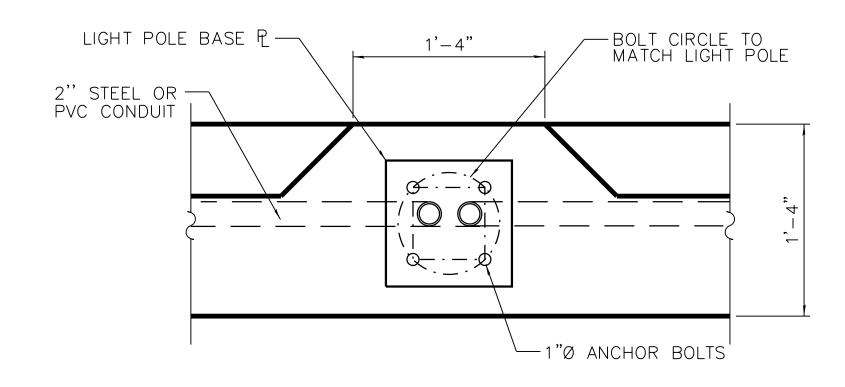






### NOTE:

- 1. FOR LIGHT POLE STRUCTURE AND CONDUIT DETAIL, SEE ELECTRICAL DRAWINGS.
- 2. FOR ID-1 SIGNAGE ADDITIONAL DETAILS SEE AS507.

LIGHT STANDARD DETAIL AT RETAINING WALL

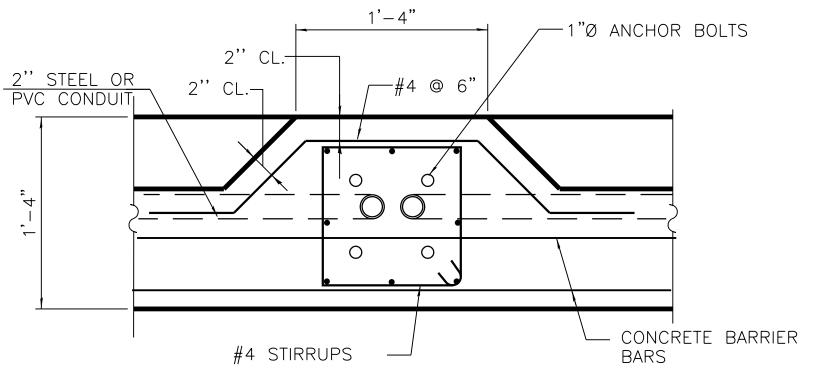



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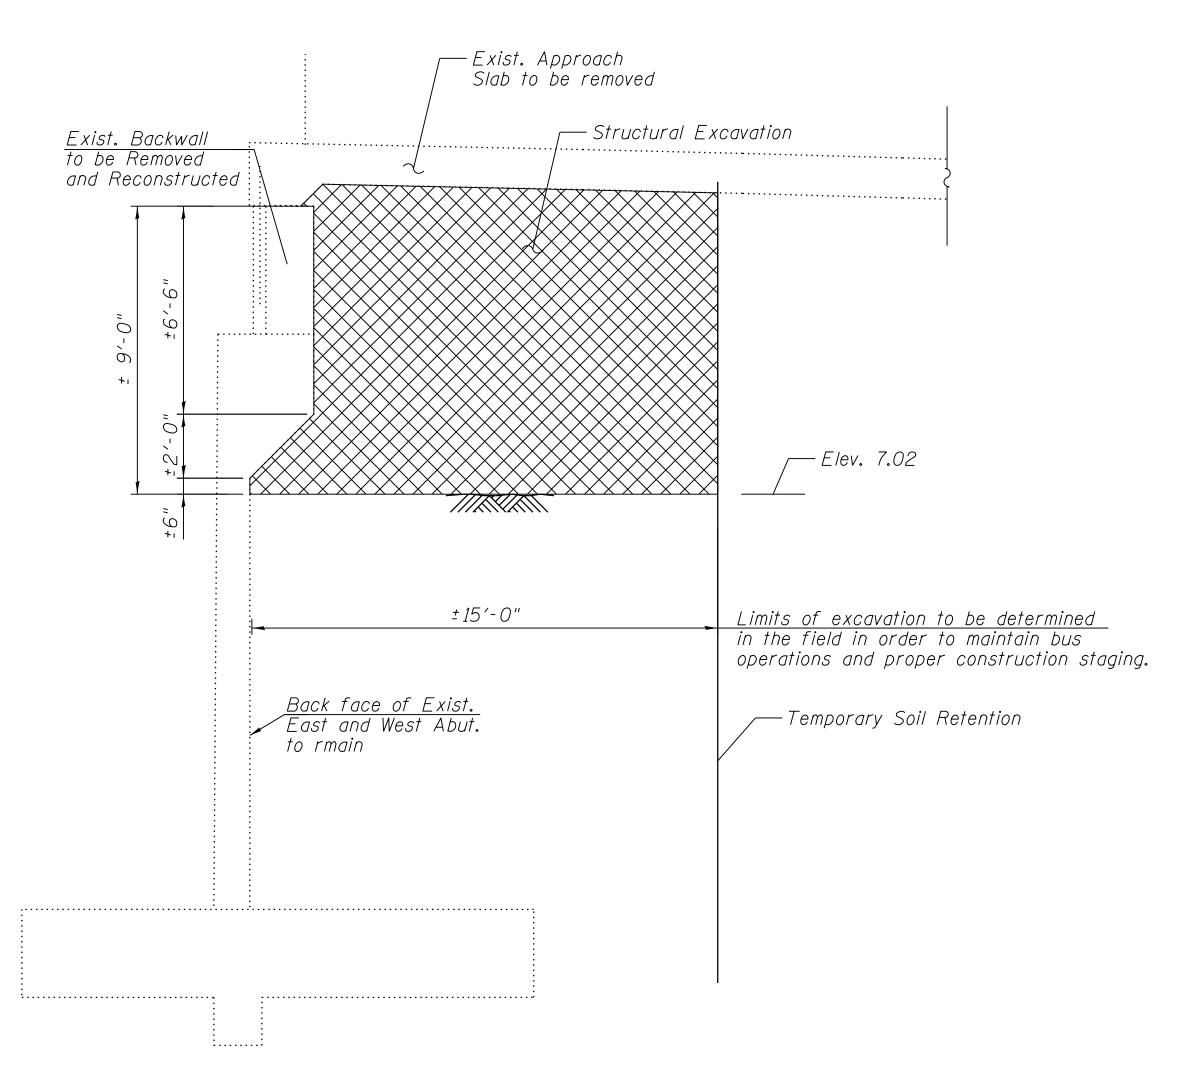
## 95th Terminal Improvement


15 West 95th Street (South Terminal) Chicago, IL 60628

IN CH	ARGE	S. KADERBEK
APPR	OVED BY	D.ZROKA
CHEC	KED BY	P.MAID
DESI	GNED BY	L.SOMMER
DRAV	VN BY	T.SLEDGE
PROJ	ECT NO.	2012-0021
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| LOCATION IDENTIFIER: DR095

LAFAYETTE AVENUE AND STATE STREET LIGHTING DETAILS



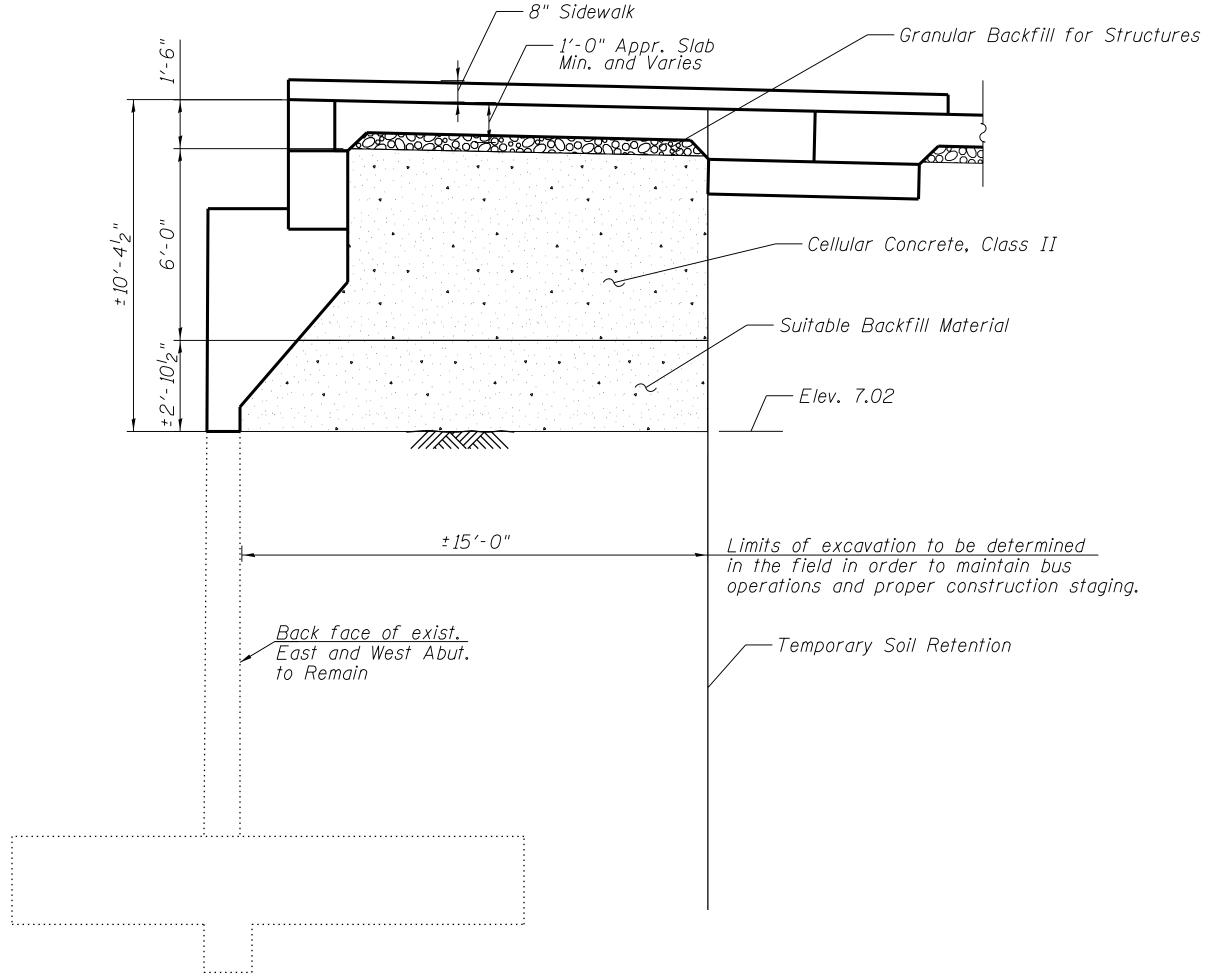

## <u>SECTION A - EXCAVATION</u> (West Abutment - Looking South)

(West Abutment - Looking South) (East Abutment - Looking North) Scale: N.T.S.

### CONSTRUCTION SEQUENCE:

- 1) Remove Existing Approach Slab.
- 2) Excavate behind Existing Retaining wall to the Limits shown on the plans.
- 3) Remove Backwall.
- 4) Reconstruct Backwall as shown on Sheets 95TH-S-135 and 95TH-S-140.
- 5) Backfill with approved Cellular Concrete in lifts not exceeding four (4) feet.
- 6) Backfill with Granular Backfill for Structures.
- 7) Construct Approach Slab. Closure Pour and Sidewalk.

### SECTION A - CELLULAR CONCRETE

(West Abutment - Looking South) (East Abutment - Looking North) Scale: N.T.S.

### NOTES:

 Cellular Concrete shall be placed in layers not exceeding 3 Feet in thickness.

<u>LEGEND:</u>

Structure Excavation

•

Cellular Concrete

FFP M \*exp



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## 95th Terminal Improvement


15 West 95th Street (South Terminal) Chicago, IL 60628

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RAV	VN BY	T.SLEDGE
ROJ	ECT NO.	2012-0021
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LOCATION IDENTIFIER: DR095

95TH ST. BRIDGE
EAST AND WEST EXISTING WALL
EXCAVATION & CELLULAR CONCRETE
SN 016-0437

95TH-S-140A

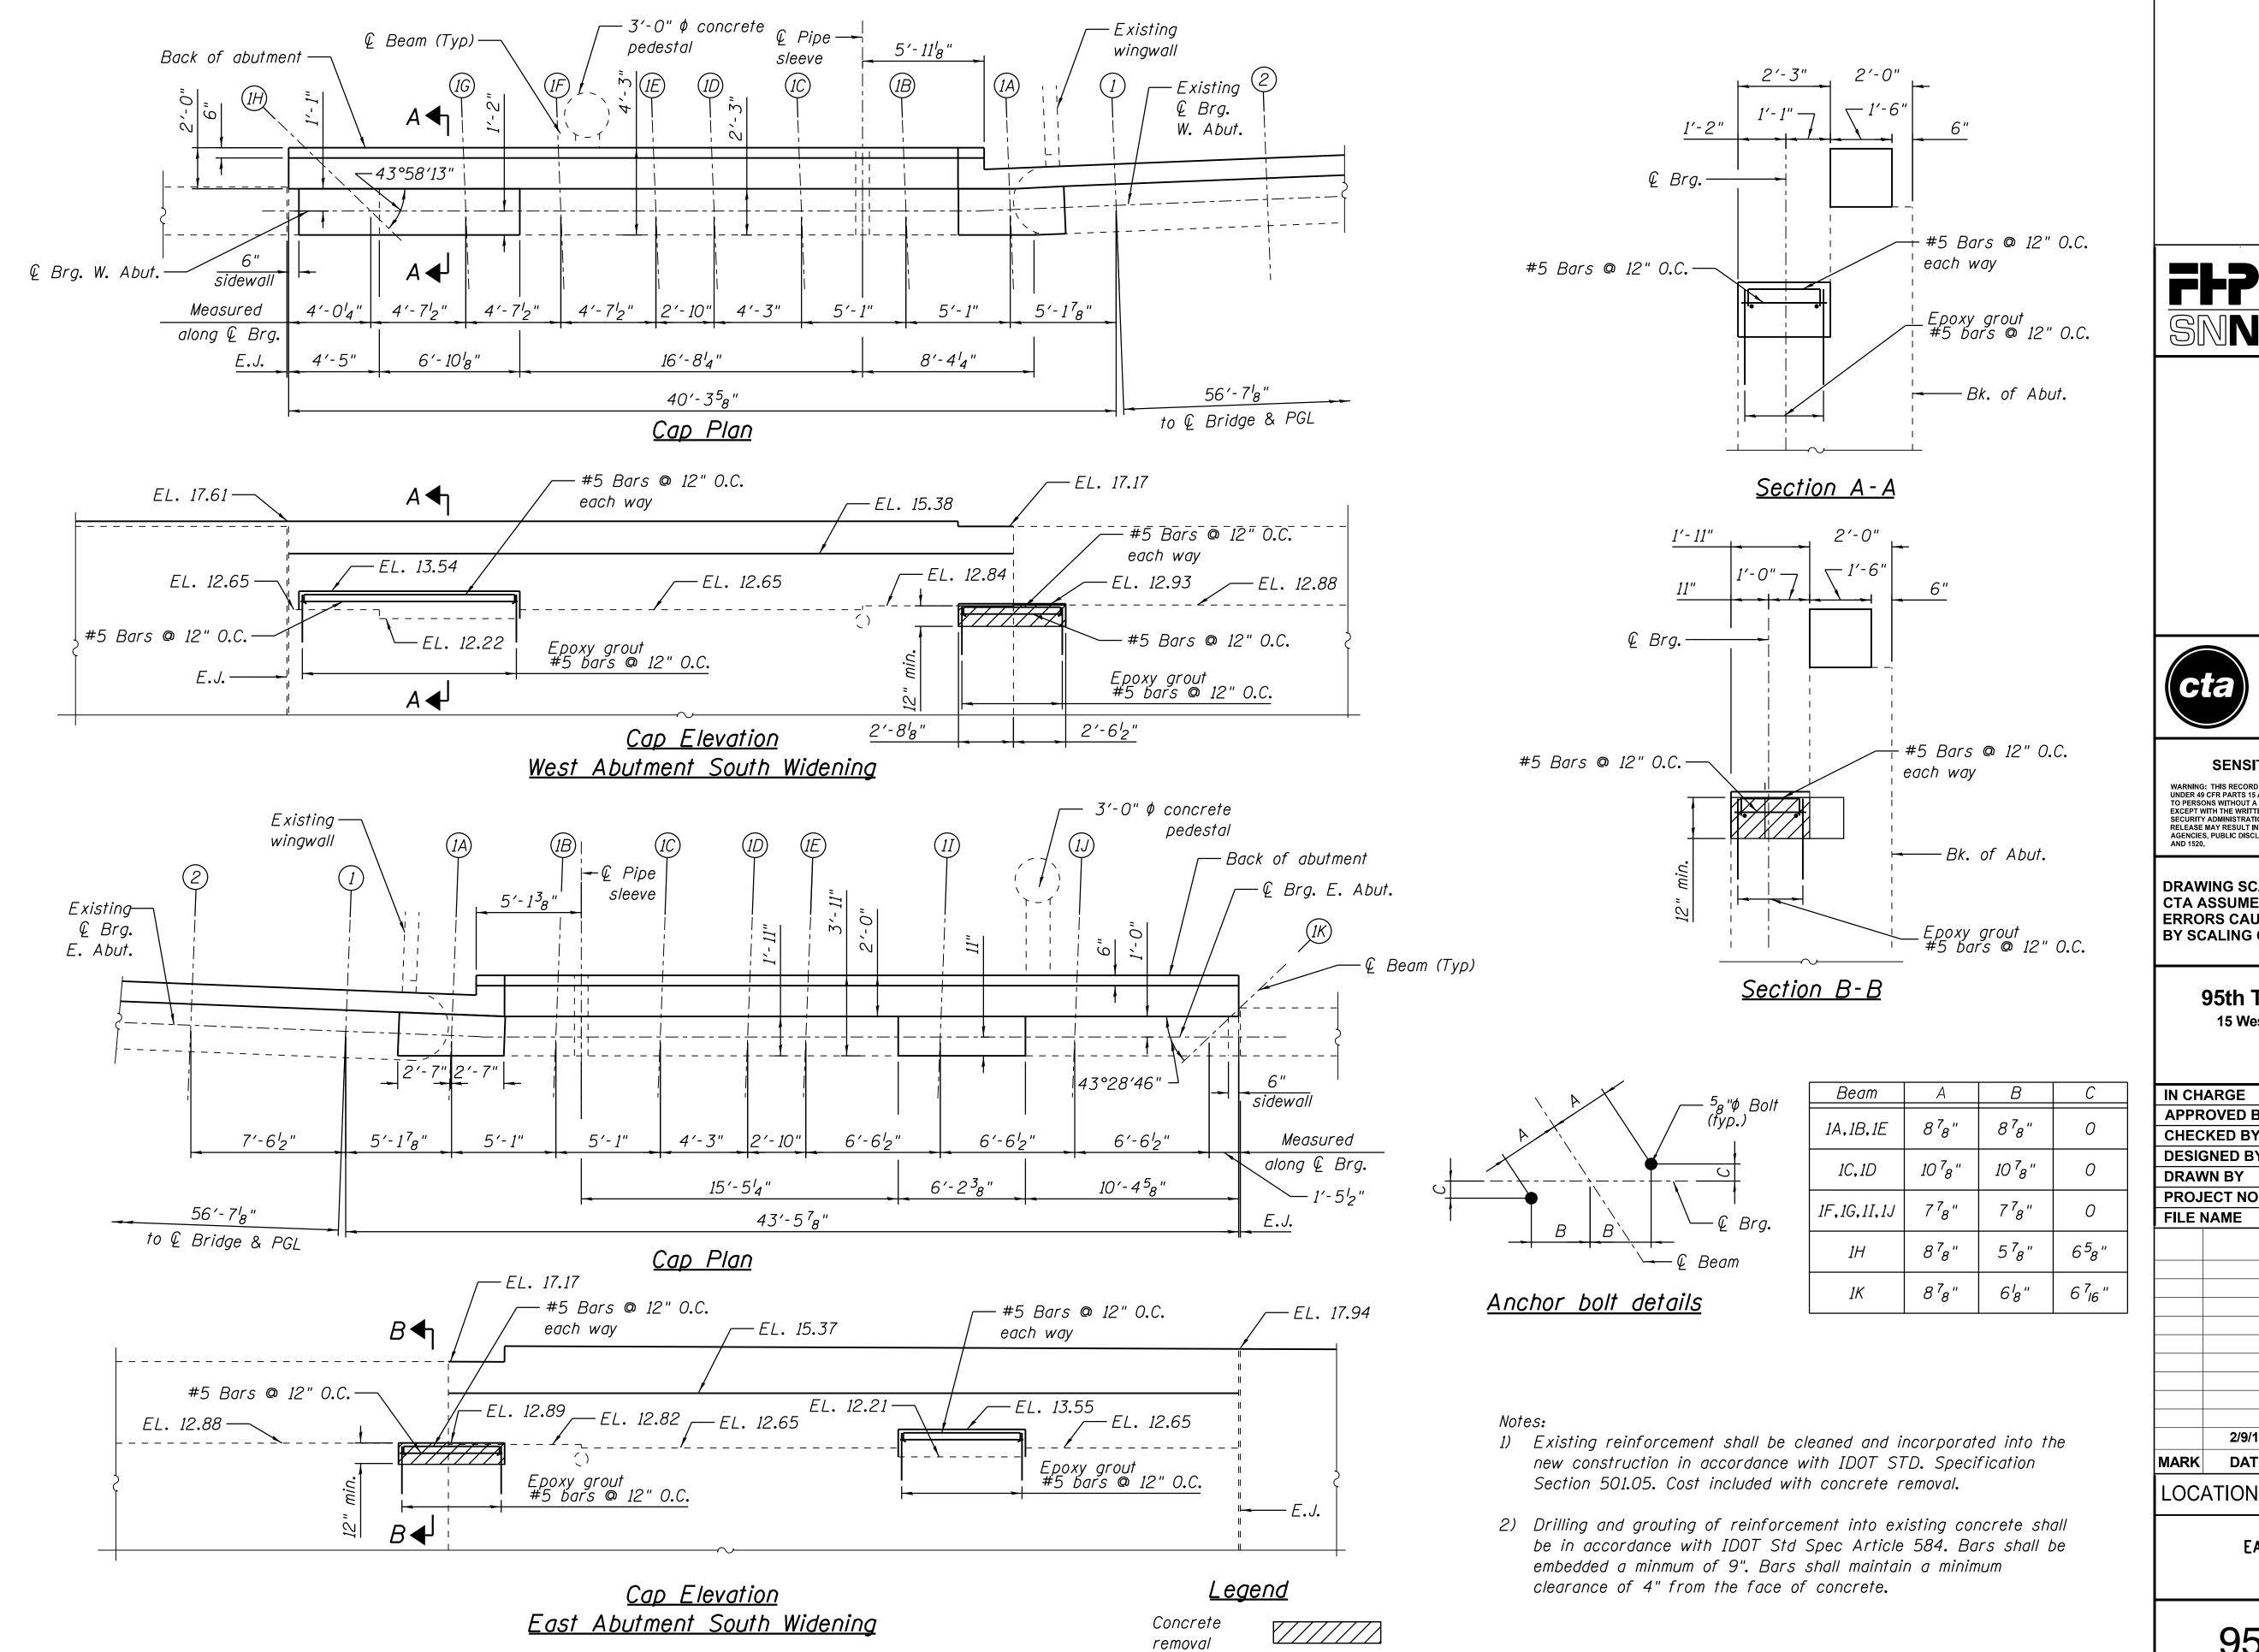

FILE NAME



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## 95th Terminal Improvement

15 West 95th Street (South Terminal) Chicago, IL 60628

IN CH	ARGE	S. KADERBEK
APPR	OVED BY	D.ZROKA
CHEC	KED BY	P.MAID
DESIG	SNED BY	L.SOMMER
DRAV	VN BY	T.SLEDGE
PROJ	ECT NO.	2012-0021
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LOCATION IDENTIFIER: **DR095** 

95TH ST. BRIDGE EAST & WEST ABUTMENTS SOUTH WIDENINGS SN 016-0437

95TH-S-140B

PIER 1 EAST ELEVATION

(Looking West)

Notes:

1. Waterproof coating shall be applied to all

section 03 74 00.

areas against actual areas.

exposed surfaces after repairs are complete.

See structural repair of concrete specification,

2. Areas of repair and lengths of sealant are approximate.

Contractor shall verify areas and include a 10 percent

increase in all quantities to allow for variations in plan

1. CTA electric ducts attached to the cap not shown for clarity.

### <u>LEGEND</u>

`—Existing Base of Rail


Epoxy seal (Width > 0.06")


> Hairline Crack not to be sealed (Width < 0.06")

Structural repair of concrete (Depth greater than 5 inches) Repair of concrete (Depth equal

SF = Square Foot



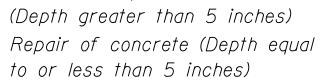

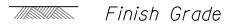

LF = Linear Foot





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## 95th Terminal Improvement

15 West 95th Street (South Terminal) Chicago, IL 60628

IN CH	ARGE	S. KADERBEK	
APPR	OVED BY	D.ZROKA	
CHEC	KED BY	P.MAID	
DESIG	ENED BY	L.SOMMER	
DRAV	VN BY	T.SLEDGE	
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95TH ST. BRIDGE PIER 1 REPAIR DETAILS (SHEET 1 OF 2) SN 016-0437

95TH-S-144

Note:

FILE NAME PLOT DATE



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## 95th Terminal Improvement

15 West 95th Street (South Terminal) Chicago, IL 60628

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PROJE	CT NO.	2012-0021
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DESIG	NED BY	L.SOMMER
CHECI	KED BY	P.MAID
APPRO	OVED BY	D.ZROKA
IN CHA	ARGE	S. KADERBEK


LOCATION IDENTIFIER: **DR095** 

> 95TH ST. BRIDGE PIER 1 REPAIR DETAILS (SHEET 2 OF 2) SN 016-0437

95TH-S-144A

- variations in planareas against actual areas.

3. See 95th-S-150, detail F, for barier detail.

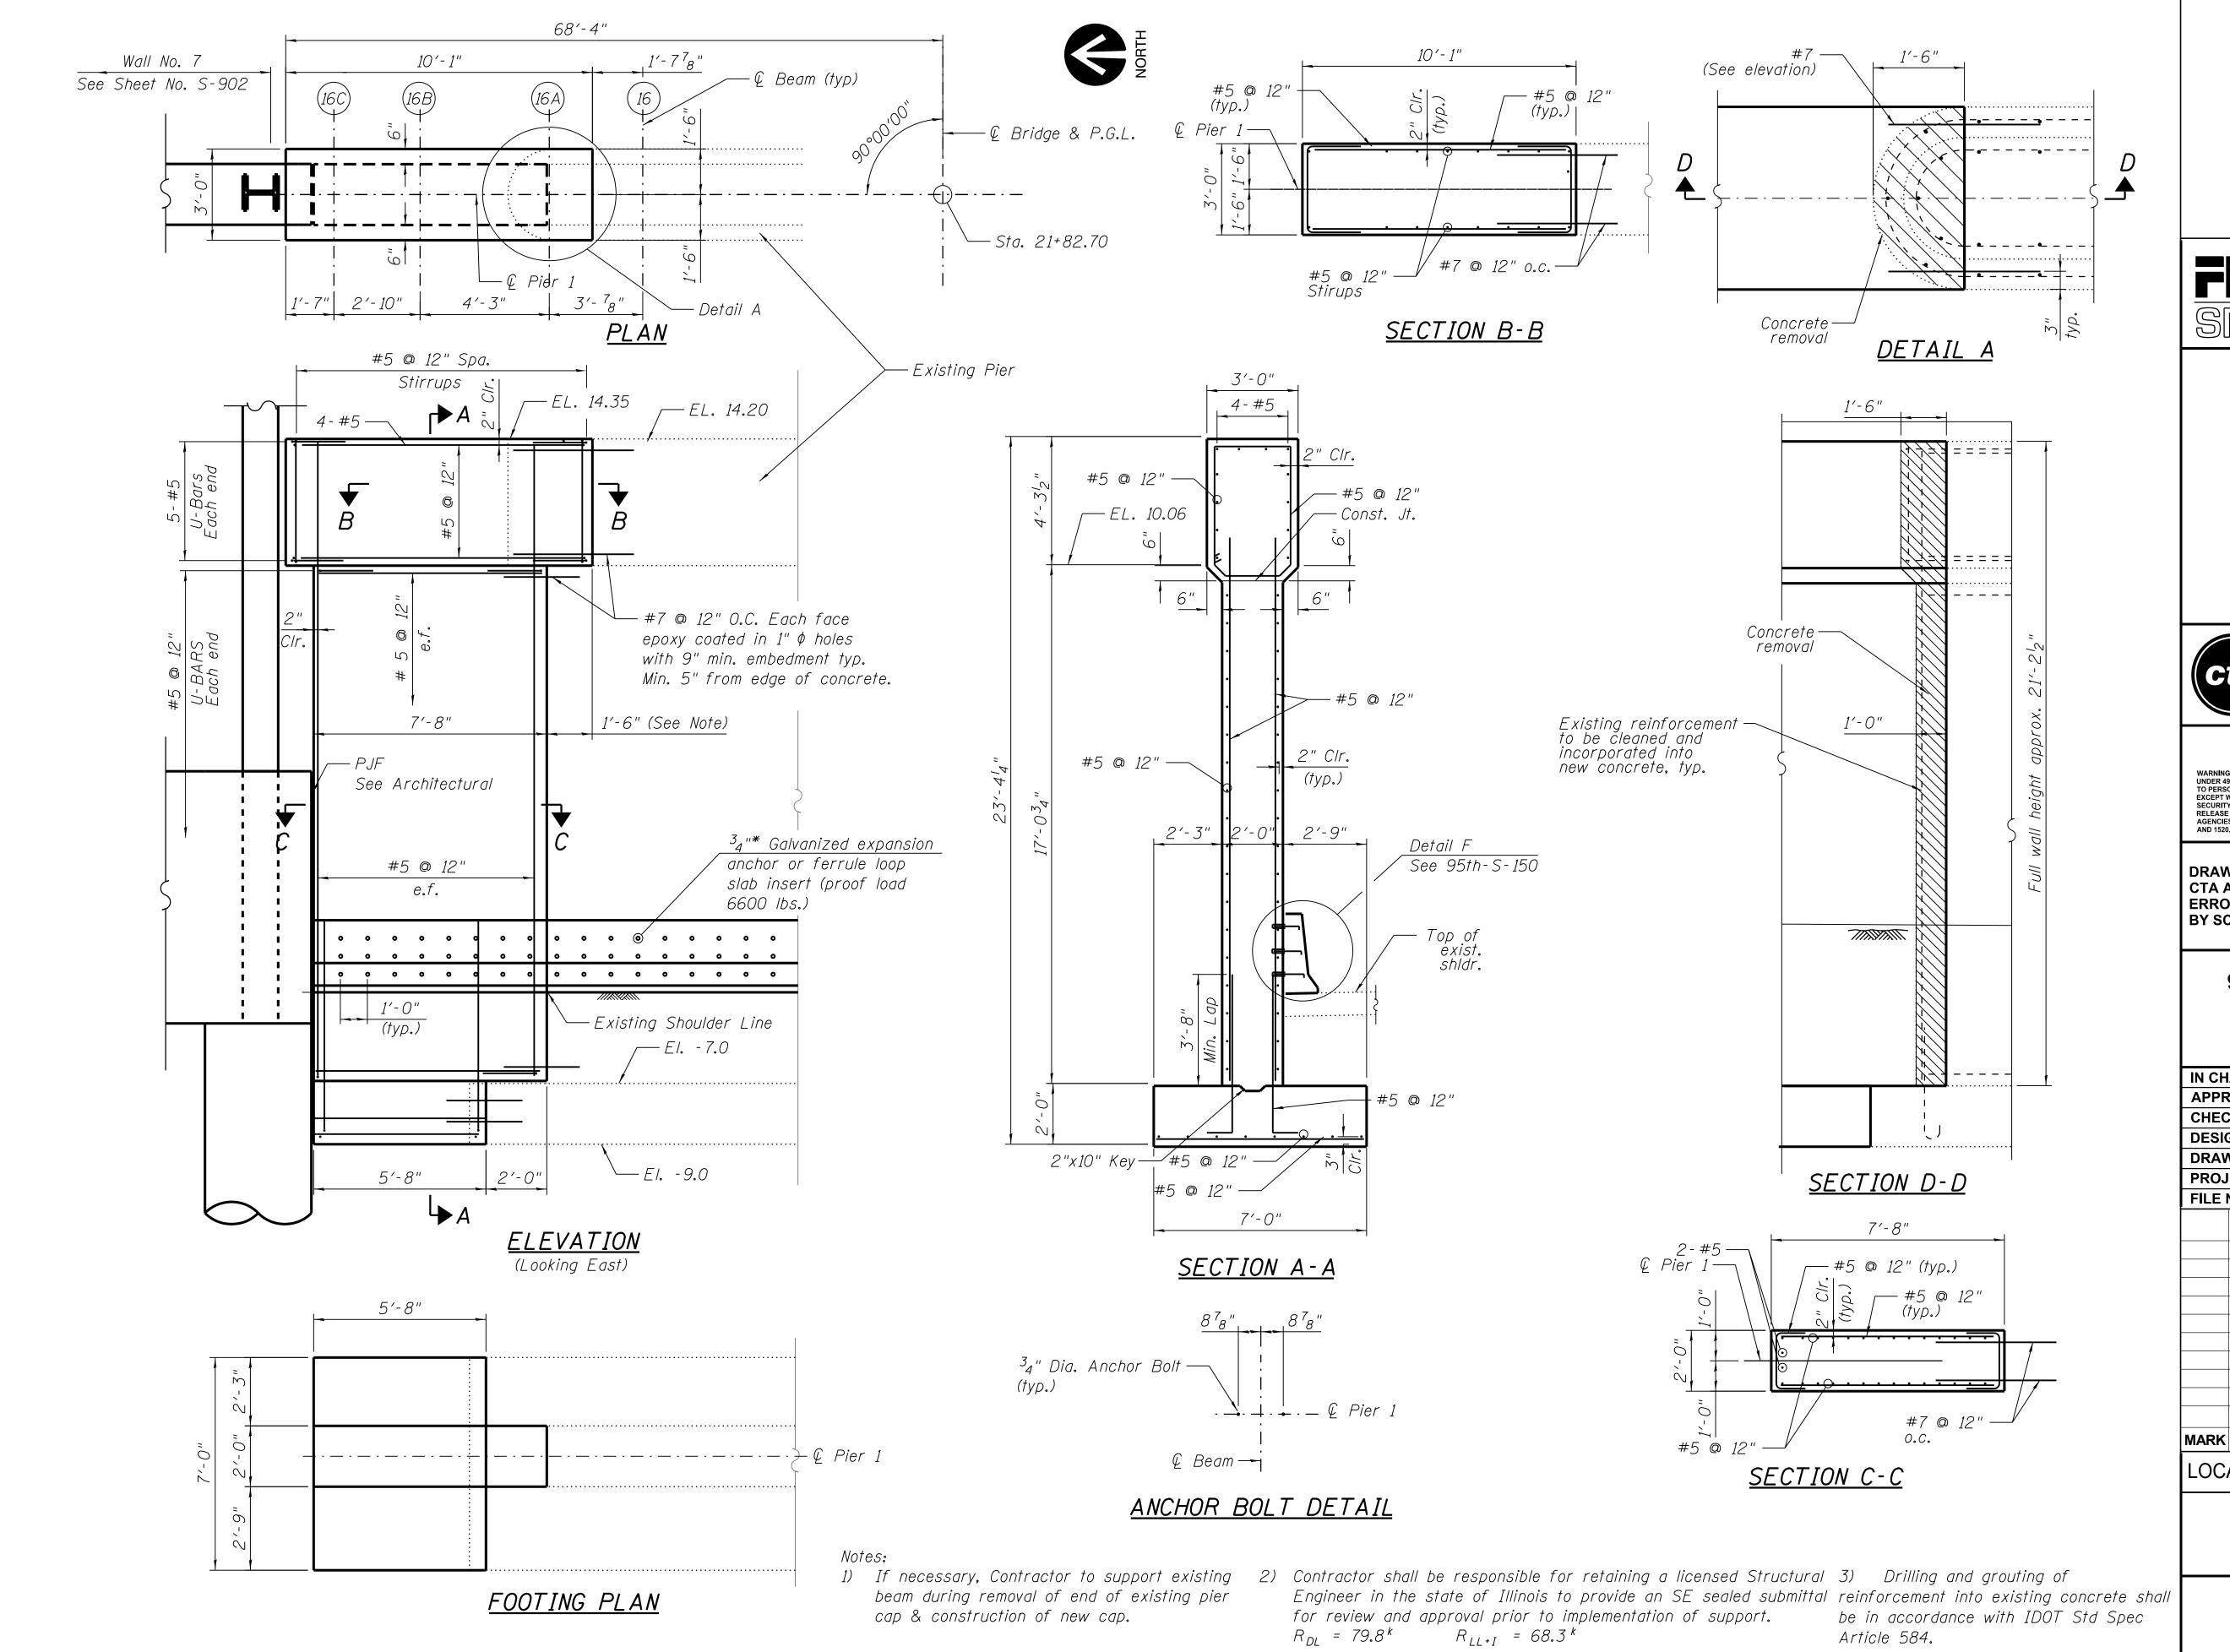

ILE NAME =  $070_DR095_$ PLOT DATE = 8/31/2016



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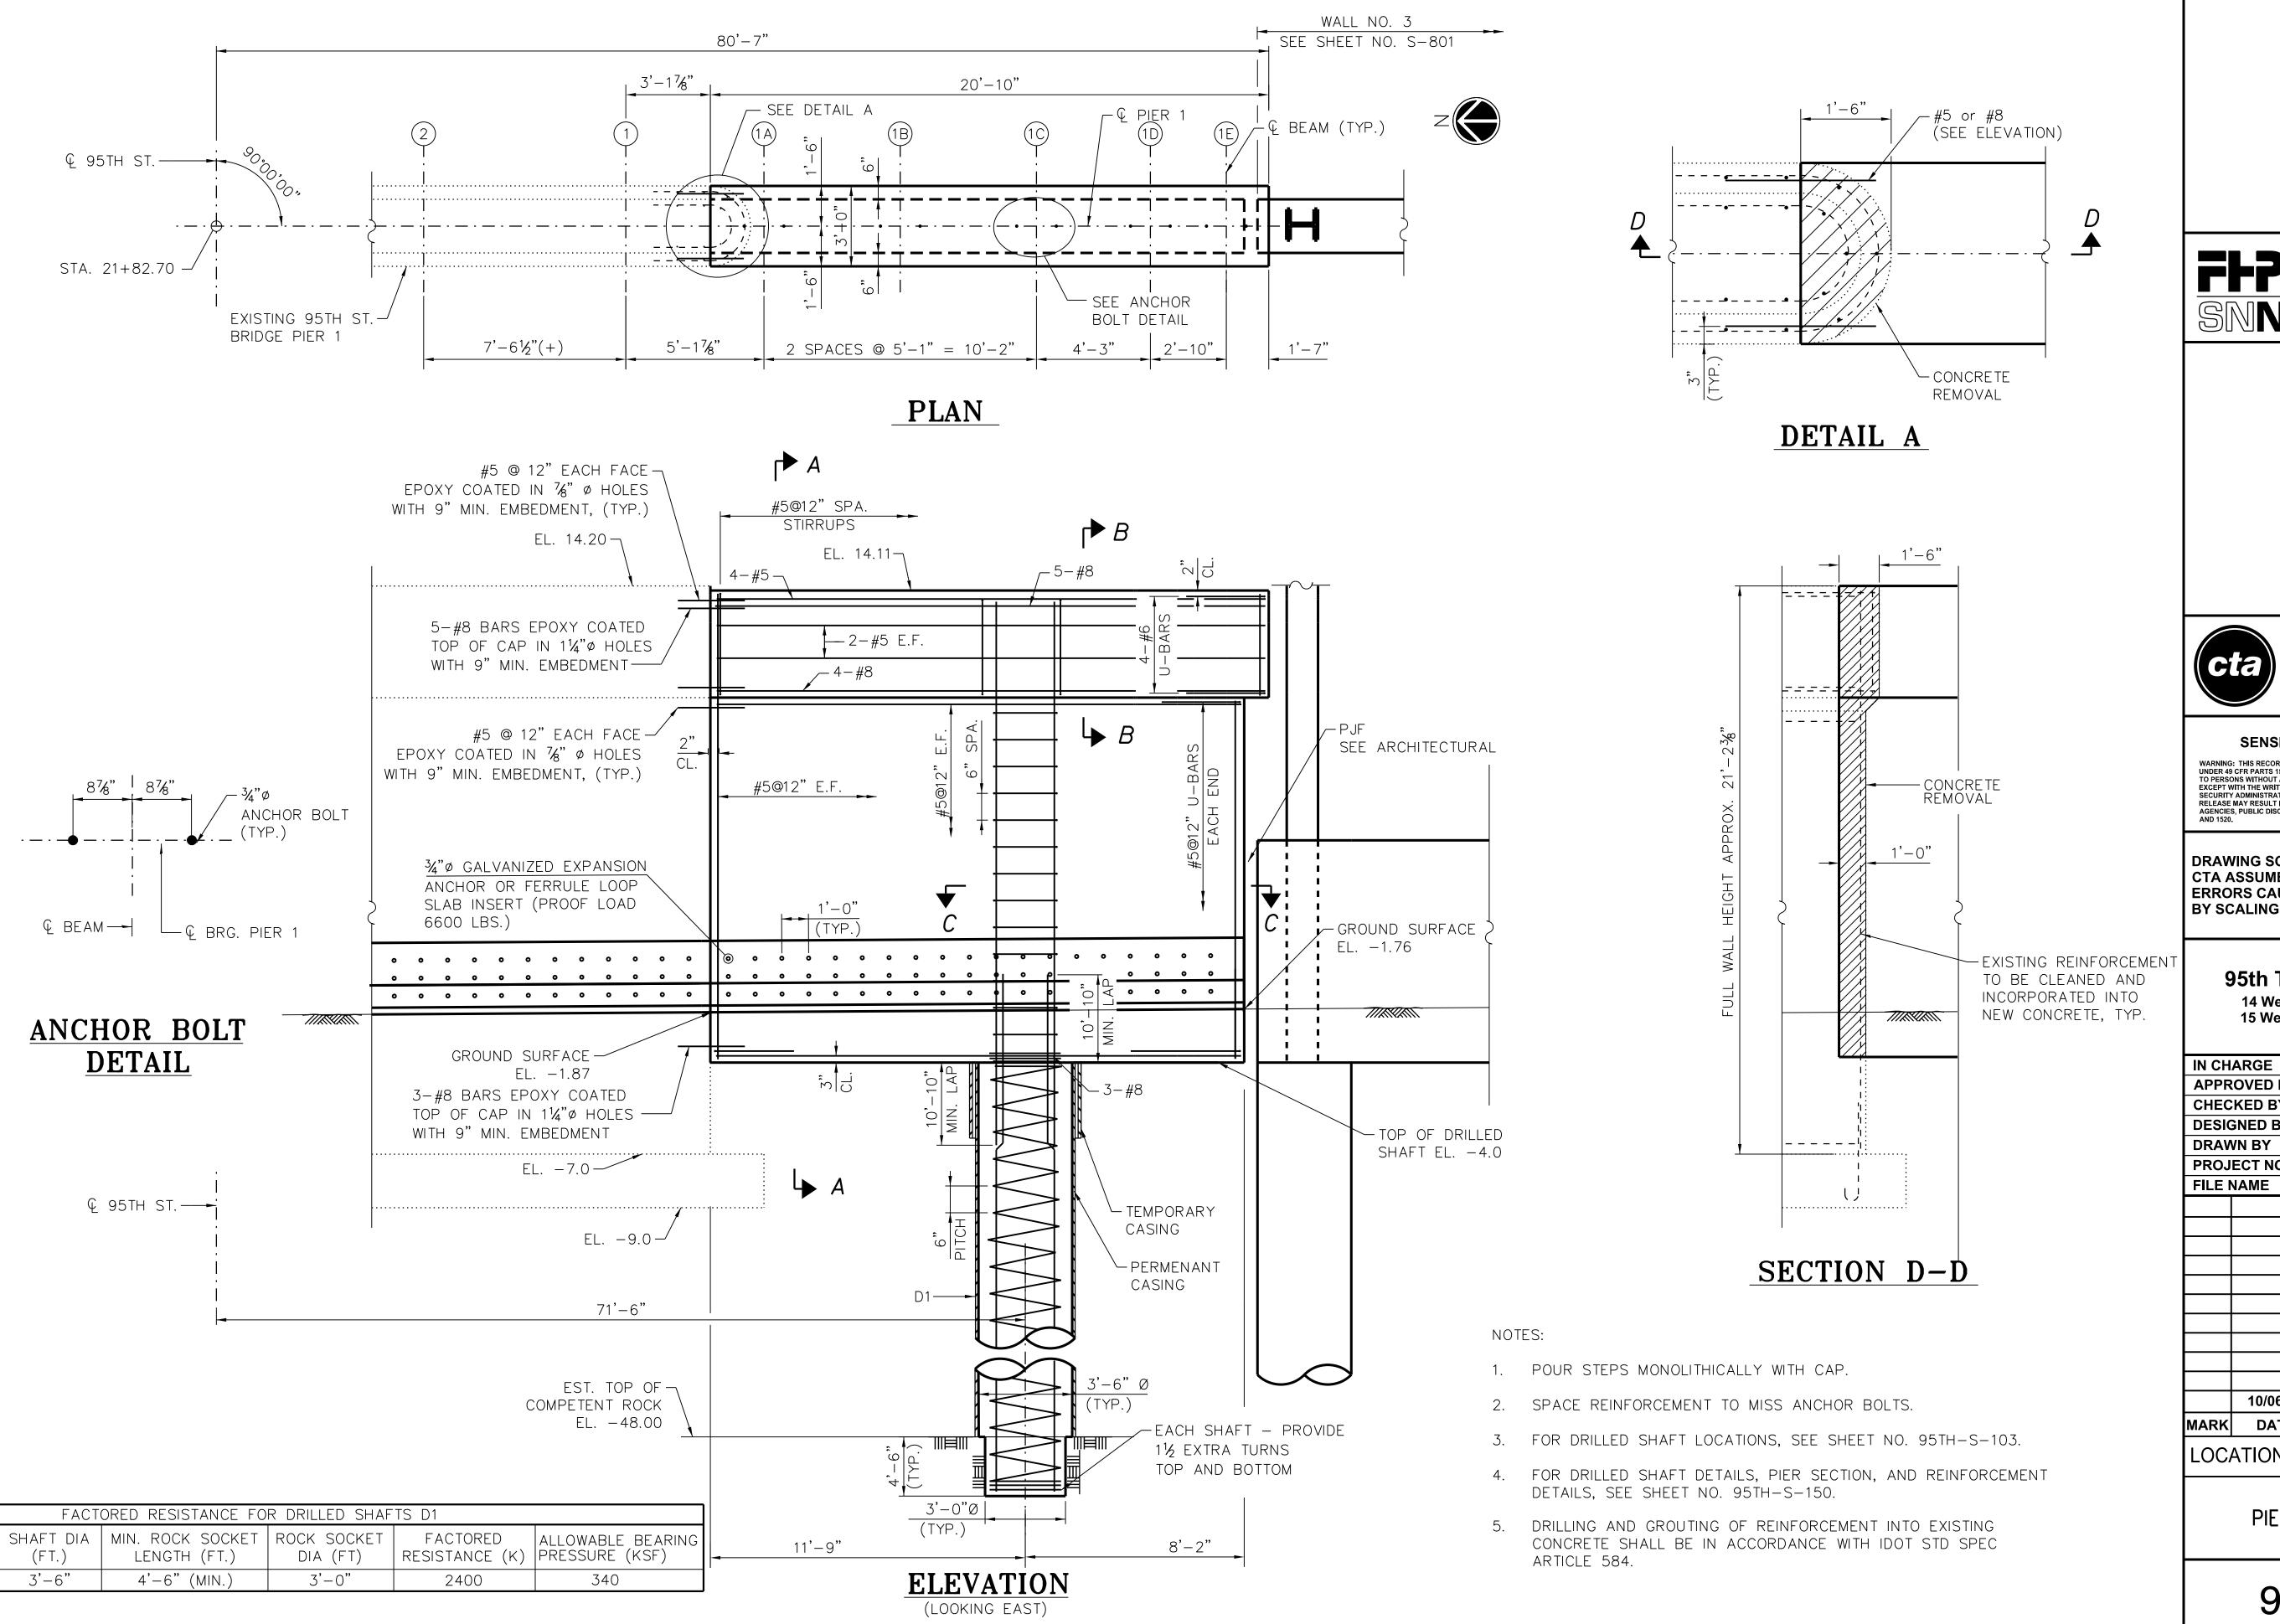
## 95th Terminal Improvement

15 West 95th Street (South Terminal) Chicago, IL 60628

IN CH	ARGE	S. KADERBEK
APPR	OVED BY	D.ZROKA
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DESIG	ENED BY	L.SOMMER
DRAW	VN BY	T.SLEDGE
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95TH ST. BRIDGE PIER 1 NORTH WIDENING SN 016-0437



FFP SIN SIN SEXP.



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### **95th Terminal Improvement**

14 West 95th Street (North Terminal) 15 West 95th Street (South Terminal) Chicago, IL 60628

S. KADERBEK

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APPR	OVED BY	D.ZROKA	
CHECKED BY		P.MAID	
DESIC	ENED BY	L.SOMMER	
DRAV	VN BY	T.SLEDGE	
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| LOCATION IDENTIFIER: DR095

95TH ST. BRIDGE PIER 1 SOUTH WIDENING SN 016-0437

(Looking West)

### <u>LEGEND</u>

Epoxy seal (Width > 0.06")

Hairline Crack not to be sealed (Width < 0.06")



Structural repair of concrete (Depth greater than 5 inches) Repair of concrete (Depth equal to or less than 5 inches) Finish Grade

SF = Square Foot LF = Linear Foot





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## 95th Terminal Improvement

15 West 95th Street (South Terminal) Chicago, IL 60628

IN CH	ARGE	S. KADERBEK
APPR	OVED BY	D.ZROKA
CHEC	KED BY	P.MAID
DESIG	ENED BY	L.SOMMER
DRAV	VN BY	T.SLEDGE
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| LOCATION IDENTIFIER: DR095

95TH ST. BRIDGE PIER 2 REPAIR DETAILS (SHEET 1 OF 2) SN 016-0437

95TH-S-147

Notes:

1. Waterproof coating shall be applied to all exposed surfaces after repairs are complete. See structural repair of concrete specification, section 03 74 00.

2. Areas of repair and lengths of sealant are approximate. Contractor shall verify areas and include a 10 percent increase in all quantities to allow for variations in plan areas against actual areas.

FILE NAME PLOT DATE

FILE NAME = 070\_DR095\_S-147A.dgn PLOT DATE = 8/31/2016 FFP SNN \*exp



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## 95th Terminal Improvement


15 West 95th Street (South Terminal) Chicago, IL 60628

IN CHA	ARGE	S. KADERBEK
APPR	OVED BY	D.ZROKA
CHEC	KED BY	P.MAID
DESIG	NED BY	L.SOMMER
DRAW	N BY	T.SLEDGE
PROJE	ECT NO.	2012-0021
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	2/9/17	ISSUED FOR CONSTRUCTION
	2/3/1/	1330LD FOR CONSTRUCTION
MARK	DATE	DESCRIPTION
		DESCRIPTION  FNITIFIER: DR005

LOCATION IDENTIFIER: DR095

95TH ST. BRIDGE
PIER 2 REPAIR DETAILS
(SHEET 2 OF 2)
SN 016-0437

95TH-S-147A

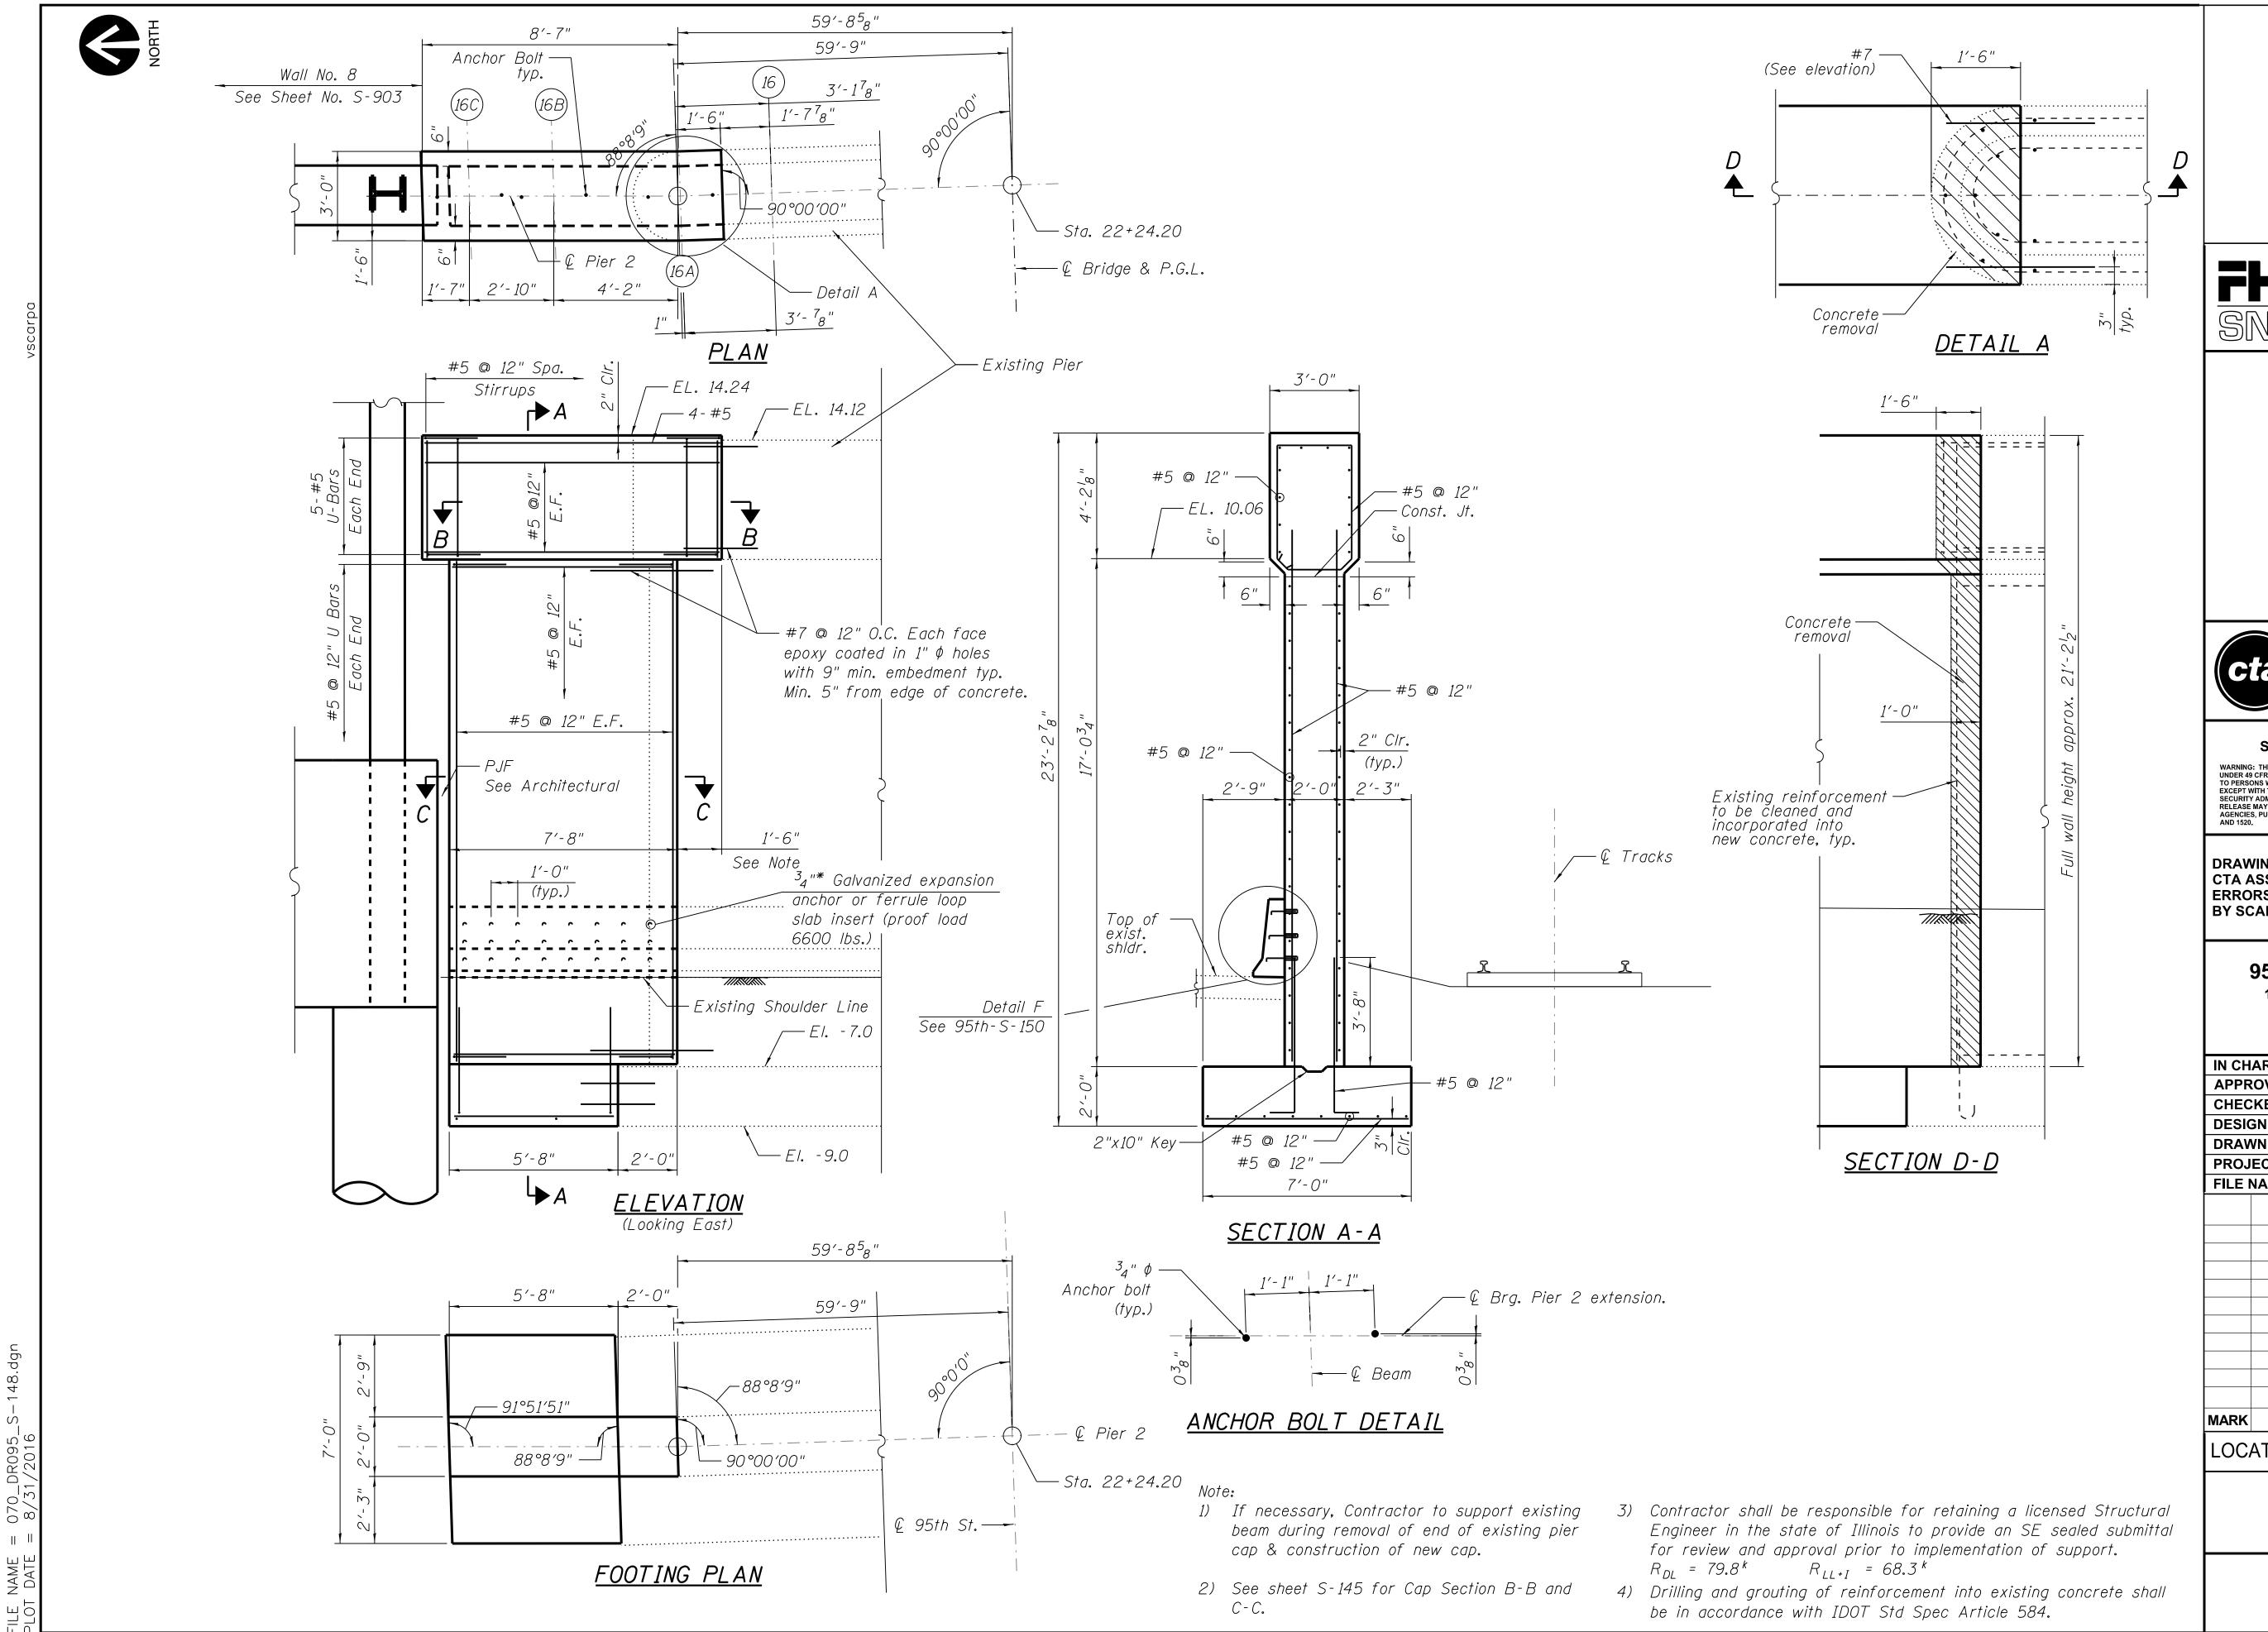



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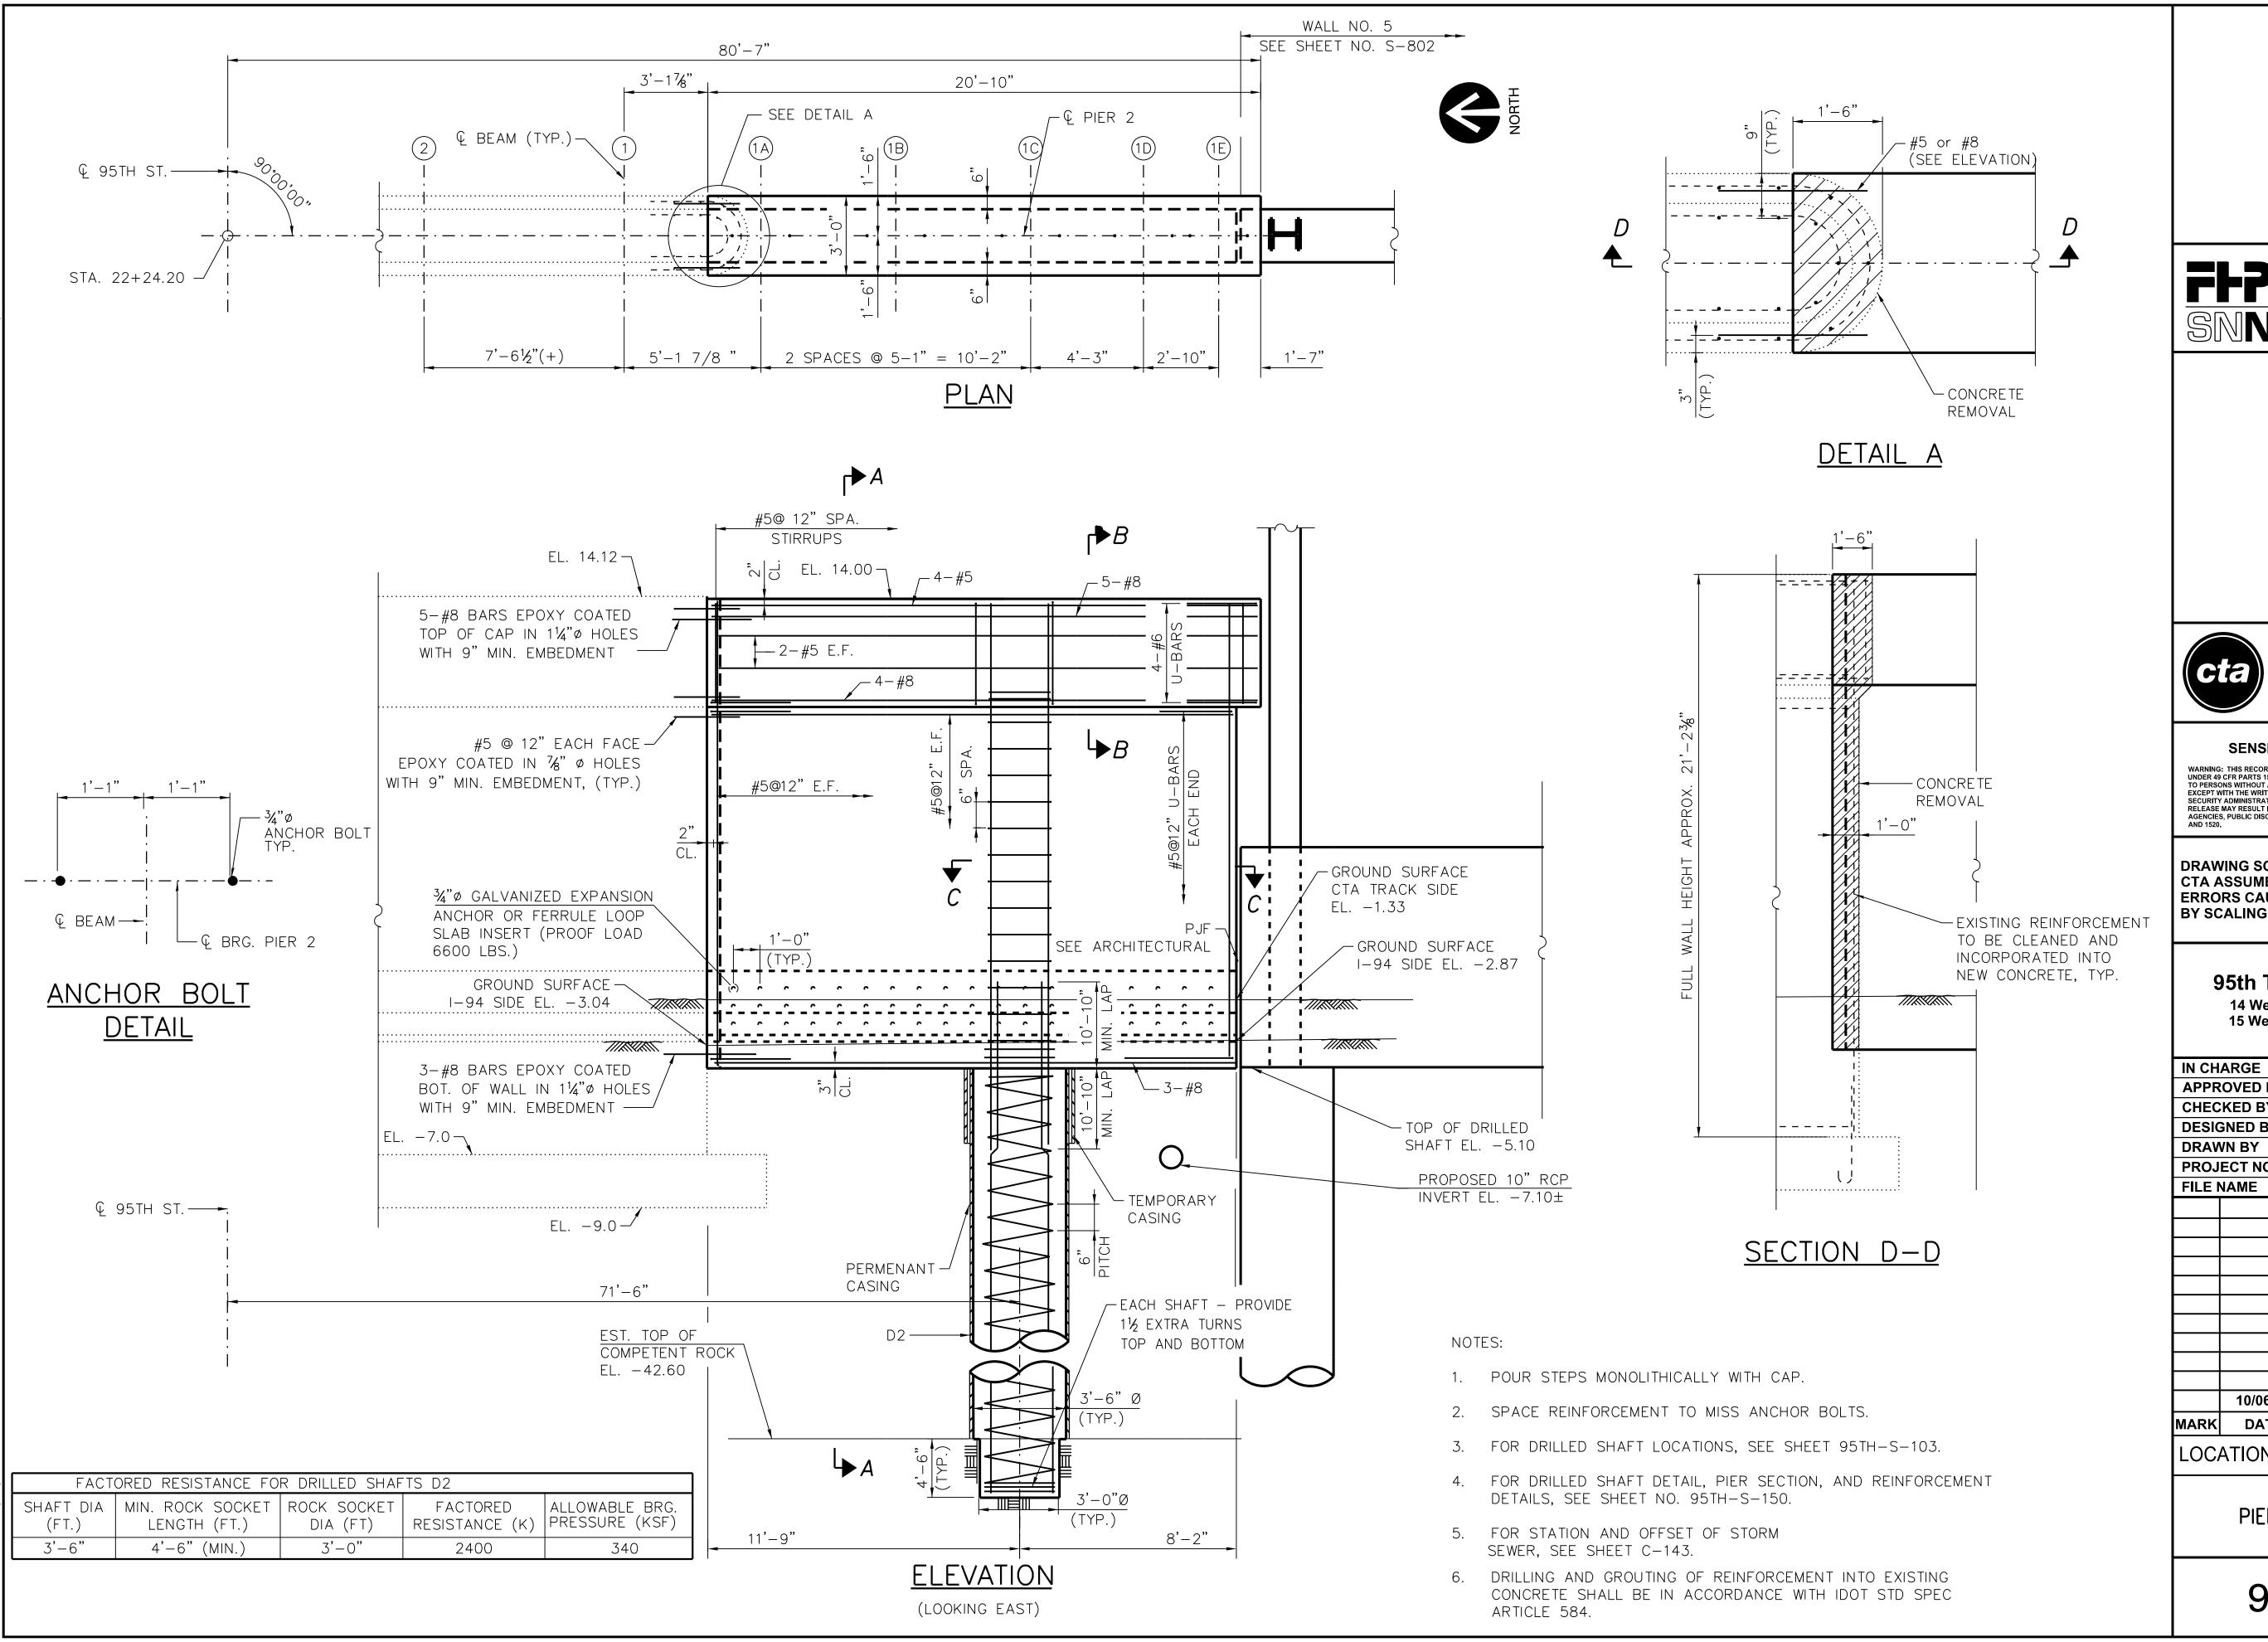
## 95th Terminal Improvement

15 West 95th Street (South Terminal) Chicago, IL 60628

IN CH	ARGE	S. KADERBEK	
APPR	OVED BY	D.ZROKA	
CHEC	KED BY	P.MAID	
DESIG	ENED BY	L.SOMMER	
DRAW	VN BY	T.SLEDGE	
PROJ	ECT NO.	2012-0021	
FILE N	NAME	File Name	
	2/9/17	ISSUED FOR CONSTRUCTION	
MARK	DATE	DESCRIPTION	
LOC	LOCATION IDENTIFIER: DR095		

LOCATION IDENTIFIER.

95TH ST. BRIDGE PIER 2 NORTH WIDENING SN 016-0437







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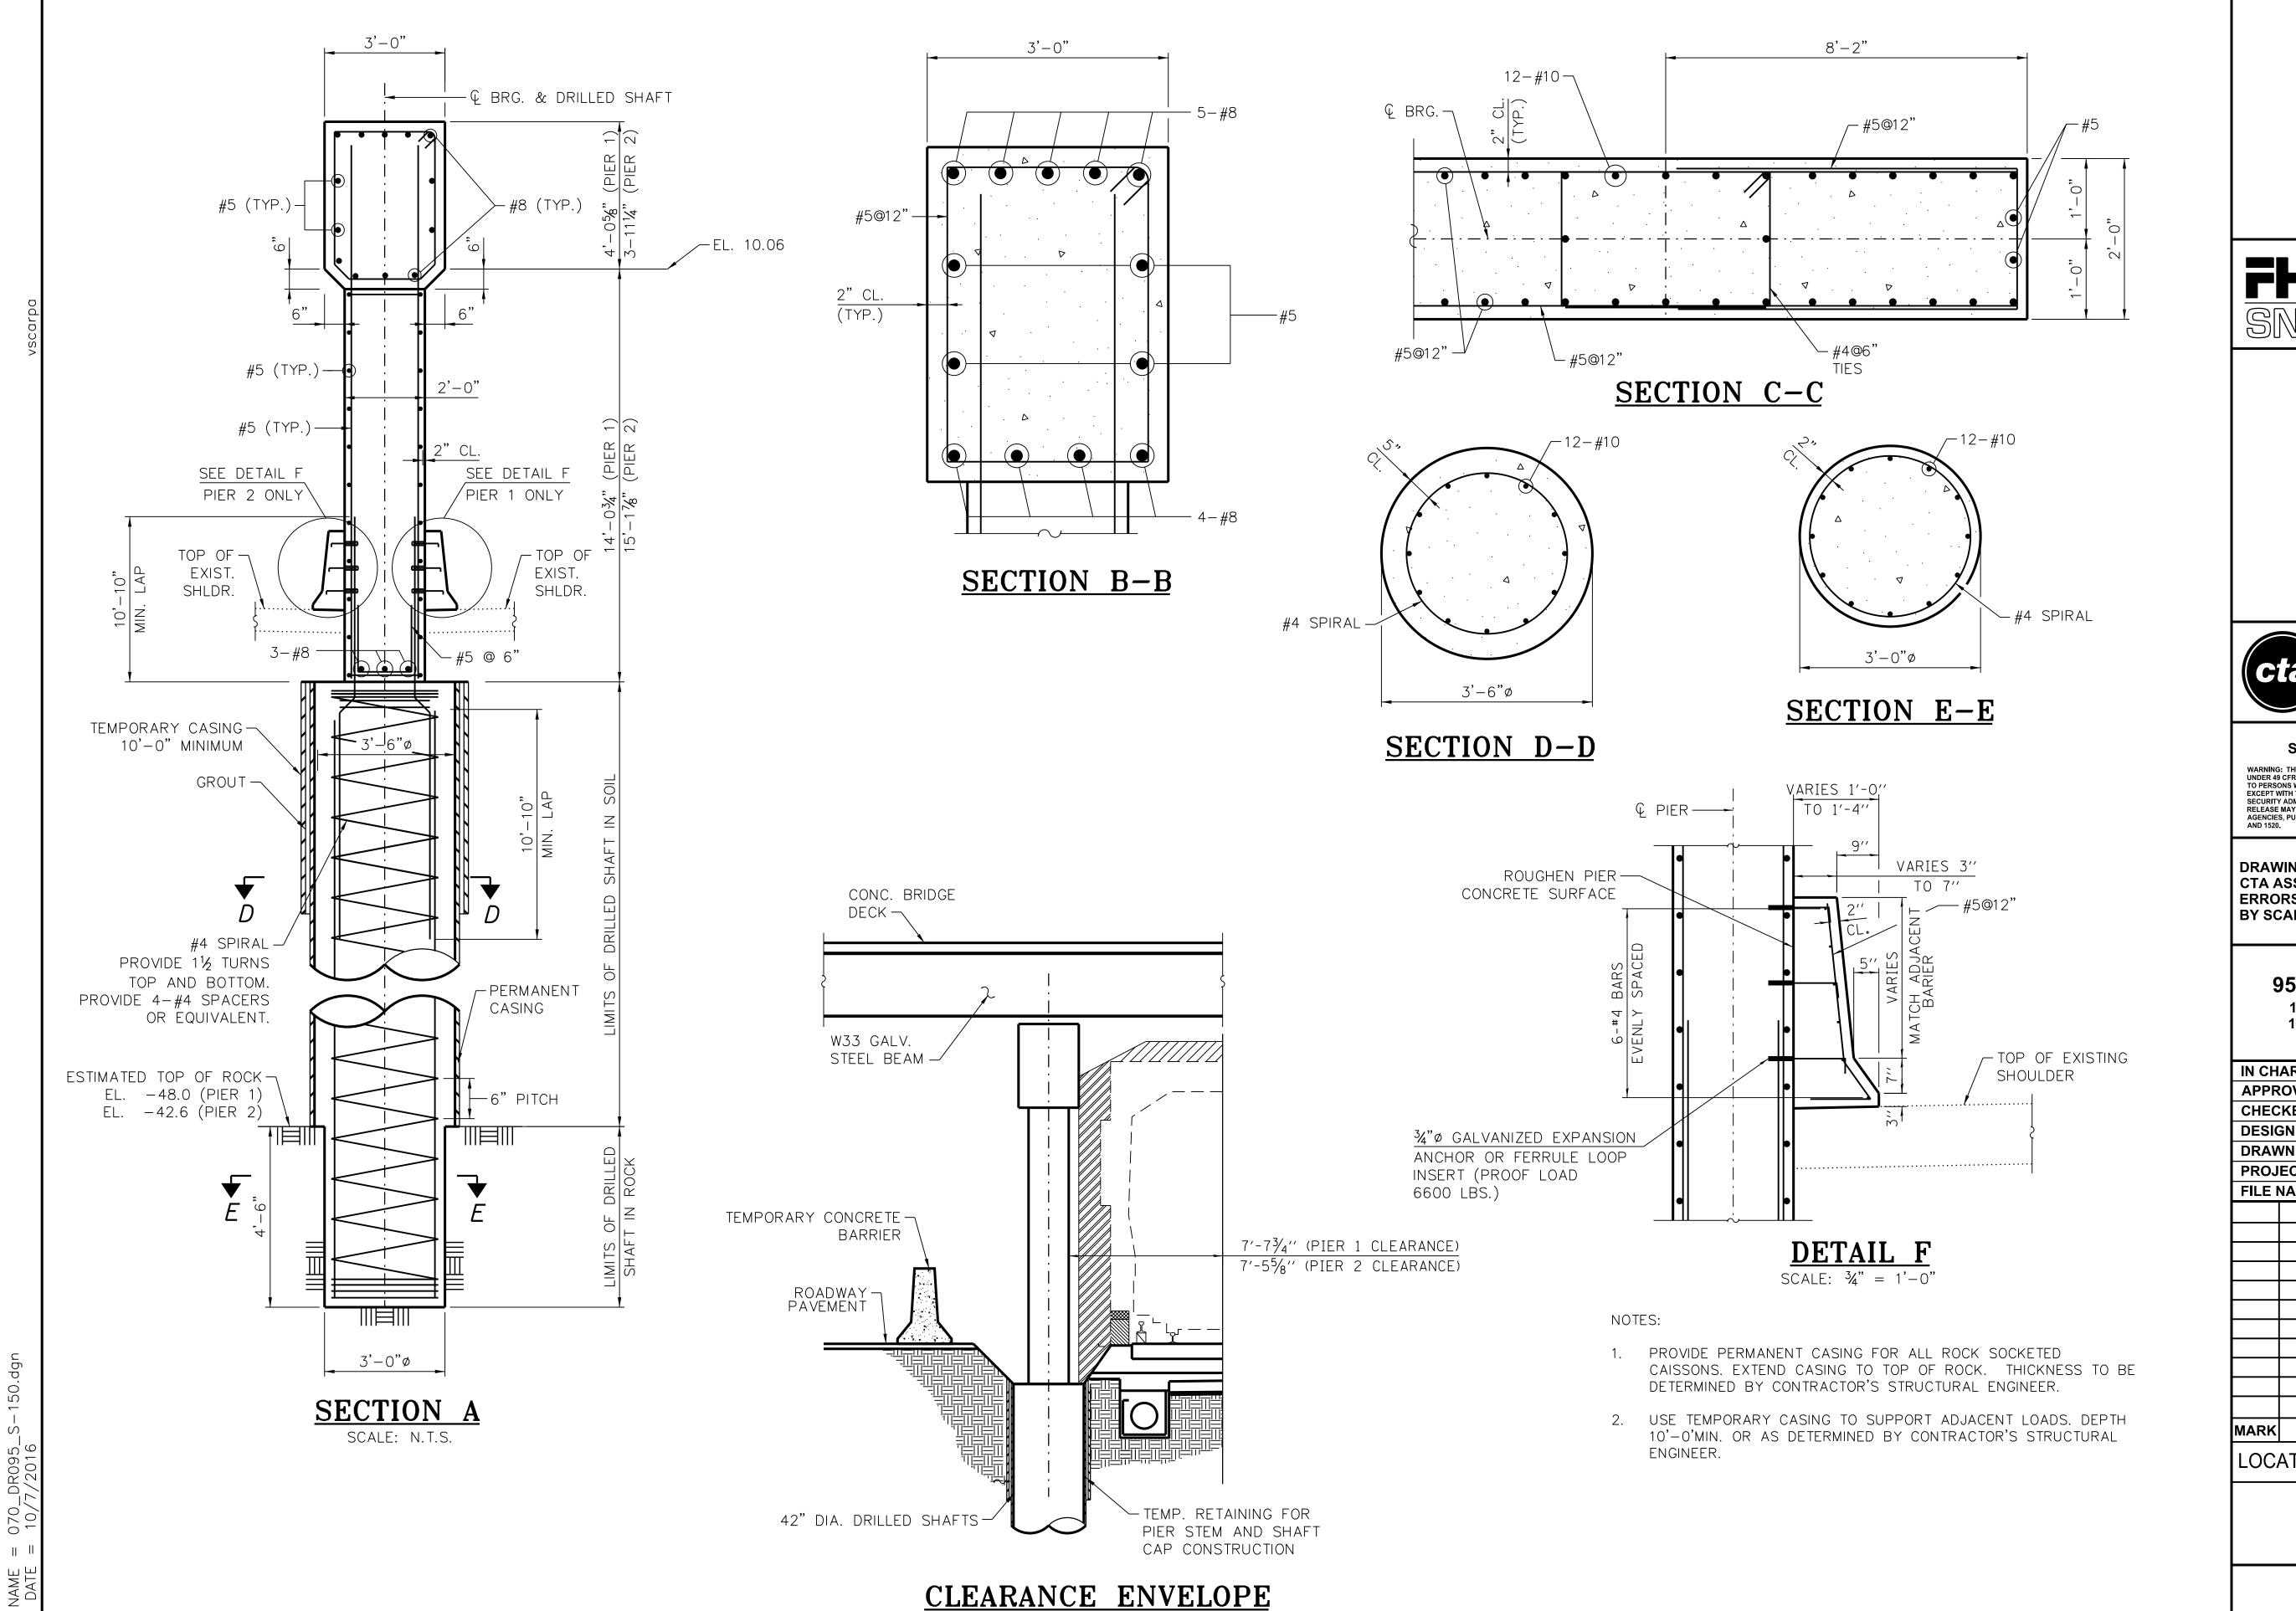
### **95th Terminal Improvement**

14 West 95th Street (North Terminal) 15 West 95th Street (South Terminal) Chicago, IL 60628

IN CH	ARGE	S. KADERBEK	
APPROVED BY		D.ZROKA	
CHEC	KED BY	P.MAID	
DESIG	SNED BY	L.SOMMER	
DRAV	VN BY	T.SLEDGE	
PROJ	ECT NO.	2012-0021	
FILE	NAME	File Name	
	10/06/16	ISSUED FOR CONSTRUCTION	
MARK	DATE	DESCRIPTION	

LOCATION IDENTIFIER: DR095

95TH ST. BRIDGE
PIER 2 SOUTH WIDENING
SN 016-0437



FFP SIN SEXP.



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### 95th Terminal Improvement

14 West 95th Street (North Terminal) 15 West 95th Street (South Terminal) Chicago, IL 60628


IN CH	ARGE	S. KADERBEK
APPR	OVED BY	D.ZROKA
CHEC	KED BY	P.MAID
DESIC	GNED BY	L.SOMMER
DRAV	VN BY	T.SLEDGE
PROJ	ECT NO.	2012-0021
FILE N	NAME	File Name
	_	
	10/06/16	ISSUED FOR CONSTRUCTION
MARK	DATE	DESCRIPTION

LOCATION IDENTIFIER: DR095


95TH ST. BRIDGE
PIER 1 AND 2 SOUTH
WIDENING DETAILS
SN 016-0437

STRUCTURAL CONCRETE REPAIR - LESS THAN 5 INCHES

ELEVATION VIEW

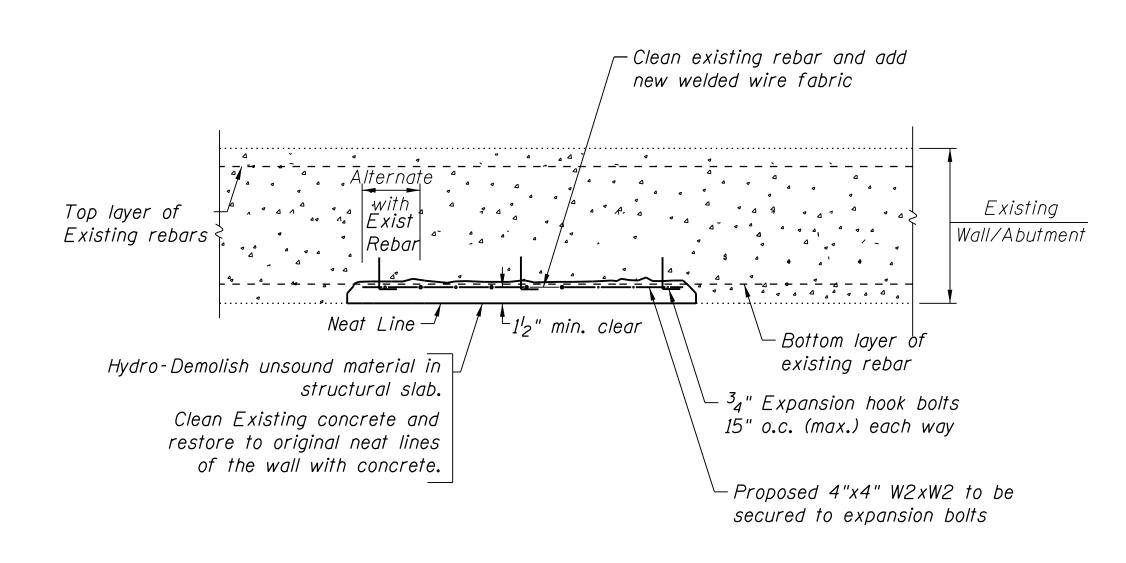


STRUCTURAL CONCRETE REPAIR - LESS THAN 5 INCHES

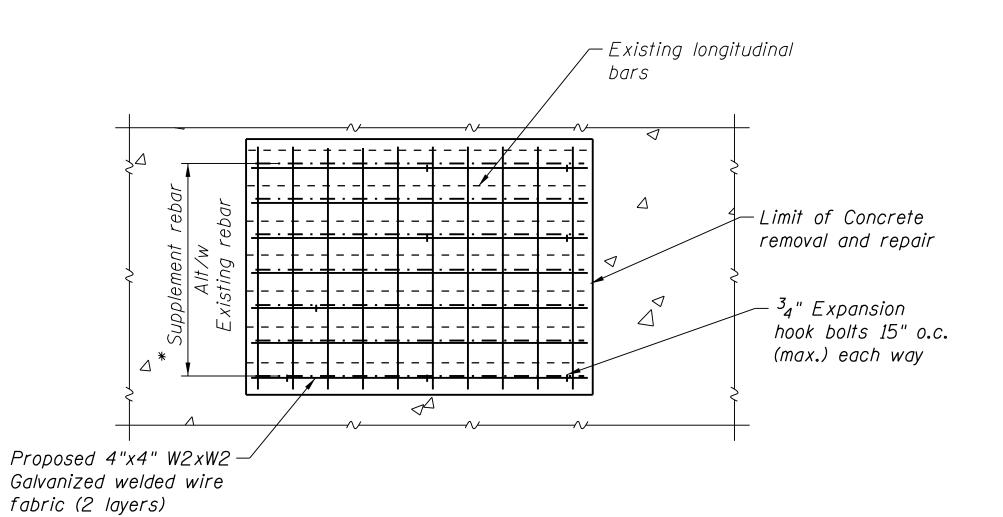

# STRUCTURAL CONCRETE REPAIR - GREATER THAN 5 INCHES ELEVATION VIEW

Note: Saw cut to straight lines. Saw cuts  $^{l}_{2}$ " deep or as required to avoid damage to reinforcing bars. If existing rebar is deteriorated more than 25% of cross sectional area, provide bar of equal size and lap 32 bar diameters beyond area of deterioration.

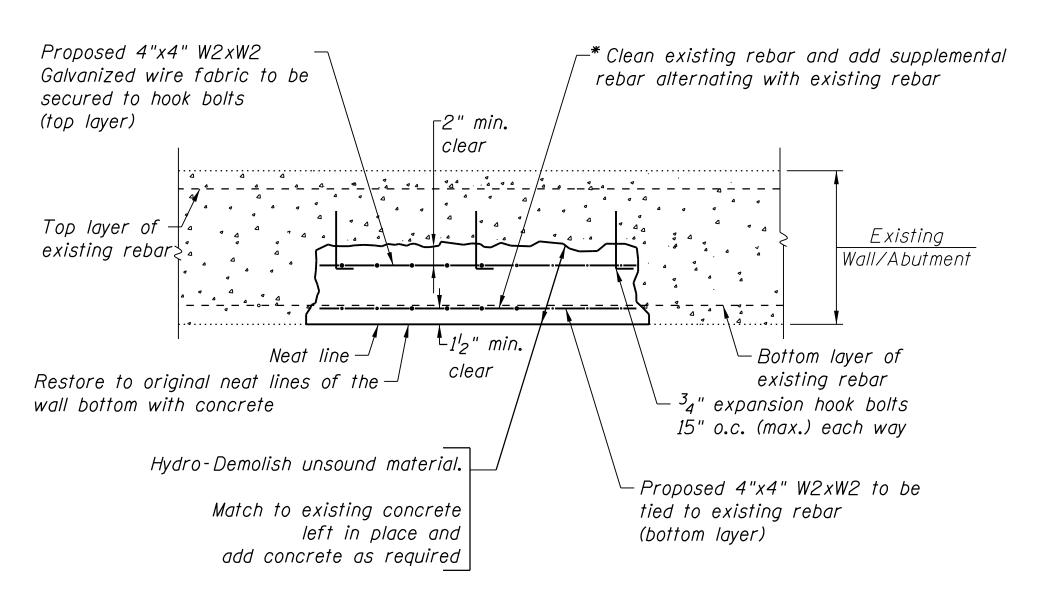

STRUCTURAL CONCRETE REPAIR - GREATER THAN 5 INCHES





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## 95th Terminal Improvement 15 West 95th Street (South Terminal)


15 West 95th Street (South Terminal) Chicago, IL 60628

IN CH	ARGE	S. KADERBEK
APPR	OVED BY	D.ZROKA
CHEC	KED BY	P.MAID
DESIG	ENED BY	L.SOMMER
DRAW	VN BY	T.SLEDGE
PROJ	ECT NO.	2012-0021
FILE N	NAME	File Name
	2/2/4	
	2/9/17	ISSUED FOR CONSTRUCTION
MARK	DATE	DESCRIPTION

LOCATION IDENTIFIER: DR095

95TH ST. BRIDGE STRUCTURAL REPAIR DETAILS SN 016-0437

95TH-S-150A

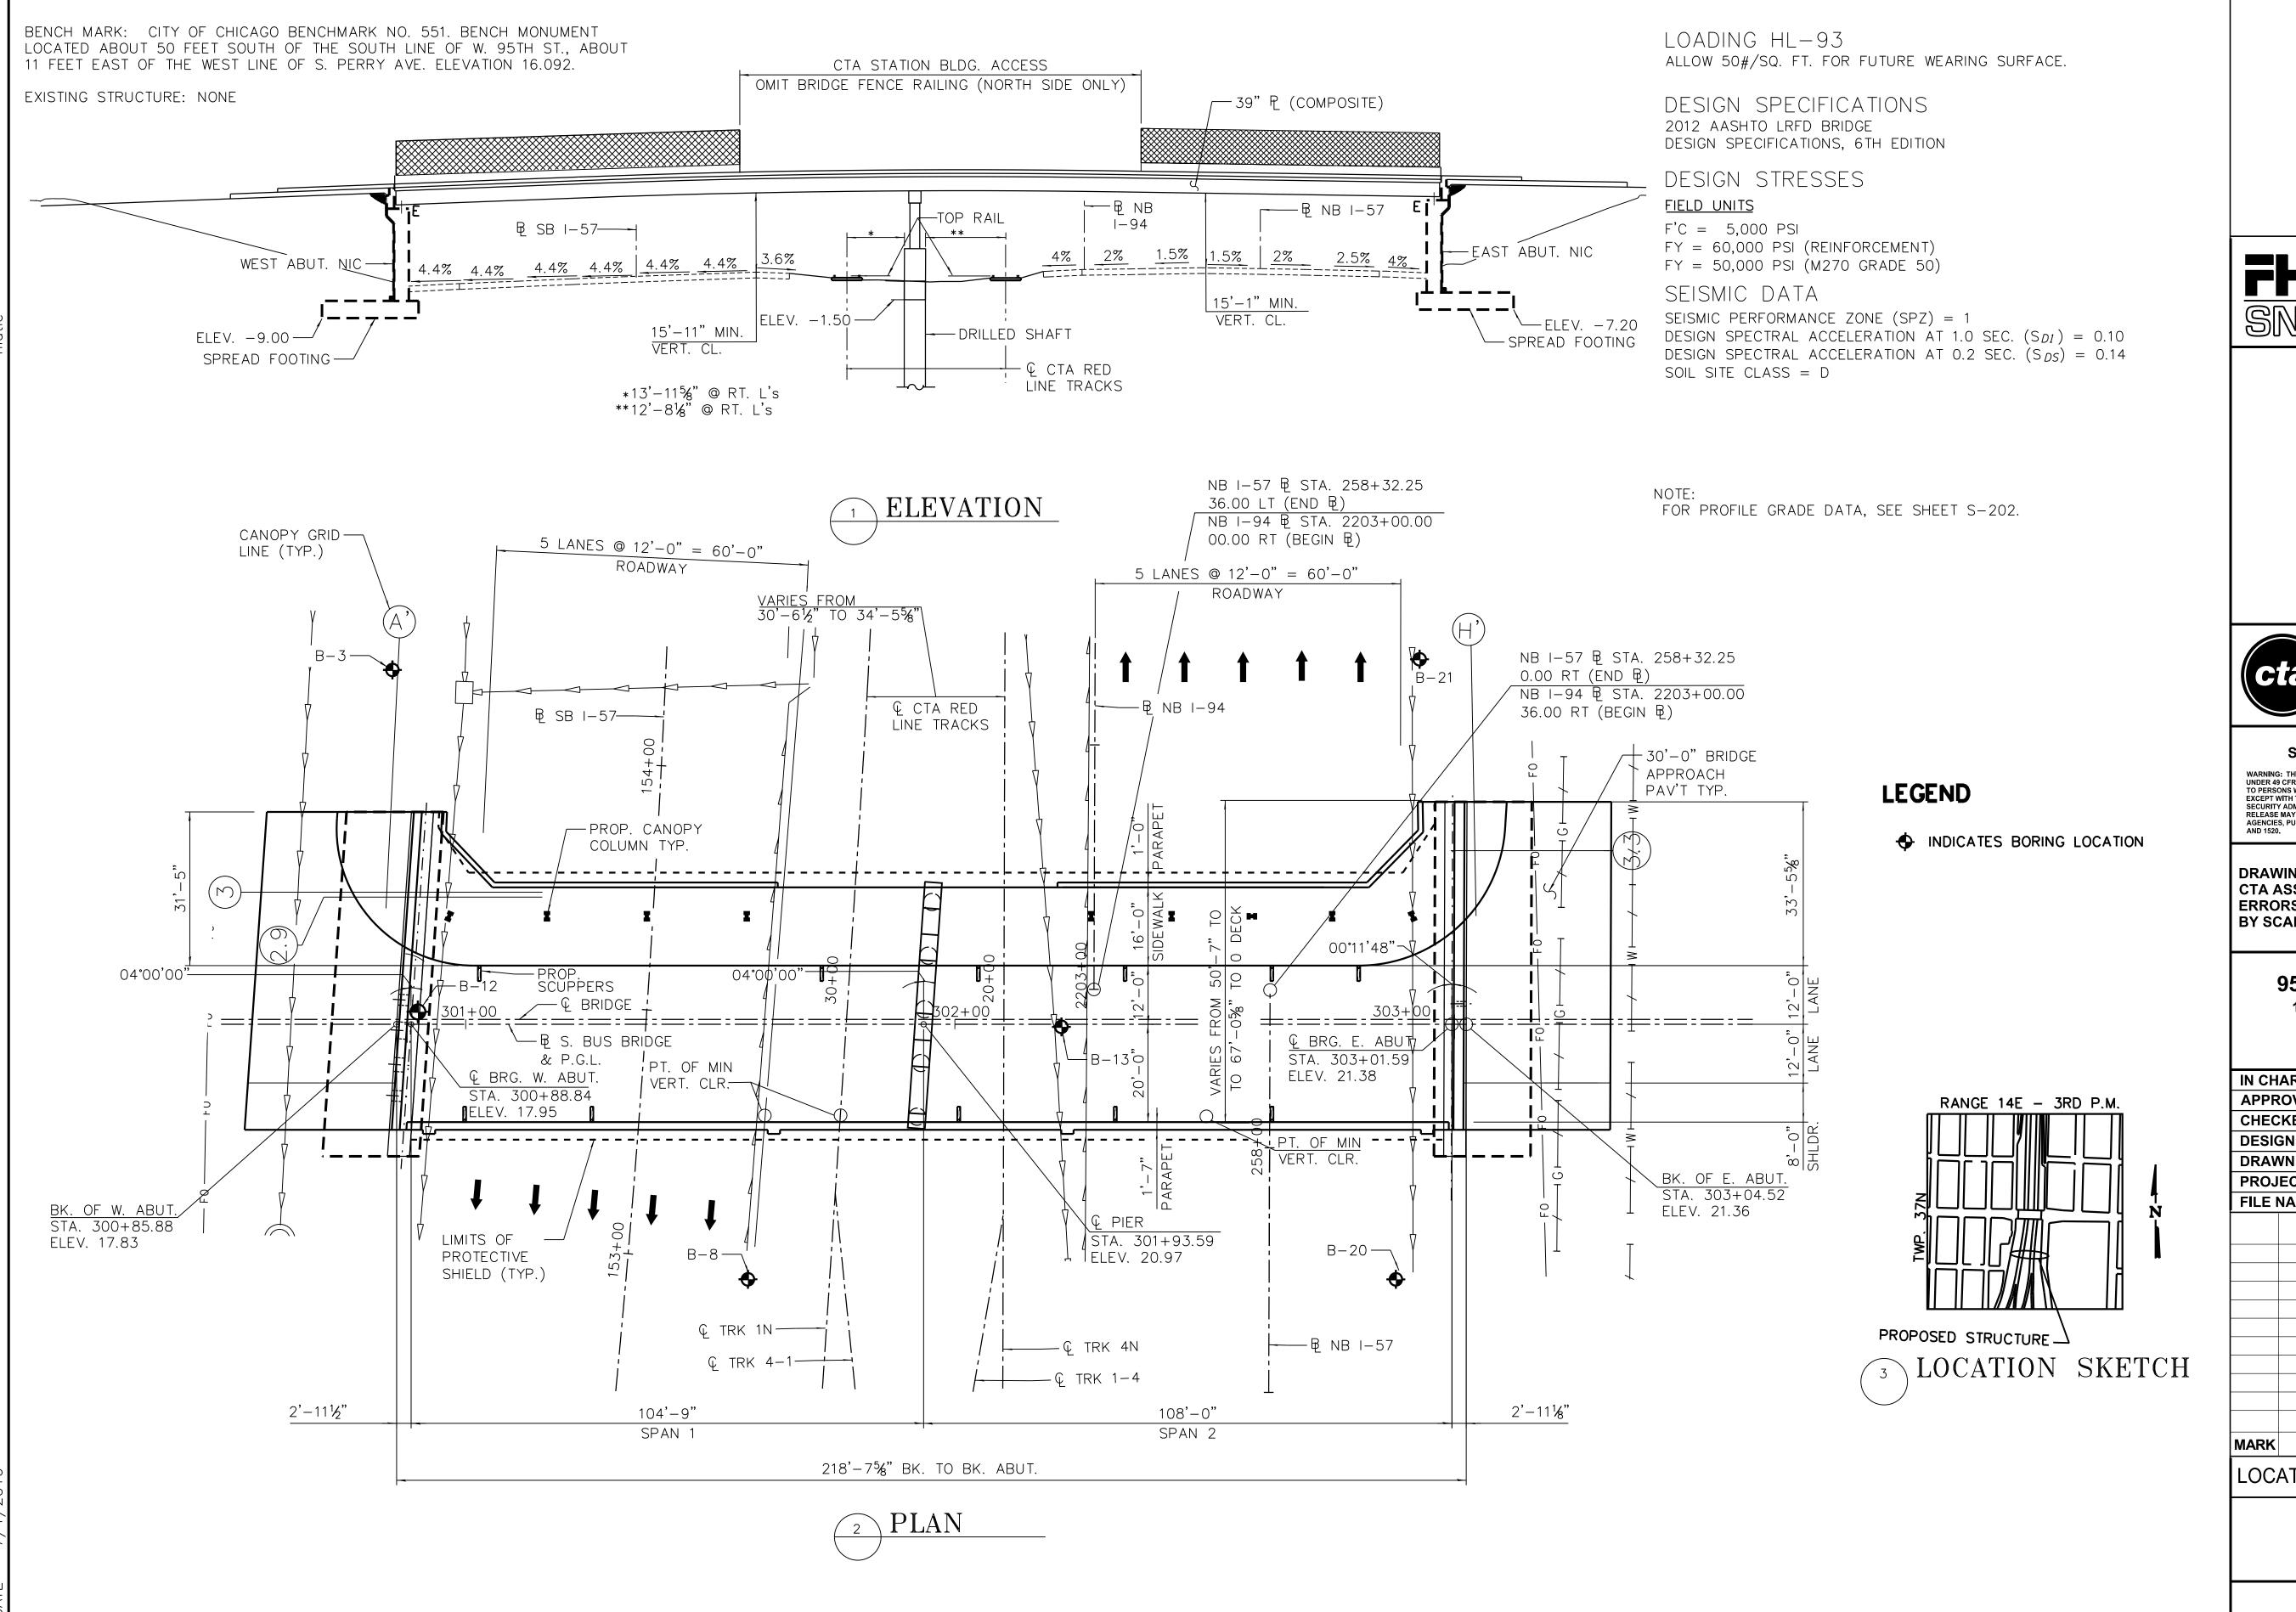





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## 95th Terminal Improvement 15 West 95th Street (South Terminal)


15 West 95th Street (South Terminal) Chicago, IL 60628


IN CH	ARGE	S. KADERBEK
APPR	OVED BY	D.ZROKA
CHEC	KED BY	P.MAID
DESIG	GNED BY	L.SOMMER
DRAV	VN BY	T.SLEDGE
PROJ	ECT NO.	2012-0021
FILE I	NAME	File Name
	2/9/17	ISSUED FOR CONSTRUCTION
MADIC	_	
MARK	DATE	DESCRIPTION
$I \cap C$		NTIFIED: DDAGE


LOCATION IDENTIFIER: **DR095** 

SOUTH BUS BRIDGE GENERAL PLAN AND ELEVATION

SBB-S-201

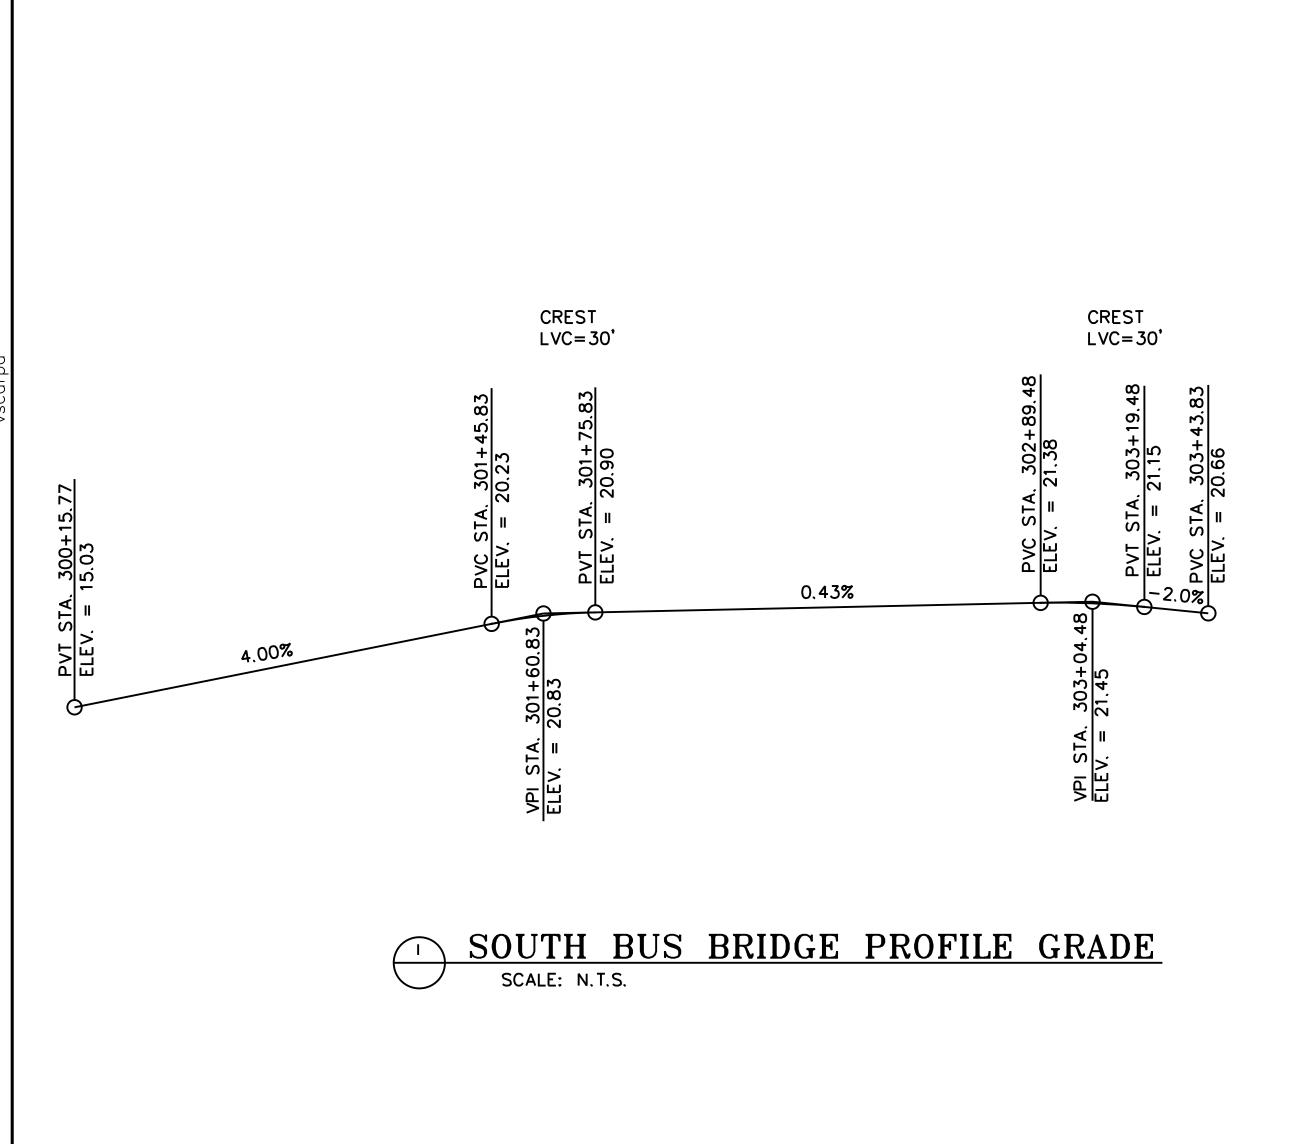


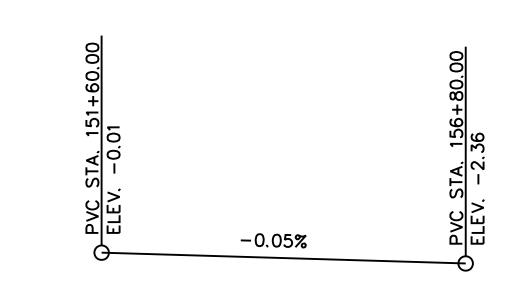


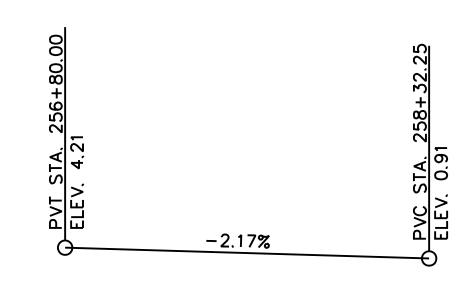

2 I-57 SB EX. PROFILE GRADE
SCALE: N.T.S.

3 I-57 NB EX. PROFILE GRADE
SCALE: N.T.S.

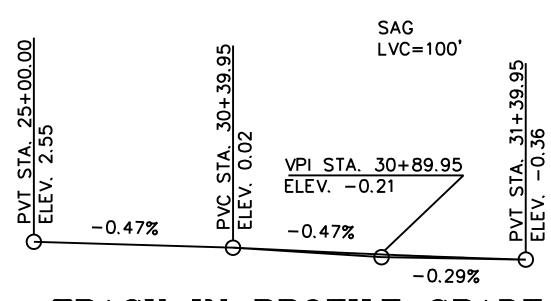

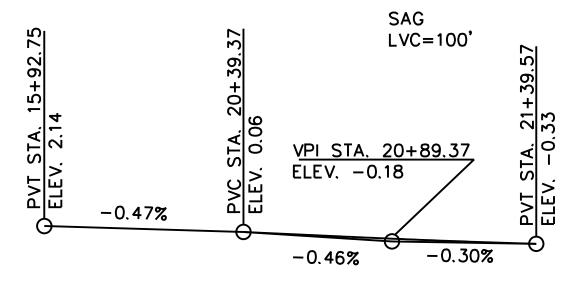

TRACK IN PROFILE GRADE

SCALE: N.T.S.

5 TRACK IN PROFILE GRADE
SCALE: N.T.S.

CHICAGO TRANSIT
AUTHORITY
ENGINEERING

SENSITIVE SECURITY INFORMATION

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95th Terminal Improvement
15 West 95th Street (South Terminal)
Chicago, IL 60628

IN CHARGE S. KADERBEK
APPROVED BY D.ZROKA
CHECKED BY P.MAID

DESIGNED BY
DRAWN BY
T.SLEDGE
PROJECT NO. 2012-0021
FILE NAME
File Name

MARK DATE DESCRIPTION

LOCATION IDENTIFIER: DR095


2/9/17 ISSUED FOR CONSTRUCTION

SOUTH BUS BRIDGE GENERAL DATA

SBB-S-202

NOTE:

1. EXISTING PROFILES ARE REPRESENTATIVE OF A BEST FIT FROM FIELD SURVEY BY SANCHEZ & ASSOCIATES LAND SURVEYING ON 05-21-2013. EXISTING PROFILE GRADE IS TO REMAIN UNCHANGED.

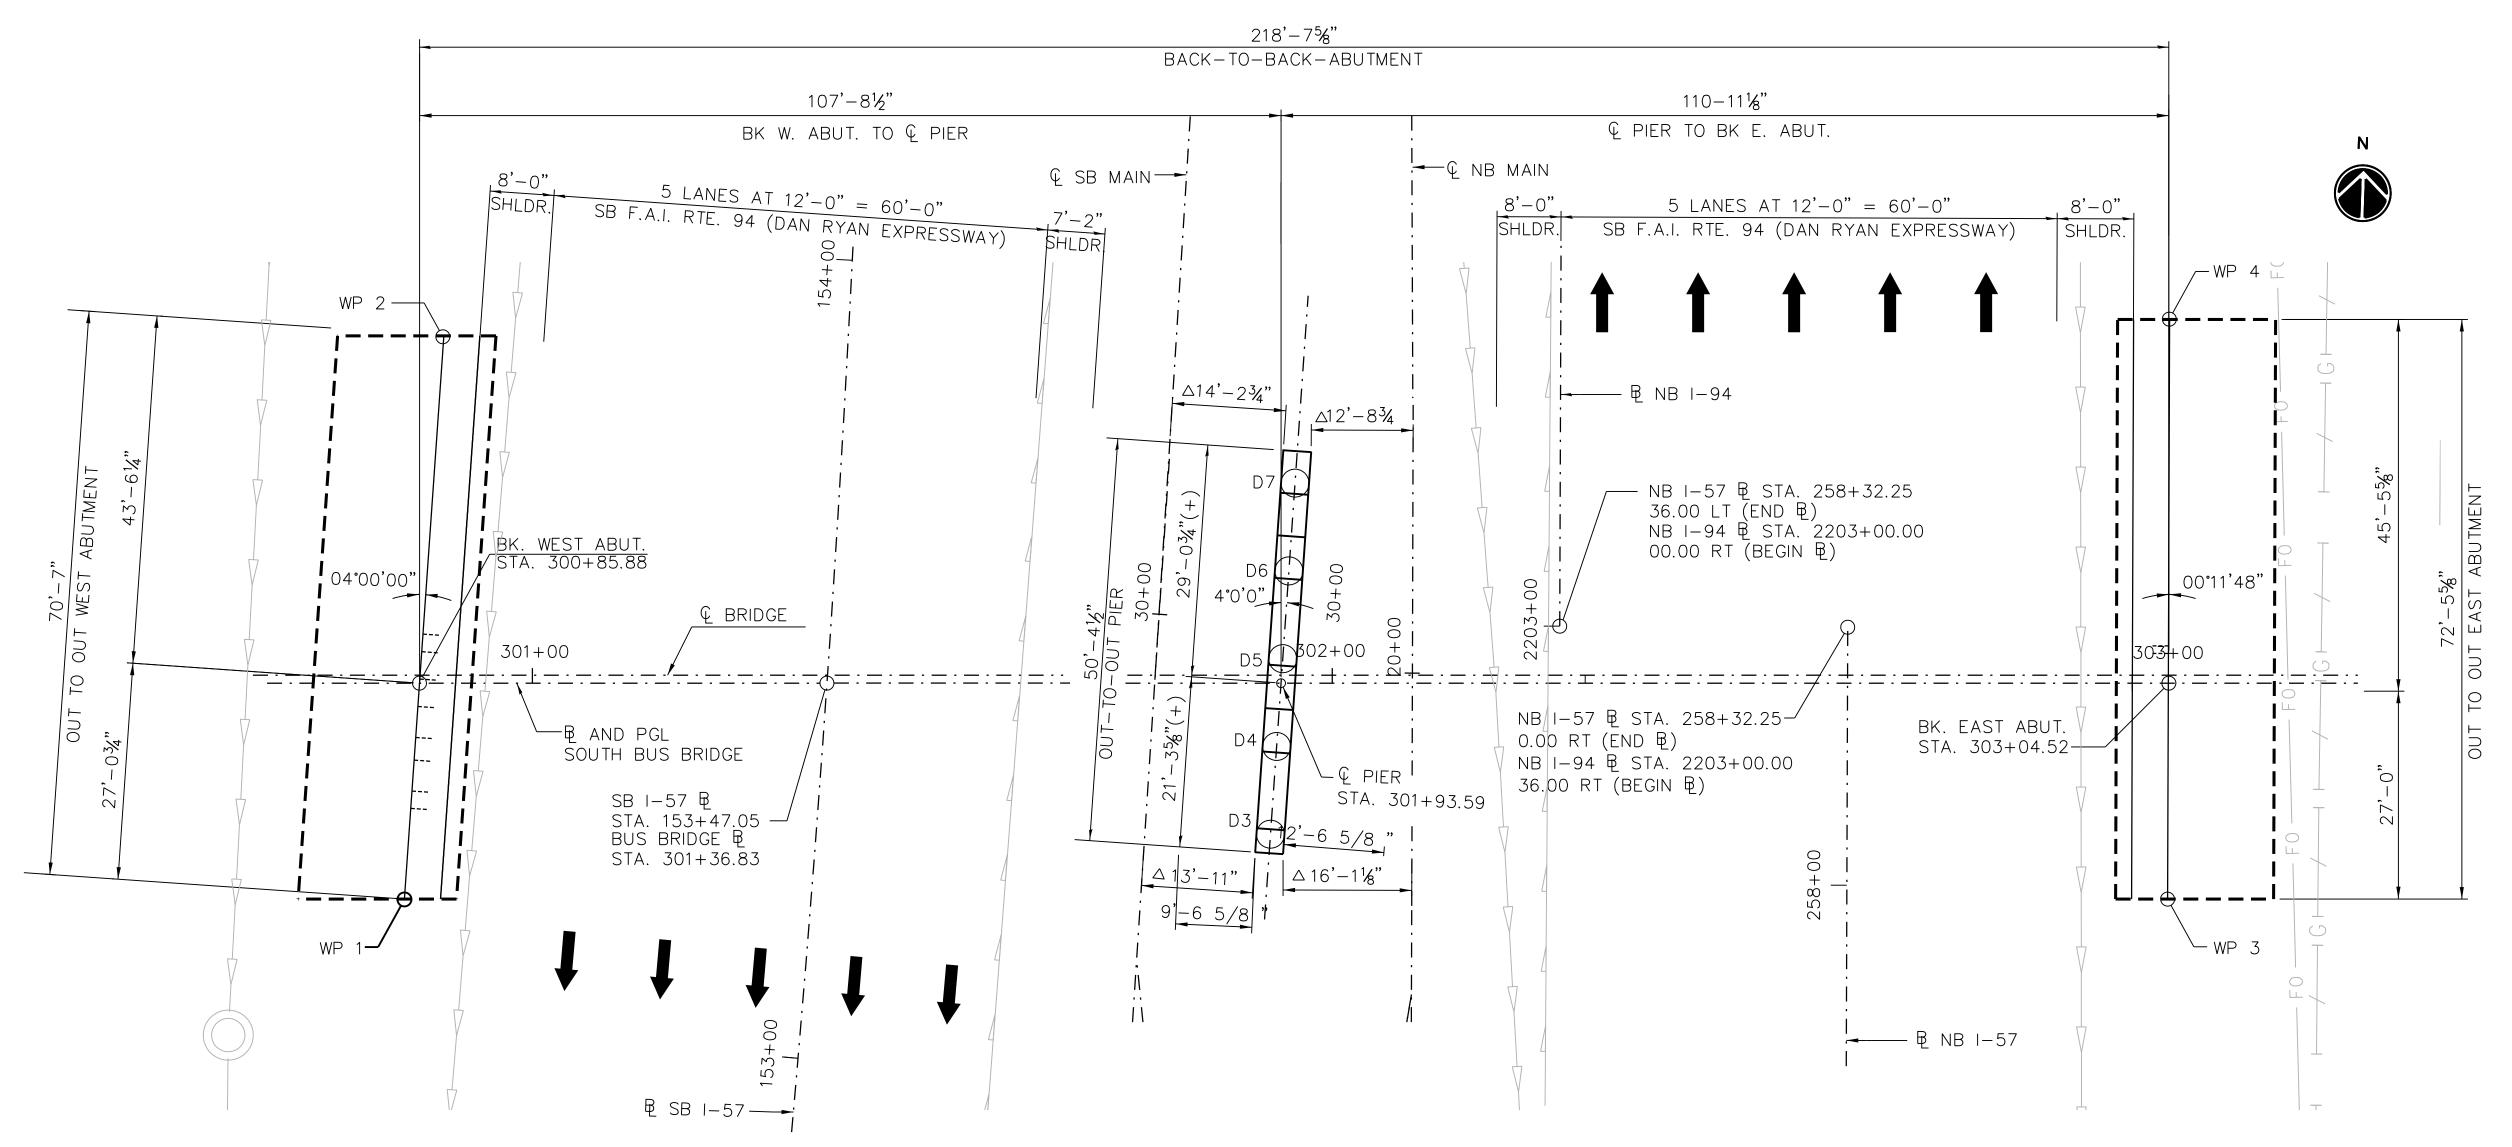

SUBSTRUCTURE LAYOUT
SCALE: N.T.S.

 $\triangle$  FOR CLEARANCES DURING CONSTRUCTION, SEE TABLE

NOTES:

1. FOR PIER DETAILS SEE PIER SHEETS SBB-S-233 AND SBB-S-235.

 WP NO.
 STATION
 OFFSET
 BASELINE

 1
 300+84.00
 27
 SOUTH BUS BRIDGE

 2
 300+88.92
 -43.42
 SOUTH BUS BRIDGE

 3
 303+04.43
 27
 SOUTH BUS BRIDGE

 4
 303+04.67
 -45.47
 SOUTH BUS BRIDGE

S-203.DGN

070\_DR095\_S



DRILLED SHAFT	STATION	OFFSET	BASELINE
D3	301+92.27	18.89 RT.	SOUTH BUS BRIDGE
D4	301+93.04	7.91 RT.	SOUTH BUS BRIDGE
D5	301+93.80	3.06 LT.	SOUTH BUS BRIDGE
D6	301+94.57	14.03 LT.	SOUTH BUS BRIDGE
D7	301+95.34	25.01 LT	SOUTH BUS BRIDGE

# TEMPORARY CLEARANCE DURING CONSTRUCTION

NORTHWEST PIER CORNER	10'-101%"
NORTHEAST PIER CORNER	11'-9¾"
SOUTHWEST PIER CORNER	9'-6%"
SOUTHEAST PIER CORNER	12'-6%"
DISTANCES ARE TO CENTERLINE	OF TRACK





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### 95th Terminal Improvement

14 West 95th Street (North Terminal) 15 West 95th Street (South Terminal) Chicago, IL 60628


IN CHARGE		S. KADERBEK
APPROVED BY		D.ZROKA
CHEC	KED BY	P.MAID
DESIG	ENED BY	L.SOMMER
DRAW	VN BY	T.SLEDGE
PROJ	ECT NO.	2012-0021
FILE N	NAME	File Name
_/1\	10/13/16	REVISIONS 1
	10/06/16	ISSUED FOR CONSTRUCTION
MARK	DATE	DESCRIPTION

LOCATION IDENTIFIER: DR095

SOUTH BUS BRIDGE FOOTING LAYOUT

SBB-S-203

**PLAN** 

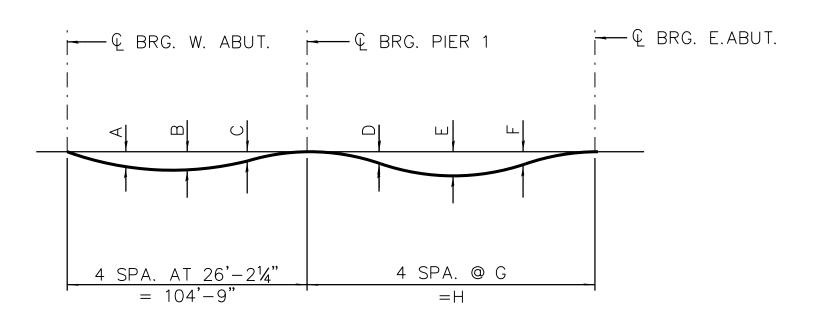


### DEAD LOAD DEFLECTION DIAGRAM


(INCLUDES WEIGHT OF CONCRETE, EXCLUDING BEAMS).

NOTE: THE ABOVE DEFLECTIONS ARE NOT FOR USE IN THE FIELD IF THE ENGINEER IS WORKING FROM THE "THEORETICAL GRADE ELEVATIONS ADJUSTED FOR DEAD LOAD DEFLECTION."

		DEAD LOAD DEFLECTIONS (INCHES)						
GIRDER NUMBER		SPAN 1		(	SPAN 2			
	Α	В	O	О	E	F	G	Н
1	11/4	13/8	5%	3/4	15⁄8	1½	26'-6½"	106'-21/6"
2	13/4	2	3/4	7/8	21/4	21/8	26'-7%"	106'-47/6"
3	13/4	2	3/4	7/8	21/4	21/8	26'-8¾ <sub>6</sub> "	106'-8¾"
4	11/8	11/4	1/2	3/4	15⁄8	13⁄ <sub>8</sub>	26'-9¼"	107'-11/6"
5	11/8	11/4	1/2	3/4	15⁄8	1¾	26'-10%"	
6	11/8	11/4	1/2	3/4	1 %	1¾	26'-117 <sub>6</sub> "	
7	11/8	11/4	1/2	3/4	15⁄8	1¾	27'-01/2"	108'-21/6"
8	11/8	11/4	1/2	3/4	15⁄8	1¾	27'-1 <b>%</b> "	108'-6%"
9	11/8	11/4	1/2	3/4	1 <del>%</del>	1¾	27'-2 <sup>1</sup> 1/ <sub>6</sub> "	
10	11/8	1 1/4	1/2	3/4	15⁄8	1¾	27'-3¾"	109'-3"

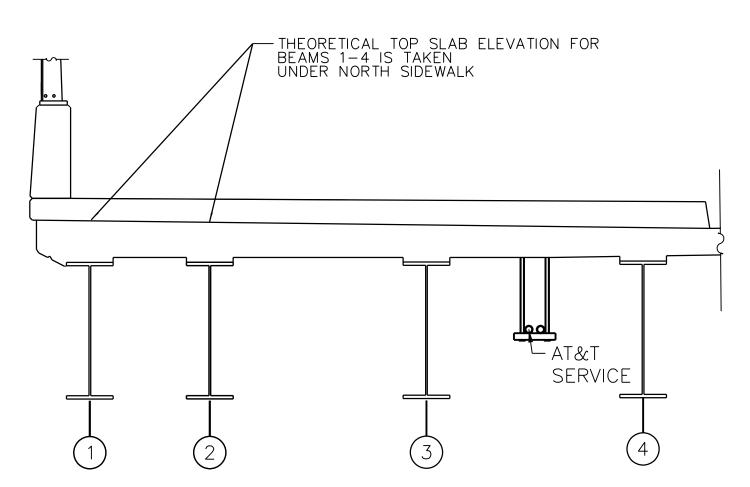

### THEORETICAL TOP OF SLAB ELEVATIONS FOR BEAMS UNDER NORTH SIDEWALK

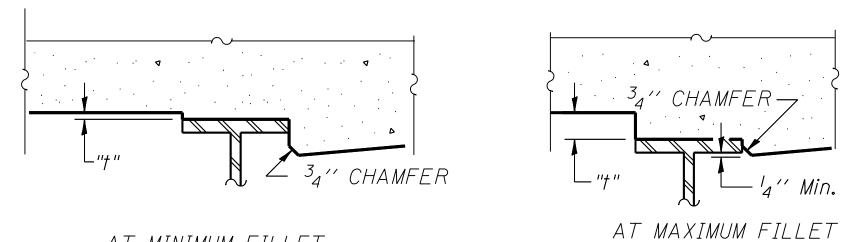

AT MINIMUM FILLET

FLANGE OF BEAMS.

TO DETERMINE "t": AFTER ALL STRUCTURAL STEEL HAS BEEN ERECTED, ELEVATIONS OF THE TOP FLANGES OF THE BEAMS SHALL BE TAKEN AT INTERVALS SHOWN ON SHEETS SBB S-205 & S-206. THESE ELEVATIONS SUBTRACTED FROM THE INDICATED "THEORETICAL GRADE ELEVATIONS ADJUSTED FOR DEAD LOAD DEFLECTION", MINUS SLAB THICKNESS, EQUALS THE FILLET HEIGHTS "t" ABOVE TOP







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## 95th Terminal Improvement

15 West 95th Street (South Terminal) Chicago, IL 60628

IN CHA	ARGE	S. KADERBEK
APPR	OVED BY	D.ZROKA
CHEC	KED BY	P.MAID
DESIG	NED BY	L.SOMMER
DRAW	N BY	T.SLEDGE
PROJE	ECT NO.	2012-0021
FILE N	IAME	File Name
	2/9/17	ISSUED FOR CONSTRUCTION
	2/3/1/	1330LD FOR CONSTRUCTION
MARK	DATE	DESCRIPTION
		DESCRIPTION  FNITIFIER: DR005

| LOCATION IDENTIFIER: DR095

SOUTH BUS BRIDGE TOP OF SLAB ELEVATIONS (SHEET 1 OF 4)

SBB-S-204

<u>GIRDER 1</u>

Location	Station	Offset	Theoretical Grade Elevations	Theoretical Grade Elevations Adjusted For Dead Load Deflection
Bk W Abut	300+87 <b>.</b> 81	27.50	17.73	17.73
CL. W. Exp. Jt.	300+89.90	27.50	17.81	17.81
CL Brg W Abut	300+90.76	<i>27.</i> 50	17.85	<i>17.85</i>
Α	<i>301+00.76</i>	<i>27.50</i>	<i>18.25</i>	<i>18.30</i>
В	<i>301+10.76</i>	27.50	<i>18.</i> 65	18.74
С	<i>301+20.76</i>	27.50	<i>19.05</i>	19.17
D	<i>301+30.76</i>	27.50	<i>19.45</i>	19.58
Ε	<i>301+40.76</i>	27.50	<i>19.85</i>	19.98
F	<i>301+50.76</i>	27.50	20.23	20.34
G	301+60.76	27.50	20.51	20.59
Н	<i>301+70.76</i>	27.50	20.68	20.72
I	<i>301+80.76</i>	27.50	20.74	20.76
J	<i>301+90.76</i>	27.50	20.78	20.78
Pier 1	<i>301+95.51</i>	27.50	20.80	20.80
К	<i>302+03</i> <b>.</b> 68	27.50	20.83	20.85
L	<i>302+13.68</i>	27.50	20.88	20.92
М	<i>302+23</i> .68	27.50	20.92	20.99
N	<i>302+33</i> .68	27.50	<i>20.</i> 96	<i>21</i> .07
0	<i>302+43.68</i>	27.50	21.01	21.14
P	<i>302+53.68</i>	27.50	21.05	21.20
Q	302+63.68	27.50	21.09	21.24
R	<i>302+73.68</i>	27.50	21.14	21 <b>.</b> 26
S	<i>302+83.68</i>	<i>27.50</i>	21 <b>.</b> 18	21.27
Τ	<i>302+93.68</i>	27.50	21.22	21 <b>.</b> 25
CL Brg E Abut	303+01 <b>.</b> 68	<i>27</i> .50	21.20	21.20
CL. E. Exp. Jt.	<i>303+02.53</i>	27.50	21 <b>.</b> 19	21.19
Bk E Abut	303+04.61	27.50	21.18	21.18

## GIRDER 2

Location	Station	Offset	Theoretical Grade Elevations	Theoretical Grade Elevations Adjusted For Dead Load Deflection
Bk W Abut	300+87.60	24.50	17.72	17.72
CL. W. Exp. Jt.	300+89.69	24.50	17.81	17.81
CL Brg W Abut	<i>300+90.</i> 55	<i>24.</i> 50	17.84	17.84
Α	<i>301+00</i> <b>.</b> 55	<i>24.</i> 50	<i>18.24</i>	<i>18.31</i>
В	<i>301+10</i> <b>.</b> 55	24.50	<i>18.64</i>	<i>18.77</i>
С	<i>301+20</i> <b>.</b> 55	24.50	19.04	19.20
D	<i>301+30.55</i>	24.50	19.44	<i>1</i> 9 <b>.</b> 62
E	<i>301+40</i> .55	24.50	<i>19.84</i>	20.01
F	<i>301+50</i> <b>.</b> 55	<i>24</i> .50	20.23	20.37
G	<i>301+60</i> <b>.</b> 55	<i>24.</i> 50	20.51	20.61
Н	<i>301+70</i> <b>.</b> 55	<i>24.50</i>	20.68	20.73
I	<i>301+80</i> .55	<i>24.50</i>	20.74	20.76
J	<i>301+90</i> <b>.</b> 55	<i>24.</i> 50	20.78	20.78
Pier 1	<i>301+95.30</i>	<i>24.50</i>	20.80	20.80
K	<i>302+03.</i> 67	<i>24.50</i>	20.83	20.85
L	<i>302+13.67</i>	<i>24.</i> 50	20.88	20.93
M	<i>302+23</i> .67	<i>24.</i> 50	20.92	21.01
N	<i>302+33</i> .67	24.50	20.96	21.11
0	<i>302+43.</i> 67	<i>24.</i> 50	21.01	<i>21.1</i> 9
P	<i>302+53.</i> 67	<i>24.</i> 50	<i>21</i> .05	21.26
a	<i>302+63.</i> 67	<i>24.50</i>	<i>21</i> .09	<i>21.30</i>
R	<i>302+73.67</i>	<i>24.</i> 50	21.14	21.32
S	<i>302+83</i> .67	<i>24.</i> 50	21 <b>.</b> 18	21.31
T	<i>302+93.</i> 67	24.50	21.22	21.27
CL Brg E Abut	<i>303+01.67</i>	24.50	21.20	21.20
CL. E. Exp. Jt.	303+02.52	<i>24.50</i>	21 <b>.</b> 19	<i>21.1</i> 9
Bk E Abut	303+04.60	24.50	21.18	21.18

### GIRDER 3

Bk W Abut 300+87 CL. W. Exp. Jt. 300+87 CL Brg W Abut 300+90 A 301+00 B 301+10	9.3119.080.1719.080.1719.08	17.79 17.82	17.71 17.79 17.82
CL Brg W Abut 300+90 A 301+00	0.17   19.08     0.17   19.08	17.82	
CL Brg W Abut 300+90 A 301+00	0.17 19.08		17.82
		18.22	
R 301+10	19.08		18.30
		<i>18.62</i>	18.76
C 301+20	0.17 19.08	19.02	19.18
D 301+30	0.17 19.08	19.42	19.61
E 301+40	0.17 19.08	19.82	20.00
F 301+50	0.17 19.08	20.21	20.35
G 301+60	0.17 19.08	20.50	20.60
H 301+70	0.17 19.08	20.67	20.73
I 301+80	0.17 19.08	20.73	20.76
J 301+90	0.17 19.08	20.78	20.78
Pier 1 301+94	1.92 19.08	20.80	20.80
K 302+0.	3.66 19.08	20.83	20.85
L 302+1	3.66 19.08	20.88	20.93
M 302+2.	3.66 19.08	20.92	21.01
N 302+3.	3.66 19.08	20.96	21.11
0 302+4.	3.66 19.08	21.01	21.19
P 302+5.	3.66 19.08	21.05	21.26
Q 302+6.	3.66 19.08	21.09	21.30
R 302+7.	3.66 19.08	21.14	21.32
S 302+8.	3.66 19.08	<i>21.18</i>	21.31
T 302+9.	3.66 19.08	21.22	21.27
CL Brg E Abut 303+0	1.66 19.08	21.20	21.20
CL. E. Exp. Jt. 303+02	2.50 19.08	21.19	21.19
Bk E Abut 303+0-	19.08	21.18	21.18



## CHICAGO TRANSIT **AUTHORITY ENGINEERING**

### SENSITIVE SECURITY INFORMATION

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DRAWING SCALE IS NOT GUARANTEED. CTA ASSUMES NO RISK OF LIABILITY FOR ERRORS CAUSED, DIRECTLY OR INDIRECTLY, BY SCALING OF THIS DRAWING.

## 95th Terminal Improvement 15 West 95th Street (South Terminal) Chicago, IL 60628

IN CH	ARGE	S. KADERBEK
APPR	OVED BY	D.ZROKA
CHEC	KED BY	P.MAID
DESIG	GNED BY	L.SOMMER
DRAV	VN BY	T.SLEDGE
PROJ	ECT NO.	2012-0021
FILE N	NAME	File Name
	2/9/17	ISSUED FOR CONSTRUCTION
MARK	DATE	DESCRIPTION

LOCATION IDENTIFIER: DR095

SOUTH BUS BRIDGE TOP OF SLAB ELEVATIONS (SHEET 2 OF 4)

SBB-S-205

### GIRDER 4

Location	Station	Offset	Theoretical Grade Elevations	Theoretical Grade Elevations Adjusted For Dead Load Deflection
Bk W Abut	300+86.84	13.67	17.69	17.69
CL. W. Exp. Jt.	300+88.93	<i>13.67</i>	17.78	17.78
CL Brg W Abut	300+89.80	<i>13.67</i>	<i>17.81</i>	<i>17.81</i>
Α	300+99.80	<i>13</i> .67	18 <b>.</b> 21	<i>18</i> <b>.</b> 25
В	<i>301+09.80</i>	<i>13.67</i>	<i>18.61</i>	<i>18.</i> 69
С	<i>301+19.80</i>	<i>13.67</i>	19.01	<i>19.11</i>
D	301+29.80	<i>13</i> .67	19 <b>.</b> 41	<i>19.52</i>
E	<i>301+39.80</i>	<i>13.67</i>	19.81	19.92
F	301+49.80	<i>13.67</i>	20.20	20.29
G	<i>301+59.80</i>	<i>13</i> .67	20.49	20.56
Н	<i>301+69.80</i>	<i>13</i> .67	20.67	20.71
I	<i>301+79.80</i>	<i>13.67</i>	20.73	20.75
J	<i>301+89.80</i>	<i>13</i> .67	20.78	20.78
Pier 1	301+94.55	<i>13</i> .67	20.80	20.80
K	302+03.64	<i>13.67</i>	20.83	20.85
L	302+13.64	<i>13.67</i>	20.88	20.92
М	<i>302+23.64</i>	<i>13</i> .67	20.92	20.99
N	<i>302+33.64</i>	<i>13.67</i>	20.96	<i>21</i> .07
0	302+43.64	<i>13.67</i>	21.01	21.13
P	<i>302+53.64</i>	<i>13.67</i>	<i>21</i> .05	21.19
Q	<i>302+63.64</i>	<i>13.67</i>	<i>21</i> .09	21.23
R	<i>302+73.64</i>	<i>13.67</i>	21.14	21.26
S	<i>302+83.64</i>	<i>13.67</i>	<i>21.18</i>	21.27
T	<i>302+93<b>.</b>64</i>	<i>13.67</i>	21.22	21 <b>.</b> 26
CL Brg E Abut	303+01.64	<i>13.67</i>	21.20	21.20
CL. E. Exp. Jt.	<i>303+02.48</i>	<i>13.67</i>	21.19	21.19
Bk E Abut	<i>303+04.57</i>	<i>13.67</i>	<i>21.18</i>	21 <b>.</b> 18

### GIRDER 5

Location	Station	Offset	Theoretical Grade Elevations	Theoretical Grade Elevations Adjusted For Dead Load Deflection
Bk W Abut	<i>300+86.46</i>	8.25	17.73	17.73
CL. W. Exp. Jt.	300+88.55	8.25	17.82	17.82
CL Brg W Abut	300+89.42	8.25	17.85	17.85
A	300+99.42	<i>8.25</i>	<i>18.25</i>	<i>18.29</i>
В	301+09.42	8.25	<i>18</i> .65	18.73
C	301+19.42	<b>8.</b> 25	19.05	19.15
D	301+29.42	<b>8.</b> 25	<i>19.45</i>	19.56
Ε	301+39.42	8.25	19.85	19.96
F	301+49.42	<b>8.</b> 25	20.24	20.33
G	301+59.42	<b>8.</b> 25	20.54	20.61
Н	301+69.42	<b>8.</b> 25	20.72	20.76
I	<i>301+79.42</i>	<b>8.</b> 25	20.79	20.80
J	301+89.42	<b>8.</b> 25	20.83	20.83
Pier 1	301+94.17	<i>8.25</i>	20.85	20.85
K	<i>302+03.62</i>	<i>8.25</i>	20.89	20.90
L	<i>302+13.62</i>	<b>8.</b> 25	20.93	20.97
М	302+23.62	<i>8.25</i>	20.98	<i>21</i> .05
N	<i>302+33.62</i>	<b>8.</b> 25	21.02	21.12
0	302+43.62	<b>8.</b> 25	<i>21</i> <b>.</b> 06	21 <b>.</b> 19
P	302+53.62	<b>8.</b> 25	21.11	21.25
Q	302+63.62	<b>8.</b> 25	<i>21.1</i> 5	<i>21.29</i>
R	<i>302+73.62</i>	<b>8.</b> 25	<i>21.1</i> 9	21.31
S	<i>302+83</i> .62	<b>8.</b> 25	21.24	21.32
T	<i>302+93.62</i>	<i>8.25</i>	21.27	21.32
CL Brg E Abut	<i>303+01.62</i>	<b>8.</b> 25	21.25	<i>21.25</i>
CL. E. Exp. Jt.	303+02.47	<b>8.</b> 25	21.25	<i>21</i> .25
Bk E Abut	<i>303+04.</i> 55	8.25	21.23	21.23
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### GIRDER 6

Location	Station	Offset	Theoretical Grade Elevations	Theoretical Grade Elevations Adjusted For Dead Load Deflection
Bk W Abut	300+86.08	2.83	17.80	17.80
CL. W. Exp. Jt.	300+88.17	2.83	17.88	17.88
CL Brg W Abut	300+89.04	2.83	17.92	17.92
A	300+99.04	2.83	18.32	18.36
В	301+09.04	2.83	18.72	18.80
C	301+19.04	2.83	19.12	19.22
D	301+29.04	2.83	19.52	19.63
Ε	301+39.04	2.83	19.92	20.02
F	301+49.04	<i>2.83</i>	20.31	20.40
G	301+59.04	2.83	20.61	20.68
Н	301+69.04	2.83	20.80	20.83
I	301+79.04	2.83	20.87	20.88
J	301+89.04	2.83	20.91	20.91
Pier 1	301+93.79	2.83	20.93	20.93
K	<i>302+03.60</i>	2.83	20.97	20.98
L	<i>302+13.60</i>	2.83	21.02	<i>21.05</i>
M	<i>302+23.60</i>	2.83	21.06	21.13
N	<i>302+33.60</i>	<i>2.83</i>	21.10	21.20
0	302+43.60	2.83	21.14	21.27
P	<i>302+53.60</i>	2.83	21 <b>.</b> 19	<i>21.33</i>
Q	<i>302+63.60</i>	2.83	21.23	<i>21.37</i>
R	<i>302+73.60</i>	2.83	21.27	21.40
S	<i>302+83.60</i>	2.83	21.32	21.41
T	302+93.60	2.83	<i>21.35</i>	21.40
CL Brg E Abut	303+01.60	2.83	21.34	21.34
CL. E. Exp. Jt.	303+02.45	2.83	21.33	21.33
Bk E Abut	303+04.53	2.83	21.32	21.32

PROFILE GRADE

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Location	Station	Offset	Theoretical Grade Elevations	Theoretical Grade Elevations Adjusted For Dead Load Deflection	
Bk W Abut	300+85.88	0.00	17.83	17.83	
CL. W. Exp. Jt.	300+87.97	0.00	17.92	17.92	
CL Brg W Abut	300+88.84	0.00	<i>17.95</i>	<i>17.</i> 95	
A	300+98.84	0.00	<i>18.35</i>	<i>18.3</i> 9	
В	301+08.84	0.00	<i>18.75</i>	18.83	
С	<i>301+18.84</i>	0.00	<i>1</i> 9. <i>1</i> 5	<i>19.25</i>	
D	<i>301+28.84</i>	0.00	<i>1</i> 9 <b>.</b> 55	19.66	
Ε	<i>301+38.84</i>	0.00	<i>1</i> 9 <b>.</b> 95	20.06	
F	301+48.84	0.00	20.35	20.44	
G	<i>301+58.84</i>	0.00	20.65	20.72	
Н	301+68.84	0.00	20.84	20.87	
I	301+78.84	0.00	20.91	20.92	
J	301+88.84	0.00	20.95	20.95	
Pier 1	<i>301+93</i> <b>.</b> 59	0.00	20.97	20.97	
K	<i>302+03</i> .59	0.00	21.01	21.03	
L	<i>302 + 13</i> .59	0.00	21.06	21.10	
М	<i>302+23</i> .59	0.00	21.10	21.17	
N	<i>302+33</i> .59	0.00	21.14	21.25	
0	<i>302+43</i> .59	0.00	21 <b>.</b> 19	21.31	
P	<i>302+53</i> .59	0.00	21.23	21.37	
Q	<i>302+63</i> .59	0.00	21.27	21.41	
R	<i>302+73</i> .59	0.00	21.32	21.44	
S	<i>302+83</i> .59	0.00	<i>21.3</i> 6	21.45	
T	<i>302+93</i> <b>.</b> 59	0.00	21.40	21.44	
CL Brg E Abut	<i>303+01</i> <b>.</b> 59	0.00	<i>21.38</i>	21 <b>.</b> 38	
CL. E. Exp. Jt.	303+02.44	0.00	21 <b>.</b> 37	21.37	
Bk E Abut	303+04.52	0.00	21.36	21.36	

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Location	Station	Offset	Theoretical Grade Elevations	Theoretical Grade Elevations Adjusted For Dead Load Deflection
Bk W Abut	<i>300+85.70</i>	-2 <b>.</b> 58	17.79	17.79
CL. W. Exp. Jt.	300+87.79	-2.58	17.87	<i>17.87</i>
CL Brg W Abut	<i>300+88</i> <b>.</b> 66	- 2 <b>.</b> 58	17.91	17.91
Α	300+98.66	- 2 <b>.</b> 58	<i>18.31</i>	<i>18.35</i>
В	<i>301+08.66</i>	-2 <b>.</b> 58	18.71	<i>18.78</i>
С	<i>301+18.66</i>	-2 <b>.</b> 58	<i>19.11</i>	19.21
D	<i>301+28.66</i>	-2 <b>.</b> 58	19.50	19.62
Ε	<i>301+38.66</i>	-2 <b>.</b> 58	19.90	20.01
F	<i>301+48.66</i>	- 2 <b>.</b> 58	20.30	20.39
G	<i>301+58.66</i>	- 2 <b>.</b> 58	20.61	20.67
Н	301+68.66	- <i>2.58</i>	20.79	20.83
I	<i>301+78.66</i>	- 2 <b>.</b> 58	20.87	20.88
J	<i>301+88.66</i>	- 2 <b>.</b> 58	20.91	20.91
Pier 1	301+93.41	- 2 <b>.</b> 58	20.93	20.93
K	<i>302+03.58</i>	- 2 <b>.</b> 58	20.98	20.99
L	<i>302+13.41</i>	- 2 <b>.</b> 58	21.02	21.06
М	<i>302+23.41</i>	- 2 <b>.</b> 58	21.06	21.13
N	<i>302+33.41</i>	- 2 <b>.</b> 58	21.10	21.21
0	<i>302+43.41</i>	-2 <b>.</b> 58	21 <b>.</b> 15	21.27
P	<i>302+53.41</i>	- 2 <b>.</b> 58	21 <b>.</b> 19	21.33
Q	<i>302+63.41</i>	-2 <b>.</b> 58	21.23	21.37
R	<i>302+73.41</i>	-2 <b>.</b> 58	21.28	21.40
S	<i>302+83.41</i>	-2 <b>.</b> 58	21.32	21.41
T	<i>302+93.41</i>	-2 <b>.</b> 58	<i>21.36</i>	21.40
CL Brg E Abut	303+01 <b>.</b> 58	-2 <b>.</b> 58	21.34	21.34
CL. E. Exp. Jt.	303+02.43	-2 <b>.</b> 58	21.33	21.33
Bk E Abut	303+04.34	- 2.58	21.32	21.32

### GIRDER 8

Location	Station	Offset	Theoretical Grade Elevations	Theoretical Grade Elevations Adjusted For Dead Load Deflection
Bk W Abut	300+85 <b>.</b> 33	- 8.00	17.69	17.69
CL. W. Exp. Jt.	300+87.41	- 8 <b>.</b> 00	17.77	17.77
CL Brg W Abut	<i>300+88.28</i>	-8.00	<i>17<b>.</b>81</i>	17.81
Α	<i>300+98<b>.</b>28</i>	-8.00	18 <b>.</b> 21	<i>18.25</i>
В	<i>301+08.28</i>	-8.00	<i>18.61</i>	<i>18</i> <b>.</b> 69
C	<i>301+18.28</i>	-8.00	19.01	19.11
D	<i>301+28.28</i>	-8.00	<i>19.41</i>	<i>1</i> 9 <b>.</b> 52
Ε	<i>301+38.28</i>	-8.00	19.81	<i>1</i> 9 <b>.</b> 92
F	<i>301+48.28</i>	-8.00	20.20	20.30
${\mathcal G}$	<i>301+58<b>.</b>28</i>	-8.00	20.52	20.58
Н	301+68.28	-8.00	20.71	20.75
I	<i>301+78.28</i>	-8.00	20.79	20.80
J	<i>301+88.28</i>	-8.00	20.83	20.83
Pier 1	301+93.03	-8.00	20.85	<i>20.</i> 85
K	<i>302+03</i> <b>.</b> 56	-8.00	20.89	20.91
L	<i>302+13</i> <b>.</b> 56	-8.00	20.94	20.98
М	<i>302+23</i> .56	-8.00	20.98	<i>21</i> .05
N	<i>302+33</i> .56	-8.00	21.02	21.13
0	<i>302+43.</i> 56	-8.00	21.07	<i>21.1</i> 9
P	<i>302+53</i> <b>.</b> 56	- 8.00	21 <b>.</b> 11	<i>21.25</i>
Q	<i>302+63</i> .56	-8.00	<i>21.1</i> 5	21.29
R	<i>302+73</i> .56	-8.00	21.20	21.32
S	<i>302+83</i> .56	-8.00	21.24	<i>21.33</i>
$\mathcal{T}$	<i>302+93</i> .56	-8.00	21.28	21.32
CL Brg E Abut	303+01 <b>.</b> 56	-8.00	21.26	21.26
CL. E. Exp. Jt.	<i>303+02.41</i>	-8.00	<i>21.25</i>	21.25
Bk E Abut	303+04.49	-8.00	21.24	21.24





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## 95th Terminal Improvement

15 West 95th Street (South Terminal) Chicago, IL 60628

IN CH	ARGE	S. KADERBEK
APPR	OVED BY	D.ZROKA
CHEC	KED BY	P.MAID
DESIG	ENED BY	L.SOMMER
DRAV	VN BY	T.SLEDGE
PROJ	ECT NO.	2012-0021
FILE N	NAME	File Name
	2/9/17	ISSUED FOR CONSTRUCTION
MARK	DATE	DESCRIPTION
	ATION IDE	NTIFIER DROS

| LOCATION IDENTIFIER: DR095

SOUTH BUS BRIDGE TOP OF SLAB ELEVATIONS (SHEET 3 OF 4)

SBB-S-206

### <u>GIRDER 9</u>

Location	Station	Offset	Theoretical Grade Elevations	Theoretical Grade Elevations Adjusted For Dead Load Deflection
Bk W Abut	300+84.95	- 13.42	17.59	17.59
CL. W. Exp. Jt.	300+87.03	- 13 <b>.</b> 42	17.67	17.67
CL Brg W Abut	300+87.90	- 13 <b>.</b> 42	17.71	17.71
Α	300+97.90	- 13 <b>.</b> 42	18.11	<i>18.1</i> 5
В	301+07.90	- <i>13.42</i>	<i>18.51</i>	<i>18</i> .58
С	301+17.90	- 13 <b>.</b> 42	<i>18.91</i>	19.01
D	<i>301+27.90</i>	- <i>13.42</i>	<i>19.31</i>	19.42
Ε	<i>301+37.90</i>	- <i>13.42</i>	19.70	19.81
F	<i>301+47.90</i>	- <i>13.42</i>	20.10	<i>20.1</i> 9
G	<i>301+57.90</i>	- <i>13.42</i>	20.42	20.48
Н	<i>301+67.90</i>	- <i>13.42</i>	20.61	20.65
I	<i>301+77.90</i>	- <i>13.42</i>	20.70	<i>20.71</i>
J	<i>301+87.90</i>	- 13 <b>.</b> 42	20.74	20.74
Pier 1	<i>301+92.</i> 65	- 13 <b>.</b> 42	20.76	20.76
К	302+03.54	- <i>13.42</i>	20.81	20.82
L	<i>302+13.54</i>	- 13 <b>.</b> 42	20.85	20.89
М	<i>302+23.54</i>	- <i>13.42</i>	20.89	20.96
N	<i>302+33.54</i>	- <i>13.42</i>	20.94	21.04
0	<i>302+43.54</i>	- <i>13.42</i>	20.98	21.11
Р	<i>302+53.54</i>	- <i>13.42</i>	21.02	<i>21.1</i> 6
Q	<i>302+63.54</i>	- <i>13.42</i>	<i>21.06</i>	21.20
R	302+73.54	- <i>13.42</i>	21.11	21.23
S	<i>302+83.54</i>	- <i>13.42</i>	<i>21.1</i> 5	21.24
T	<i>302+93.54</i>	- <i>13.42</i>	<i>21.1</i> 9	21.23
CL Brg E Abut	<i>303+01.54</i>	- <i>13.42</i>	21.17	21.17
CL. E. Exp. Jt.	<i>303+02.3</i> 9	- <i>13.42</i>	<i>21.1</i> 6	<i>21.1</i> 6
Bk E Abut	<i>303+04.47</i>	- 13 <b>.</b> 42	<i>21.1</i> 5	<i>21.1</i> 5

### GIRDER 10

Location	Station	Offset	Theoretical Grade Elevations	Theoretical Grade Elevations Adjusted For Dead Load Deflection
Bk W Abut	300+84.57	- 18 <b>.</b> 83	17.46	17.46
CL. W. Exp. Jt.	<i>300+86.66</i>	- 18 <b>.</b> 83	<i>17.</i> 55	<i>17.55</i>
CL Brg W Abut	<i>300+87.52</i>	- 18 <b>.</b> 83	<i>17.58</i>	17.58
Α	<i>300+97.52</i>	- 18 <b>.</b> 83	17.98	18.03
В	<i>301+07.52</i>	- 18 <b>.</b> 83	<i>18.38</i>	<i>18.46</i>
С	301+17.52	- 18 <b>.</b> 83	<i>18.78</i>	18.88
D	<i>301+27.52</i>	- 18 <b>.</b> 83	19 <b>.</b> 18	19.29
Ε	<i>301+37.52</i>	- 18 <b>.</b> 83	<i>19</i> <b>.</b> 58	19.69
F	301+47.52	- 18 <b>.</b> 83	<i>19</i> <b>.</b> 98	20.07
${\it G}$	<i>301+57.52</i>	- 18 <b>.</b> 83	20.30	20.37
Н	301+67.52	- 18 <b>.</b> 83	20.50	20.54
I	301+77.52	- 18 <b>.</b> 83	<i>20</i> <b>.</b> 59	20.60
J	301+87.52	- 18 <b>.</b> 83	20.63	20.63
Pier 1	<i>301+92.27</i>	- 18 <b>.</b> 83	<i>20.</i> 65	20.65
K	<i>302+03</i> .5 <i>3</i>	- 18 <b>.</b> 83	20.70	20.71
L	<i>302+13.53</i>	- 18 <b>.</b> 83	20.74	20.78
М	<i>302+23</i> .53	- 18 <b>.</b> 83	20.78	20.85
N	<i>302+33</i> .53	- 18 <b>.</b> 83	20.83	20.93
0	<i>302+43</i> .53	- 18 <b>.</b> 83	20.87	21.00
Р	<i>302+53</i> .53	- 18 <b>.</b> 83	20.91	21.05
Q	<i>302+63.53</i>	- 18 <b>.</b> 83	20.96	21.10
R	<i>302+73.53</i>	- 18 <b>.</b> 83	21.00	21.12
S	<i>302+83</i> .5 <i>3</i>	- 18 <b>.</b> 83	21.04	21.13
$\mathcal{T}$	<i>302+93</i> <b>.</b> 53	- 18 <b>.</b> 83	21.08	21.12
CL Brg E Abut	<i>303+01.53</i>	- 18 <b>.</b> 83	21.06	21.06
CL. E. Exp. Jt.	303+02.37	- 18 <b>.</b> 83	21.06	21.06
Bk E Abut	303+04.46	- 18 <b>.</b> 83	21.04	21.04


Location	Station	Offset	Theoretical Grade Elevations	Theoretical Grade Elevations Adjusted For Dead Load Deflection
Bk W Abut	300+88.94	43.90	17.78	17.78
CL. W. Exp. Jt.	300+90.88	41.87	17.85	17.85
CL Brg W Abut	300+91.71	41.00	17.89	17.89
U	300+98.60	33.76	18.16	18.20
At Beam 1	301+04.57	27.50	18.40	18.47

### BEAM 2W

Location	Station	Offset	Theoretical Grade Elevations	Theoretical Grade Elevations Adjusted For Dead Load Deflection
Bk W Abut	300+88.44	36.50	17.76	17.76
CL. W. Exp. Jt.	300+90.53	36.50	17.84	17.84
CL Brg W Abut	300+91.39	36.50	17.87	17.87
At Beam 1W	300+95.99	36.50	18.06	18.08

### <u>BEAM 3W</u>

Location	Station	Offset	Theoretical Grade Elevations	Theoretical Grade Elevations Adjusted For Dead Load Deflection
Bk W Abut	300+88.12	32.00	17.74	17.74
CL. W. Exp. Jt.	300+90.21	32.00	17.83	17.83
CL Brg W Abut	300+91.08	32.00	17.86	17.86
At Beam 1W	301+00.28	32.00	18.23	18.28

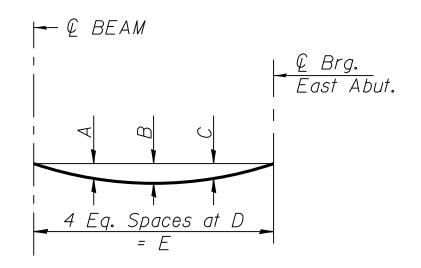

## DEAD LOAD DEFLECTIONS

(Includes weight of concrete, excluding beams).

Beam	А	В	С	D	Ε
1E	0	<i>l</i> , "	0	5'-9 <sup>3</sup> 8"	23'-1 <sup>3</sup> 8"

Note:

Beams 1W,2W,3W,2E & 3E have no measurable dead load deflection.

### <u>BEAM 1E</u>

Location	Station	Offset	Theoretical Grade Elevations	Theoretical Grade Elevations Adjusted For Dead Load Deflection
At Beam 1 V CL Brg E Abut	302+85.55 302+92.55 303+01.74	27.50 34.64 44.00 44.87	21.19 21.21 21.20 21.19	21.28 21.27 21.20 21.19
CL. E. Exp. Jt. Bk E Abut	303+02.60 303+04.68	44.67 46.99	21.19 21.18	21.19 21.18

### BEAM 2E

Location	Station	Offset	Theoretical Grade Elevations	Theoretical Grade Elevations Adjusted For Dead Load Deflection
At Beam 1E	302+96.34	38.50	21.22	21.28
CL Brg E Abut	303+01.74	38.50	21.20	21.20
CL. E. Exp. Jt.	303+02.64	38.50	21.19	21.19
Bk E Abut	303+04.65	38.50	21.18	21.18

### <u>BEAM 3E</u>

Location	Station	Offset	Theoretical Grade Elevations	Theoretical Grade Elevations Adjusted For Dead Load Deflection
At Beam 1E	<i>302+90.</i> 95	33.00	21.21	21.25
CL Brg E Abut	<i>303+01.70</i>	33.00	21.20	21.20
CL. E. Exp. Jt.	<i>303+02.</i> 55	33.00	21 <b>.</b> 19	21.19
Bk E Abut	303+04.63	33.00	21 <b>.</b> 18	21.18





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### 95th Terminal Improvement


15 West 95th Street (South Terminal) Chicago, IL 60628

IN CH	ARGE	S. KADERBEK			
APPR	OVED BY	D.ZROKA			
CHEC	KED BY	P.MAID			
DESIG	SNED BY	L.SOMMER			
DRAV	VN BY	T.SLEDGE			
PROJ	ECT NO.	2012-0021			
FILE I	NAME	File Name			
	2/9/17	ISSUED FOR CONSTRUCTION			
AADIZ					
IARK	DATE	DESCRIPTION			

LOCATION IDENTIFIER: DR095

SOUTH BUS BRIDGE TOP OF SLAB ELEVATIONS (SHEET 4 OF 4)

SBB-S-206A

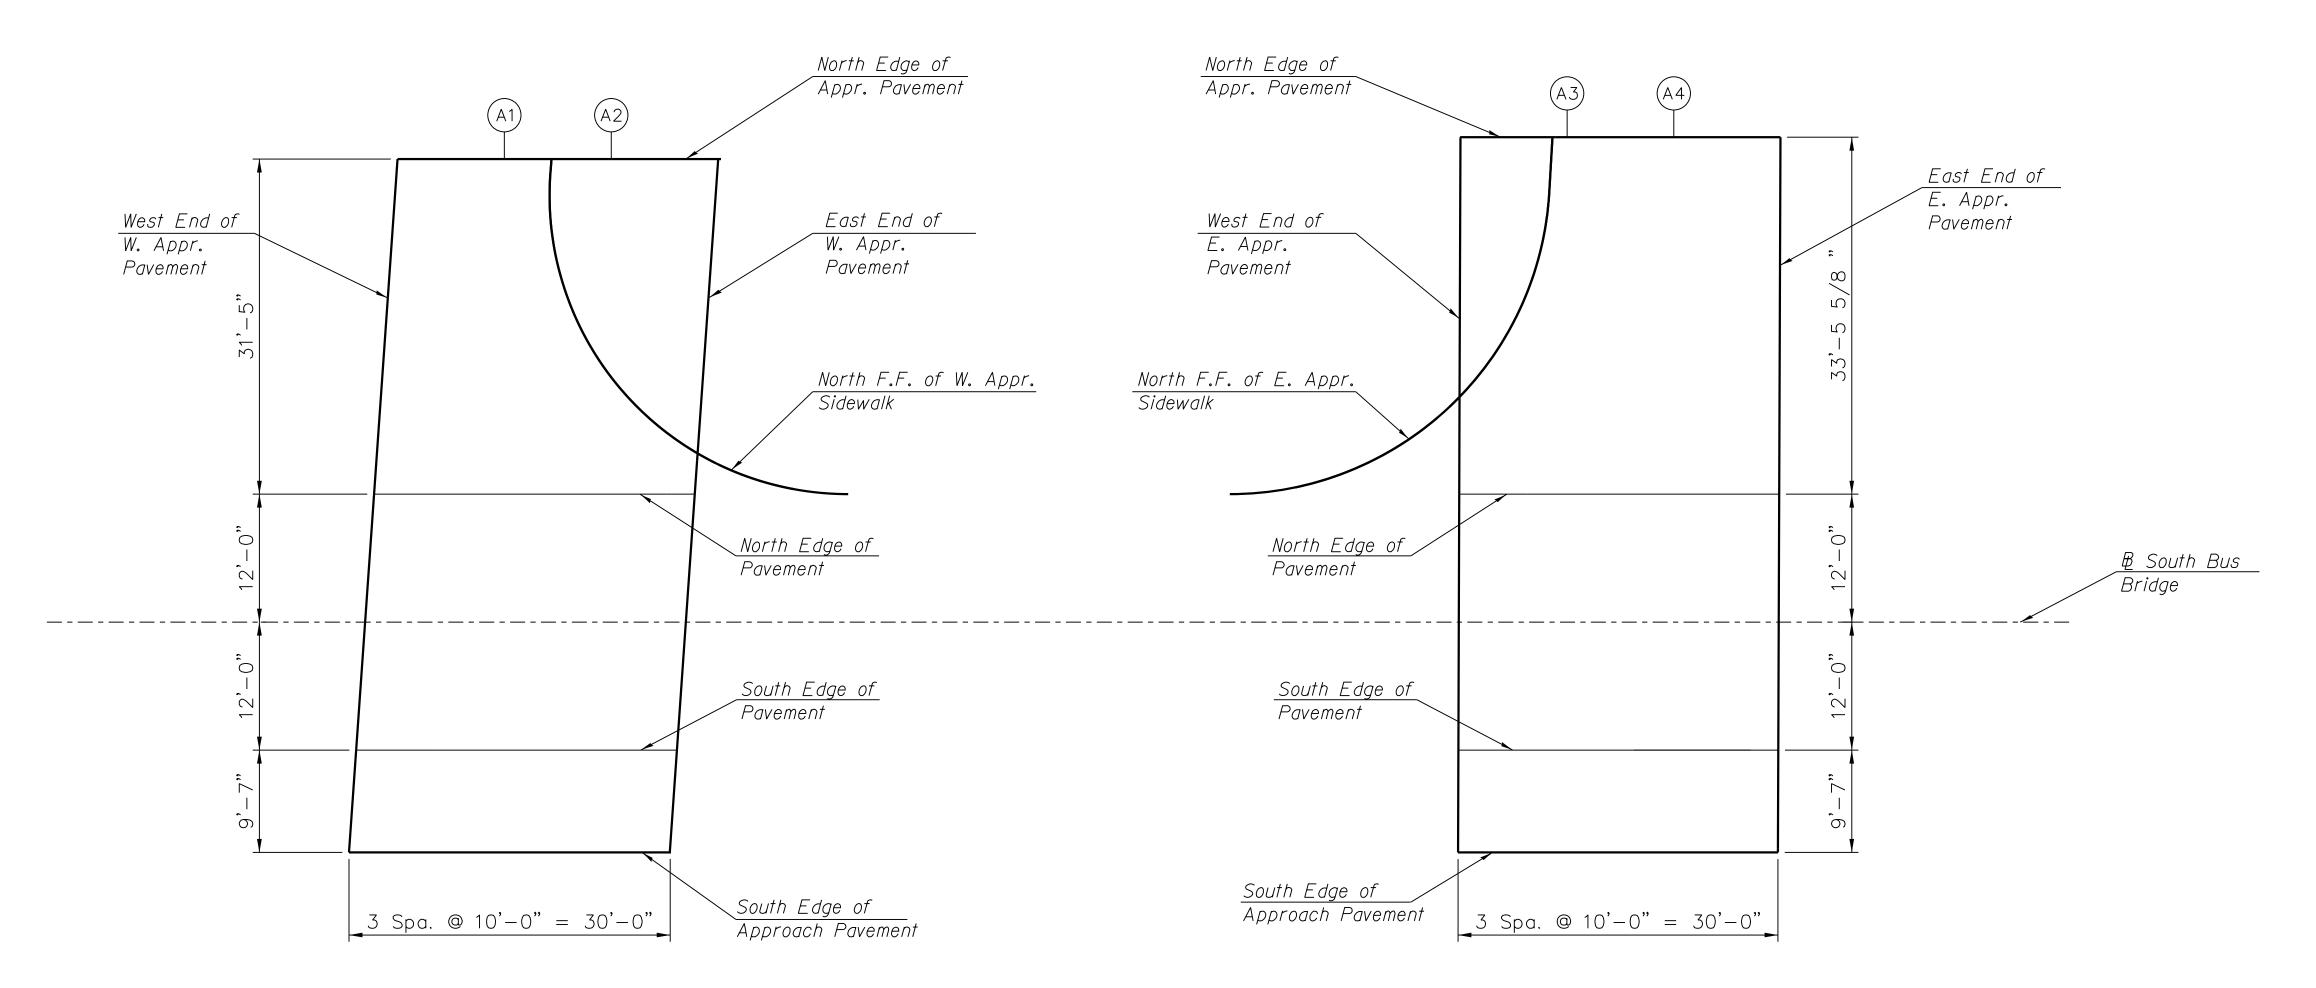

<u>PLAN</u>





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# 95th Terminal Improvement 15 West 95th Street (South Terminal) Chicago, IL 60628

Chicago, IL 60628

IN CHARGE S. KADERBEK

APPR	OVED BY	D.ZROKA			
CHEC	KED BY	P.MAID			
DESIC	SNED BY	L.SOMMER			
DRAV	VN BY	T.SLEDGE			
PROJ	ECT NO.	2012-0021			
FILE N	NAME	File Name			
	0/0/47	IOOUED EOD CONCEDUCTION			
	2/9/17	ISSUED FOR CONSTRUCTION			
MARK	DATE	DESCRIPTION			
LOCATION IDENTIFIED. BRACE					

LOCATION IDENTIFIER: DR095

SOUTH BUS BRIDGE
TOP OF APPROACH SLAB ELEVATIONS
(SHEET 1 OF 2)

SBB-S-207

# NORTH EDGE OF APPROACH

Location	Station	Offset	Theoretical Grade Elevations
West End W. Appr. Pav't.	300+59.34	+43.42	17.65
A 1	300+69.37	+43.42	17.91
North F.F. W. Appr. Sidewalk	300+73.79	+43.42	18.68
A2	300+79.39	+43.42	18.78
East End W. Appr. Pav't.	300+89.42	+43.42	18.95
West End E. Appr. Pav't.	303+04.17	+45.47	21.71
North F.F. E. Appr. Sidewalk	303+12.80	+45.47	21.58
A 3	303+14.17	+45.47	20.89
A4	303+24.17	+45.47	20.74
East End E. Appr. Pav't.	303+34.17	+45.47	20.57

# NORTH EDGE OF PAVEMENT

Location	Station	Offset	Theoretical Grade Elevations
West End W. Appr. Pav't.	300+57.15	+12.00	16.58
A 1	300+67.17	+ 12.00	16.91
A2	300+77.20	+12.00	17.31
East End W. Appr. Pav't.	300+87.22	+ 12.00	17.71
West End E. Appr. Pav't.	303+04.05	+ 12.00	21.18
A 3	303+14.05	+ 12.00	21.06
A 4	303+24.05	+ 12.00	20.88
East End E. Appr. Pav't.	303+34.05	+12.00	20.68

# B OF SOUTH BUS BRIDGE

Location	Station	Offset	Theoretical Grade Elevations
West End W. Appr. Pav't.	300+56.31	0.00	16.65
A 1	300+66.33	0.00	17.05
A2	300+76.36	0.00	17.45
East End W. Appr. Pav't.	300+86.38	0.00	17.85
West End E. Appr. Pav't.	303+04.01	0.00	21.36
A 3	303+14.01	0.00	21.24
A4	303+24.01	0.00	21.06
East End E. Appr. Pav't.	303+34.01	0.00	20.86

# SOUTH EDGE OF PAVEMENT

Location	Station	Offset	Theoretical Grade Elevations
West End W. Appr. Pav't.	300+55.47	- 12.00	16.44
A1	300+65.49	- 12.00	16.84
A2	300+75.52	- 12.00	17.24
East End W. Appr. Pav't.	300+85.54	- 12.00	17.64
West End E. Appr. Pav't.	303+03.97	- 12.00	21.18
A 3	303+13.97	- 12.00	21.06
A4	303+23.97	- 12.00	20.88
East End E. Appr. Pav't.	303+33.97	- 12.00	20.68

# CHICAGO TRANSIT **cta** AUTHORITY **ENGINEERING**

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# 95th Terminal Improvement 15 West 95th Street (South Terminal) Chicago, IL 60628


IN CH	ARGE	S. KADERBEK	
APPROVED BY		D.ZROKA	
CHEC	KED BY	P.MAID	
DESIG	SNED BY	L.SOMMER	
DRAV	VN BY	T.SLEDGE	
PROJ	ECT NO.	2012-0021	
FILE	NAME	File Name	
	2/9/17	ISSUED FOR CONSTRUCTION	
	_		
MARK	DATE	DESCRIPTION	
LOCATION IDENTIFIER: DR095			

SOUTH BUS BRIDGE TOP OF APPROACH SLAB ELEVATIONS (SHEET 2 OF 2)


SBB-S-208


# SOUTH EDGE OF APPROACH


Location	Station	Offset	Theoretical Grade Elevations
West End W. Appr. Pav't.	300+54.80	-21.58	16.24
A1	300+64.82	-21.58	16.62
A2	300+74.85	-21.58	17.02
East End W. Appr. Pav't.	300+84.87	-21.58	17.42
West End E. Appr. Pav't.	303+03.94	- 21.58	20.99
A 3	303+13.94	-21.58	20.87
A 4	303+23.94	- 21.58	20.69
East End E. Appr. Pav't.	303+33.94	- 21.58	20.49

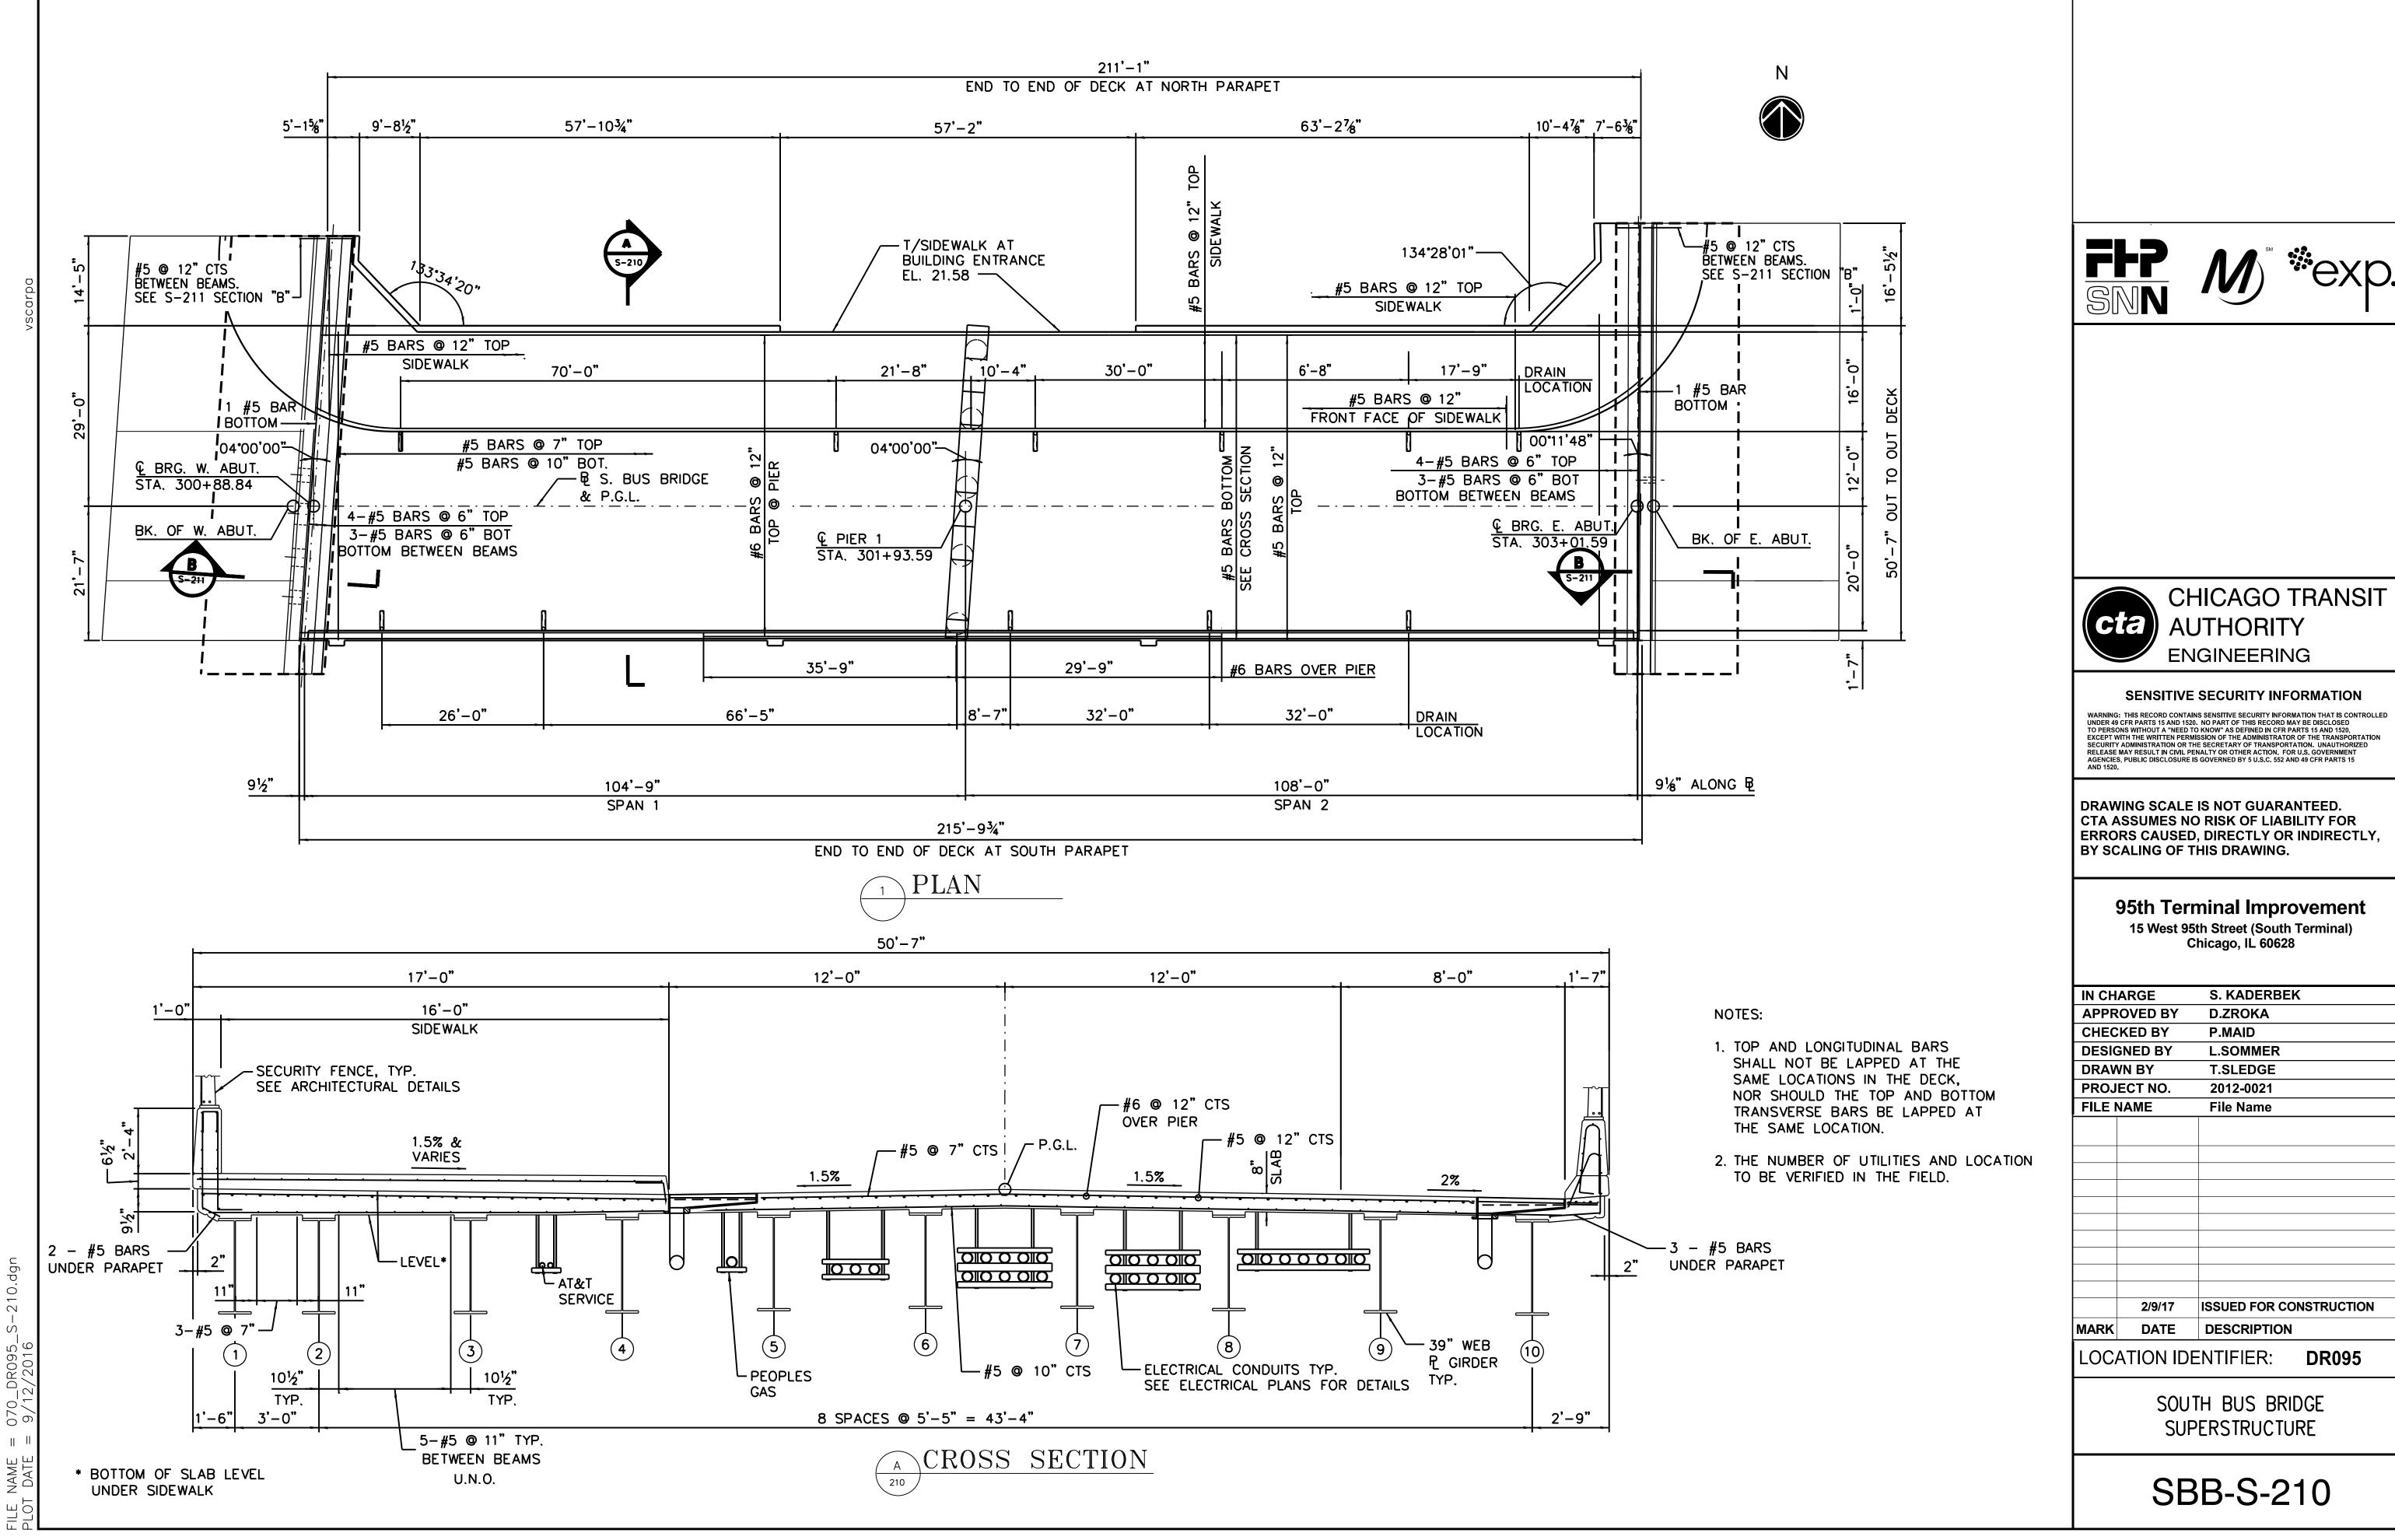

IN CH	ARGE	S. KADERBEK
APPR	OVED BY	D.ZROKA
CHEC	KED BY	P.MAID
DESIG	GNED BY	L.SOMMER
DRAV	VN BY	T.SLEDGE
PROJ	ECT NO.	2012-0021
FILE I	NAME	File Name
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	2/9/17	ISSUED FOR CONSTRUCTION
MARK	DATE	DESCRIPTION
LOC	ATION IDE	ENTIFIER: <b>DR095</b>

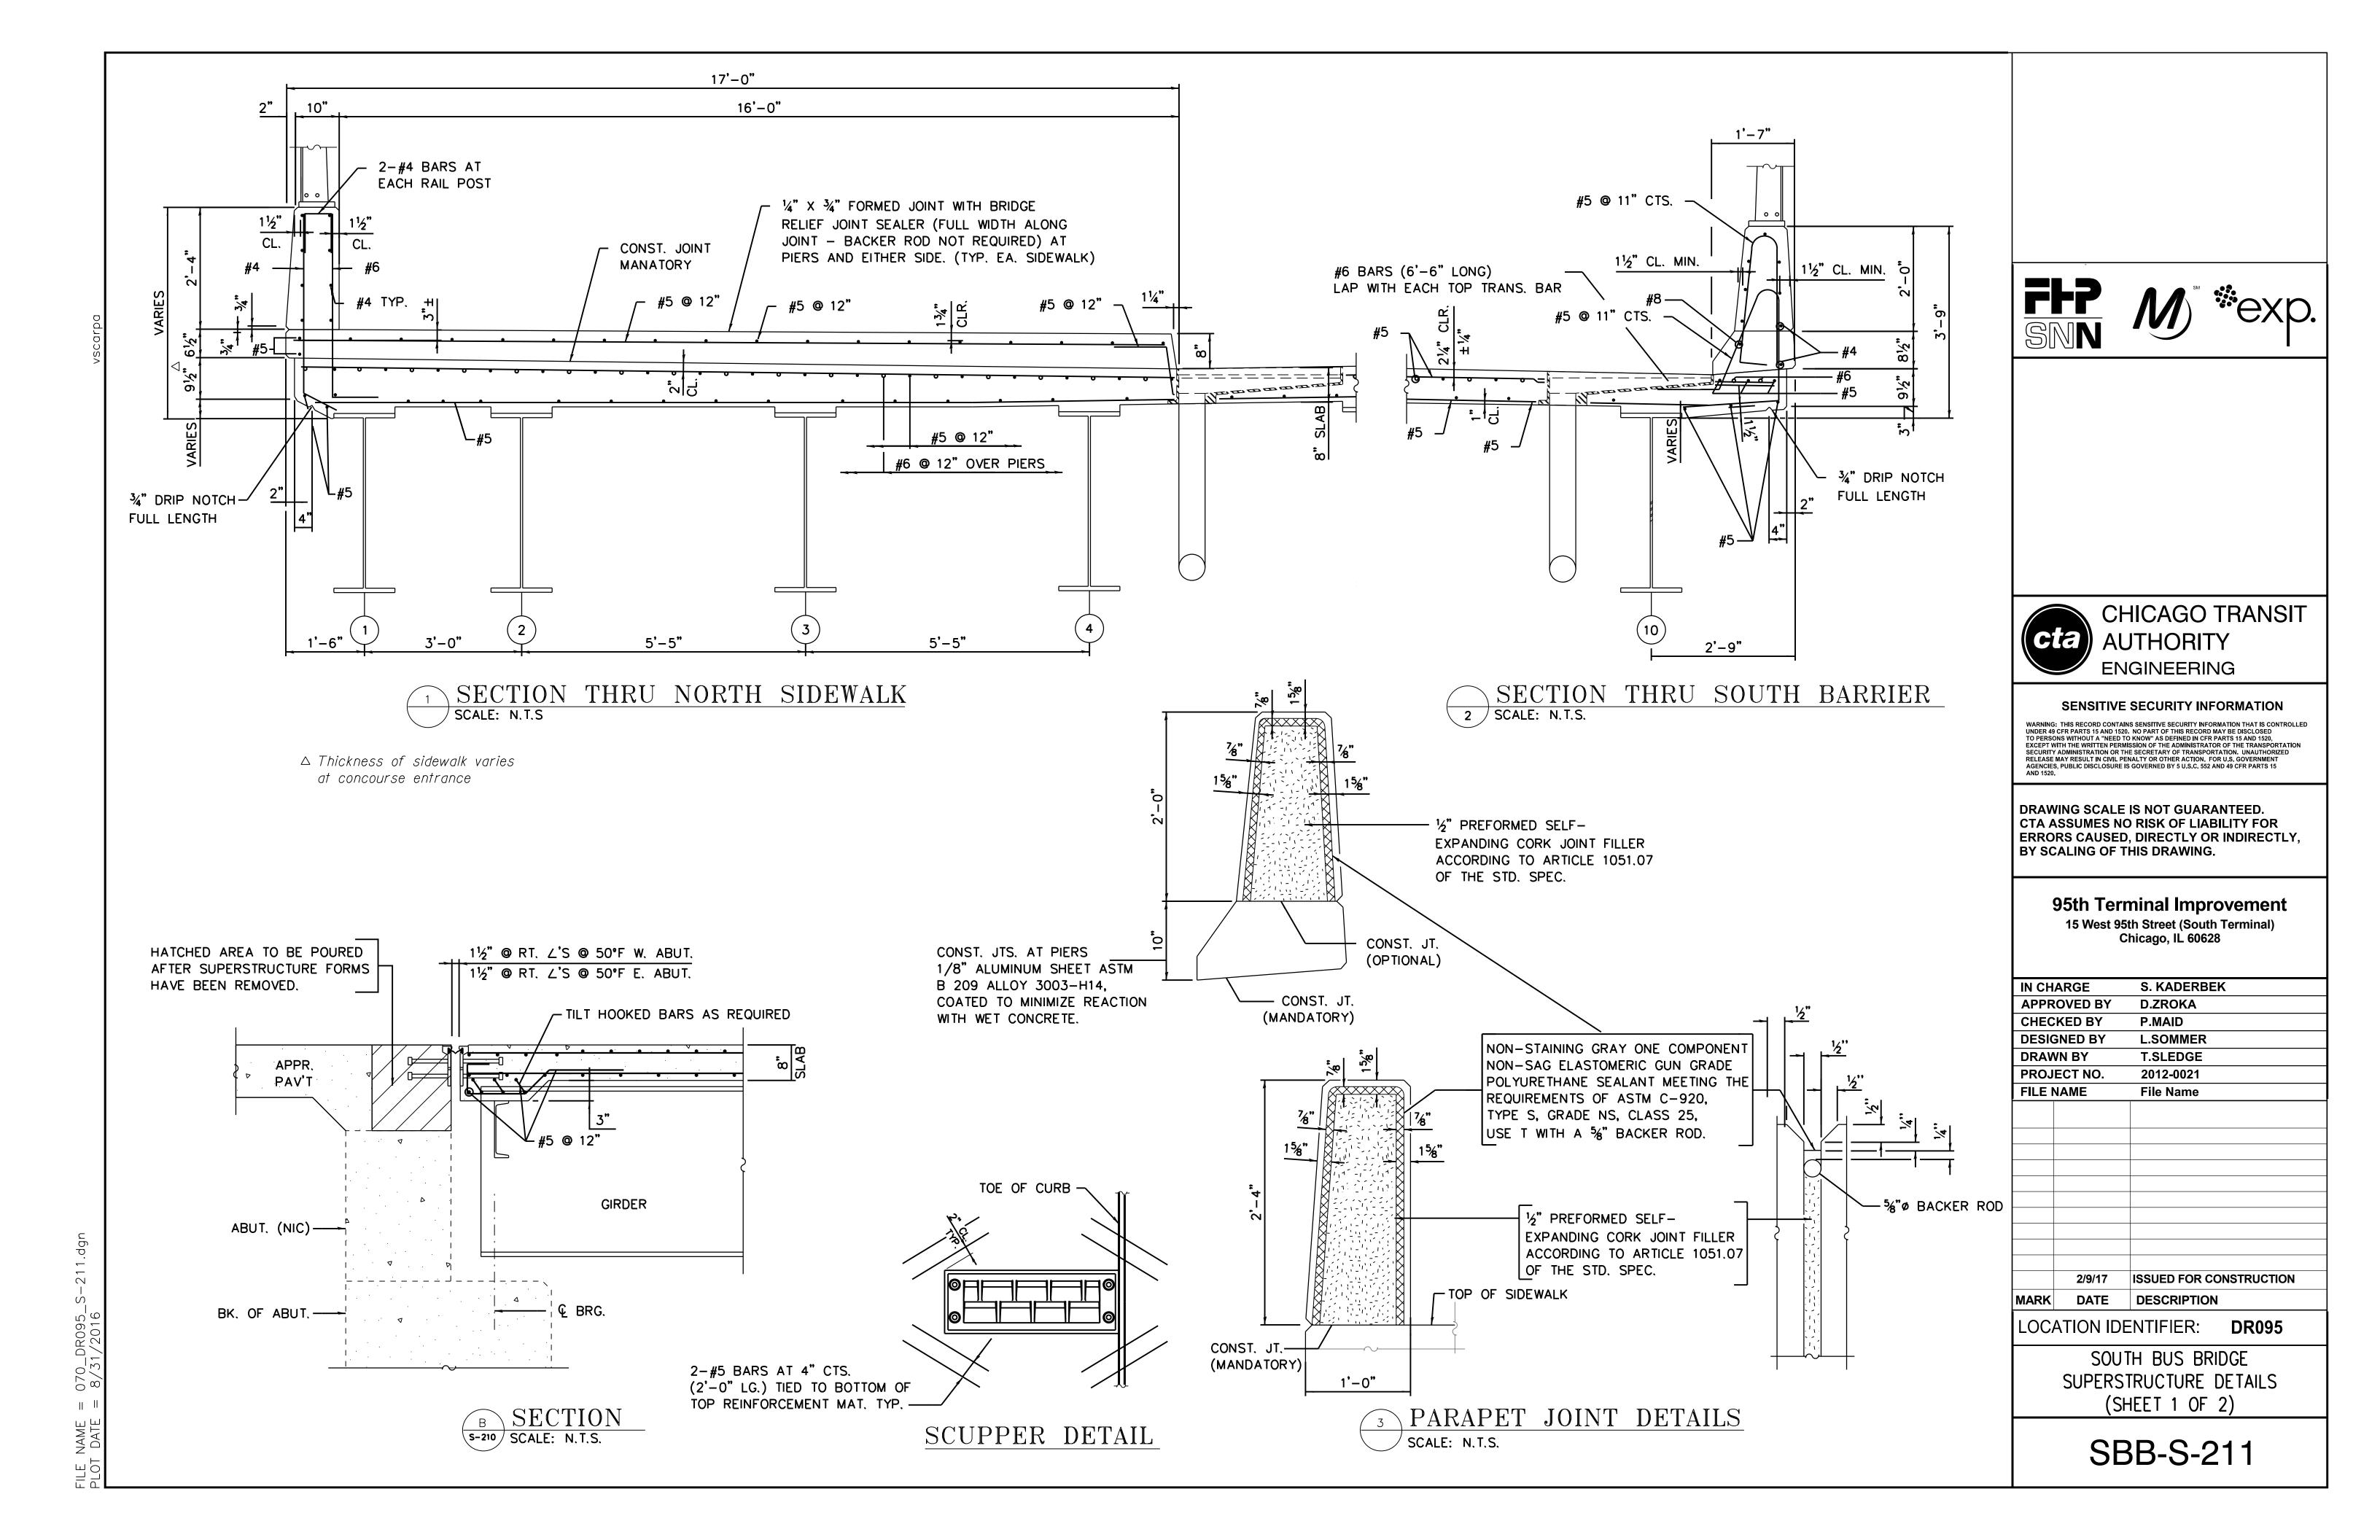

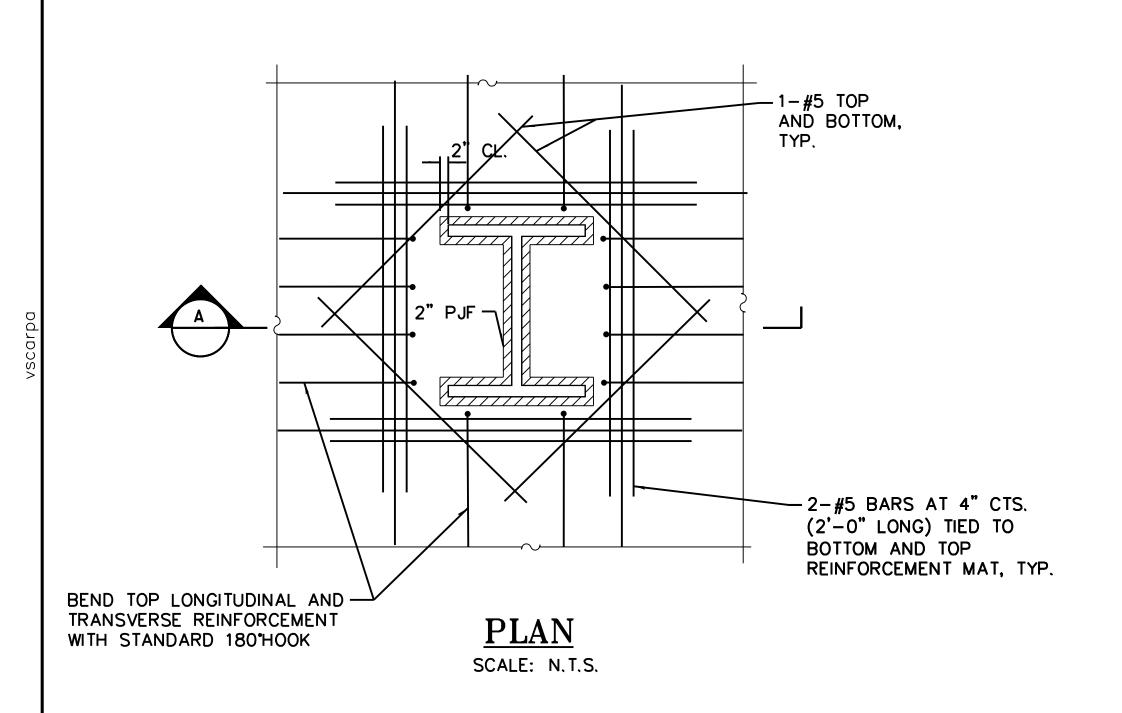

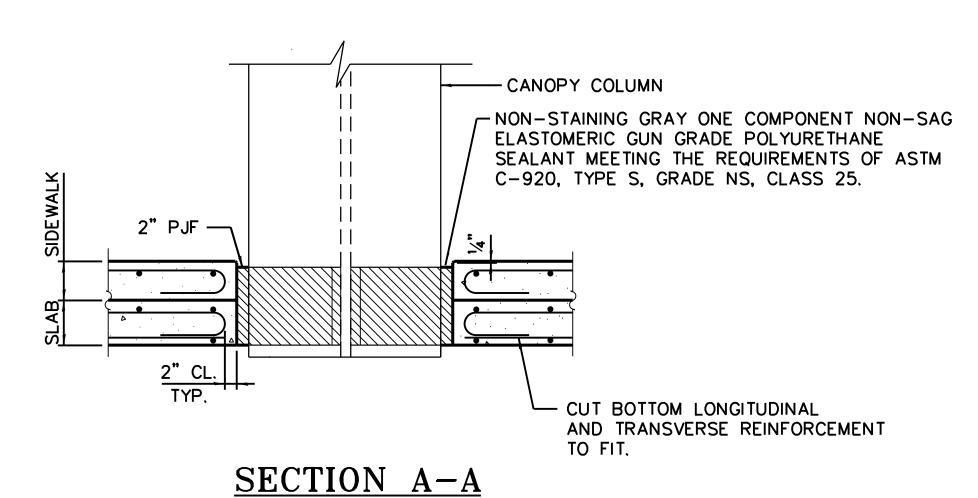

STEEL COLUMN CONNECTION NOT SHOWN FOR CLARITY.





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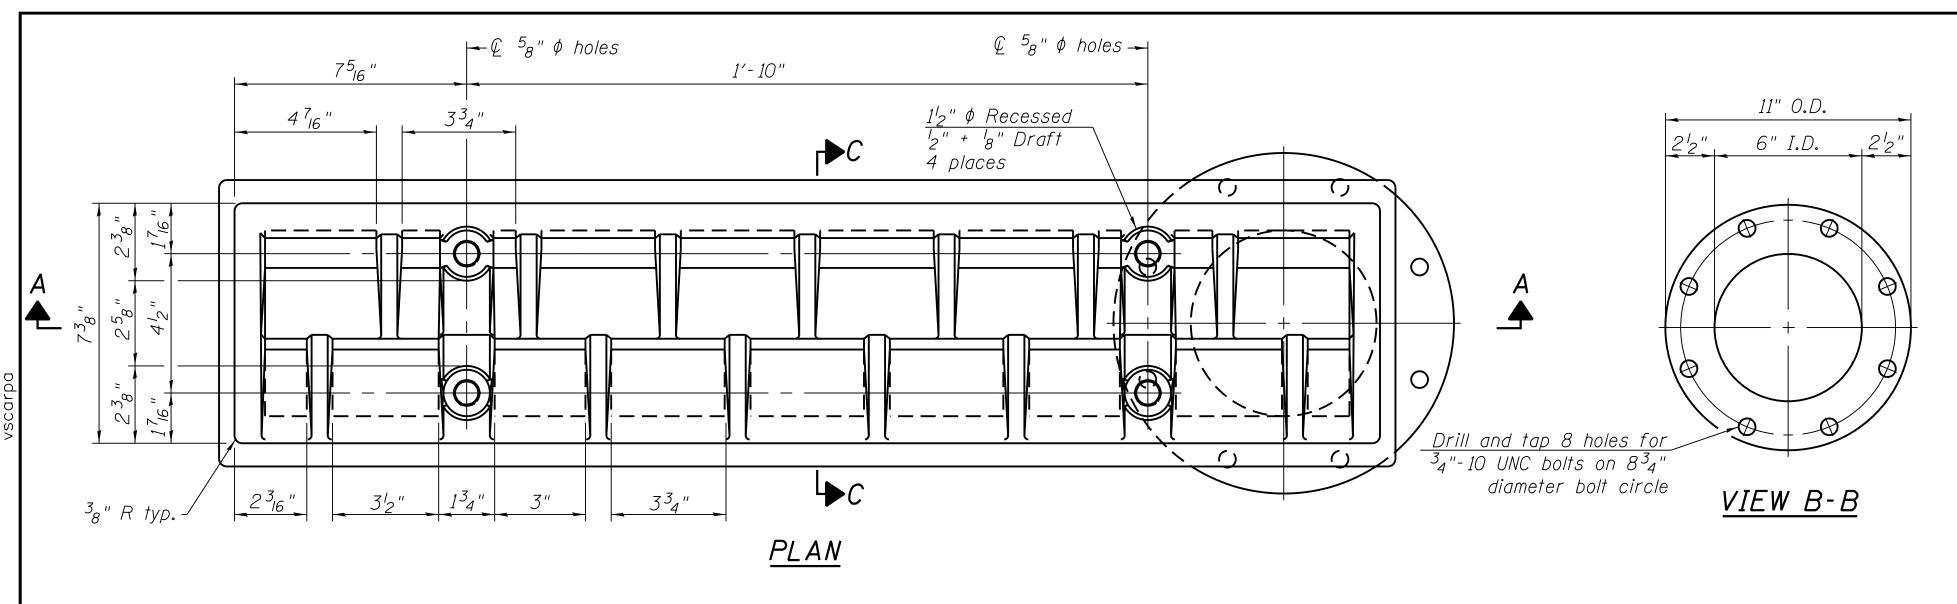
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### 95th Terminal Improvement

15 West 95th Street (South Terminal) Chicago, IL 60628

IN CHARGE		S. KADERBE	K		
APPROVED BY		D.ZROKA			
CHECKED BY		P.MAID			
DESIG	SNED BY	L.SOMMER			
DRAV	VN BY	T.SLEDGE			
PROJ	ECT NO.	2012-0021			
FILE	NAME	File Name			
	2/9/17	ISSUED FOR CO	DISTRUCTION		
MARK DATE DESCRIPTION		DESCRIPTION			
LOC	LOCATION IDENTIFIER: DR095				

SOUTH BUS BRIDGE SUPERSTRUCTURE DETAILS (SHEET 2 OF 2)



Refer to Drainage system specification, section 33 41 10. All cast iron parts shall be gray iron conforming to the requirements of AASHTO M 105, Class 35B.

Bolts, anchor studs, washers and nuts shall conform to the requirements of ASTM A 307 and shall be galvanized according to AASHTO M 232.

As an alternate, bolts, anchor studs, washers and nuts may be stainless steel according to Article 1006.29(d) of the IDOT Standard Specifications.

Structural steel weldments of equal sections and of the same configuration may be substituted for the cast iron scupper frame. Fillet or full penetration welds shall be used for the weldments. Details shall be submitted to the Engineer for approval. Structural steel weldments shall not be substituted for the cast iron scupper grate. Structural steel frames and downspouts shall be galvanized according to AASHTO M111.

The Contractor shall take appropriate measures to assure that Protective Coat is not applied to the scupper.

 $8^{3}_{4}$ "  $\phi$  bolt circle

Alternate fiberglass downspout conforming to ASTM D 2996 with a short-time rupture strength hoop tensile stress of 30,000 psi min. may be used in lieu of the cast iron or steel equivalent.

11" O.D.

6" I.D.

6" I.D.

7" O.D.

**DOWNSPOUT** 





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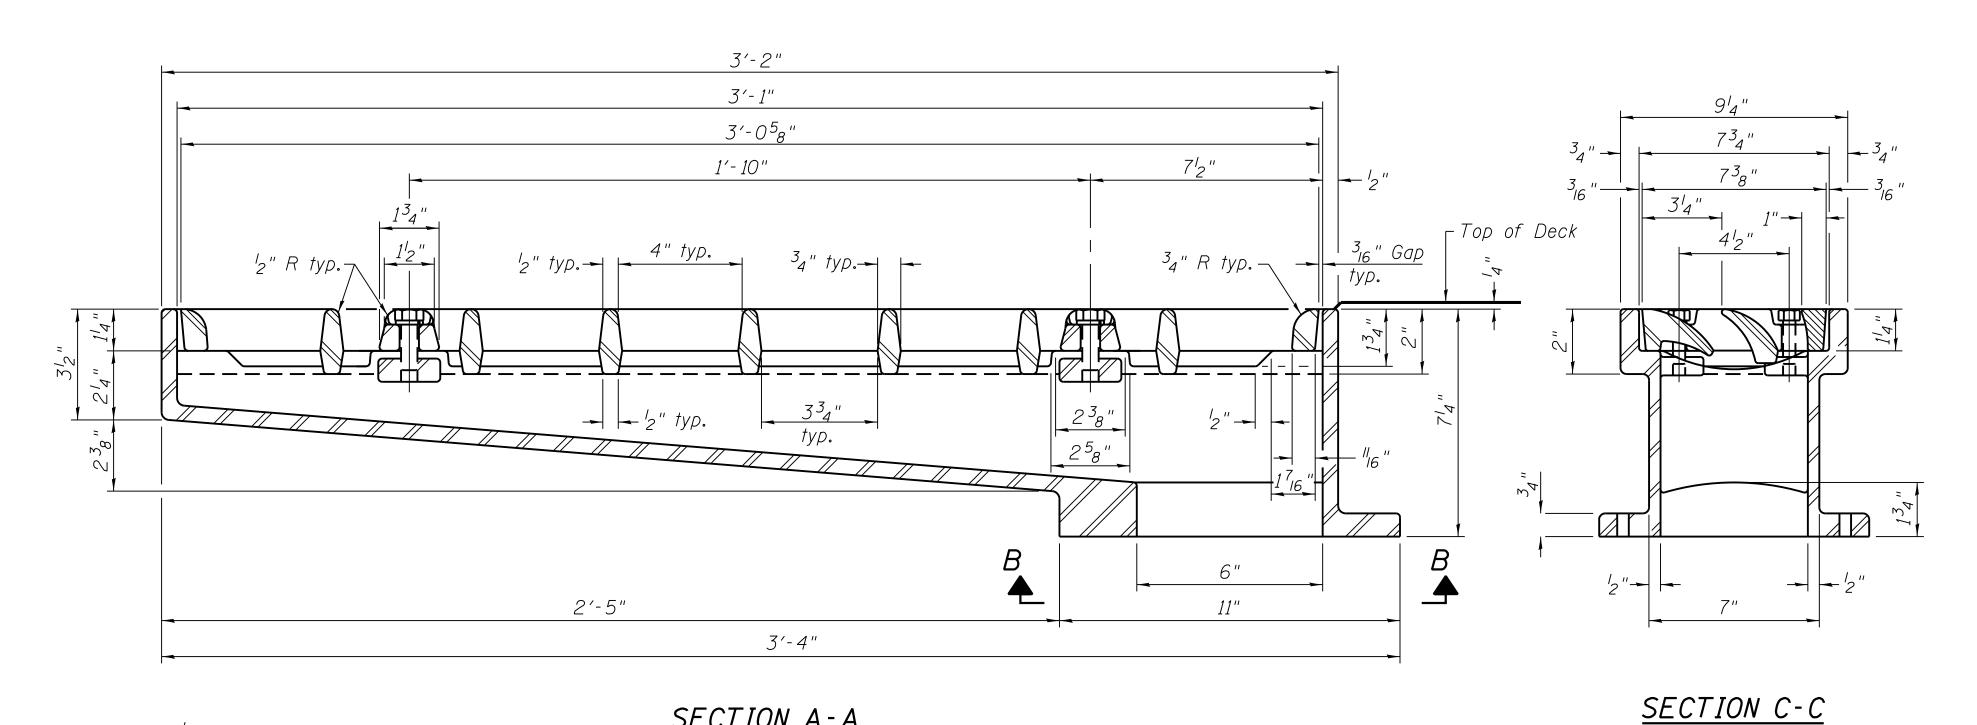
# 95th Terminal Improvement

15 West 95th Street (South Terminal) Chicago, IL 60628

IN CHA	ARGE	S. KADERBEK
APPROVED BY		D.ZROKA
CHECKED BY		P.MAID
DESIG	NED BY	L.SOMMER
DRAW	N BY	T.SLEDGE
PROJE	ECT NO.	2012-0021
FILE N	IAME	File Name
	2/9/17	ISSUED FOR CONSTRUCTION
MARK	DATE	DESCRIPTION
LOCA	ATION IDI	ENTIFIER: <b>DR095</b>
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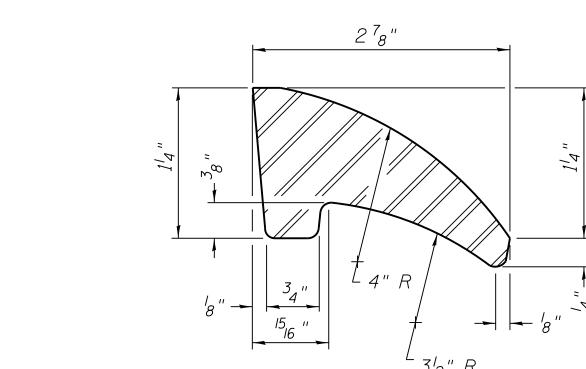
SOUTH BUS BRIDGE DRAINAGE SCUPPER, DS-33

SBB-S-212A





SECTION A-A

See sheet SBB-S-211 for scupper location relative to curb.



FIRST VANE DETAIL

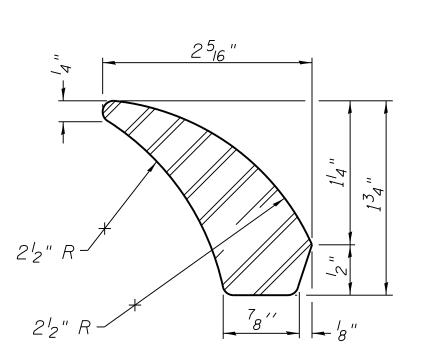


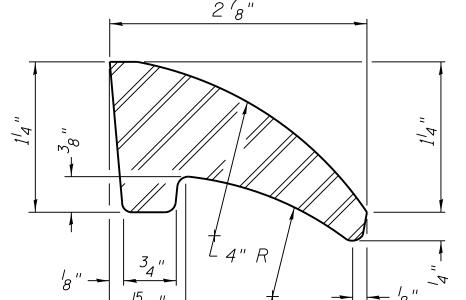

SECOND VANE DETAIL

<sup>l</sup>8" R typ.

BOLT HOLE DETAIL

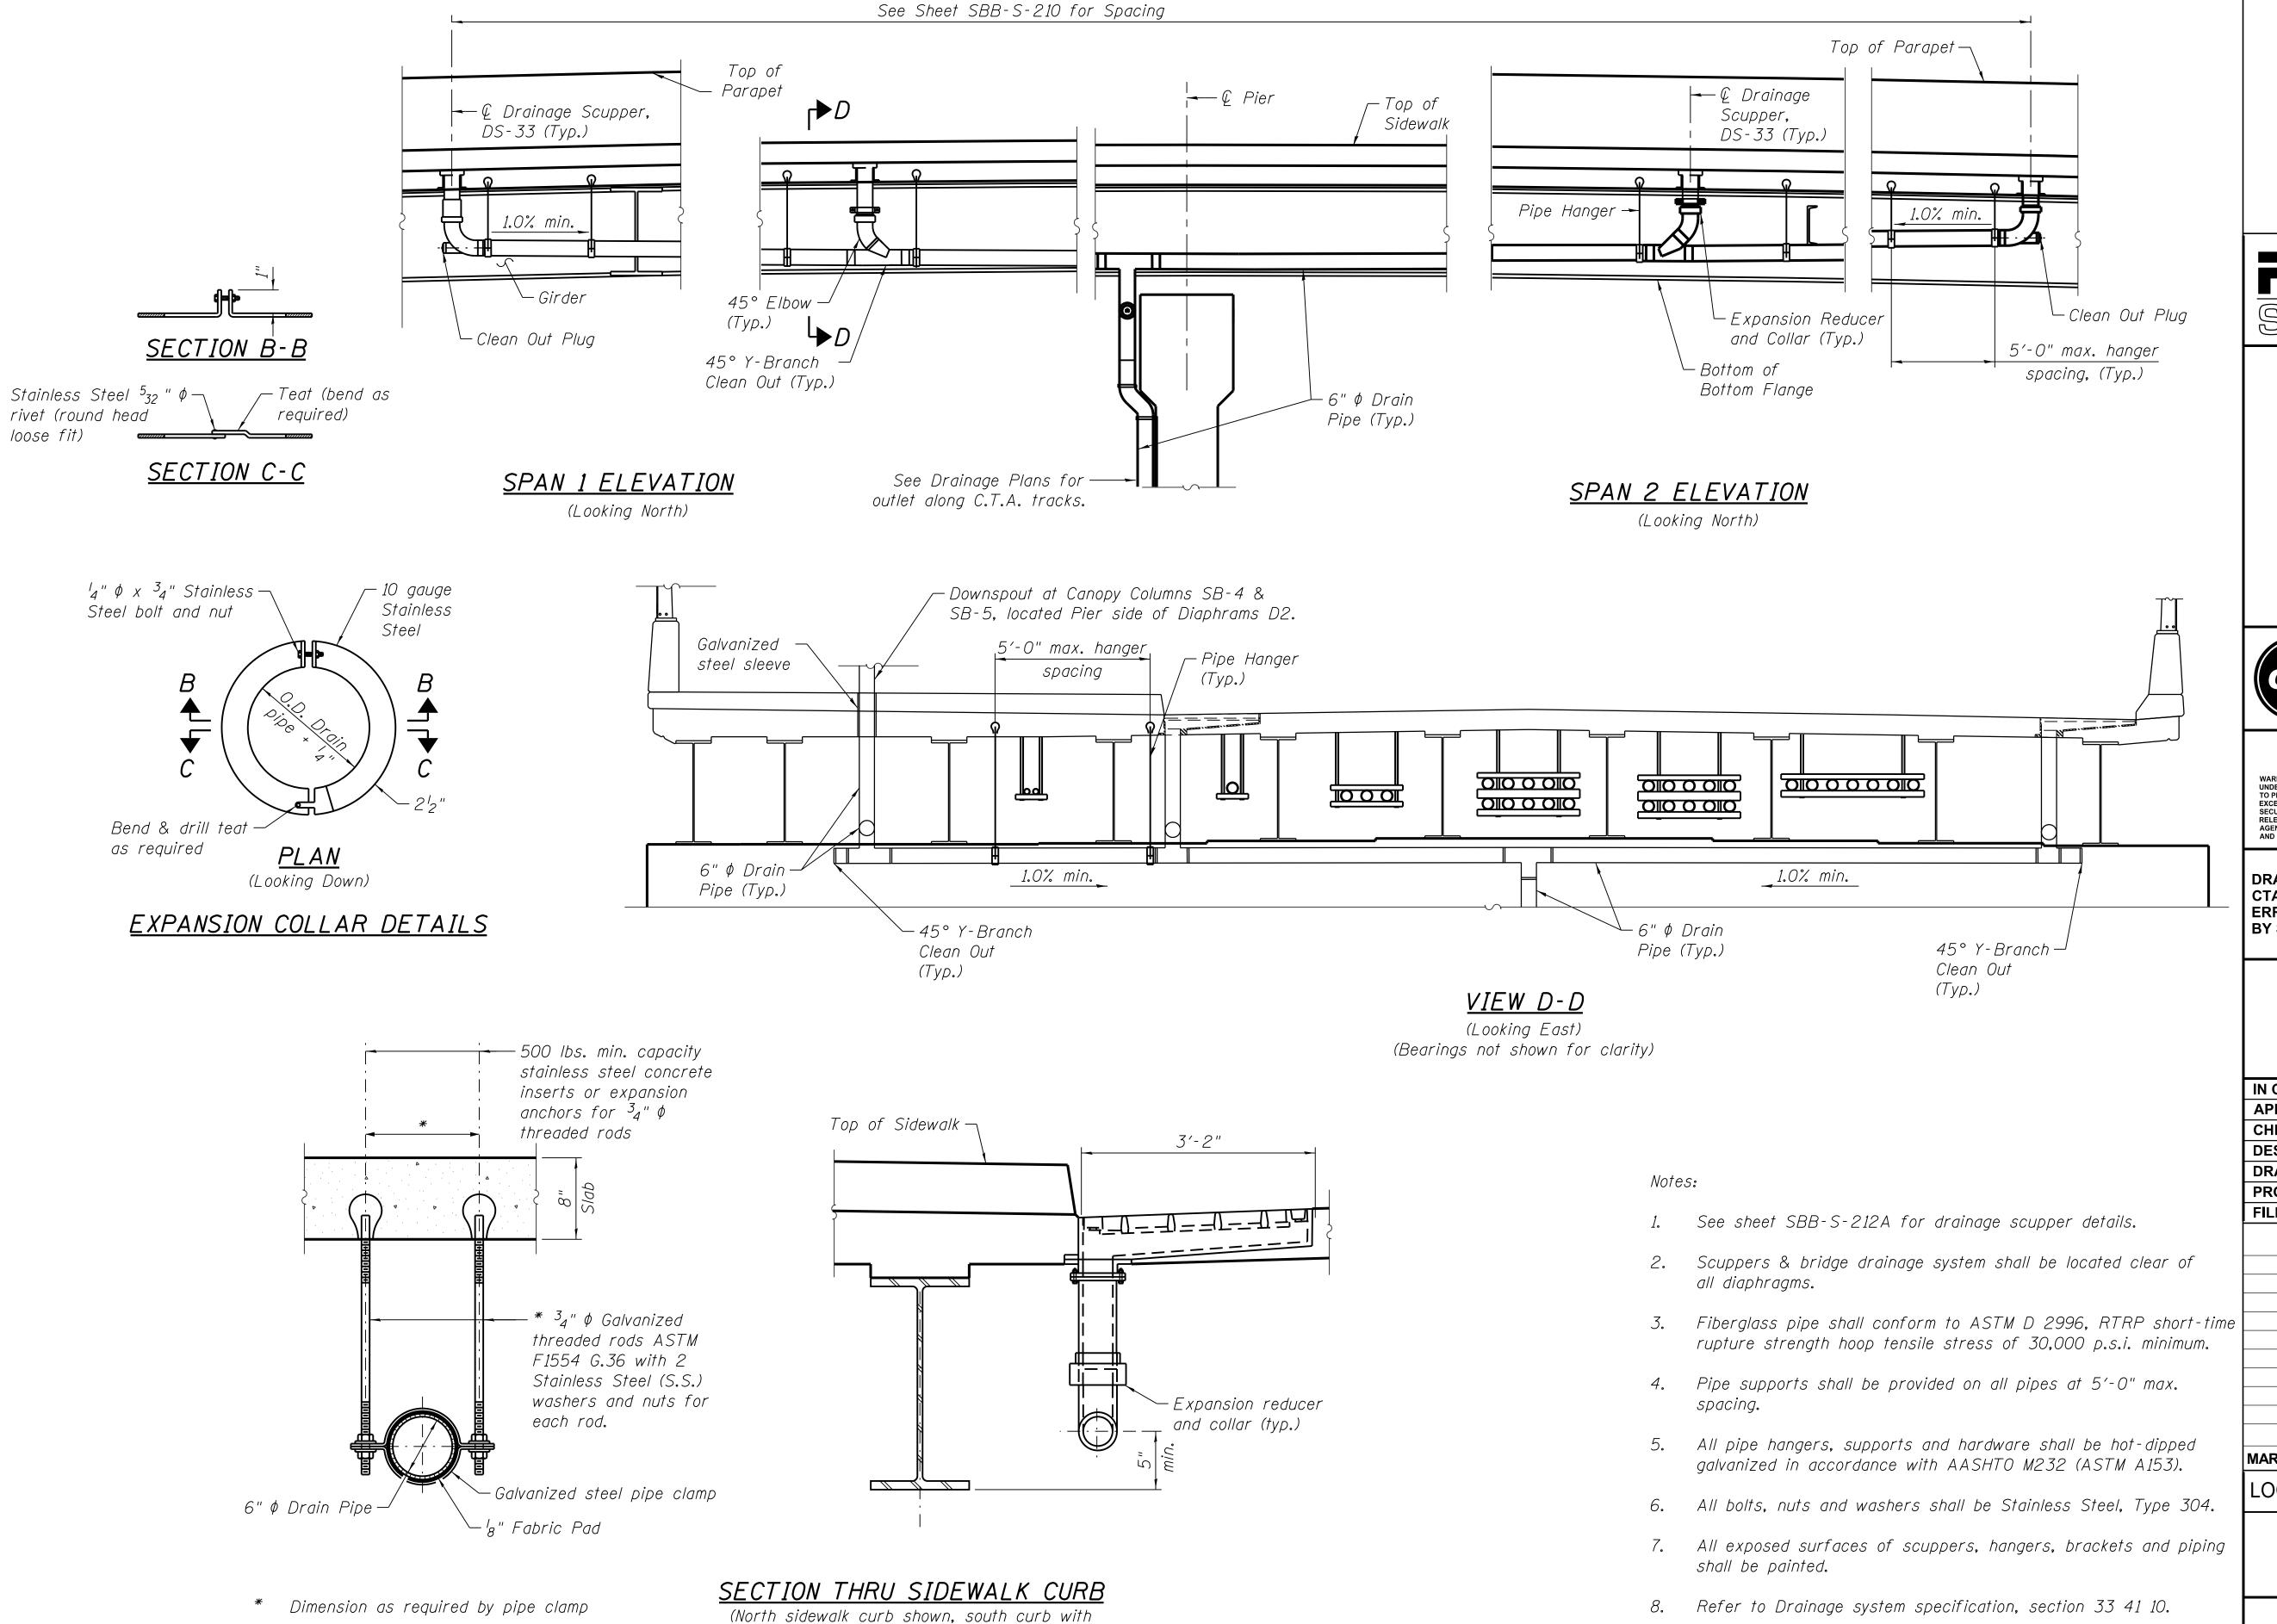

downspout on opposite side)

070\_DR095\_S-212B.dgn 9/12/2016

NAME DATF FFP SIN SEXP



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# 95th Terminal Improvement

15 West 95th Street (South Terminal) Chicago, IL 60628

	IN CHARGE		S. KADERBEK
	APPROVED BY CHECKED BY		D.ZROKA
			P.MAID
	DESIG	SNED BY	L.SOMMER
	DRAV	VN BY	T.SLEDGE
	PROJ	ECT NO.	2012-0021
	FILE N	NAME	File Name
		0/0/47	IONUED FOR CONCEDUCTION
		2/9/17	ISSUED FOR CONSTRUCTION
	MARK	DATE	DESCRIPTION
		ATION ID	ENITIFIED: DDAGE

LOCATION IDENTIFIER: DR095

SOUTH BUS BRIDGE CLOSED DRAINAGE SYSTEM

**SBB-S-212B** 

INTERIOR GIRD	ER MON	MENT TABLE (GIRDER 2	AND 3)
		0.4 Sp. 1 or 0.6 Sp. 2	Pier
$I_{\mathcal{S}}$	(in <sup>4</sup> )	16,872	41,269
$I_c(n)$	(in4)	37.924	_
$I_c(3n)$	(in <sup>4</sup> )	28,138	_
$I_c(cr)$	(in4)	_	44.941
S <sub>5</sub>	(in <sup>3</sup> )	823	1,876
Sc(n)	(in <sup>3</sup> )	1,081	_
Sc(3n)	(in³)	992	_
Sc(cr)	(in <sup>3</sup> )	_	1,934
DC1	(k/')	.768	.989
M DC1	('k)	1160	1891
DC2	(k/')	.390	.390
M DC2	('k)	315	543
DW	(k/')	.160	.160
MDW	('k)	129	223
M4 + W + S	('k)	2034	2868
Mu (Strength )	('k)	4070	6245
$\phi_f M_{\Omega}$	('k)	5196	_
f <sub>s</sub> DC1	(ksi)	16.90	12.09
f <sub>s</sub> DC2	(ksi)	3.81	3.37
f <sub>s</sub> DW	(ksi)	1.56	1.38
fs (4+W+S)	(ksi)	17.33	13.68
fs (Service)	(ksi)	39.60	30.52
0.95R <sub>h</sub> F <sub>yf</sub>	(ksi)	47.5	47.5
fs (Total)(Strength)	(ksi)	_	39.20
$\phi_f F_n$	(ksi)	_	50.0
Vf	(k)	53.0	52.6

INTERIOR	GIRDER	REACTION	TABLE	GIRDER 1, 4-10)
		Abut.		Pier
R DC1	(k)	30.3		110.9
RDC2	(k)	15.3		53.5
Row	(k)	6.3		21.9
R4 + IM	(k)	77.1		156.8
RTotal	(k)	129.0		343.1

INTERIOR	GIRDE	R REACTION TABLE	(GIRDER 2 AND 3)
		Abut.	Pier
R <sub>DC1</sub>	(k)	60.3	166.8
R <sub>DC2</sub>	(k)	15.2	51.5
Row	(k)	6.3	21.1
R4 + W + S	(k)	82.2	157.0
RTotal	(k)	164 0	396 4

#### TOP OF WEB ELEVATIONS

(FOR FABRICATION ONLY)

GIRDER	<i>ℚ BRG.</i> W. ABUT.	© SPLICE 1	© PIER 1	© SPLICE 2	ℚ BRG. E. ABUT.
1	17.036	19.603	19.904	19.943	20.385
2	17.028	19.547	19.840	19.890	20.385
3	17.012	19.539	19.839	19.889	20.385
4	16.997	19.584	19.900	19.939	20.385
5	17.038	19.632	19.954	19.994	20.442
6	17.105	19.706	20.034	20.073	20.523
7	17.093	19.701	20.036	20.075	20.527
8	16.997	19.612	19.953	19.992	20.446
9	16.893	19.515	19.863	19.902	20.357
10	16.770	19.398	19.753	19.793	20.249

#### TOP OF BEAM ELEVATIONS


(FOR FABRICATION ONLY)

BEAM	ℚ BRG. W. ABUT.	End
1 W	17.178	17.692
2W	17.165	17.349
3W	17.153	17.521

BEAM	Start	ℚ BRG. E. ABUT.
1E	20.480	20.489
2E	20.507	20.489
3E	20.502	20.489

#### CAMBER TABLE

GIRDER	Α	В	С	D	Ε	F	G	Н	I	J										
1	2"	3¼"	2"	1/2"	1/2"	1/2"	2"	23/4"	2"	4-EQ. Spa. @ 20′-0′2″(-)=80′-2′ <sub>16</sub> ″										
2	21/4"	4"	21/4"	17"	1,''	17"	2 <sup>3</sup> ⁄₄"	3 <sup>1</sup> / <sub>6</sub> "	2 <sup>3</sup> ⁄₄"	4-EQ. Spa. @ 20'-1' <sub>8</sub> "(-)=80'-4 <sup>7</sup> <sub>16</sub> "										
3	∠ 1⁄4	4	Z 7/4	1/2"	1/2"	1/2"	Z 94	5/2	2%	4-E0. Spa. © 20′-2³ <sub>16</sub> "(-)=80′-8³ <sub>4</sub> "										
4										4-EQ. Spa. @ 20′-3′ <sub>4</sub> ″(-)=81′-1′ <sub>16</sub> ″										
5										4-E0. Spa. © 20′-4 <sup>3</sup> 8"(-)=81′-5 <sup>7</sup> 16"										
6	7 , 3,"	434"	7"	4 7 4 17	437"	4 3 4 77	434"	434"	434"	434"	. 7 . "	4 3 4 11	4 3 4 77	7,11	7,,,	3,"	"	074"	, , , , , , , , , , , , , , , , , , ,	4-E0. Spa. © 20′-5 <sup>7</sup> <sub>16</sub> "(-)=81′-9 <sup>3</sup> 4"
7	1¾"	3"	1¾"	3/4"	3/4"	3/4"	2"	2¾"	2"	4-E0. Spa. @ 20′-6½"(-)=82′-2½"										
8										4-E0. Spa. © 20′-7 <sup>5</sup> 8″(-)=82′-6 <sup>3</sup> 8″										
9										4-E0. Spa. ◎ 20′-8″ <sub>16</sub> ″(-)=82′-10″ <sub>16</sub> ″										
10										4-E0. Spa. © 20′-9³₄"(-)=83′-3"										

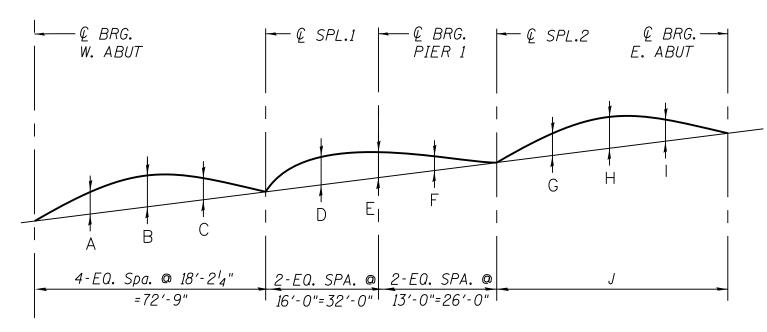

CAMBER DIAGRAM
SCALE: N.T.S.

 $I_s$ ,  $S_s$ : Non-composite moment of inertia and section modulus of the steel section used for computing  $f_s$  (Total-Strength, and Service) due to non-composite dead loads (in.<sup>4</sup> and in.<sup>3</sup>).

 $I_c(n)$ ,  $S_c(n)$ : Composite moment of inertia and section modulus of the steel and deck based upon the modular ratio, "n", used for computing  $f_s$  (Total-Strength, and Service) in uncracked sections due to short-term composite live loads (in.4 and in.3).

 $I_c(3n)$ ,  $S_c(3n)$ : Composite moment of inertia and section modulus of the steel and deck based upon 3 times the modular ratio, "3n", used for computing  $f_s$  (Total-Strength, and Service) in uncracked sections, due to long-term composite (superimposed) dead loads (in.4 and in.3).

 $I_c(cr)$ ,  $S_c(cr)$ : Composite moment of inertia and section modulus of the steel and longitudinal deck reinforcement, used for computing f (Total-Strength and Service) in cracked sections, due to both short-term composite live loads and long-term composite (superimposed) dead loads (in.<sup>4</sup> and in.<sup>3</sup>).

DC1: Un-factored non-composite dead load (kips/ft.).

Mpc1: Un-factored moment due to non-composite dead load (kip-ft.). DC2: Un-factored long-term composite (superimposed excluding future wearing surface) dead load (kips/ft.).

MDC2: Un-factored moment due to long-term composite (superimposed excluding future wearing surface) dead load (kip-ft.).

DW: Un-factored long-term composite (superimposed future wearing surface only) dead load (kips/ft.).

Mow: Un-factored moment due to long-term composite (superimposed future wearing surface only) dead load (kip-ft.).

 $M_{L+IM}$ : Un-factored live load moment plus dynamic load allowance (impact) (kip-ft.).

M4 + w + S: Factored live load moment plus wind load plus snow load (kip-ft.).

Mu (Strength): Factored design moment (kip-ft.).

Strength I: 1.25 ( $M_{DC1}$  +  $M_{DC2}$ ) + 1.5  $M_{DW}$  + 1.75  $M_{\psi}$  +  $M_{ZW}$ 

Strength II: 1.25 ( $M_{DC1} + M_{DC2}$ ) + 1.5  $M_{DW}$  + 1.35  $M_{4+IM}$  + 1.75  $M_{S}$ 

Strength III: 1.25 ( $M_{DC1} + M_{DC2}$ ) + 1.5  $M_{DW} + 1.4 M_W + 0.6 M_S$ 

Strength V: 1.25 ( $M_{DC1}$  +  $M_{DC2}$ ) + 1.5  $M_{DW}$  + 1.35  $M_{L+IM}$ + 0.4  $M_W$  + 0.6  $M_S$   $\phi_f M_n$ : Compact composite positive moment capacity computed according to Article 6.10.7.1 or non-slender negative moment capacity

according to Article A6.1.1 or A6.1.2 (kip-ft).  $f_s$  DC1: Un-factored stress at edge of flange for controlling steel

flange due to vertical non-composite dead loads as calculated below (ksi).

 $M_{DCI}$  /  $S_{nc}$   $f_s$  DC2: Un-factored stress at edge of flange for controlling steel flange due to vertical composite dead loads as calculated below (ksi).

 $M_{DC2}/S_c(3n)$  or  $M_{DC2}/S_c(cr)$  as applicable. fs DW: Un-factored stress at edge of flange for controlling steel flange due to vertical composite future wearing surface

loads as calculated below (ksi). M<sub>DW</sub> / S<sub>c</sub>(3n) or M<sub>DW</sub> / S<sub>c</sub>(cr) as applicable.

 $f_s$  ( ${}^{L_+W+S}$ ): Un-factored stress at edge of flange for controlling steel flange due to vertical composite live load plus wind plus snow as calculated below (ksi).

 $M_{\mbox{$L$}+\mbox{$W$}+\mbox{$S$}}/S_c(n)$  or  $M_{\mbox{$L$}+\mbox{$W$}+\mbox{$S$}}/S_c(cr)$  as applicable.  $f_s$  ( $\mbox{$L$}+IM$ ): Un-factored stress at edge of flange for controlling steel flange due to vertical composite live load plus impact loads as calculated below (ksi).

 $M_{L+IM}$  /  $S_c(n)$  or  $M_{L+IM}$  /  $S_c(cr)$  as applicable.  $f_s$  (Service): Sum of stresses as computed below (ksi).

Service II:  $f_{sDC1} + f_{sDC2} + f_{sDW} + 1.3 f_s (\mu_{+IM}) + 0.6 S$ 

Service IV:  $f_{SDC1} + f_{SDC2} + f_{SDW} + 0.7 W + S$ 

0.95R<sub>h</sub>F<sub>y</sub>f: Composite stress capacity for Service loading according to Article 6.10.4.2 (ksi).

 $f_s$  (Total)(Strength): Sum of stresses as computed below on non-compact section (ksi).

Strength I: 1.25  $(f_{sDC1} + f_{sDC2}) + 1.5 f_{sDW} + 1.75 f_{s}(_{\!\! L} + _{IM})$ Strength II: 1.25  $(f_{sDC1} + f_{sDC2}) + 1.5 f_{sDW} + 1.35 f_{s}(_{\!\! L} + _{IM}) + 1.75 f_{s}s$ Strength III: 1.25  $(f_{sDC1} + f_{sDC2}) + 1.5 f_{sDW} + 1.4 f_{s} + 0.6 f_{s}s$ 

Strength V: 1.25  $(f_{sDC1} + f_{sDC2}) + 1.5 f_{sDW} + 1.35 f_s (4 + 1M) + 0.4 f_s W + 0.6 f_s S$   $\phi_f F_n$ : Non-Compact composite positive or negative stress capacity for

Of the Non-Compact composite positive or negative stress capacity for Strength I loading according to Article 6.10.7 or 6.10.8 (ksi).

Veri Maximum factored shear range in span computed according

Vf: Maximum factored shear range in span computed according to Article 6.10.10.

FFP SNN





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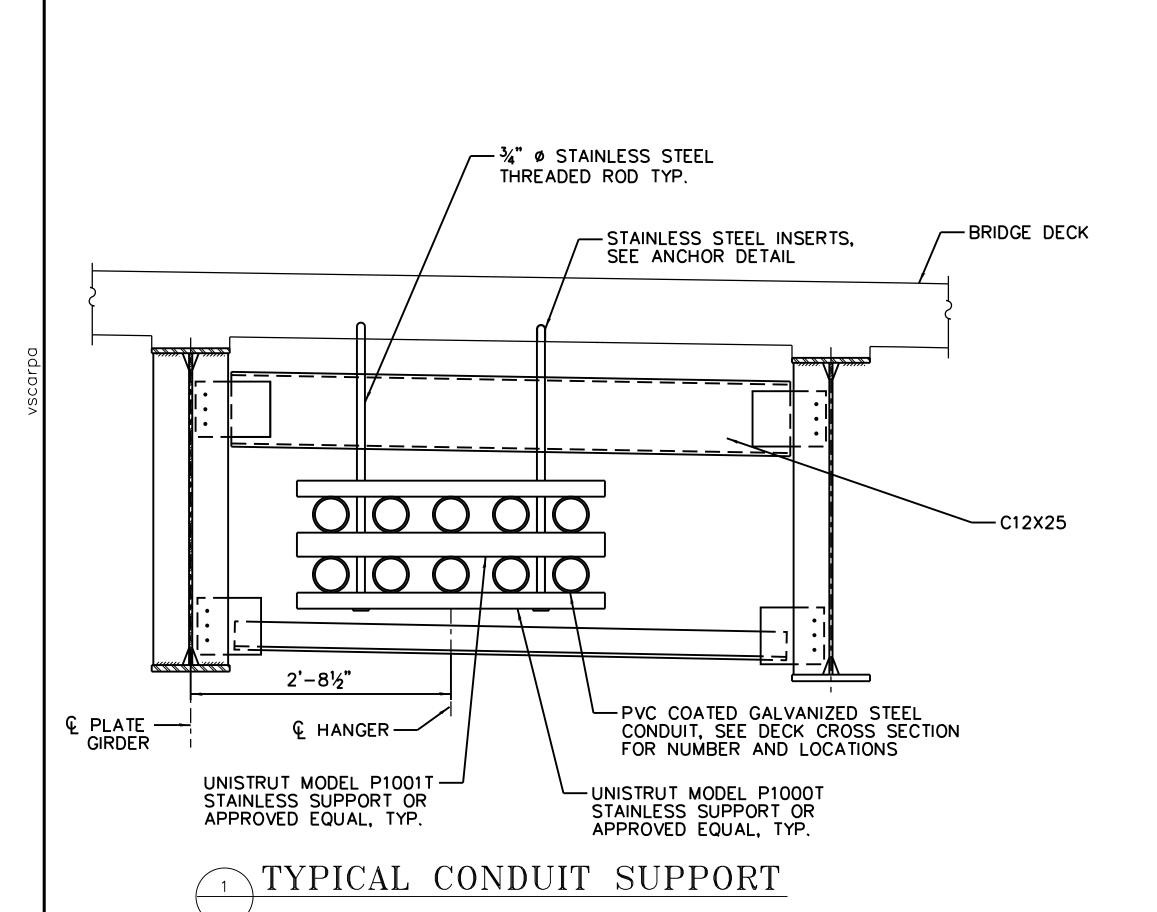
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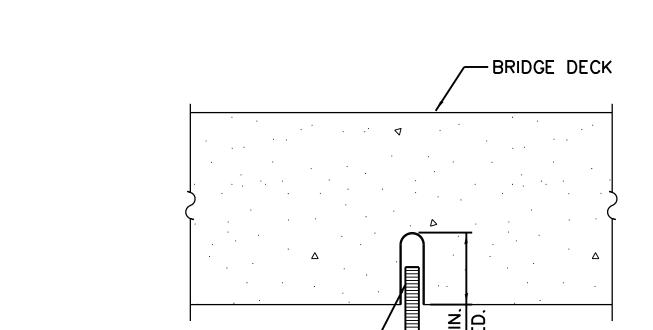
# 95th Terminal Improvement 15 West 95th Street (South Terminal) Chicago, IL 60628

MARK	DATE	DESCRIPTION
	2/9/17	ISSUED FOR CONSTRUCTION
FILE N	IAME	File Name
PROJ	ECT NO.	2012-0021
DRAW	/N BY	T.SLEDGE
DESIG	NED BY	L.SOMMER
CHEC	KED BY	P.MAID
APPR	OVED BY	D.ZROKA
IN CH	ARGE	S. KADERBEK


LOCATION IDENTIFIER: DR095

SOUTH BUS BRIDGE MOMENT & SHEAR TABLES





THREADED ROD INSTALLATION ANCHOR DETAIL

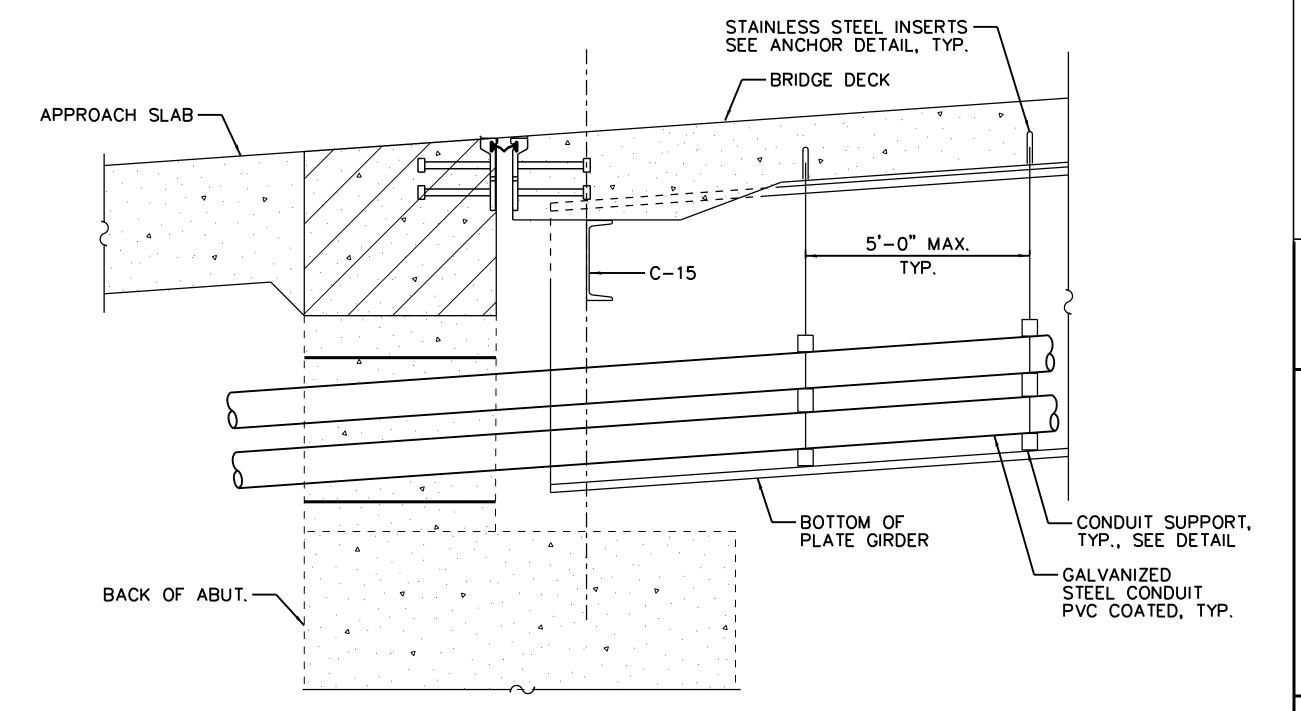

TYPICAL CONDUIT INSTALLATION

#### NOTES:

- THE CONTRACTOR MUST USE APPROVED SINGLE STRAIGHT COIL LOOP INSERTS WHEN PENDANT MOUNTING THREADED RODS TO A NEW BRIDGE DECK. THE FLARED LOOP INSERTS MUST BE CAST INTO THE CONCRETE DECK.
- 2. THE BRIDGE CONTRACTOR SHALL COORDINATE THE CONCRETE INSERTS.
- CONDUIT SHALL NOT COME INTO CONTACT WITH ANY BRACING OR OTHER STRUCTURAL MEMBERS.
- 4. CONDUIT SHALL BE SUPPORTED AT A MAXIMUM INTERVAL OF 5'. SUPPORTS SHALL BE LOCATED A MAXIMUM OF 3' AWAY FROM A CONNECTION.
- 5. ALL HARDWARE SHALL BE STAINLESS STEEL UNLESS NOTED OTHERWISE.





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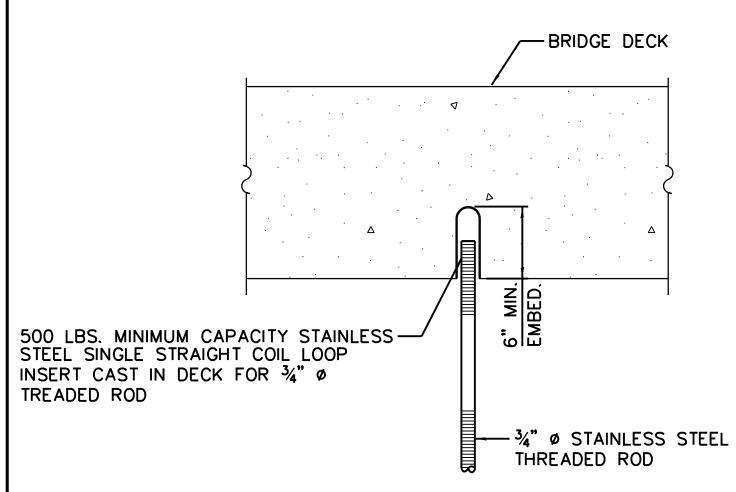
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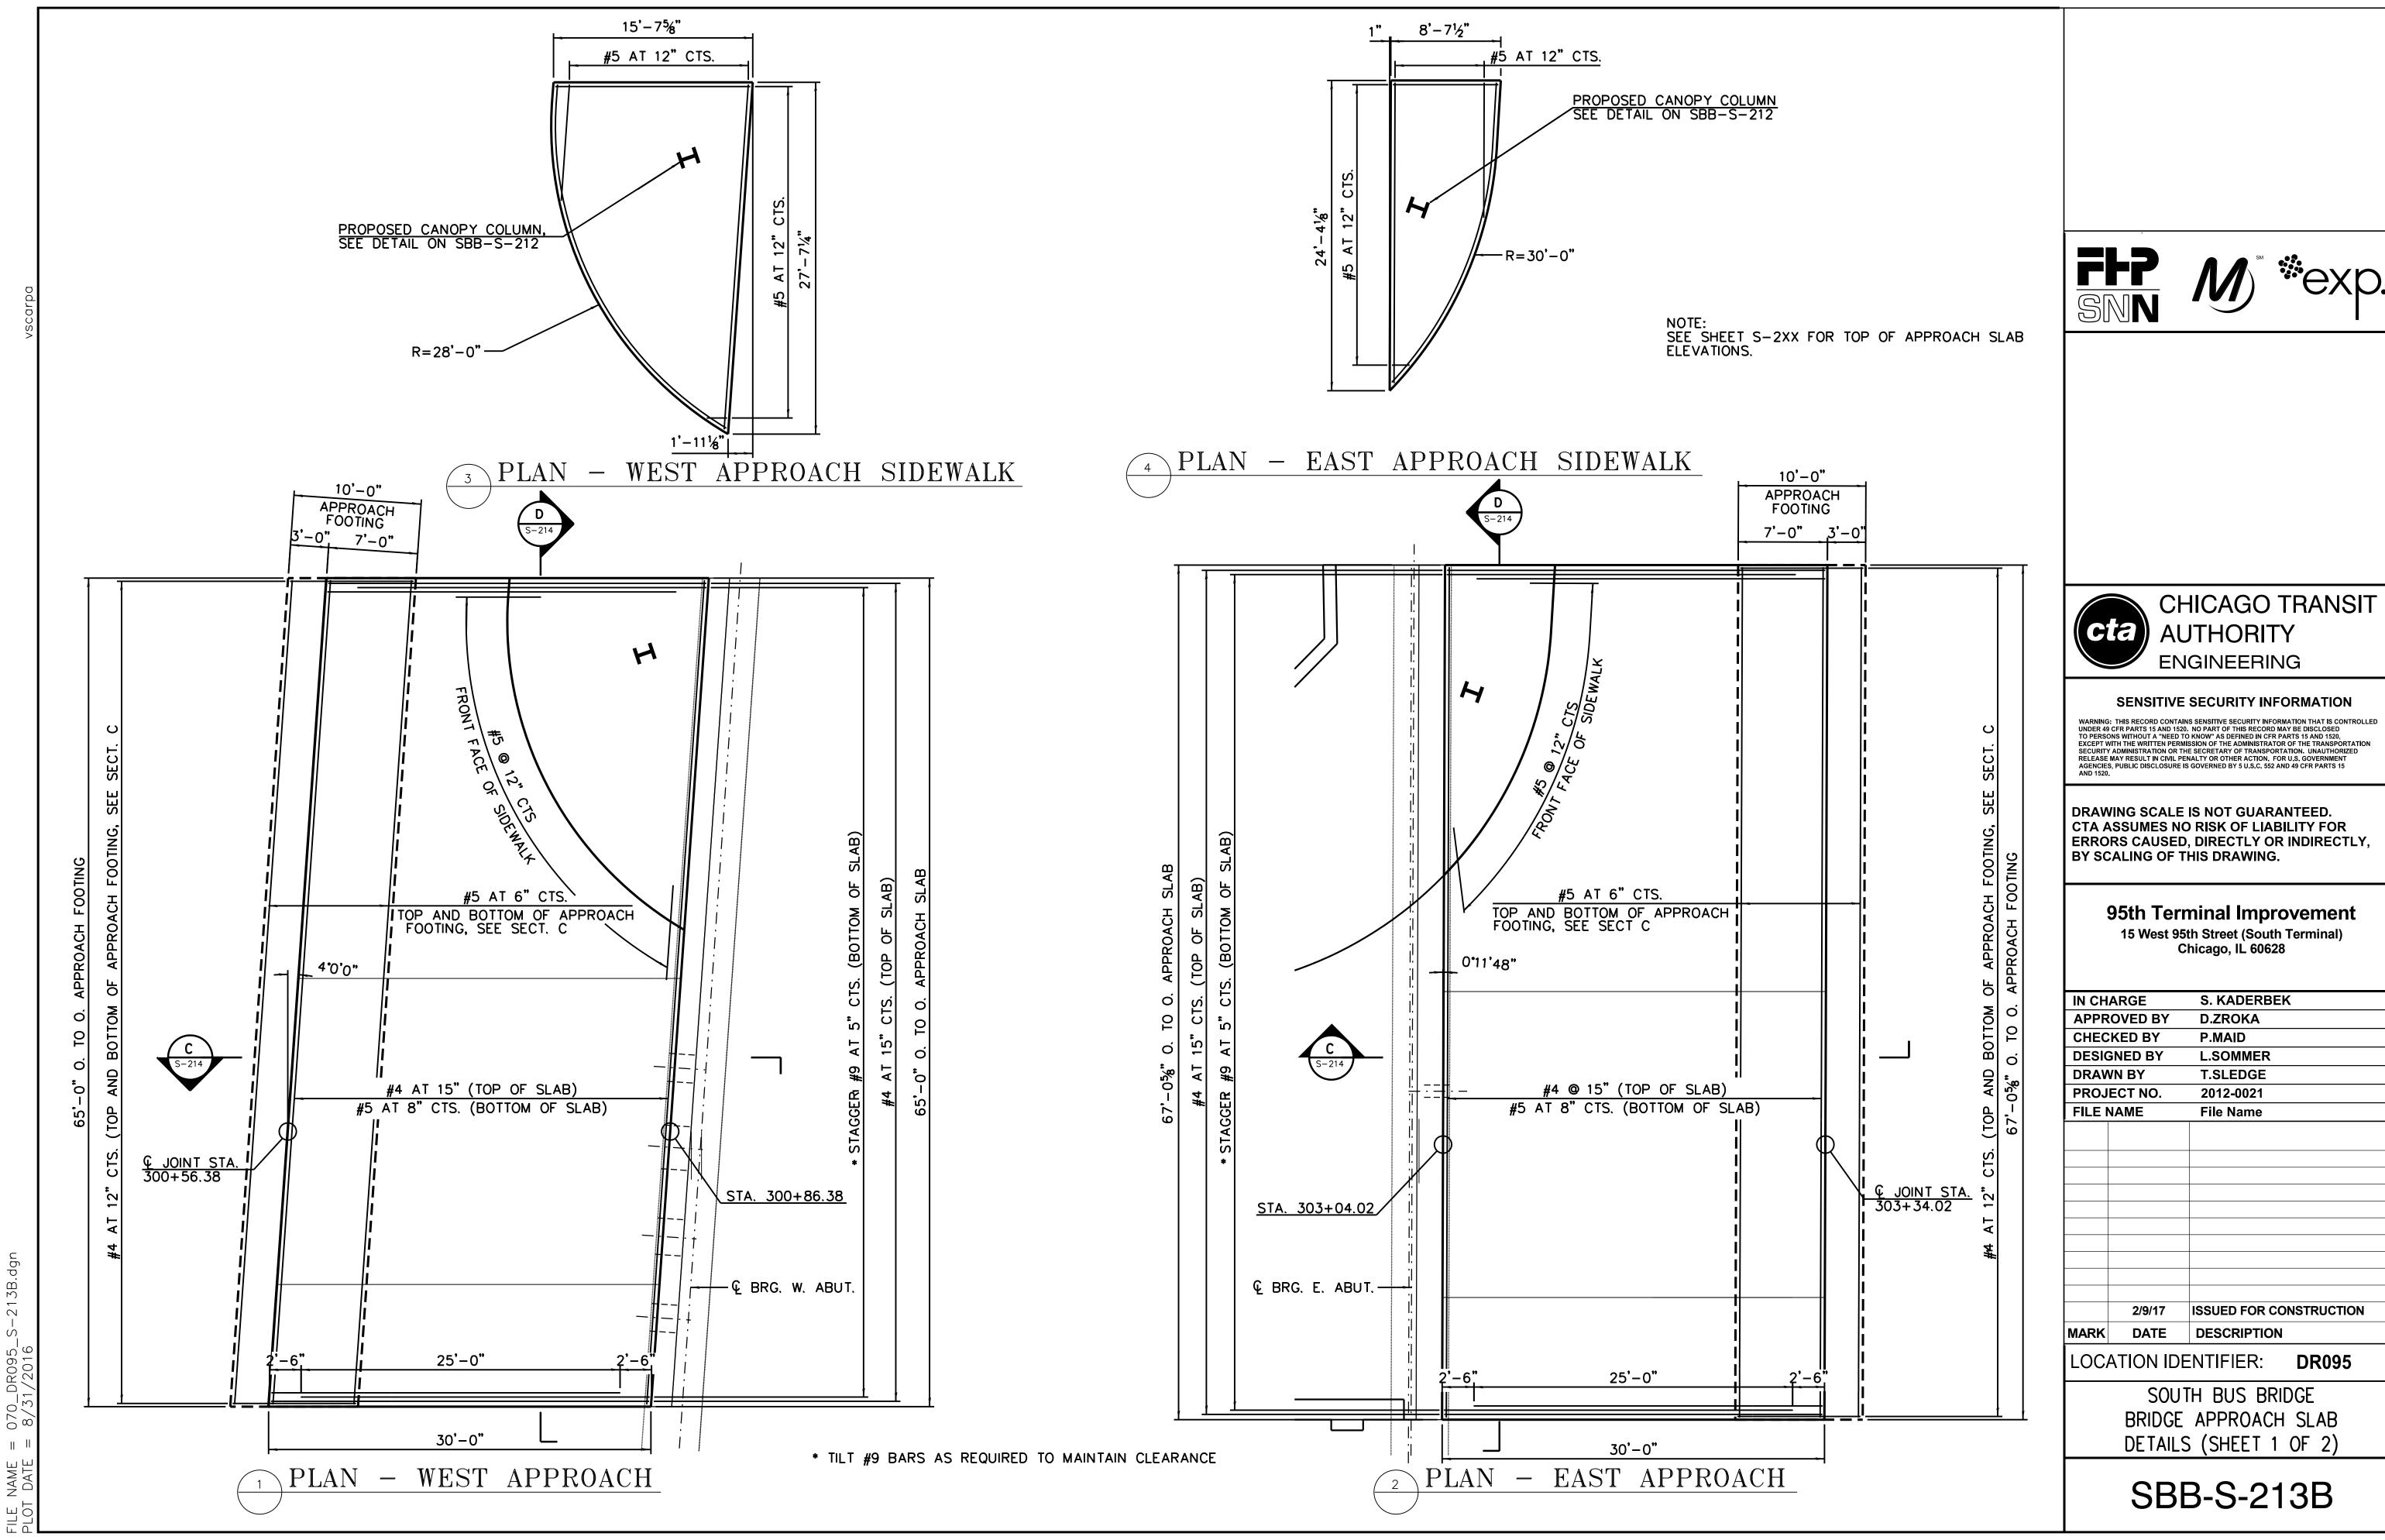
IN CH	ARGE	S. KADERBEK		
APPR	OVED BY	D.ZROKA		
CHEC	KED BY	P.MAID		
DESIC	SNED BY	L.SOMMER		
DRAV	VN BY	T.SLEDGE		
PROJ	ECT NO.	2012-0021		
FILE N	NAME	File Name		
	2/9/17	ISSUED FOR CONSTRUCTION		
//ARK	DATE	DESCRIPTION		
OCATION IDENTIFIER: DR095				

LOCATION IDENTIFIER.

SOUTH BUS BRIDGE CONDUIT HANGER DETAIL


SBB-S-213A









IN CH	ARGE	S. KADERBEK
APPR	OVED BY	D.ZROKA
CHEC	KED BY	P.MAID
DESIG	GNED BY	L.SOMMER
DRAV	VN BY	T.SLEDGE
PROJ	ECT NO.	2012-0021
FILE I	NAME	File Name
	2/9/17	ISSUED FOR CONSTRUCTION
MARK	DATE	DESCRIPTION
LOC	ATION IDE	ENTIFIER: <b>DR095</b>

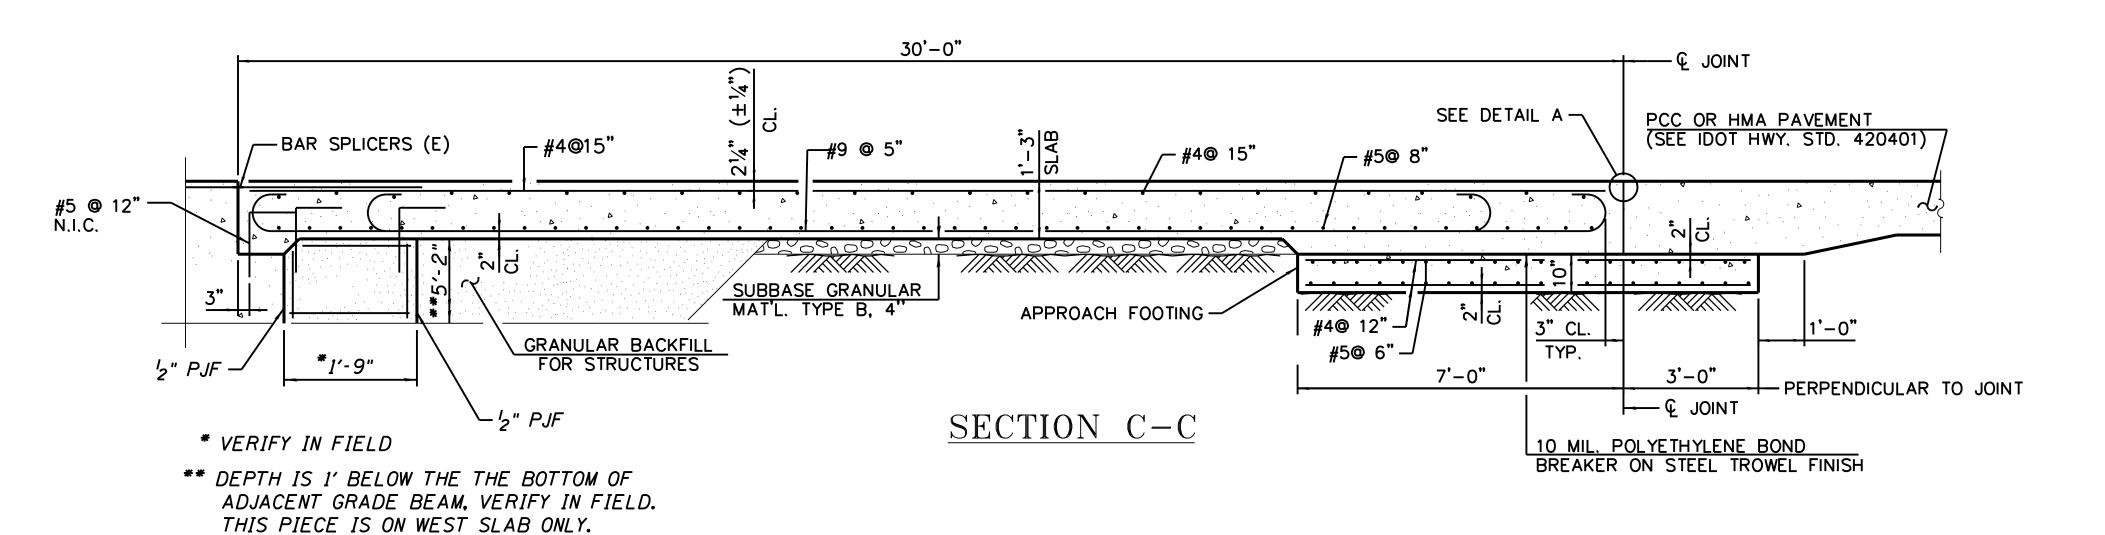

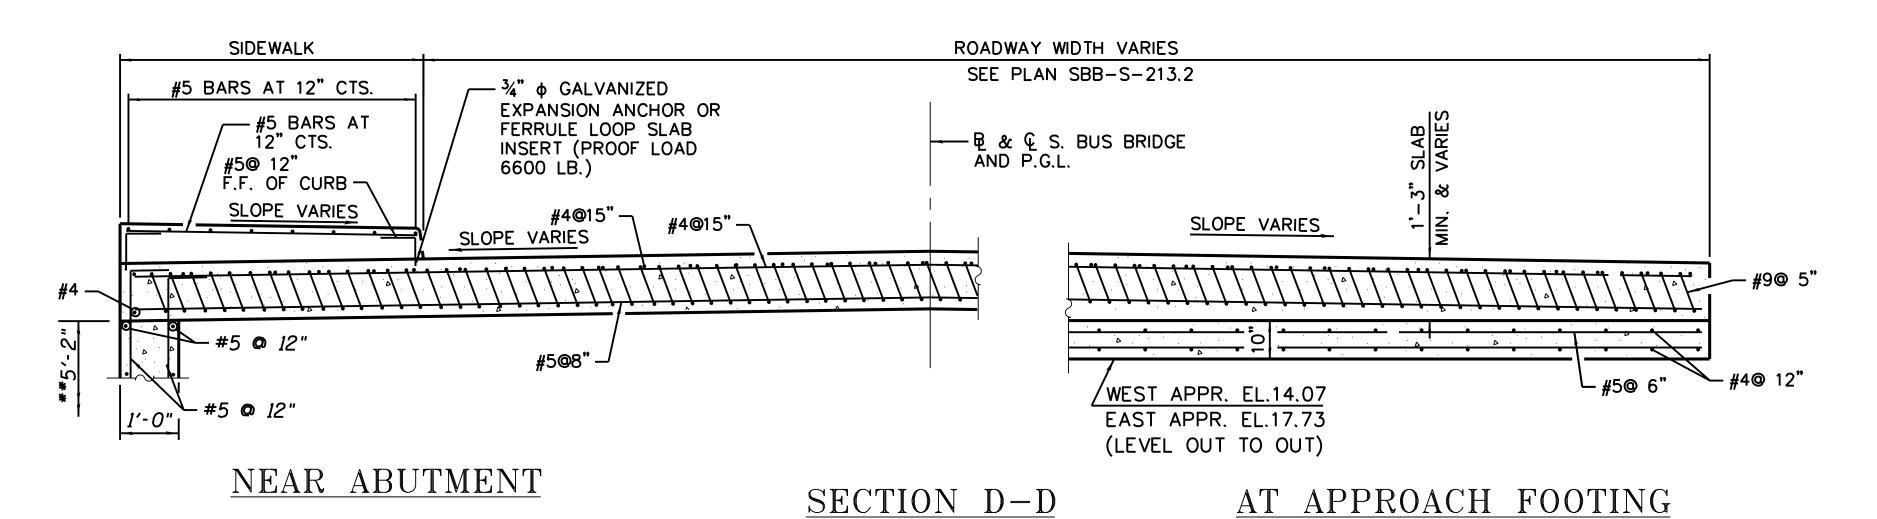


(SEE PLAN FOR DIMENSIONS NOT SHOWN)

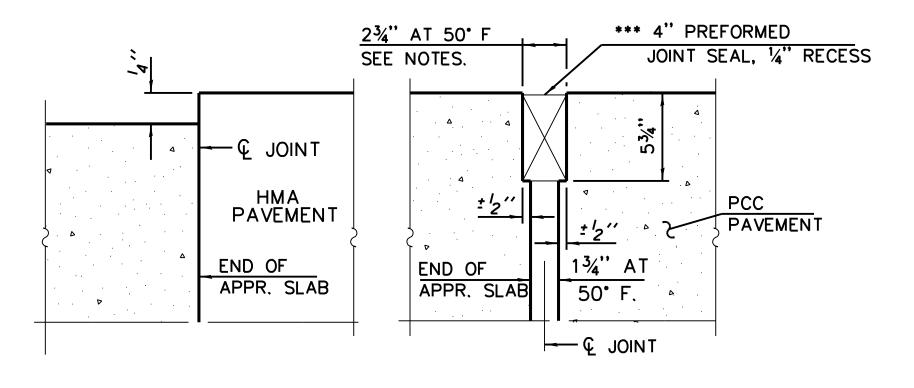

FLEXIBLE PAVEMENT

RIGID PAVEMENT

DETAIL A

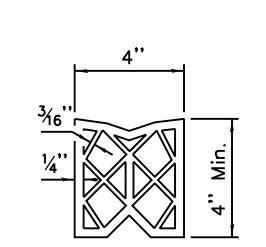

PREFORMED JOINT SEAL

(QMAX) = 2.0 KSF.

SEE PLAN FOR DIMENSIONS NOT SHOWN.

TILT #9 BARS AS REQUIRED TO MAINTAIN CLEARANCE.

THE APPROACH FOOTING MAXIMUM APPLIED SERVICE BEARING PRESSURE



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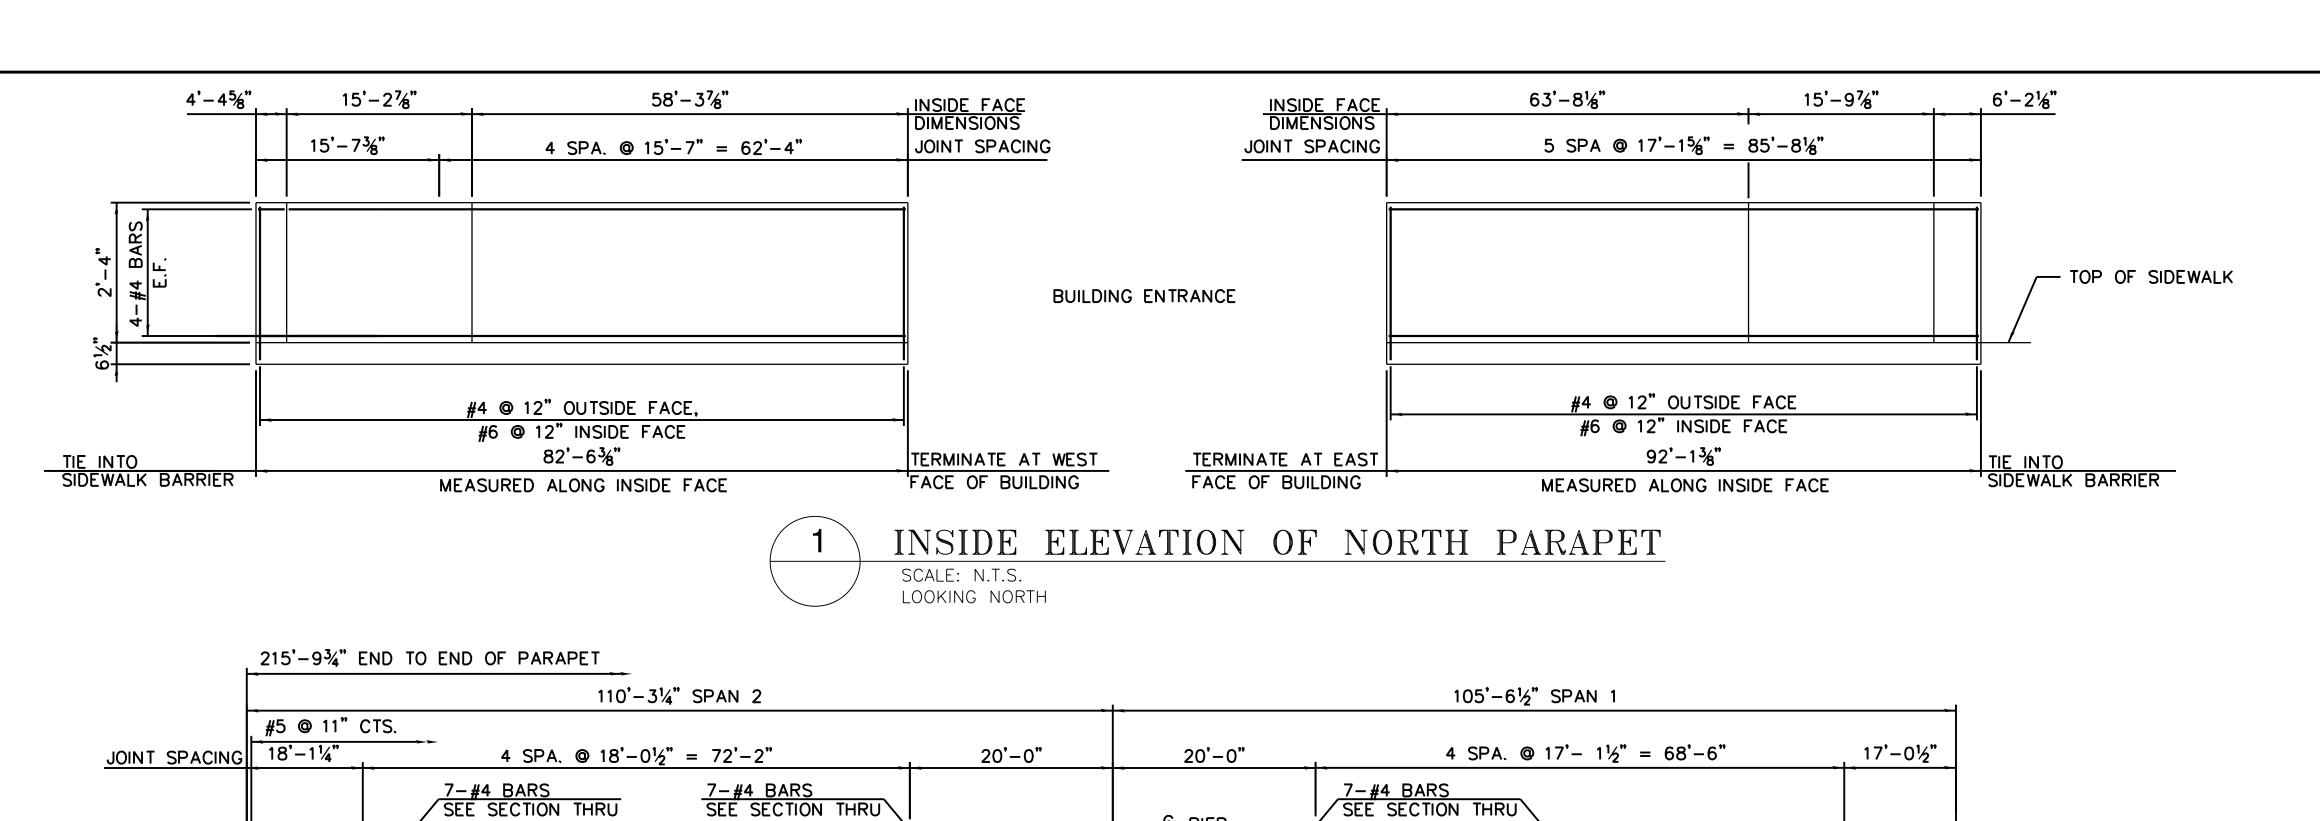
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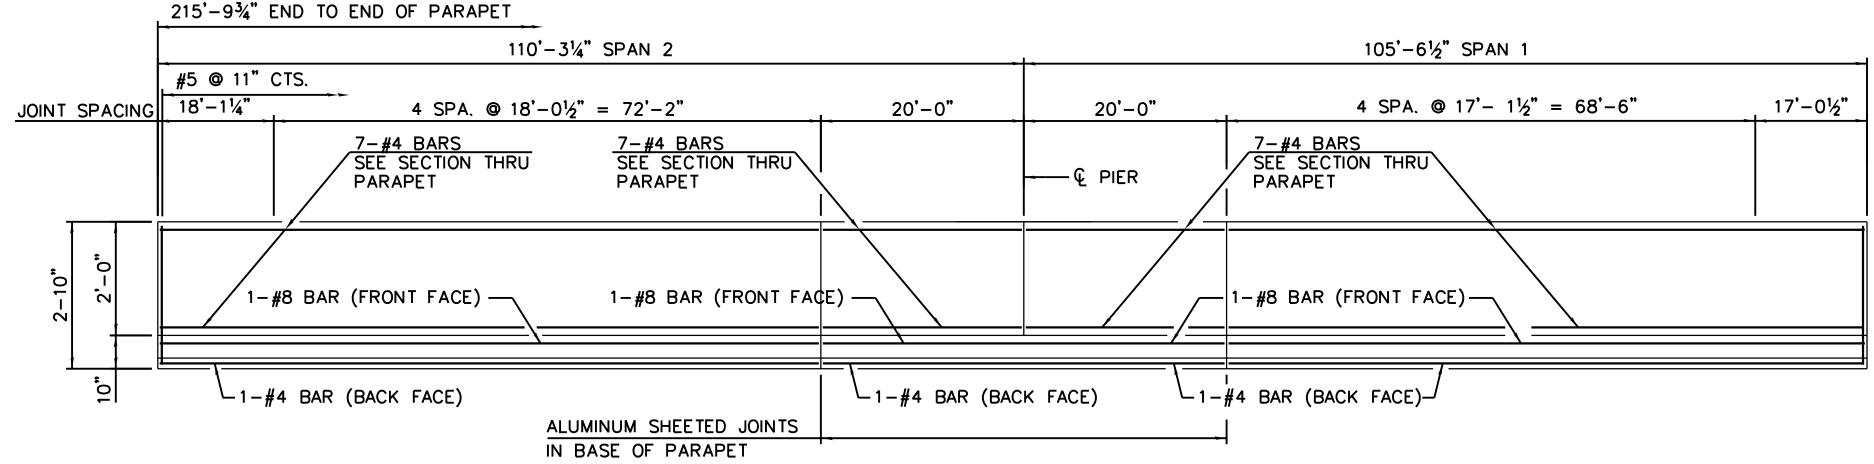
15 West 95th Street (South Terminal) Chicago, IL 60628

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	<del>*************************************</del>	
FILE		File Name
	ECT NO.	2012-0021
	/N BY	T.SLEDGE
	ENED BY	L.SOMMER
	KED BY	P.MAID
	OVED BY	S. KADERBEK D.ZROKA


LOCATION IDENTIFIER: **DR095** 

> SOUTH BUS BRIDGE BRIDGE APPROACH SLAB DETAILS (SHEET 2 OF 2)







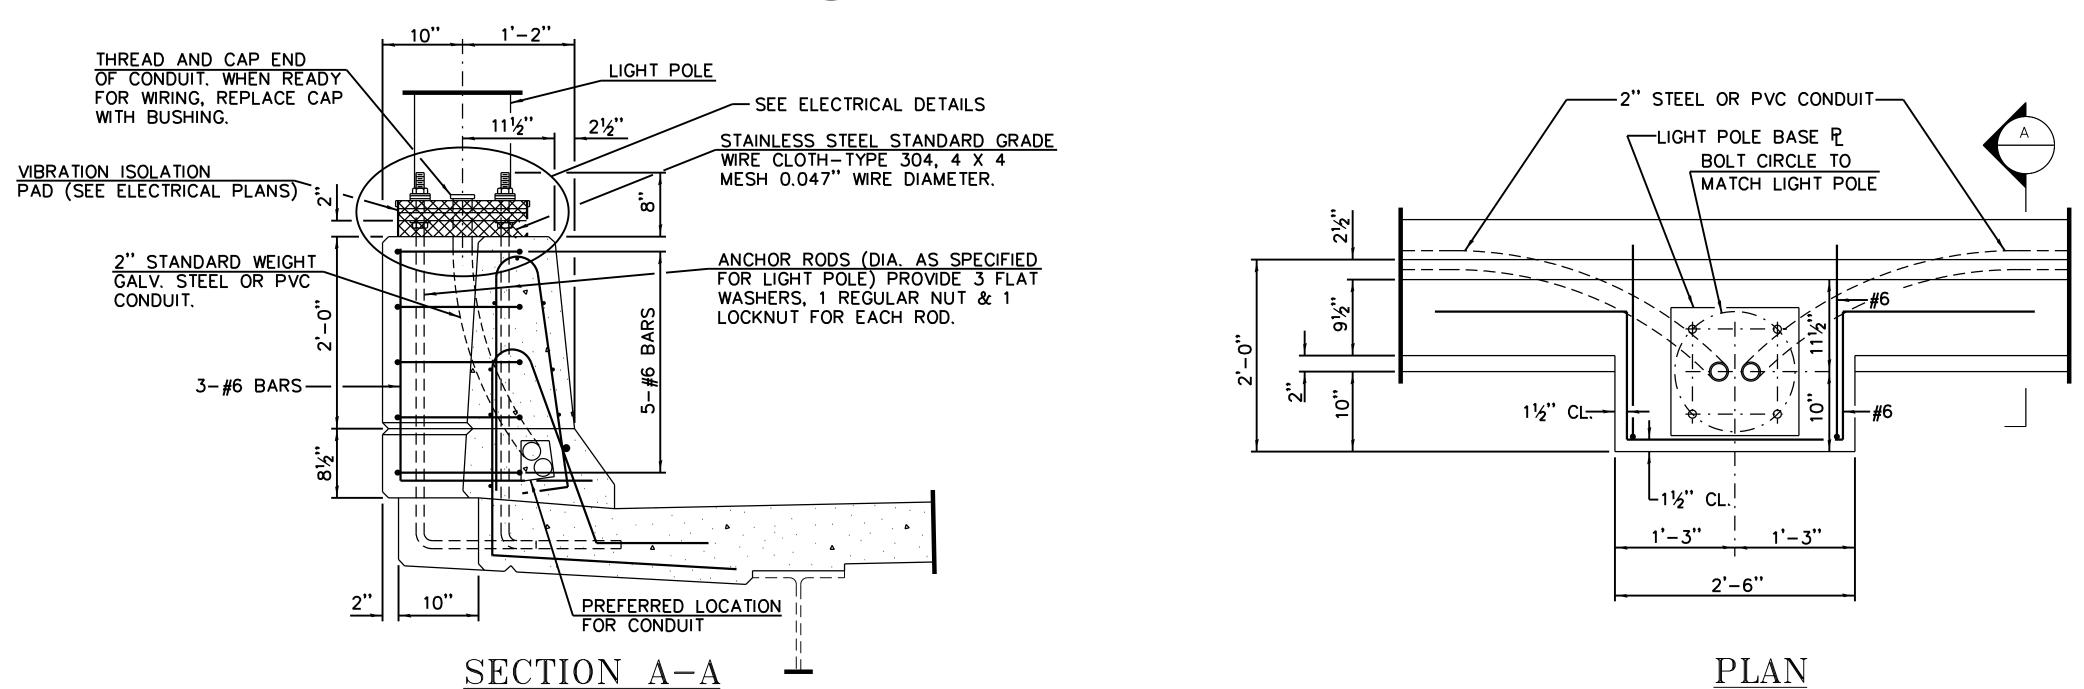

MINIMUM B	SAR LAPS
BARS	LAPS
#4	2'-7"
<b>#</b> 5	3'-3"
#6	3'-10"





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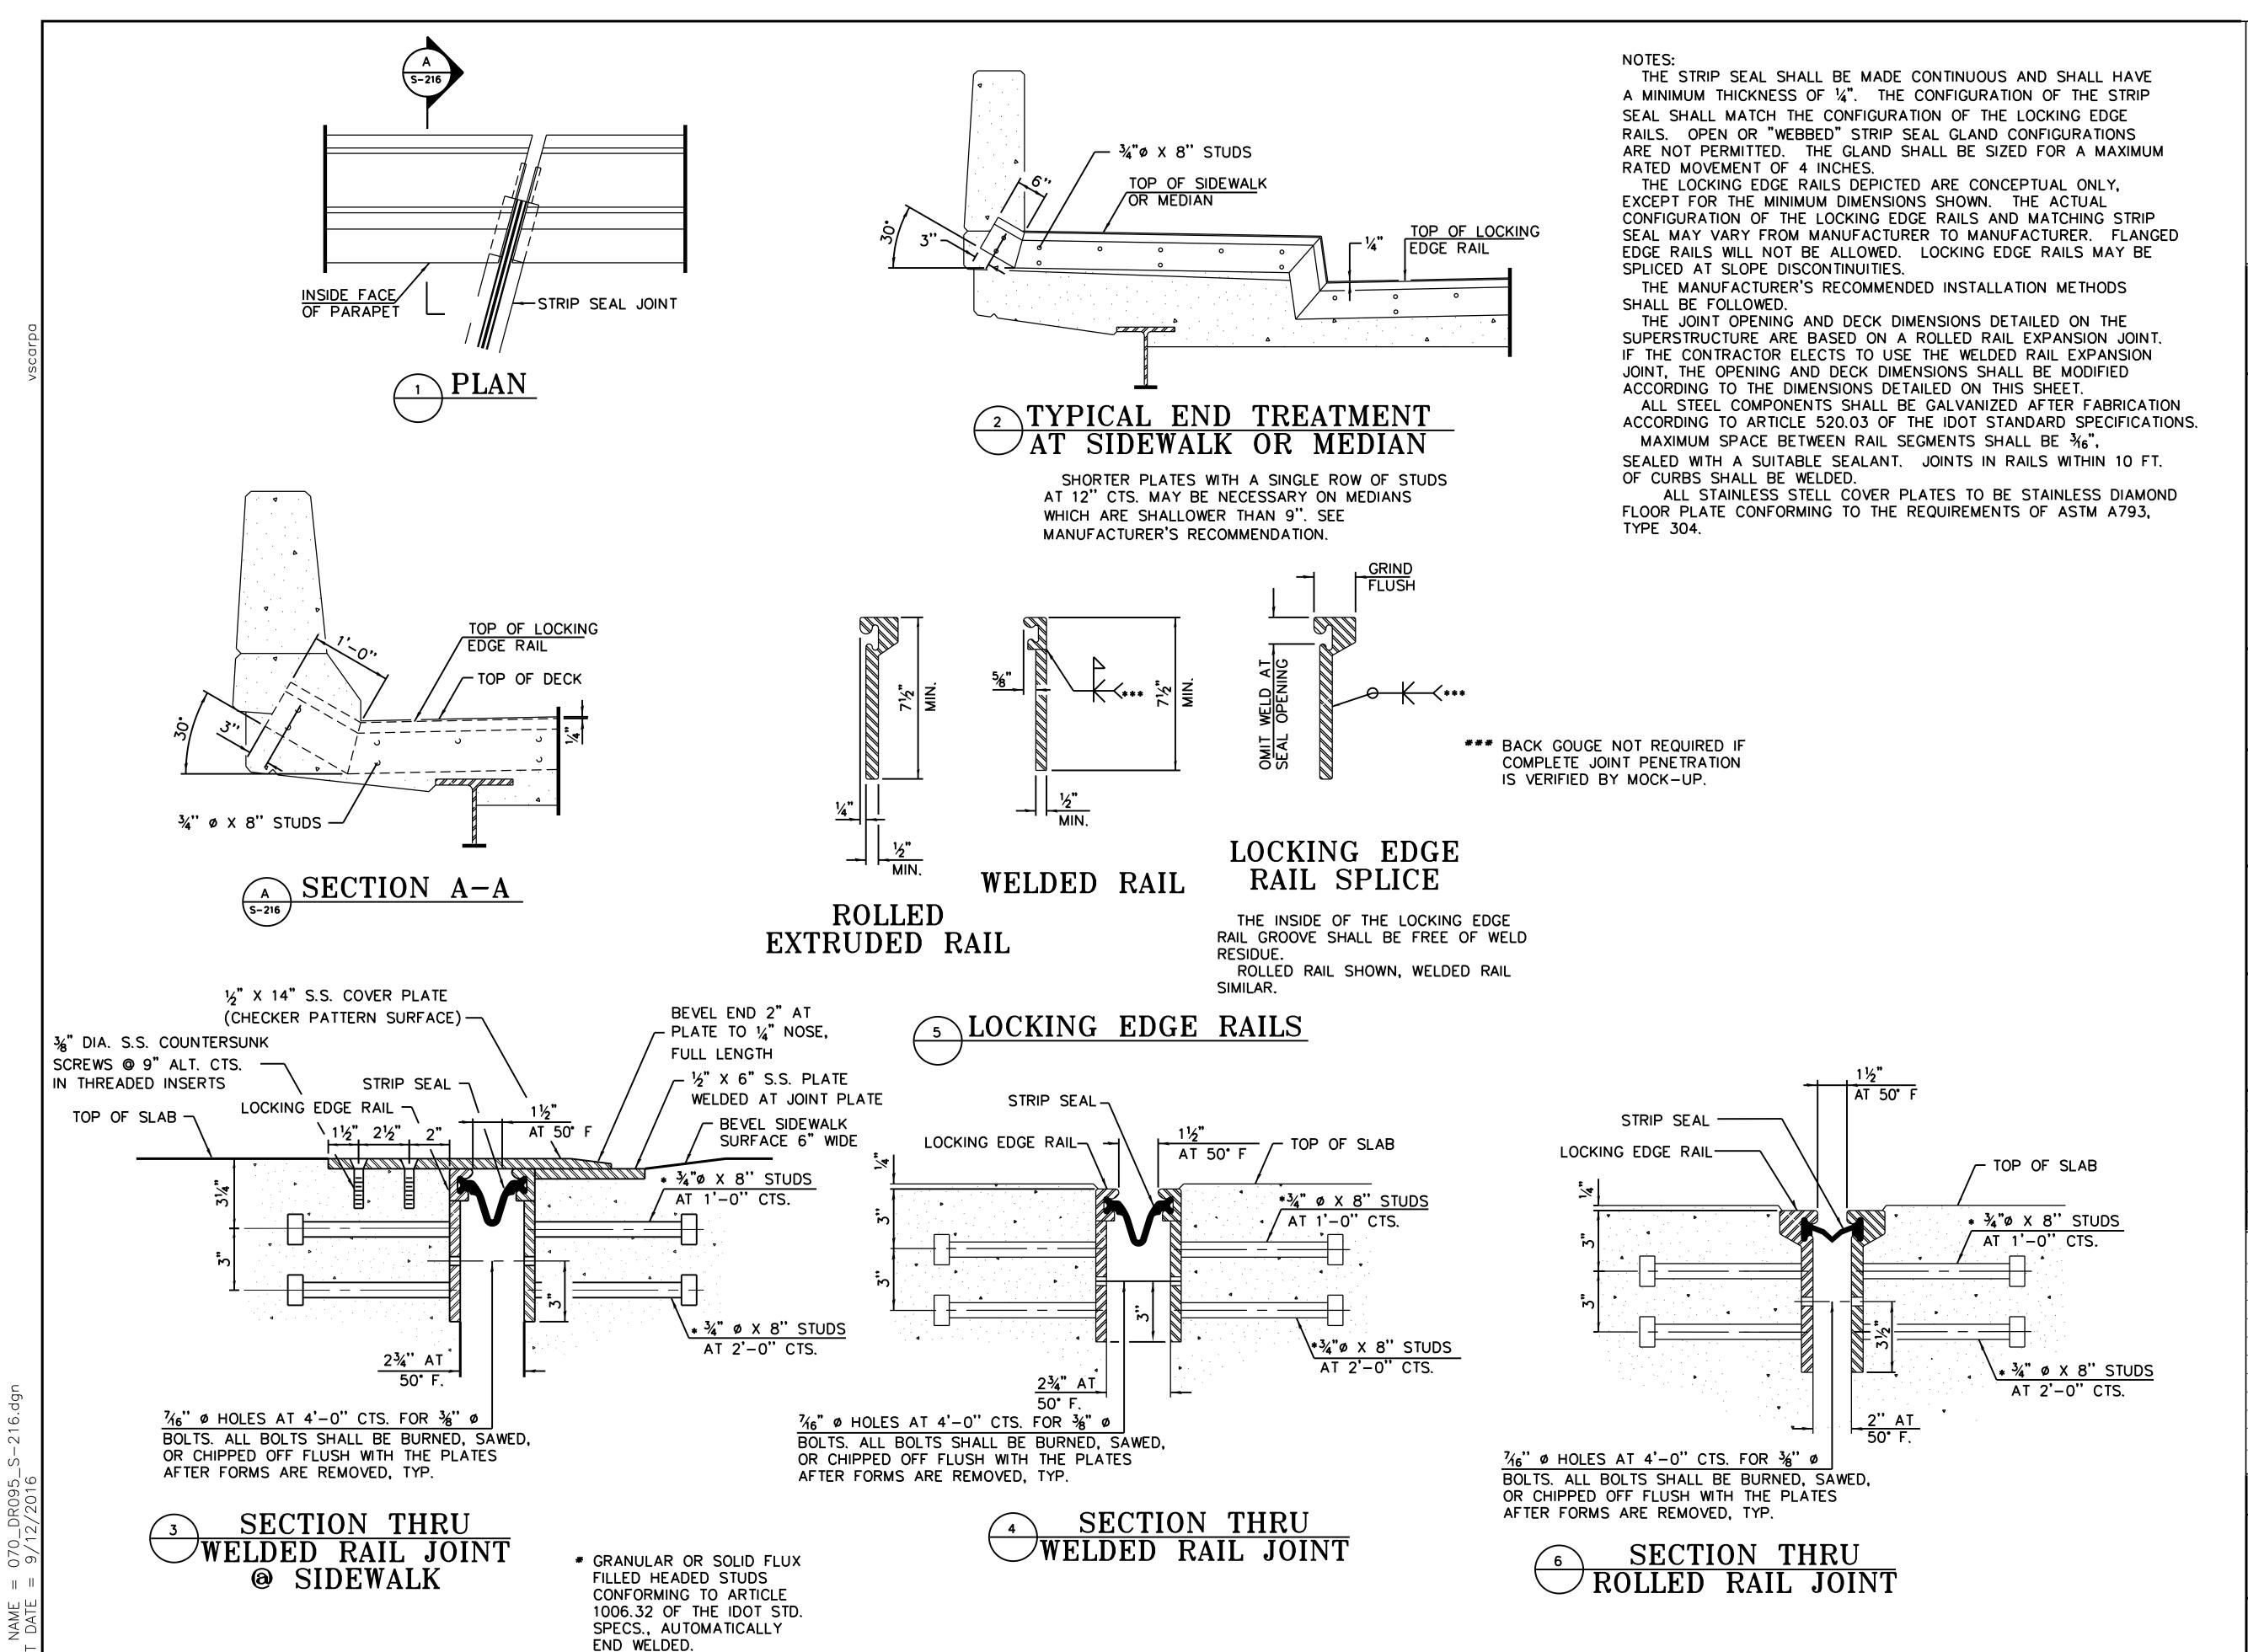
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	ARGE	S. KADERBEK

SOUTH BUS BRIDGE BRIDGE RAILING DETAIL



FFP SNN \*\*exp.



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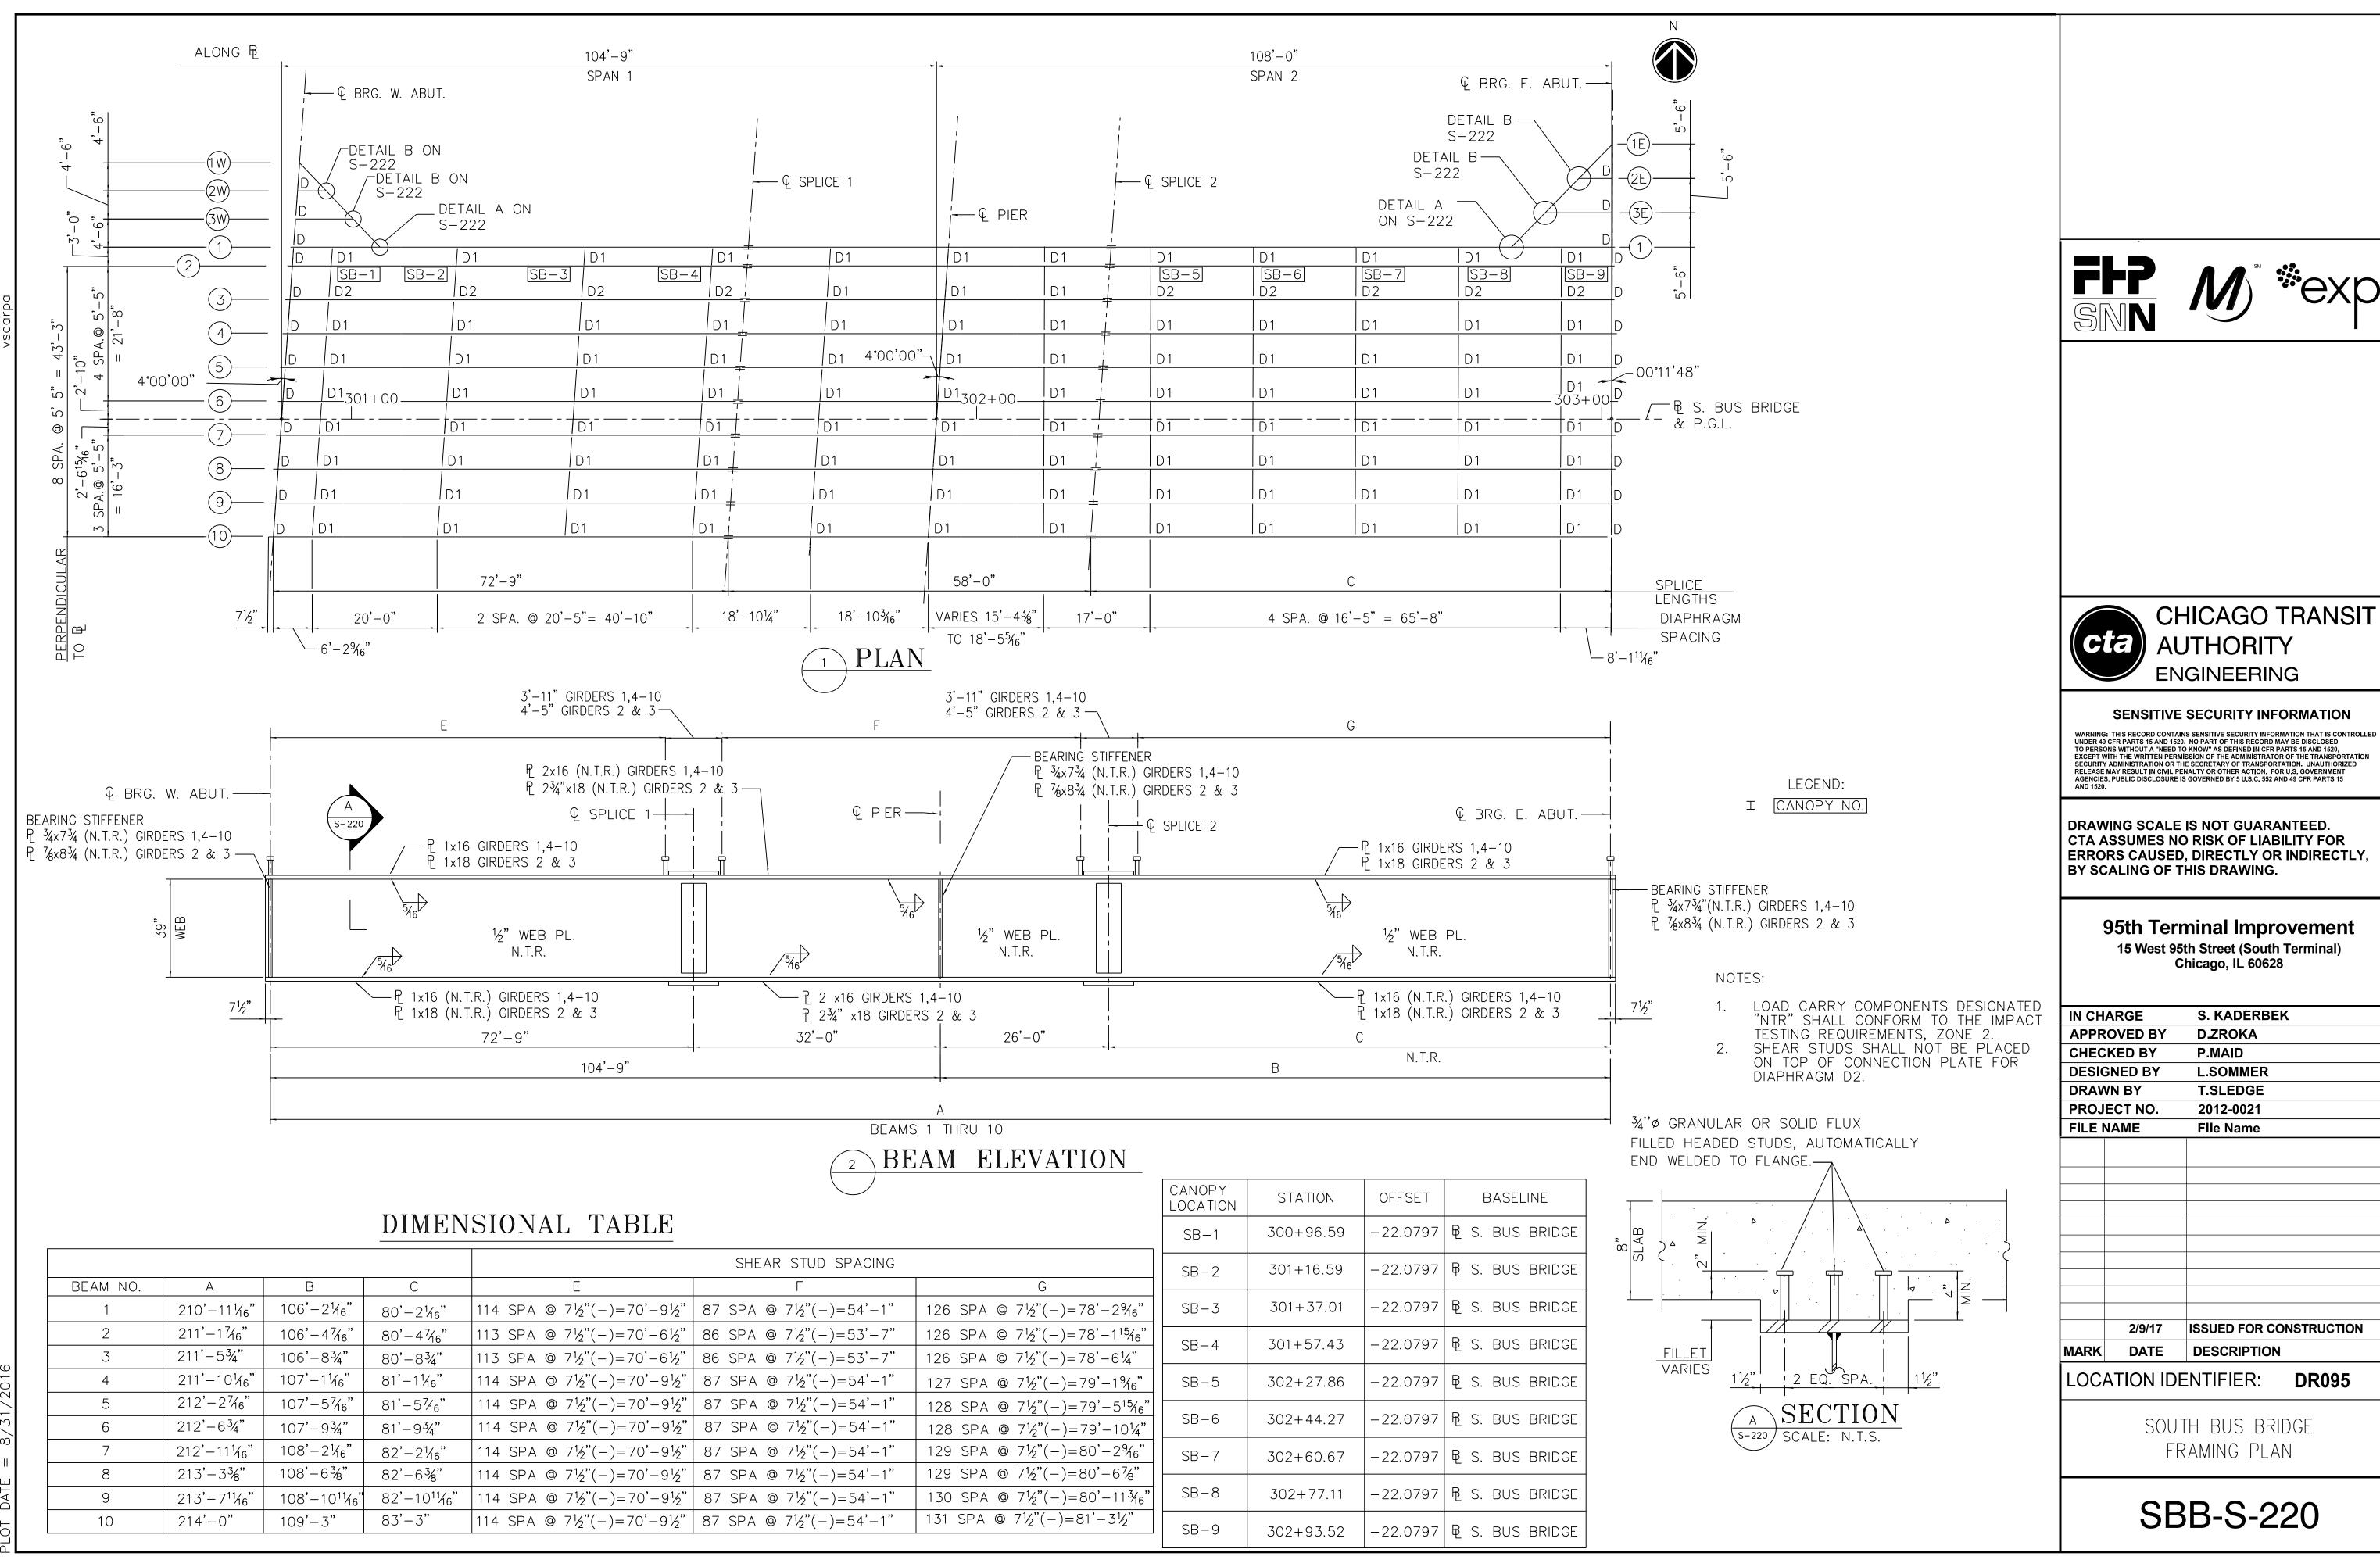
# 95th Terminal Improvement

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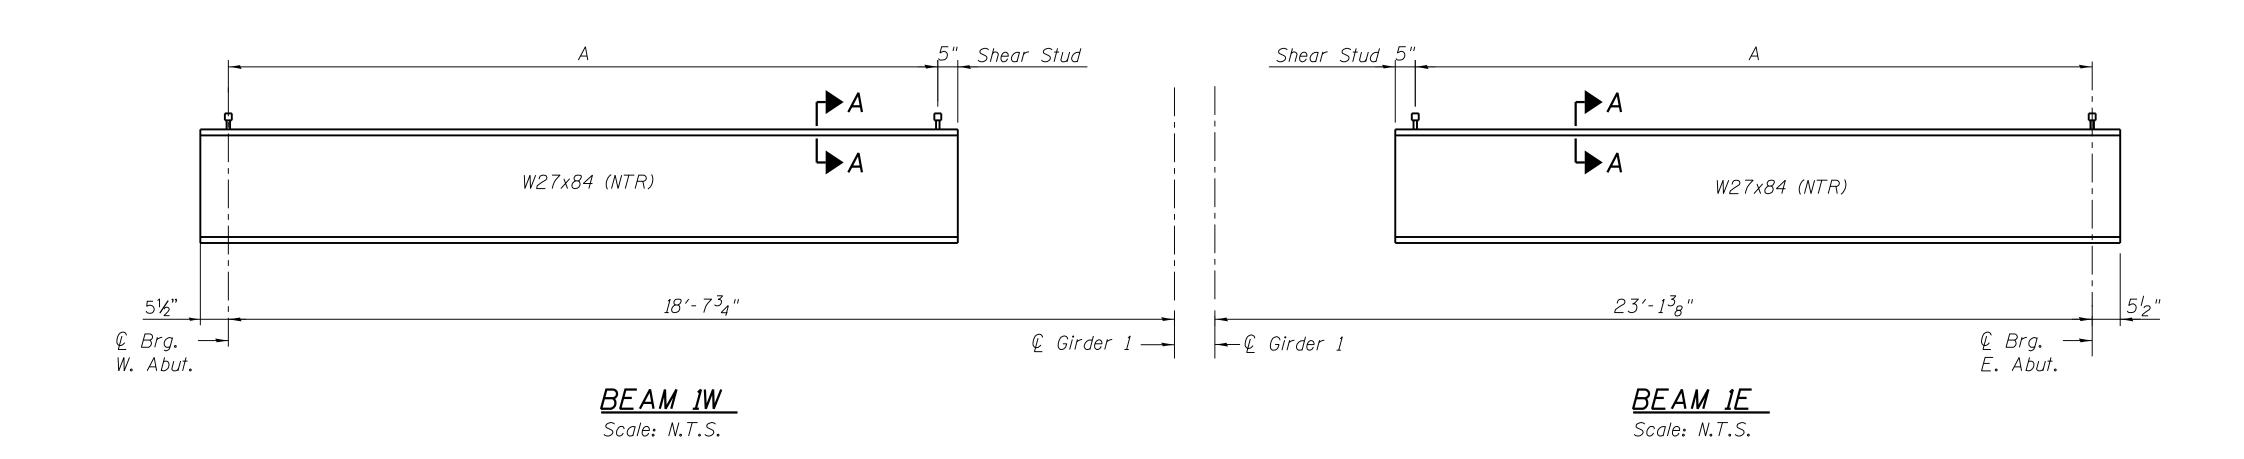
IN CH	ARGE	S. KADERBEK			
APPROVED BY		D.ZROKA			
CHEC	KED BY	P.MAID			
DESIG	SNED BY	L.SOMMER			
DRAV	VN BY	T.SLEDGE			
PROJ	ECT NO.	2012-0021			
FILE N	NAME	File Name			
	2/9/17	ISSUED FOR CONSTRUCTION			
MARK	DATE	DESCRIPTION			
LOCATION IDENTIFIED. BROSE					


LOCATION IDENTIFIER: DR095

SOUTH BUS BRIDGE PREFORMED JOINT STRIP SEAL




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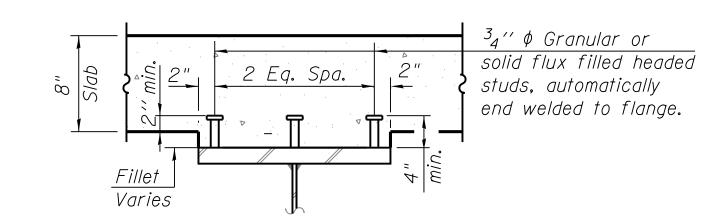


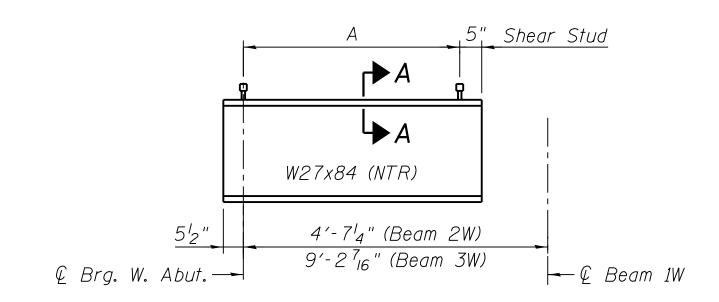

BEAMS 2W & 3W Scale: N.T.S.

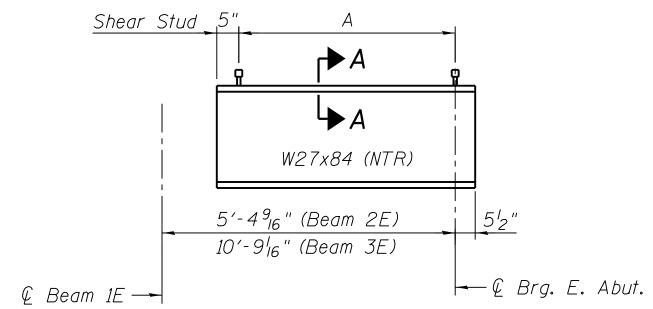


<u>BEAMS 2E & 3E</u> Scale: N.T.S.



SECTION A-A Scale: N.T.S.

#### *Note:*

1. Load carrying components designated "NTR" shall conform to the Impact Testing requirement, Zone 2.

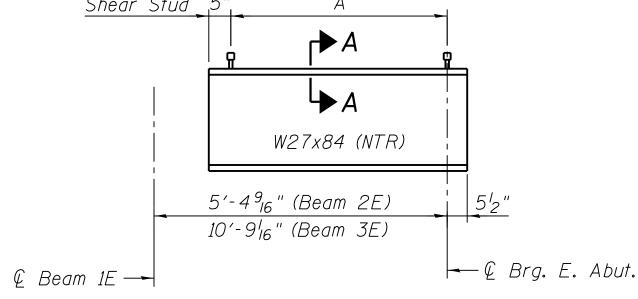

# 95th Terminal Improvement

BY SCALING OF THIS DRAWING.

15 West 95th Street (South Terminal) Chicago, IL 60628

CHICAGO TRANSIT

**AUTHORITY** 

**ENGINEERING** 

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IN CH	ARGE	S. KADERBEK
APPROVED BY		D.ZROKA
CHEC	KED BY	P.MAID
DESIG	SNED BY	L.SOMMER
DRAV	VN BY	T.SLEDGE
PROJ	ECT NO.	2012-0021
FILE	NAME	File Name
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	2/9/17	ISSUED FOR CONSTRUCTION
MARK	DATE	DESCRIPTION
LOC	ATION IDE	ENTIFIER: <b>DR095</b>


SOUTH BUS BRIDGE STRUCTURAL STEEL DETAILS (SHEET 1 OF 4)

SBB-S-221

# BEAM ELEVATIONS

# SHEAR STUD DIMENSIONS

Beam	А
1W	22 Spa. @ 9" (-)=16′-7 <sup>3</sup> 4"
1E	28 Spa. @ 9" (-)=21′-2"
2W	3 Spa. @ 9" (-)=2′-7′ <sub>4</sub> "
2E	4 Spa. © 9" (-)=3′-4½"
3W	9 Spa. @ 9" (-)=7'-2 <sup>7</sup> <sub>16</sub> "
3E	11 Spa. @ 9" (-)=8'-9"

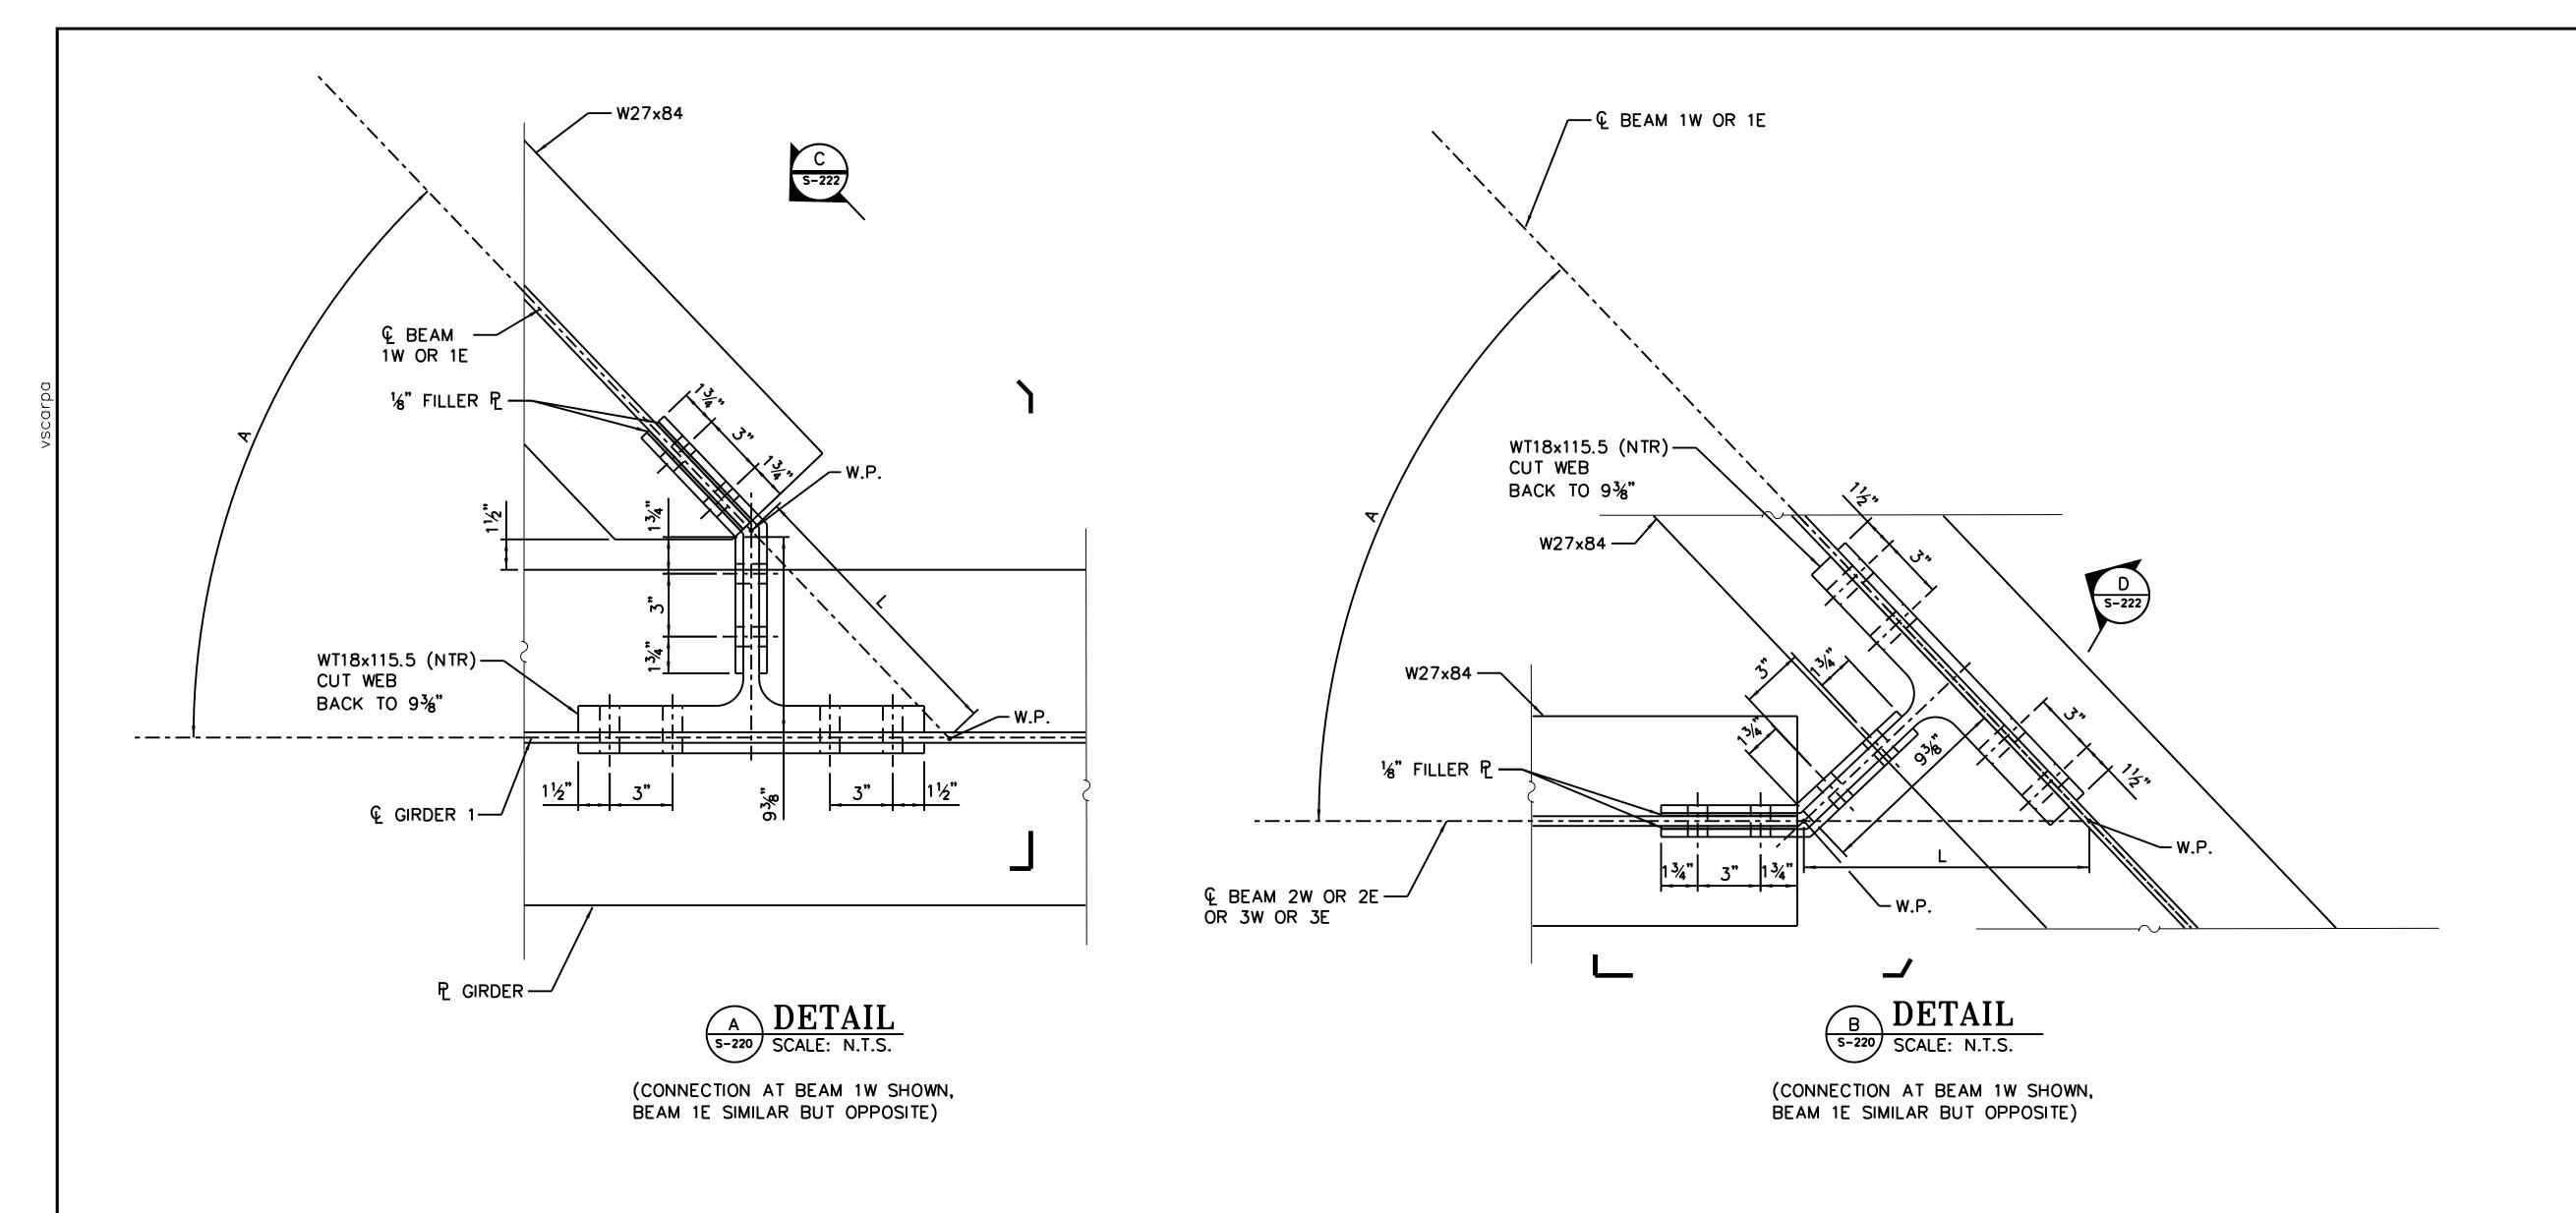

ANGLE A GIRDER BEAM BEAM (DEGREES) 46.3872 G1 2W 46.3872 46.3872 3W 45.5422 G1 45.5422 2E 3E 45.5422

1'-15/6"

1'-15/6"

1'-15/6"

1'-1½"

1'-1½"

1'-1½"





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### 95th Terminal Improvement

15 West 95th Street (South Terminal) Chicago, IL 60628

IN CH	ARGE	S. KADERBEK
APPR	OVED BY	D.ZROKA
CHEC	KED BY	P.MAID
DESI	SNED BY	L.SOMMER
DRAV	VN BY	T.SLEDGE
PROJ	ECT NO.	2012-0021
FILE I	NAME	File Name
	0/0/45	
	2/9/17	ISSUED FOR CONSTRUCTION


LOCATION IDENTIFIER: **DR095** 


SOUTH BUS BRIDGE STRUCTURAL STEEL DETAILS (SHEET 2 OF 4)

SBB-S-222

7 SPA, @ 3" =1'-6" -0-0-0-0-0-0-0-0-0-0-0-0-0-0-0-0-0-0-0	BENT PE EACH SIDE N.T.R.	3%" BENT PE EACH SIDE N.T.R.	6-6-6-6-6-6-6-6-6-6-6-6-6-6-6-6-6-6-6-
D DET S-222 SCALE:	© BEAM 1W OR 1E  CAIL  N.T.S.	© GIRDER 1	© BEAM 1W OR 1  DETAIL SCALE: N.T.S.

FILE NAME =  $070_DR095_S-222.dgn$ PLOT DATE = 8/31/2016

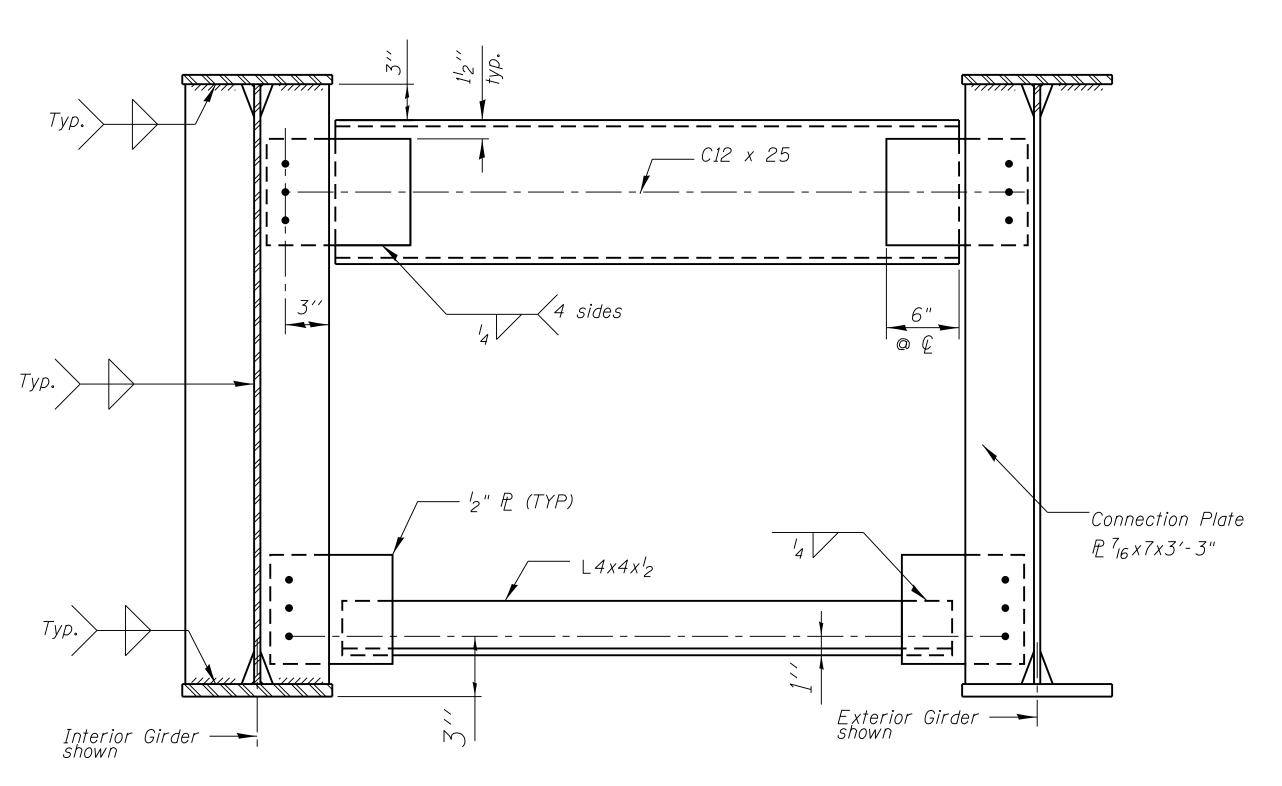


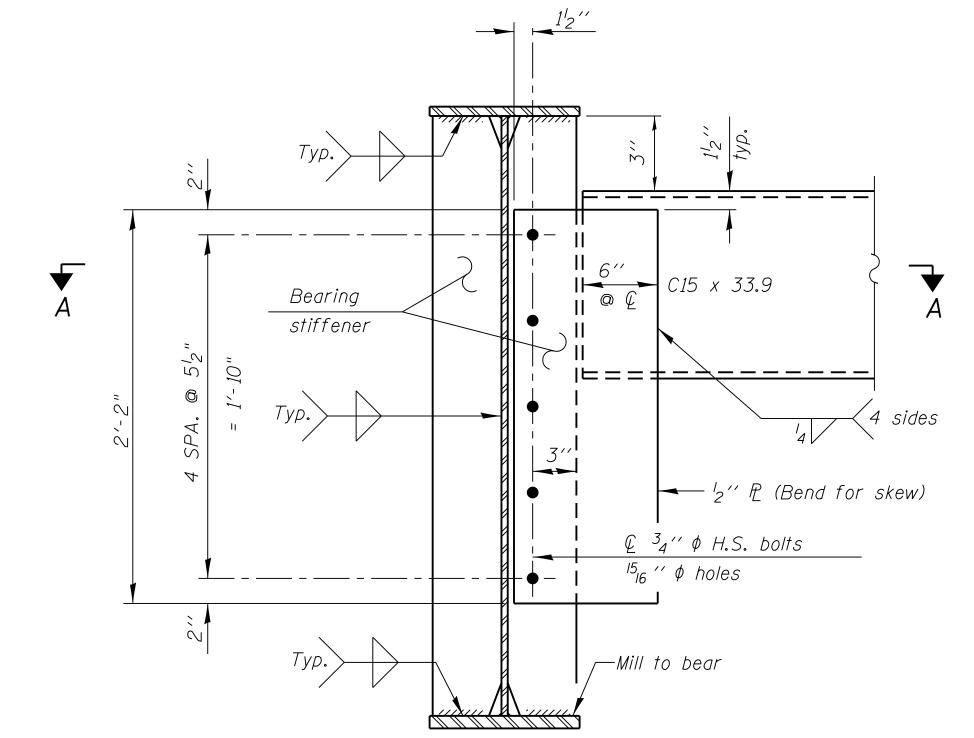

<u>END DIAPHRAGM, D</u>

INTERIOR DIAPHRAGM, D1

Note: Detail  $^{15}_{16}$ "  $\phi$  holes for all  $^{3}_{4}$ "  $\phi$  bolts. Two hardened washers required for each set of oversized holes.

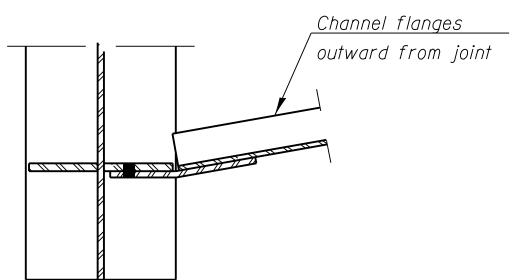

*Notes:* 

- 1) For connection of canopy column to diaphragm D2, see architectural drawings.
- 2) See weld termination detail on S-224. 3) For diaphragm detail supporting canopy column, D2, see architectual drawings.

CHICAGO TRANSIT

#### SENSITIVE SECURITY INFORMATION

**AUTHORITY** 

**ENGINEERING** 

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### 95th Terminal Improvement

15 West 95th Street (South Terminal) Chicago, IL 60628

MARK	DATE	DESCRIPTION
	2/9/17	ISSUED FOR CONSTRUCTION
FILE N	NAME	File Name
PROJECT NO.		2012-0021
	VN BY	T.SLEDGE
DESIGNED BY		L.SOMMER
		P.MAID
APPROVED BY		D.ZROKA
IN CH	ARGE	S. KADERBEK


LOCATION IDENTIFIER: DR095


SOUTH BUS BRIDGE STRUCTURAL STEEL DETAILS (SHEET 3 OF 4)


SBB-S-223

SECTION A - A

FILE NAME =  $070_DR095_S-223.dgn$ 

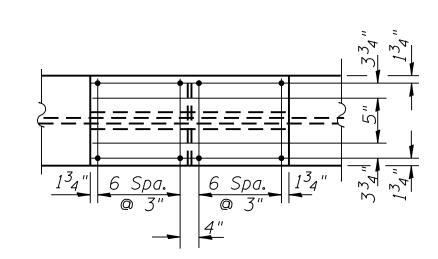


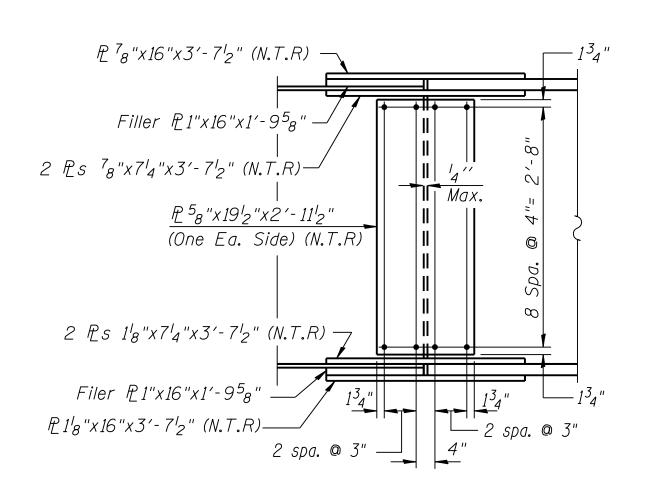


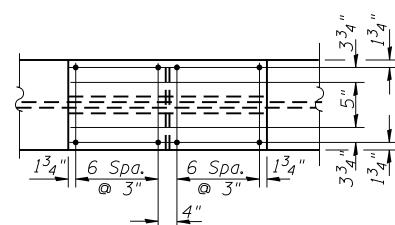

GIRDERS 1,4-10 AT SPLICES 1 & 2

# 1<sup>3</sup>4" 7 Spa. 7 Spa. 1<sup>3</sup>4" m<sup>4</sup> m<sup>4</sup> 1 4"

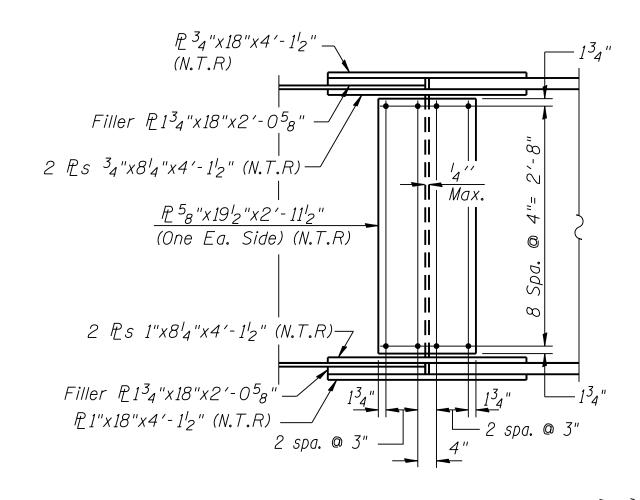

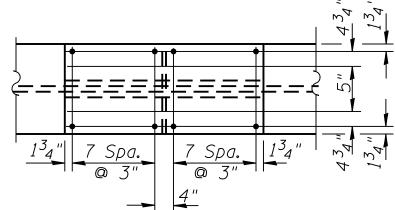



GIRDERS 2 & 3 AT SPLICES 1 & 2

### FIELD SPLICE DETAIL

*NOTE:* 

Notch toughness Required (N.T.R.) is required at all plates except at fillers

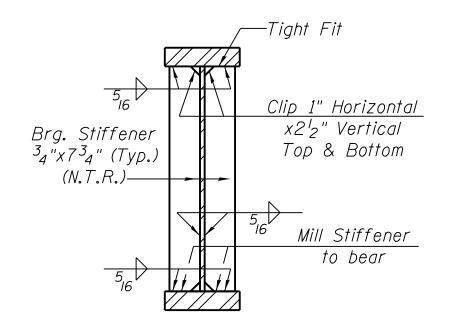


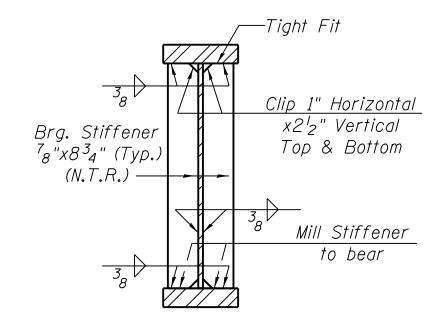

GIRDERS 1,4 Thru 10

<u>GIRDERS 2 & 3</u>

SECTION AT PIER & AT ABUTMENT

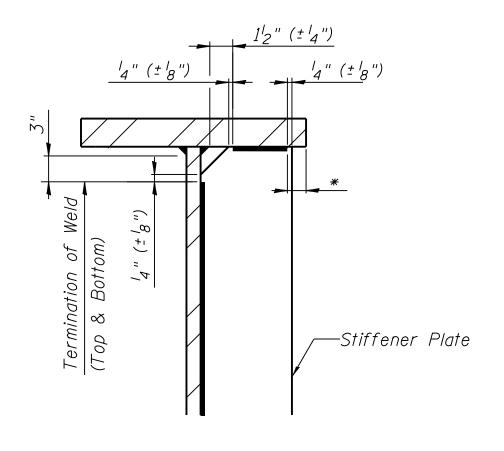

#### Weld Termination Detail

\* If stiffener plate extends beyond flange edge, the weld shall be terminated  ${}^{l}_{4}$ " ( ${}^{\pm}{}^{l}_{8}$ ") from the edge.





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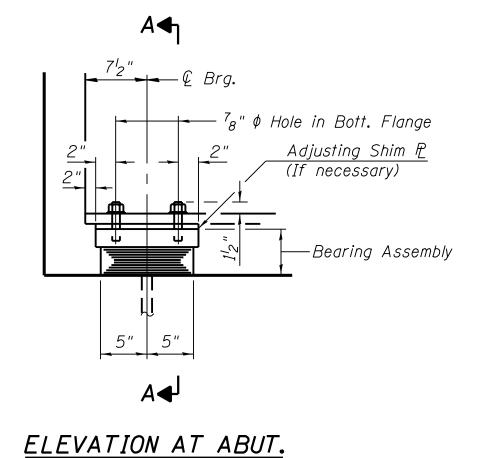
# 95th Terminal Improvement

15 West 95th Street (South Terminal) Chicago, IL 60628


IN CH	ARGE	S. KADERBEK
APPR	OVED BY	D.ZROKA
CHEC	KED BY	P.MAID
DESIGNED BY		L.SOMMER
DRAWN BY		T.SLEDGE
PROJECT NO.		2012-0021
FILE I	NAME	File Name
	0/0/47	LOCUED FOR CONSTRUCTION
	2/9/17	ISSUED FOR CONSTRUCTION
MARK	DATE	DESCRIPTION
100		ENTIFIED: DDAGE


LOCATION IDENTIFIER: DR095


SOUTH BUS BRIDGE STRUCTURAL STEEL DETAILS (SHEET 4 OF 4)



Girders 1,4-10

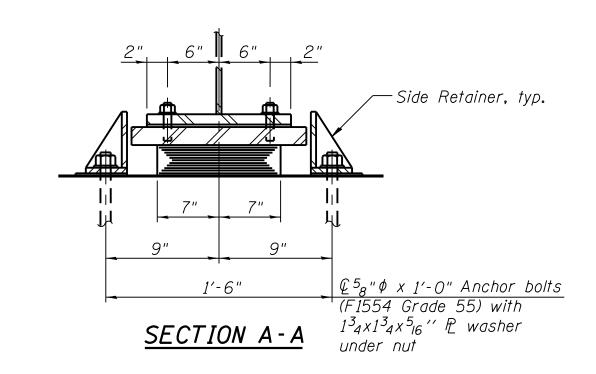

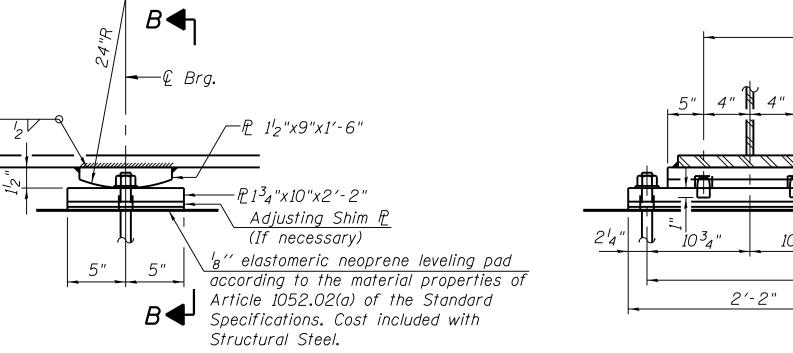

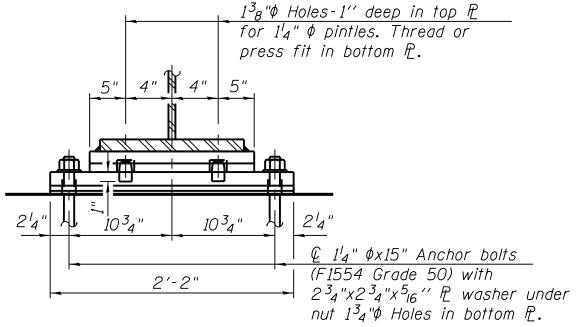

SECTION B-B


### TYPE I ELASTOMERIC EXP. BRG.


#### WEST ABUTMENT

Girder 1 add <sup>1</sup>2x11"x1'-4" shim plate Girder 3 add  $\frac{1}{4}$ x11"x1'-4" shim plate Girder 5 add <sup>l</sup>2x11"x1'-4" shim plate Girder 6 add  $\frac{1}{8}$ x11"x1'-4" shim plate

#### EAST ABUTMENT


Girder 1 add  $\frac{1}{4}$ x11"x1'-4" shim plate

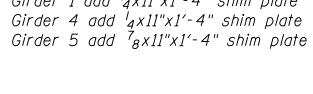

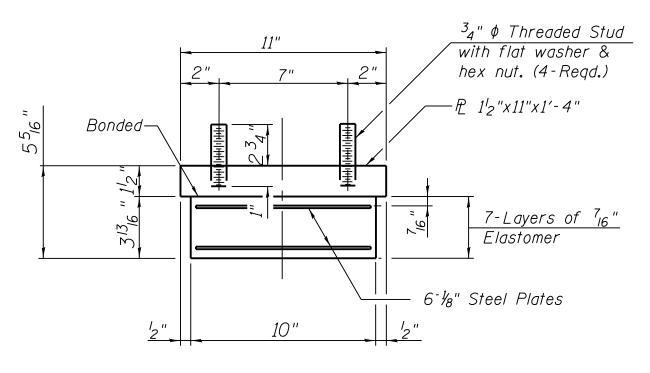

#### BEARING ASSEMBLY

Shim plates shall not be placed under Bearing Assembly.

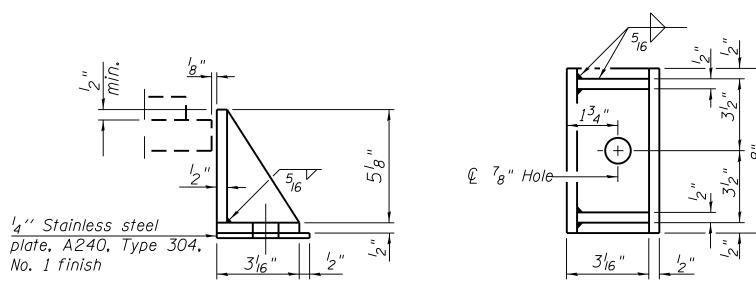

#### SIDE RETAINER

Equivalent rolled angle with stiffeners will be allowed in lieu of welded plates.




Anchor bolts shall be ASTM F1554 all-thread (or an Engineer-approved alternate material) of the grade(s) and diameter(s) specified. The corresponding specified grade of AASHTO M314 anchor bolts may be used in lieu of ASTM F1554.

Side retainers and other steel members required for the elastomeric bearing assembly shall be included in the cost of Elastomeric Bearing Assembly, Type I. Beams shall be braced for stability during erection and

remain braced until deck is poured and cured. Anchor bolts and side retainers at all supports shall

be installed as each member is erected unless an equivalent temporary means of lateral restraint is used.

FIXED BEARING

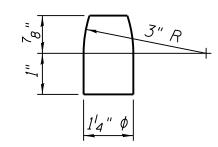

ELEVATION AT PIER

Girders 1,4-10

<u>PINTLE</u>





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### 95th Terminal Improvement


15 West 95th Street (South Terminal) Chicago, IL 60628


IN CH	ARGE	S. KADERBEK
APPROVED BY		D.ZROKA
CHECKED BY		P.MAID
DESIG	SNED BY	L.SOMMER
DRAV	VN BY	T.SLEDGE
PROJ	ECT NO.	2012-0021
FILE	NAME	File Name
	2/9/17	ISSUED FOR CONSTRUCTION
MARK	DATE	DESCRIPTION
	ATION ID	ENTIFIER: DR095


LOCATION IDENTIFIER:

SOUTH BUS BRIDGE BEARING DETAILS (SHEET 1 OF 4)

ELEVATION AT ABUT.

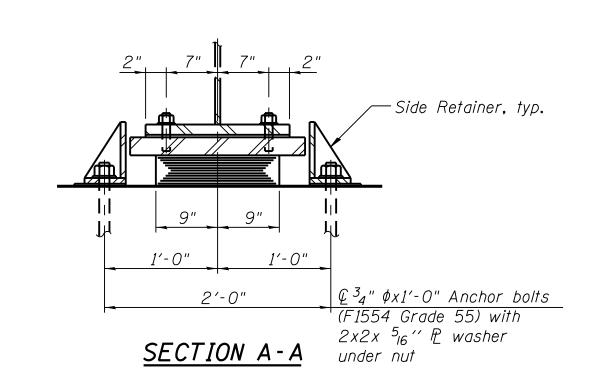

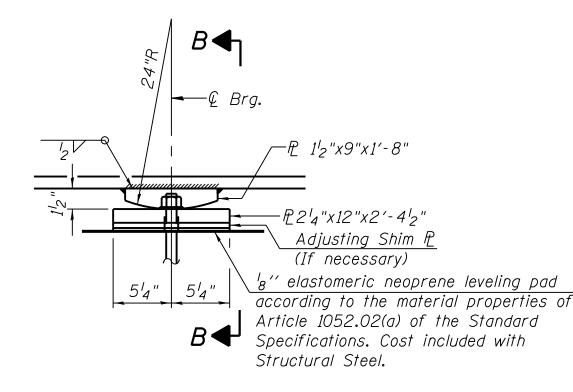

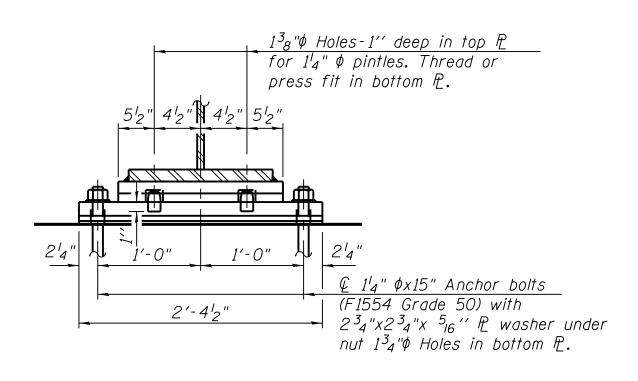

FFP SIN \*\*exp.

### TYPE I ELASTOMERIC EXP. BRG.

(Girders 2 & 3)


WEST ABUTMENT

Girder 2 add  ${}^{l}_{2}x1'$ -0"x1'-6" shim plate Girder 3 add  ${}^{3}_{8}x1'$ -0"x1'-6" shim plate

#### ELEVATION AT PIER


SECTION B-B


FIXED BEARING
Girders 2 & 3

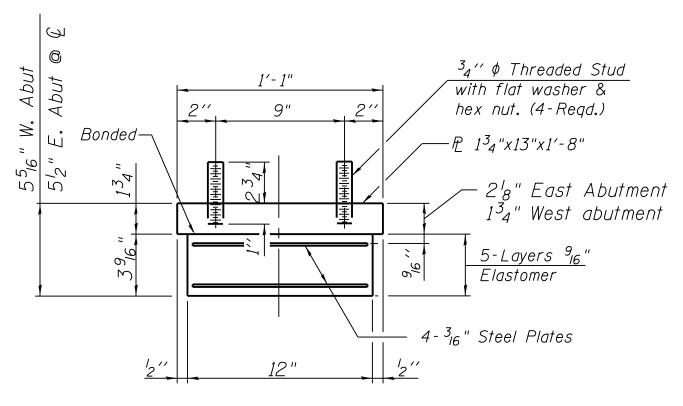

#### BEARING ASSEMBLY

Note:
Shim plates shall not be placed under Bearing Assembly.

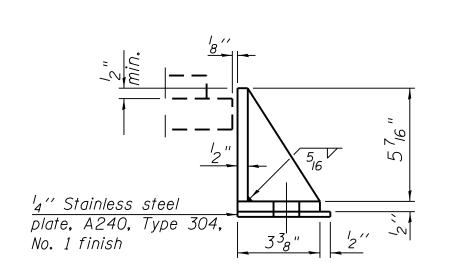

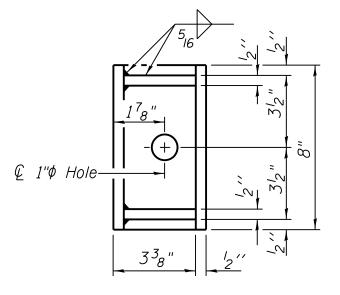

# SIDE RETAINER

Equivalent rolled angle with stiffeners will be allowed in lieu of welded plates.

Notes:


Anchor bolts shall be ASTM F1554 all-thread (or an Engineer-approved alternate material) of the grade(s) and diameter(s) specified. The corresponding specified grade of AASHTO M314 anchor bolts may be used in lieu of ASTM F1554.

Side retainers and other steel members required for the elastomeric bearing assembly shall be included in the cost of Elastomeric Bearing Assembly, Type I.

cost of Elastomeric Bearing Assembly, Type I.

Beams shall be braced for stability during erection and remain braced until deck is poured and cured.

Anchor bolts and side retainers at all supports shall be installed as each member is erected unless an equivalent temporary means of lateral restraint is used.

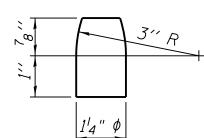

<u>PINTLE</u>

# CHICAGO TRANSIT AUTHORITY ENGINEERING

#### SENSITIVE SECURITY INFORMATION

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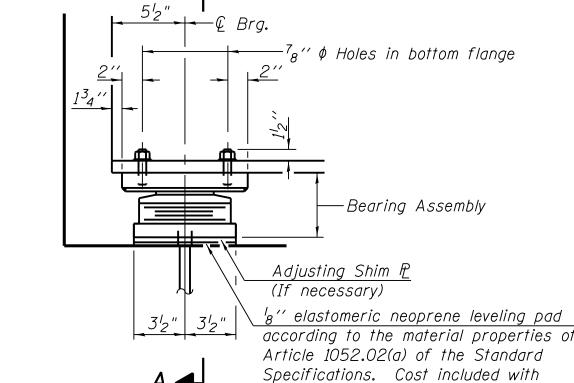
# 95th Terminal Improvement

15 West 95th Street (South Terminal) Chicago, IL 60628

MARK	DATE	DESCRIPTION
	2/9/17	ISSUED FOR CONSTRUCTION
FILE N	NAME	File Name
	ECT NO.	2012-0021
	VN BY	T.SLEDGE
DESIC	SNED BY	L.SOMMER
CHEC	KED BY	P.MAID
APPR	OVED BY	D.ZROKA
IN CH	ARGE	S. KADERBEK

LOCATION IDENTIFIER: DR095

SOUTH BUS BRIDGE BEARING DETAILS (SHEET 2 OF 4)



ELEVATION AT ABUT.

3/2"

(Beams 2W, 2E, 3W, & 3E)

Elastomeric Bearing Assembly Type II.

(Beams 2W, 2E, 3W, & 3E)

<sup>3</sup>₄′′ ¢ Threaded Stud

with flat washer &


hex. nut. (4 Reg'd.)

P 1'ヮ'' x 7'ヮ" x 1'-0"

Side Retainer  $Q^{5}_{8}$ "  $\phi$  x 12" Anchor bolts (F1554 Grade 55) with  $1^{3}_{4}$ " x  $1^{3}_{4}$ " x  $5_{16}$ " & washer under nut. 1-6<sup>3</sup>8"  $I_8^{\prime\prime}$  Holes in bottom  $P_{\bullet}$ .


SECTION A-A

# TYPE II ELASTOMERIC EXP. BRG.

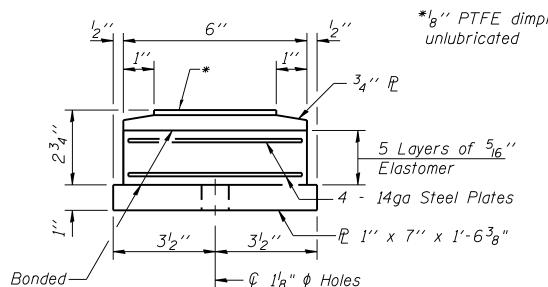


-| $\frac{1}{4}$ " Max. 6'' Stainless Steel TOP BEARING ASSEMBLY



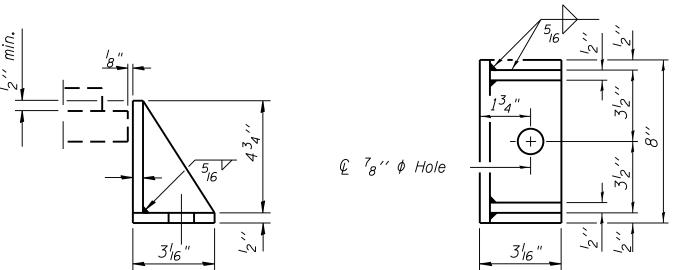


SIDE RETAINER Equivalent rolled angle with stiffeners will be allowed in lieu of welded plates. (Beams 2W, 2E, 3W, & 3E)

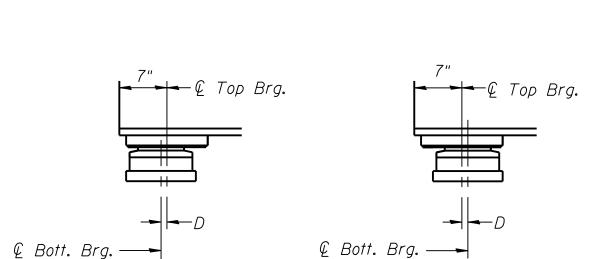

BELOW 50°F. ABOVE 50°F.  $D=\frac{1}{8}$ " per each 100" of expansion for every 15° temp. change from the normal temp. of 50°F.

#### EXPANSION BEARING ORIENTATION


The above diagrams are for informational purposes only to show the amount of expected offset "D" for the current temperature in the field.

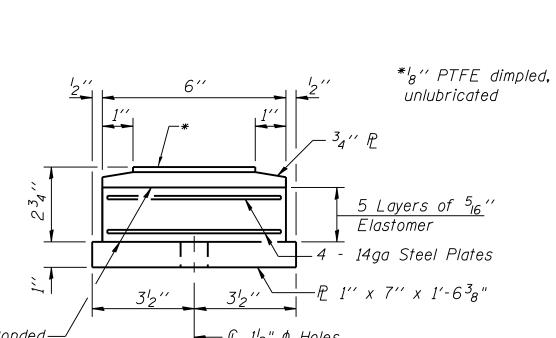

TOP BEARING ASSEMBLY (Beams 1E & 1W)

c.f.w.—


ELEVATION AT ABUT.

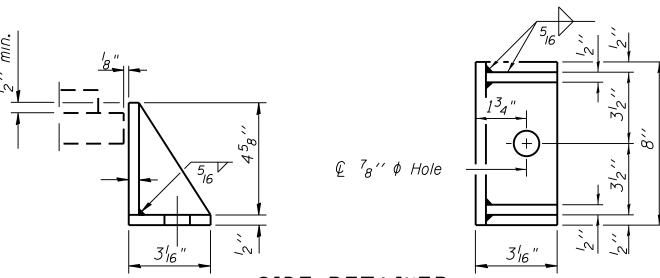

\_\_| \_\_/4'' Max.


s'' Stainless Steel

SIDE RETAINER Equivalent rolled angle with stiffeners will be allowed in lieu of welded plates. (Beams 1E & 1W)

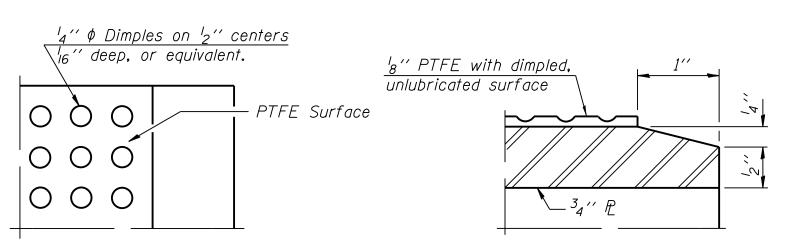

PLAN-PTFE SURFACE

SECTION THRU PTFE

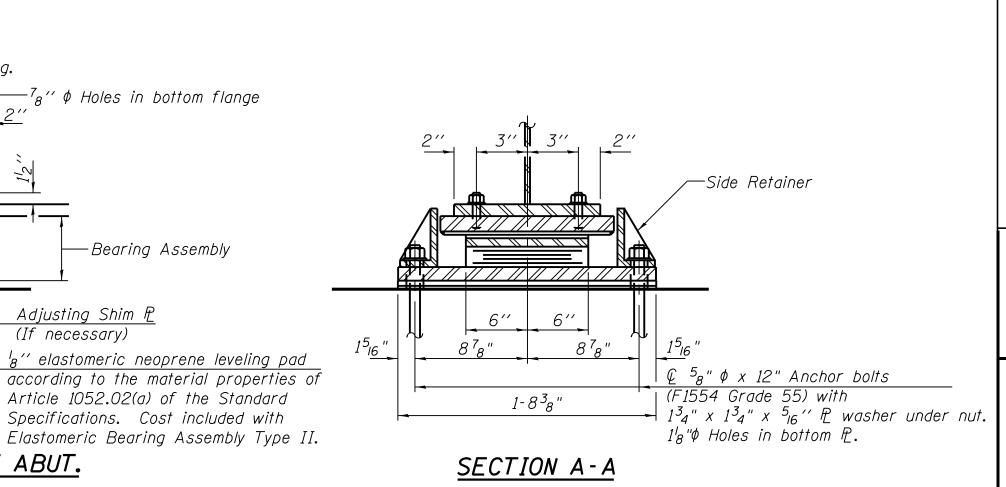

# TYPE II ELASTOMERIC EXP. BRG.

(Beams 1E & 1W)

<sup>3</sup>₄′′ ¢ Threaded Stud

with flat washer &

hex. nut. (4 Reg'd.)

1½" W. Abut.

 $P l_2'' \times 8l_4'' \times 1'-2''$ 


′ ¢ Holes in bottom flange

-Bearing Assembly

Specifications. Cost included with

Adjusting Shim P (If necessary)

Girder 1E add |<sub>8</sub>x8|<sub>4</sub>"x1'-2" shim plate

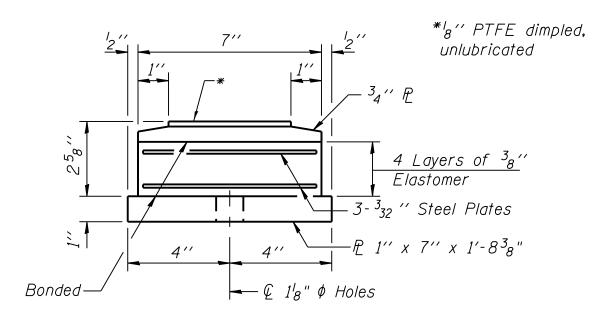

BOTTOM BEARING ASSEMBLY (Beams 1E & 1W)

Anchor bolts shall be ASTM F1554 all-thread (or an Engineer-approved alternate material) of the grade(s) and diameter(s) specified. The corresponding specified grade of AASHTO M314 anchor bolts may be used in lieu of ASTM F1554.

Side retainers and other steel members required for the elastomeric bearing assembly shall be included in the cost of Elastomeric Bearing Assembly, Type II.

The  $^{l}_{8}$ " PTFE sheet shall be bonded directly to the top steel plate with a two-component, medium viscosity epoxy resin, conforming to the requirements of the Federal Specification MMM-A-134, Type I. The bond agent shall be applied on the full area of the contact surfaces.

Bonding of  $^{l}_{8}$ " PTFE sheet during vulcanizing process will be permitted provided the process and method of adjusting assembly height is approved by the Engineer. Beams shall be braced for stability during erection and remain braced until deck is poured and cured.

Anchor bolts and side retainers at all supports shall be installed as each member is erected unless an equivalent temporary means of lateral restraint is used.





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# 95th Terminal Improvement

15 West 95th Street (South Terminal) Chicago, IL 60628

ARGE	S. KADERBEK
OVED BY	D.ZROKA
KED BY	P.MAID
NED BY	L.SOMMER
'N BY	T.SLEDGE
ECT NO.	2012-0021
AME	File Name
0/0/47	100115D FOR CONCERNATION
2/9/17	ISSUED FOR CONSTRUCTION
DATE	DESCRIPTION
	OVED BY KED BY NED BY N BY ECT NO. IAME


| LOCATION IDENTIFIER: DR095

SOUTH BUS BRIDGE BEARING DETAILS (SHEET 3 OF 4)

SBB-S-227

ΗШ NAME


# ELEVATION AT FLARED BEAMS

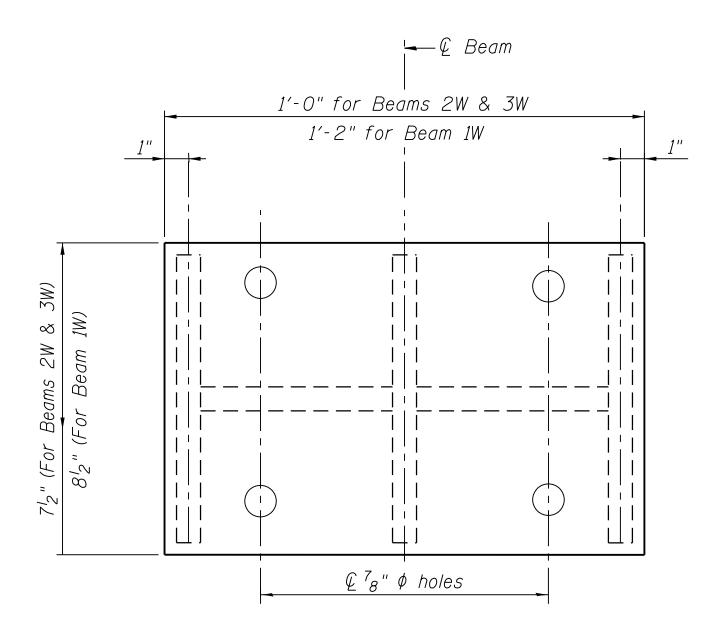


PLAN TALL STEEL EXTENSION

#### TABLE OF TALL EXTENSION HEIGHTS

Girder Number	Height
1W	6 <sup>13</sup> 16 "
2W	6 <sup>7</sup> 16 "
3W	6 <sup>5</sup> 16"

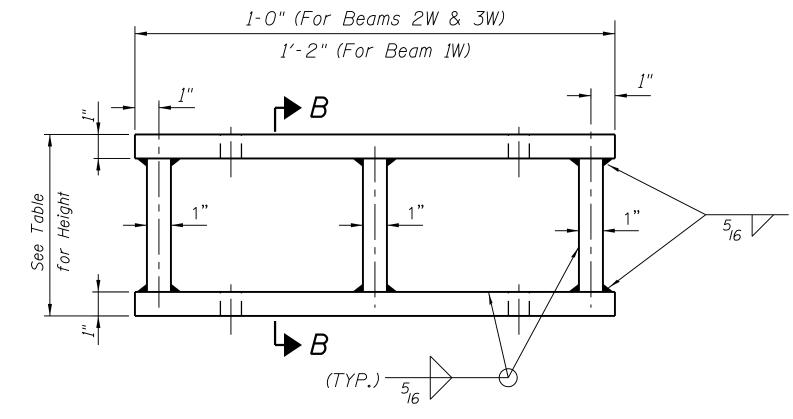

### ELEVATION TALL STEEL EXTENSION

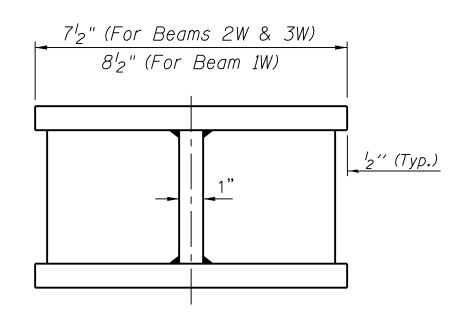

SECTION B-B







#### SENSITIVE SECURITY INFORMATION

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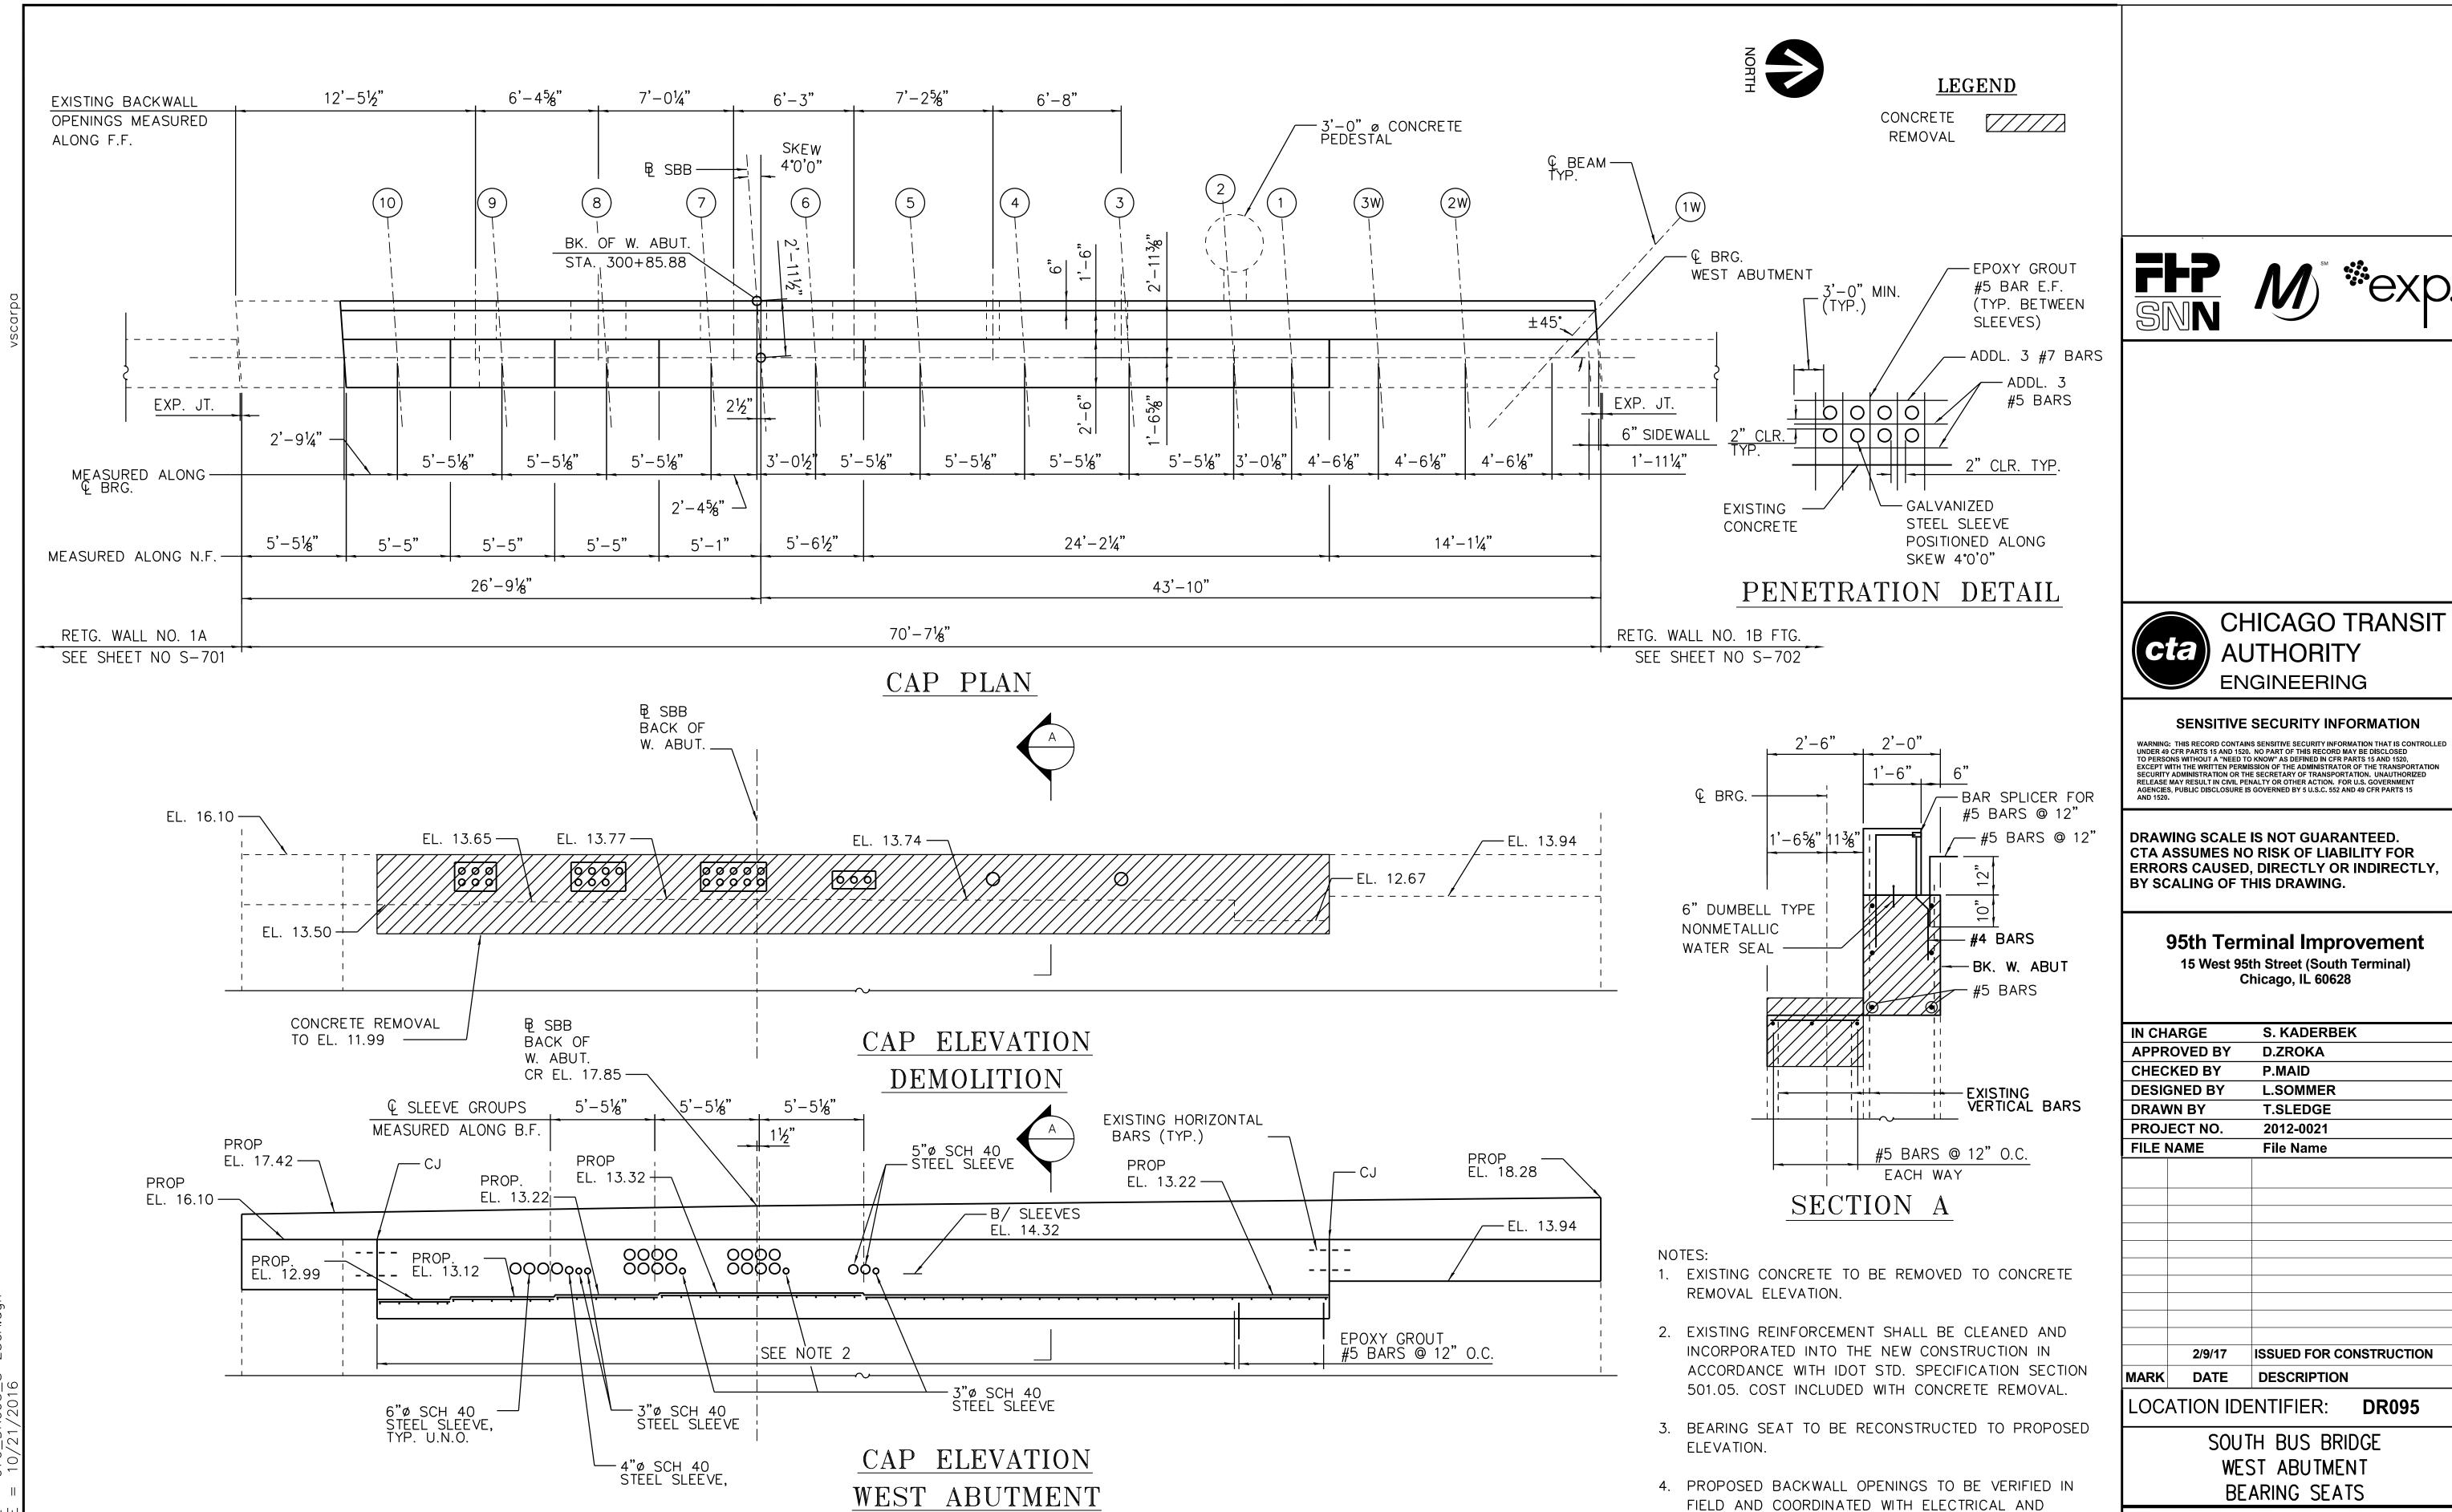
# 95th Terminal Improvement

15 West 95th Street (South Terminal) Chicago, IL 60628

IN CH	ARGE	S. KADERBEK
APPR	OVED BY	D.ZROKA
CHEC	KED BY	P.MAID
DESIG	ENED BY	L.SOMMER
DRAW	VN BY	T.SLEDGE
PROJ	ECT NO.	2012-0021
FILE N	1AME	File Name
	2/9/17	ISSUED FOR CONSTRUCTION
MARK	DATE	DESCRIPTION
	ATION IDE	NTIFIER: DR095

| LOCATION IDENTIFIER: DRU95


SOUTH BUS BRIDGE BEARING DETAILS (SHEET 4 OF 4)



070\_DR095\_ 10/21/201 NAME DATE

SBB-S-230A

UTILITY DRAWINGS.

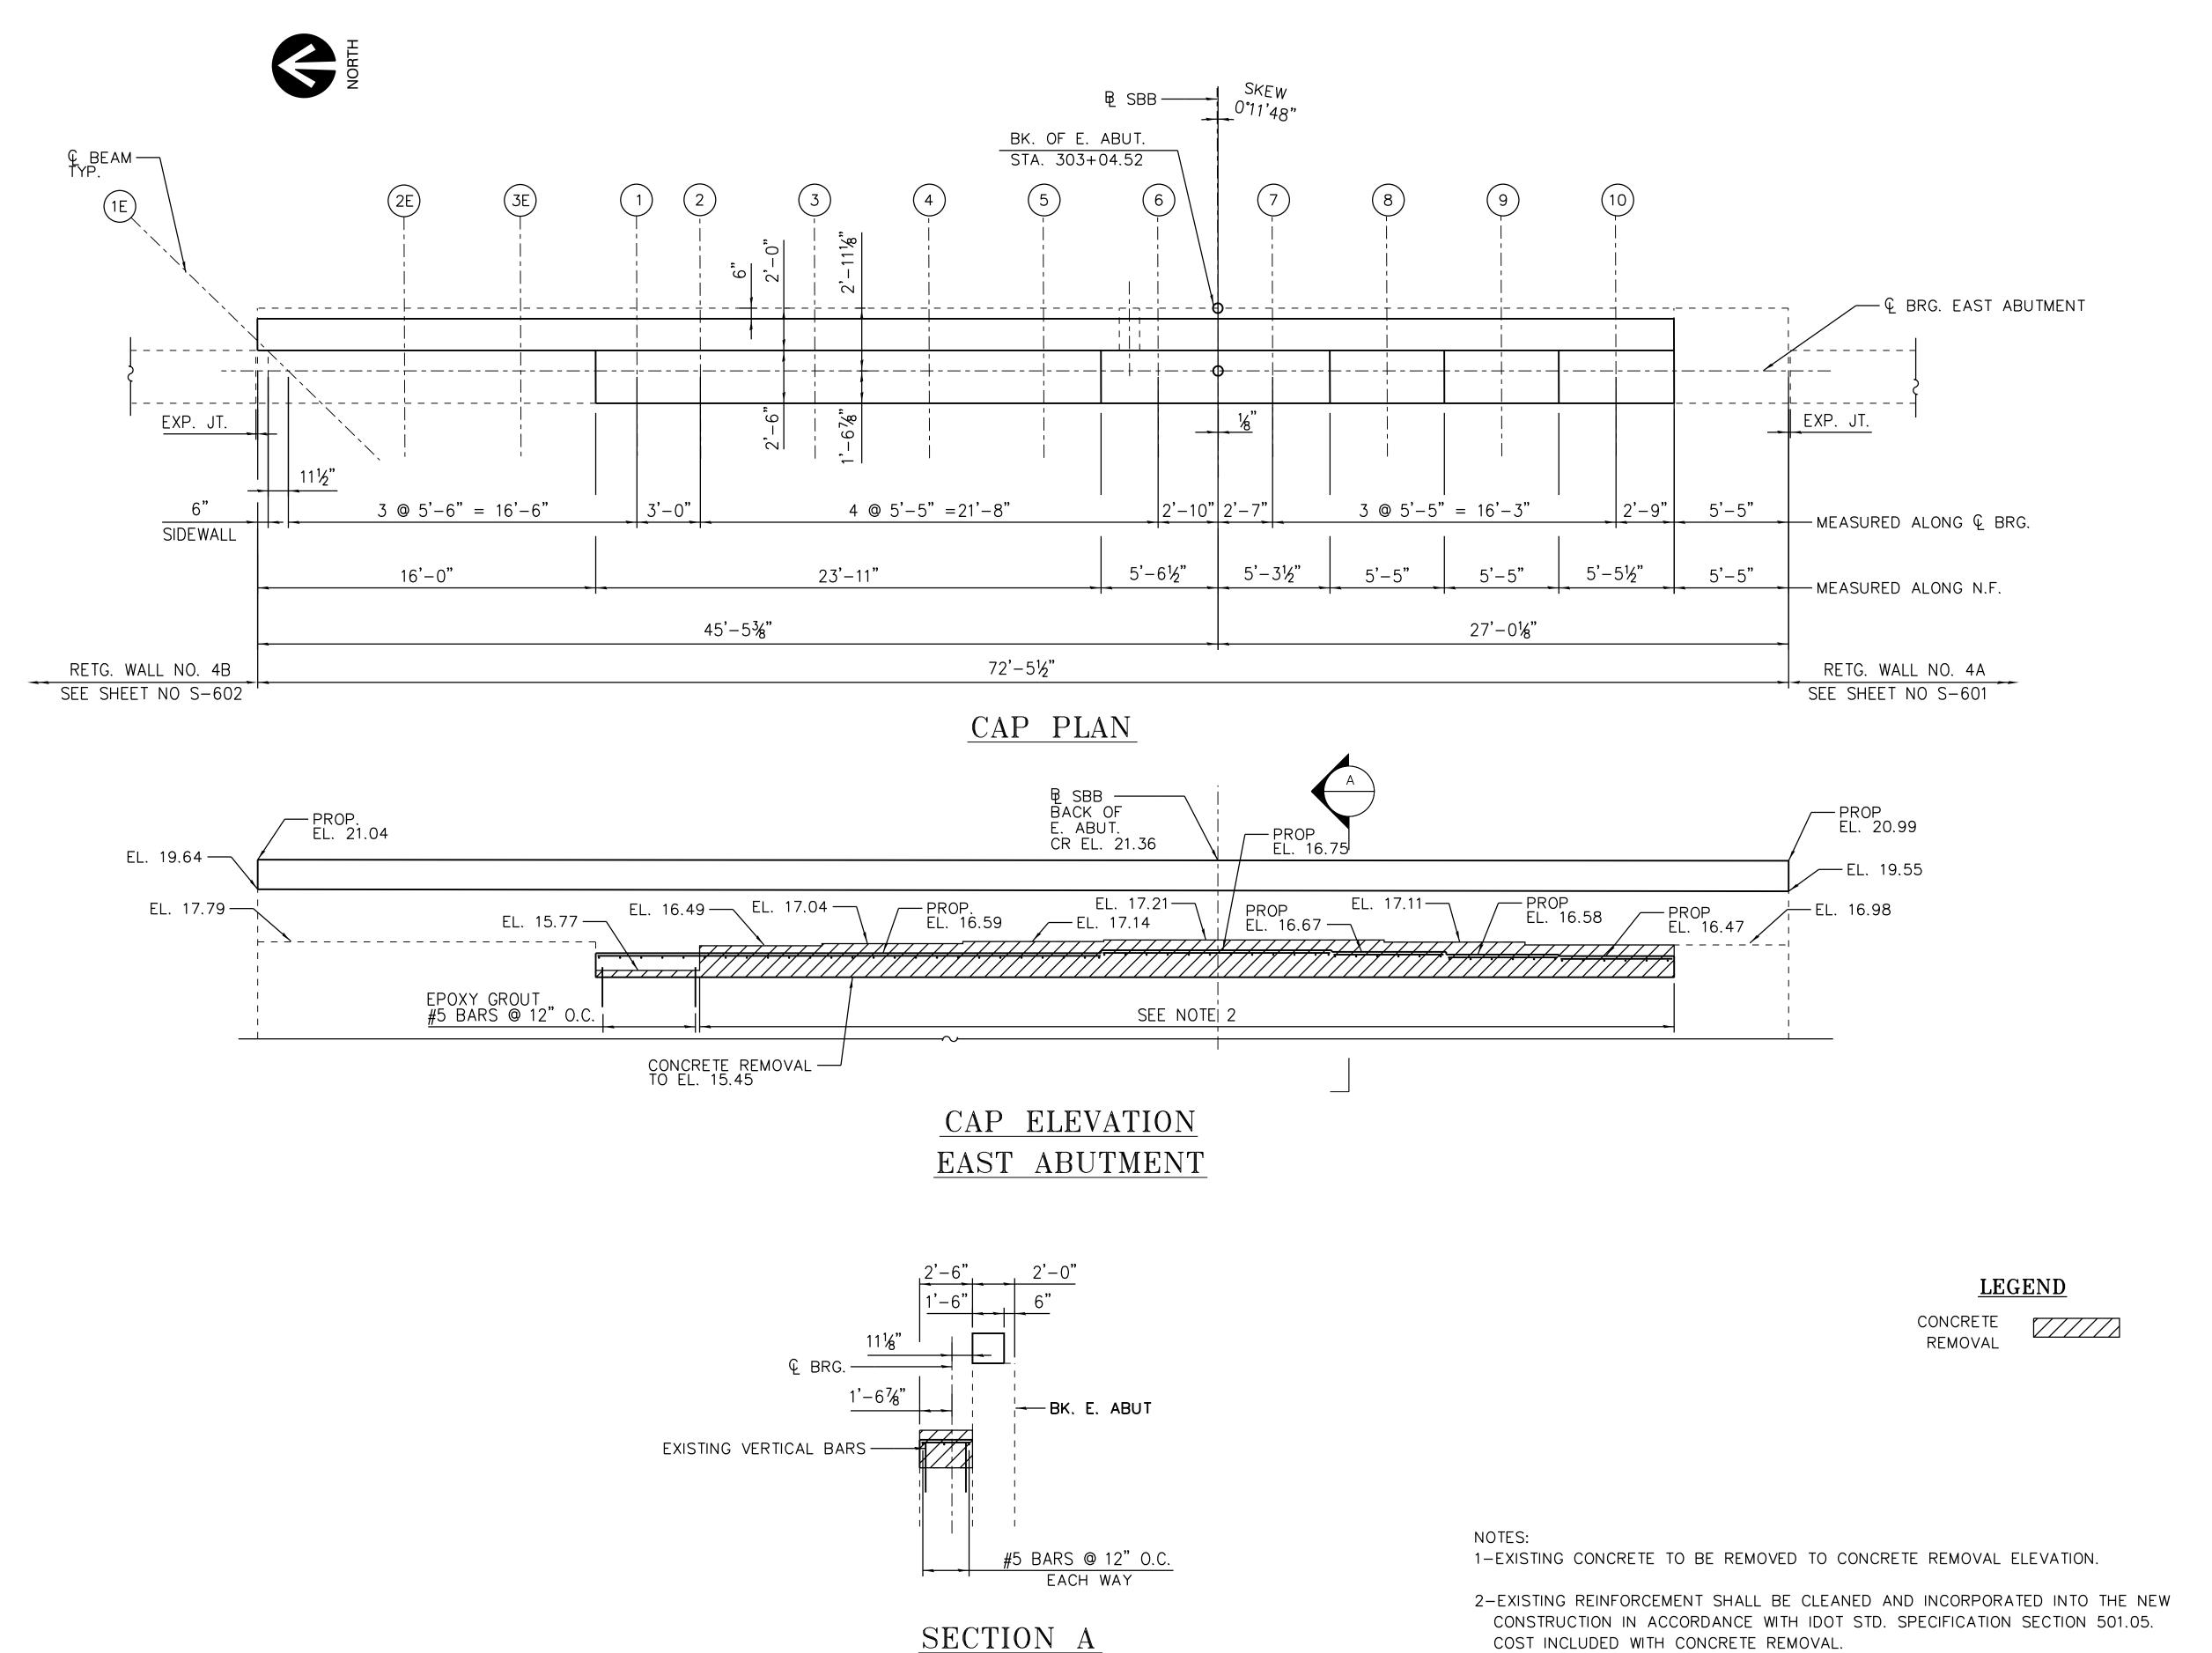



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# 95th Terminal Improvement

15 West 95th Street (South Terminal) Chicago, IL 60628


IN CH	ARGE	S. KADERBEK
APPR	OVED BY	D.ZROKA
CHEC	KED BY	P.MAID
DESIG	SNED BY	L.SOMMER
DRAV	VN BY	T.SLEDGE
PROJ	ECT NO.	2012-0021
FILE I	NAME	File Name
	2/9/17	ISSUED FOR CONSTRUCTION
	DATE	DESCRIPTION


LOCATION IDENTIFIER:

3-BEARING SEAT TO BE RECONSTRUCTED TO PROPOSED ELEVATION.

SOUTH BUS BRIDGE EAST ABUTMENT BEARING SEATS

**SBB-S-231A** 

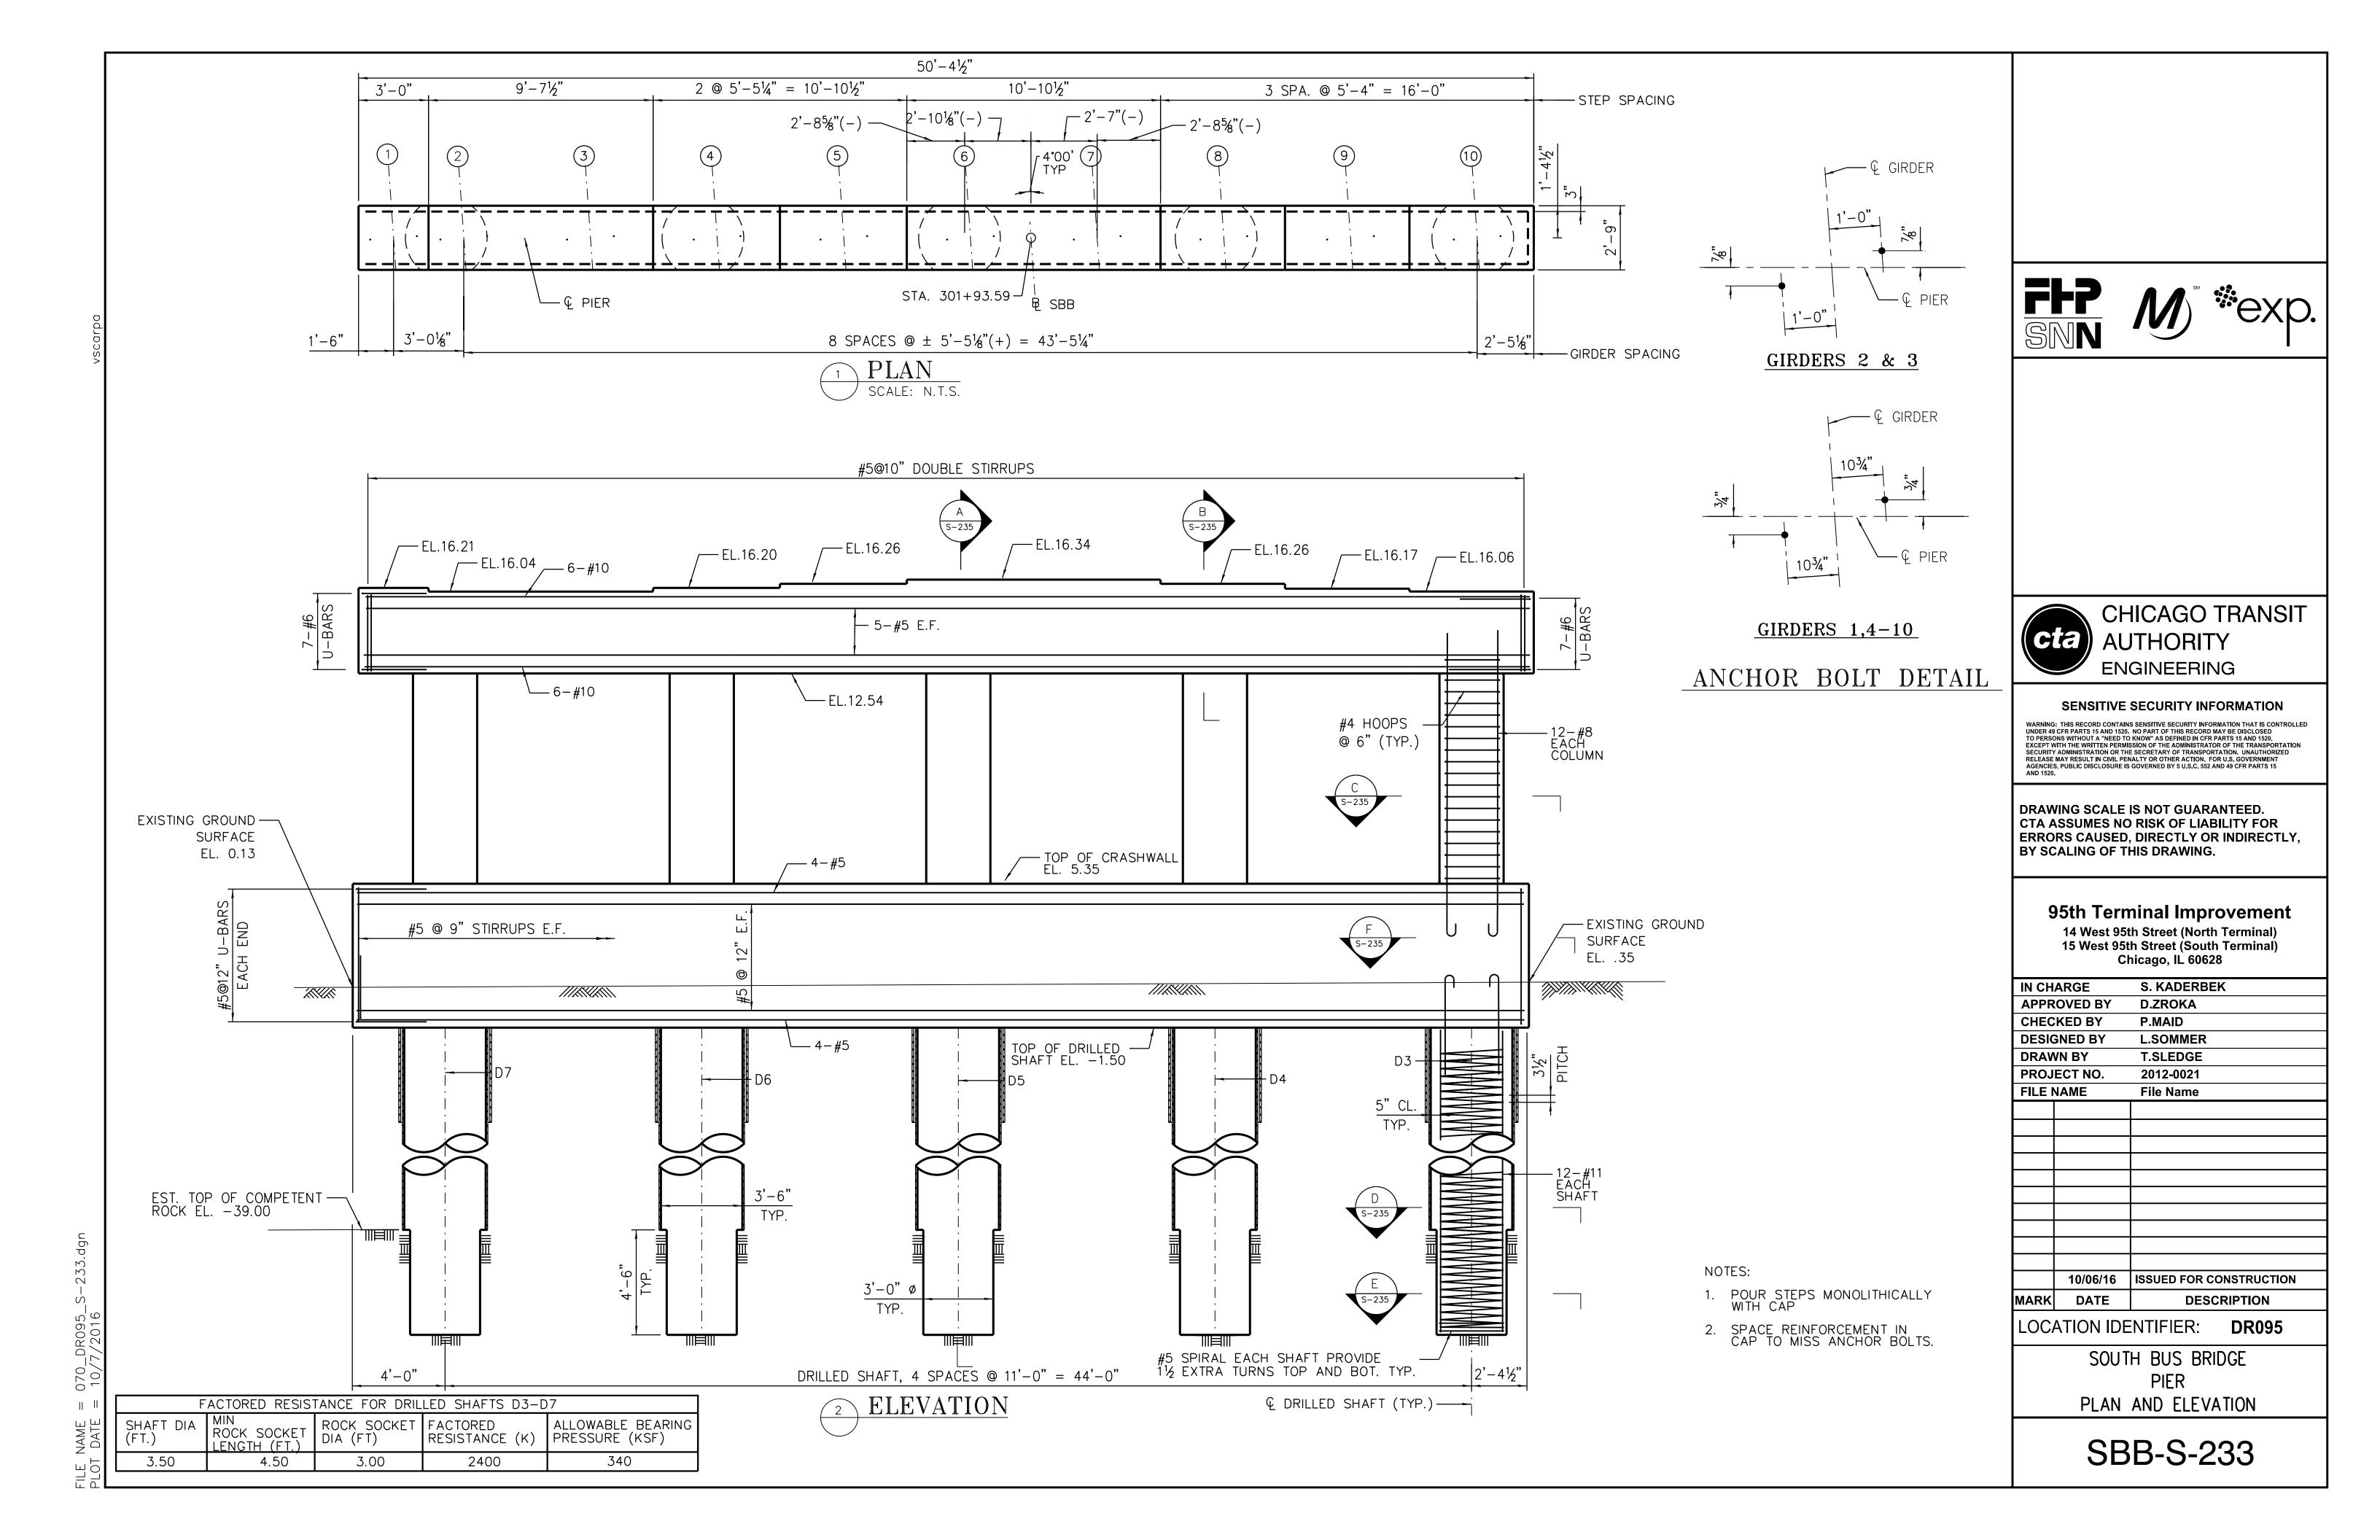

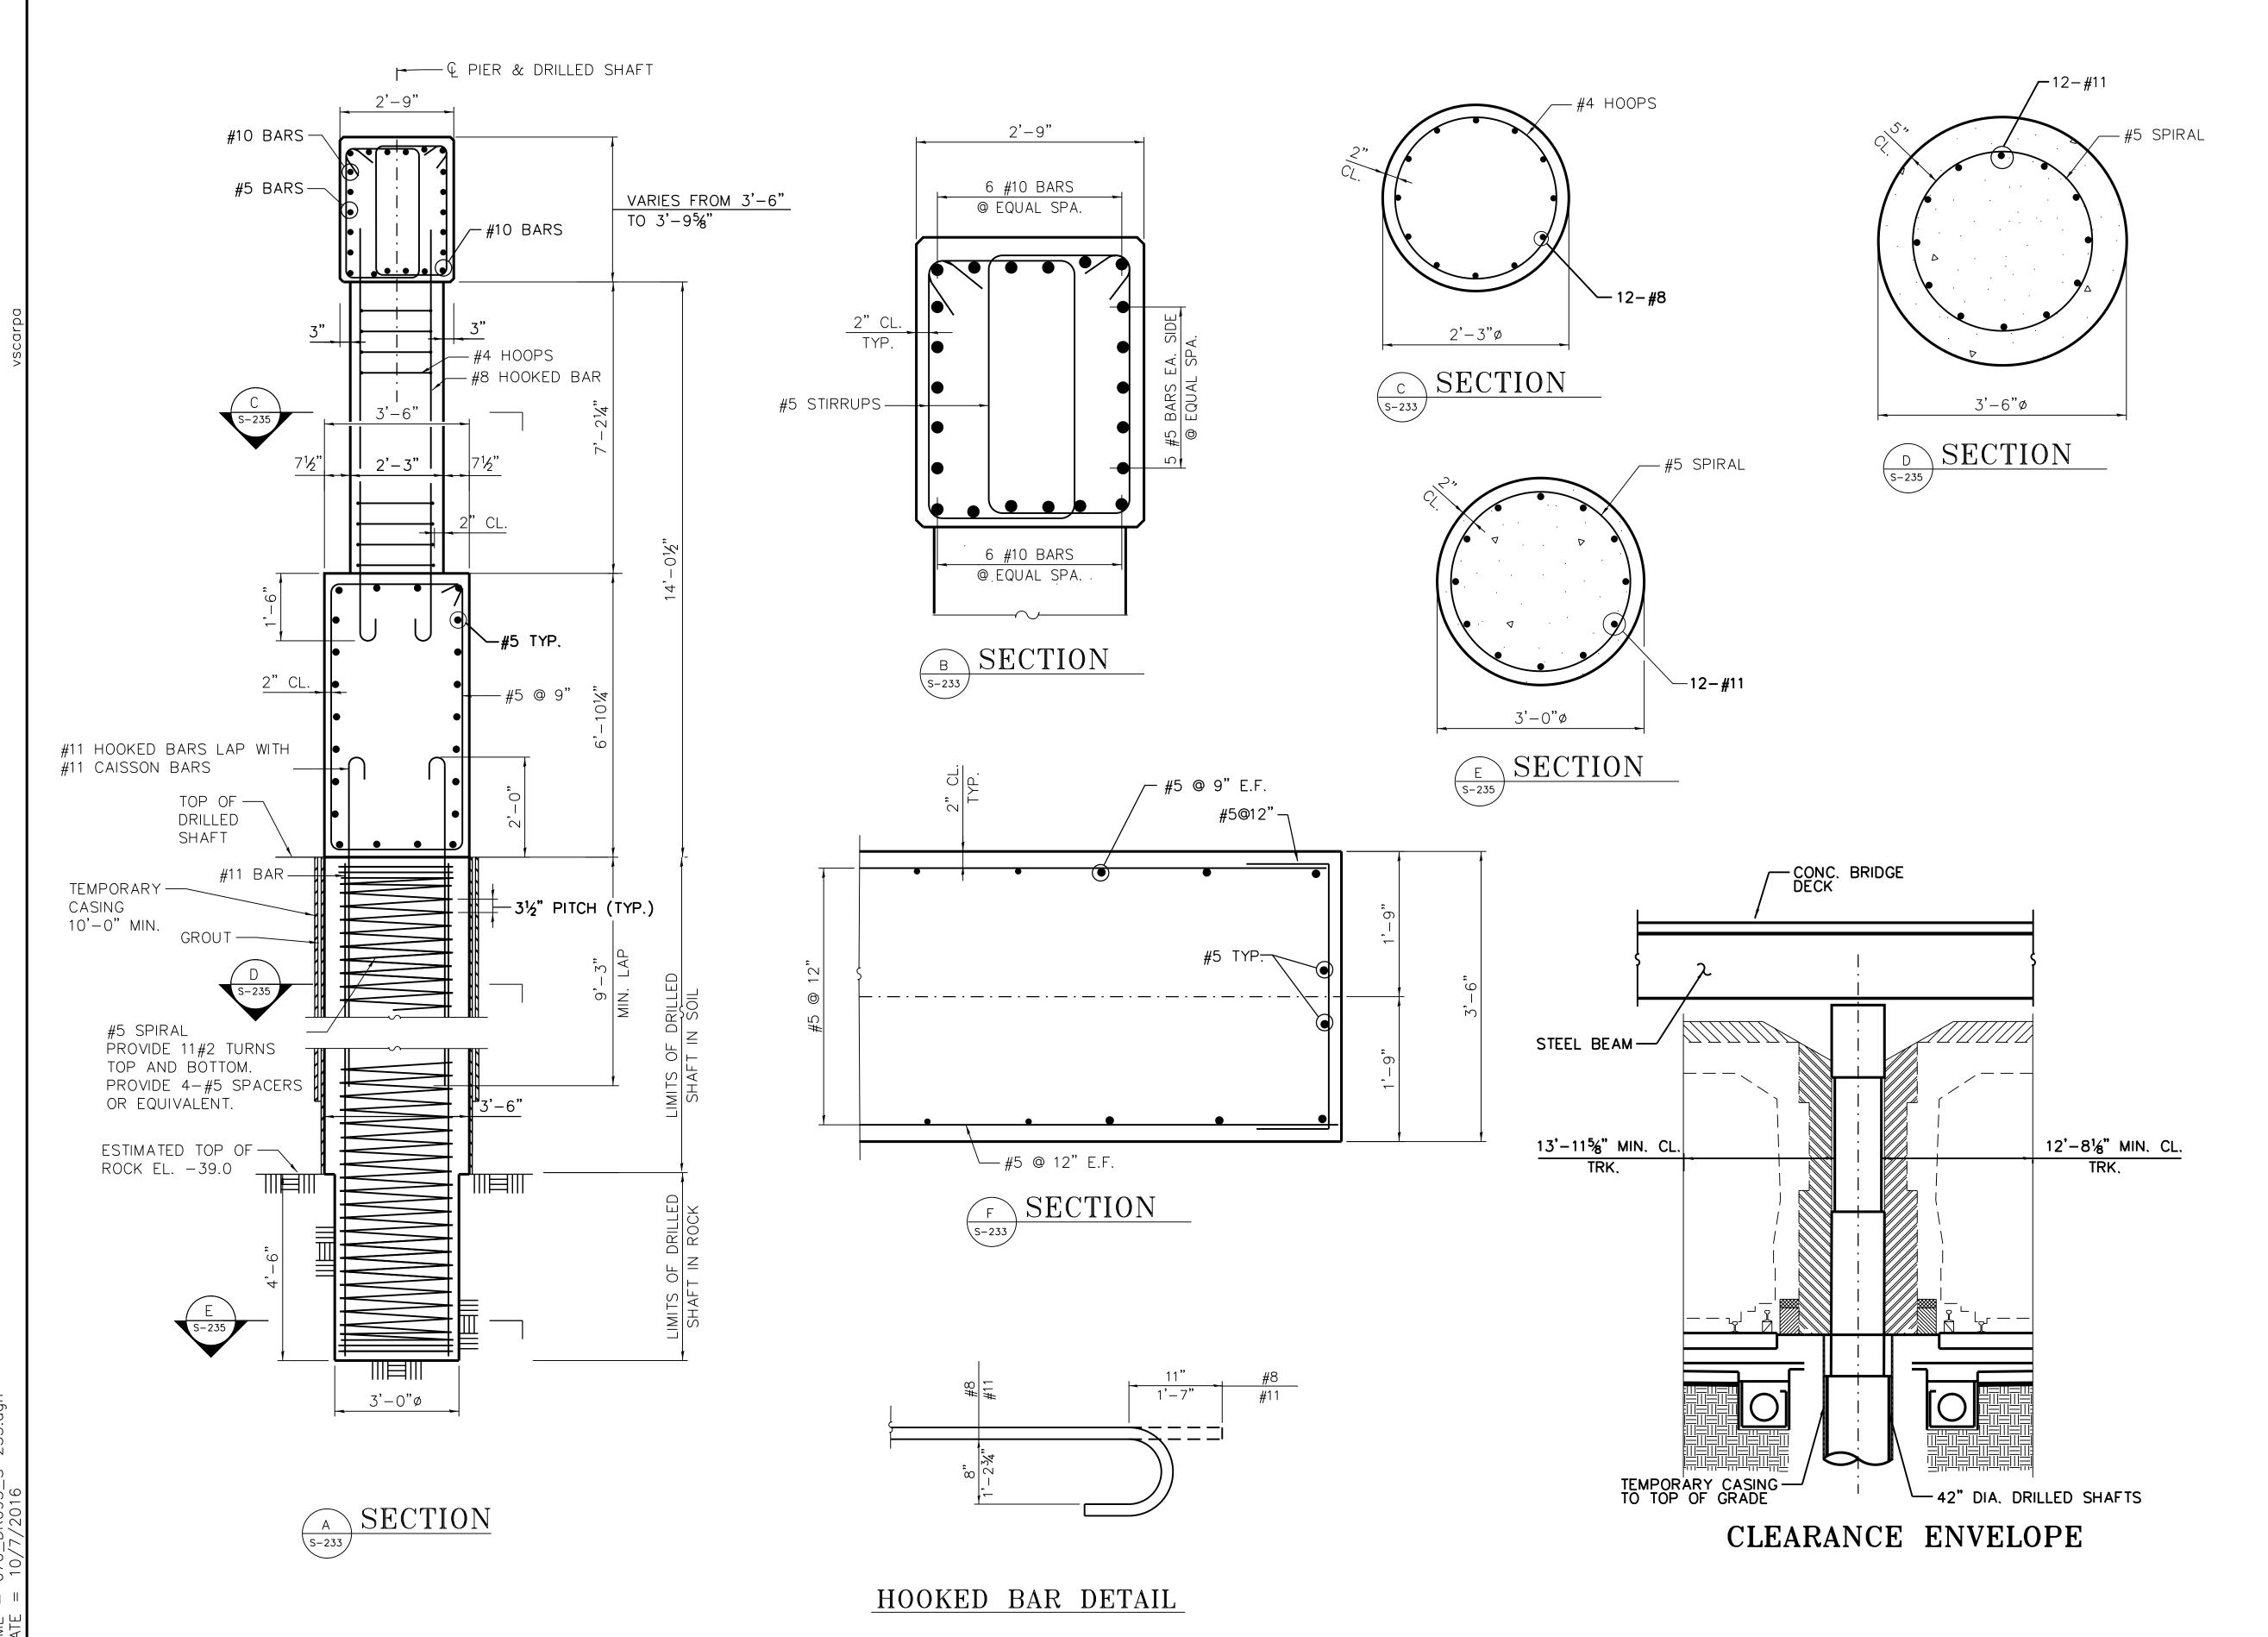





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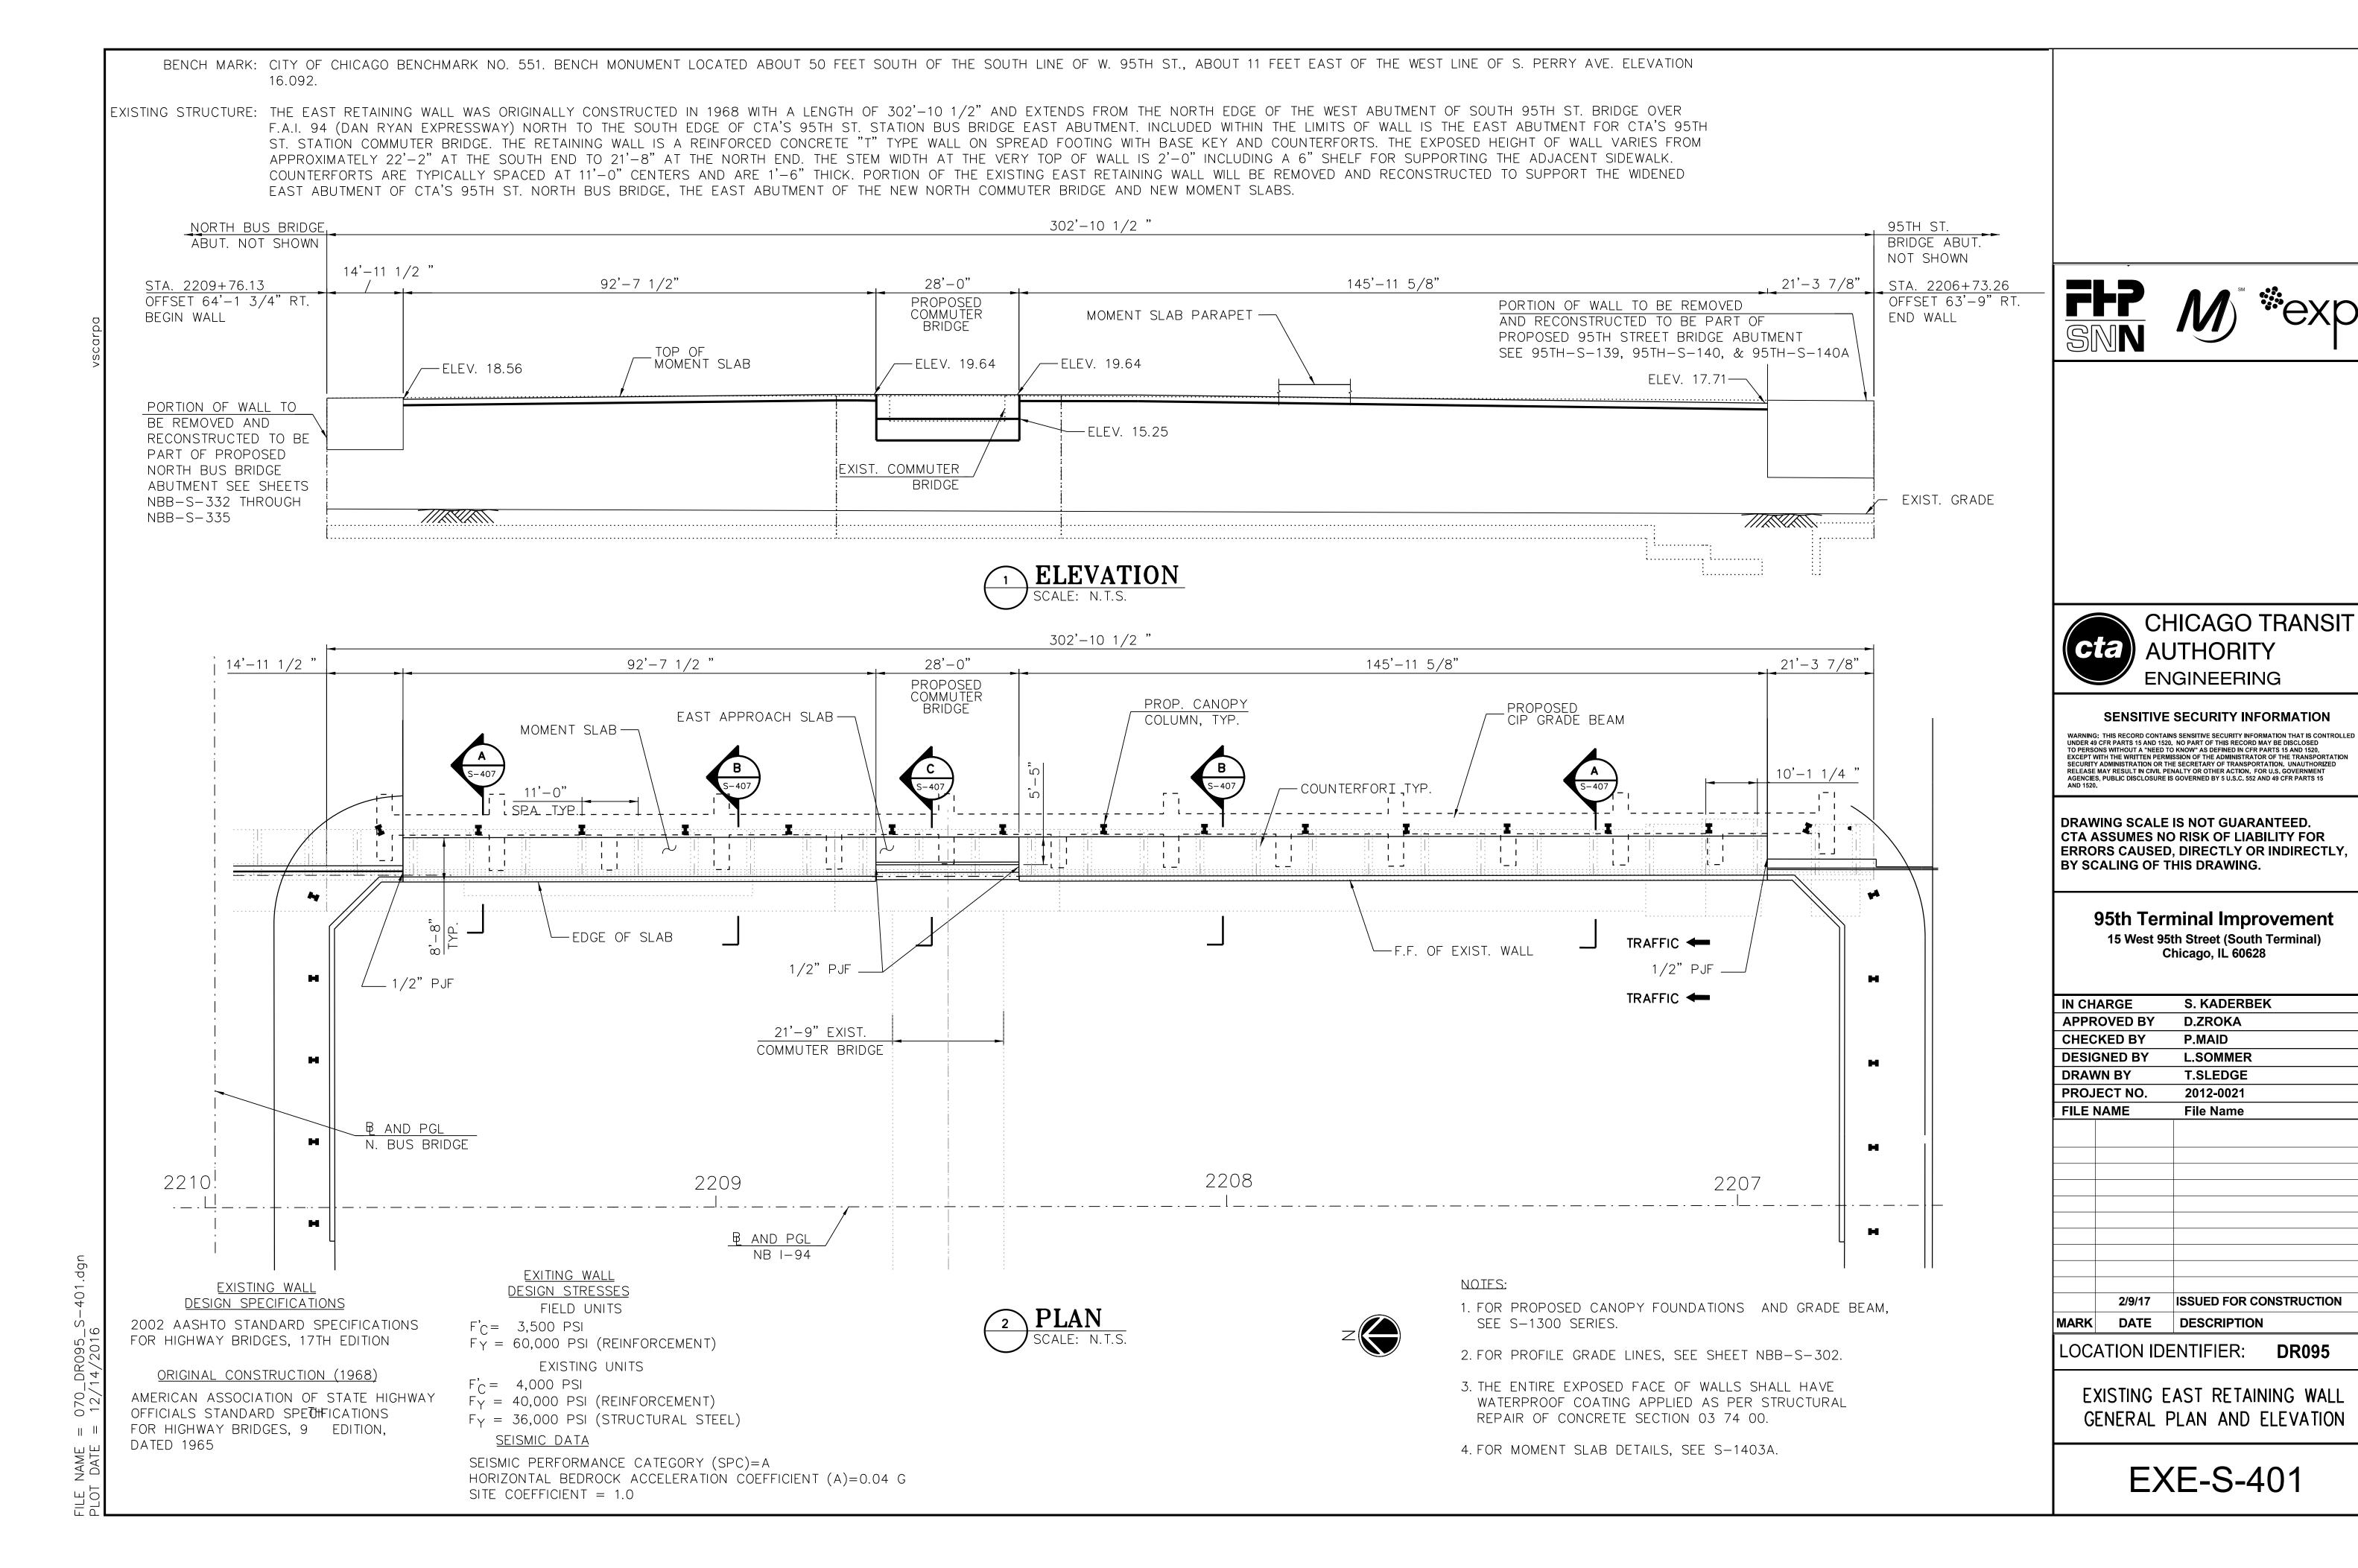
#### 95th Terminal Improvement


14 West 95th Street (North Terminal) 15 West 95th Street (South Terminal) Chicago, IL 60628

IN CHARGE		S. KADERBEK
APPROVED BY		D.ZROKA
CHECKED BY		P.MAID
DESIG	GNED BY	L.SOMMER
DRAV	VN BY	T.SLEDGE
PROJ	ECT NO.	2012-0021
FILE	NAME	File Name
	10/06/16	ISSUED FOR CONSTRUCTION
MARK	DATE	DESCRIPTION

LOCATION IDENTIFIER: DR095

SOUTH BUS BRIDGE PIER DETAILS



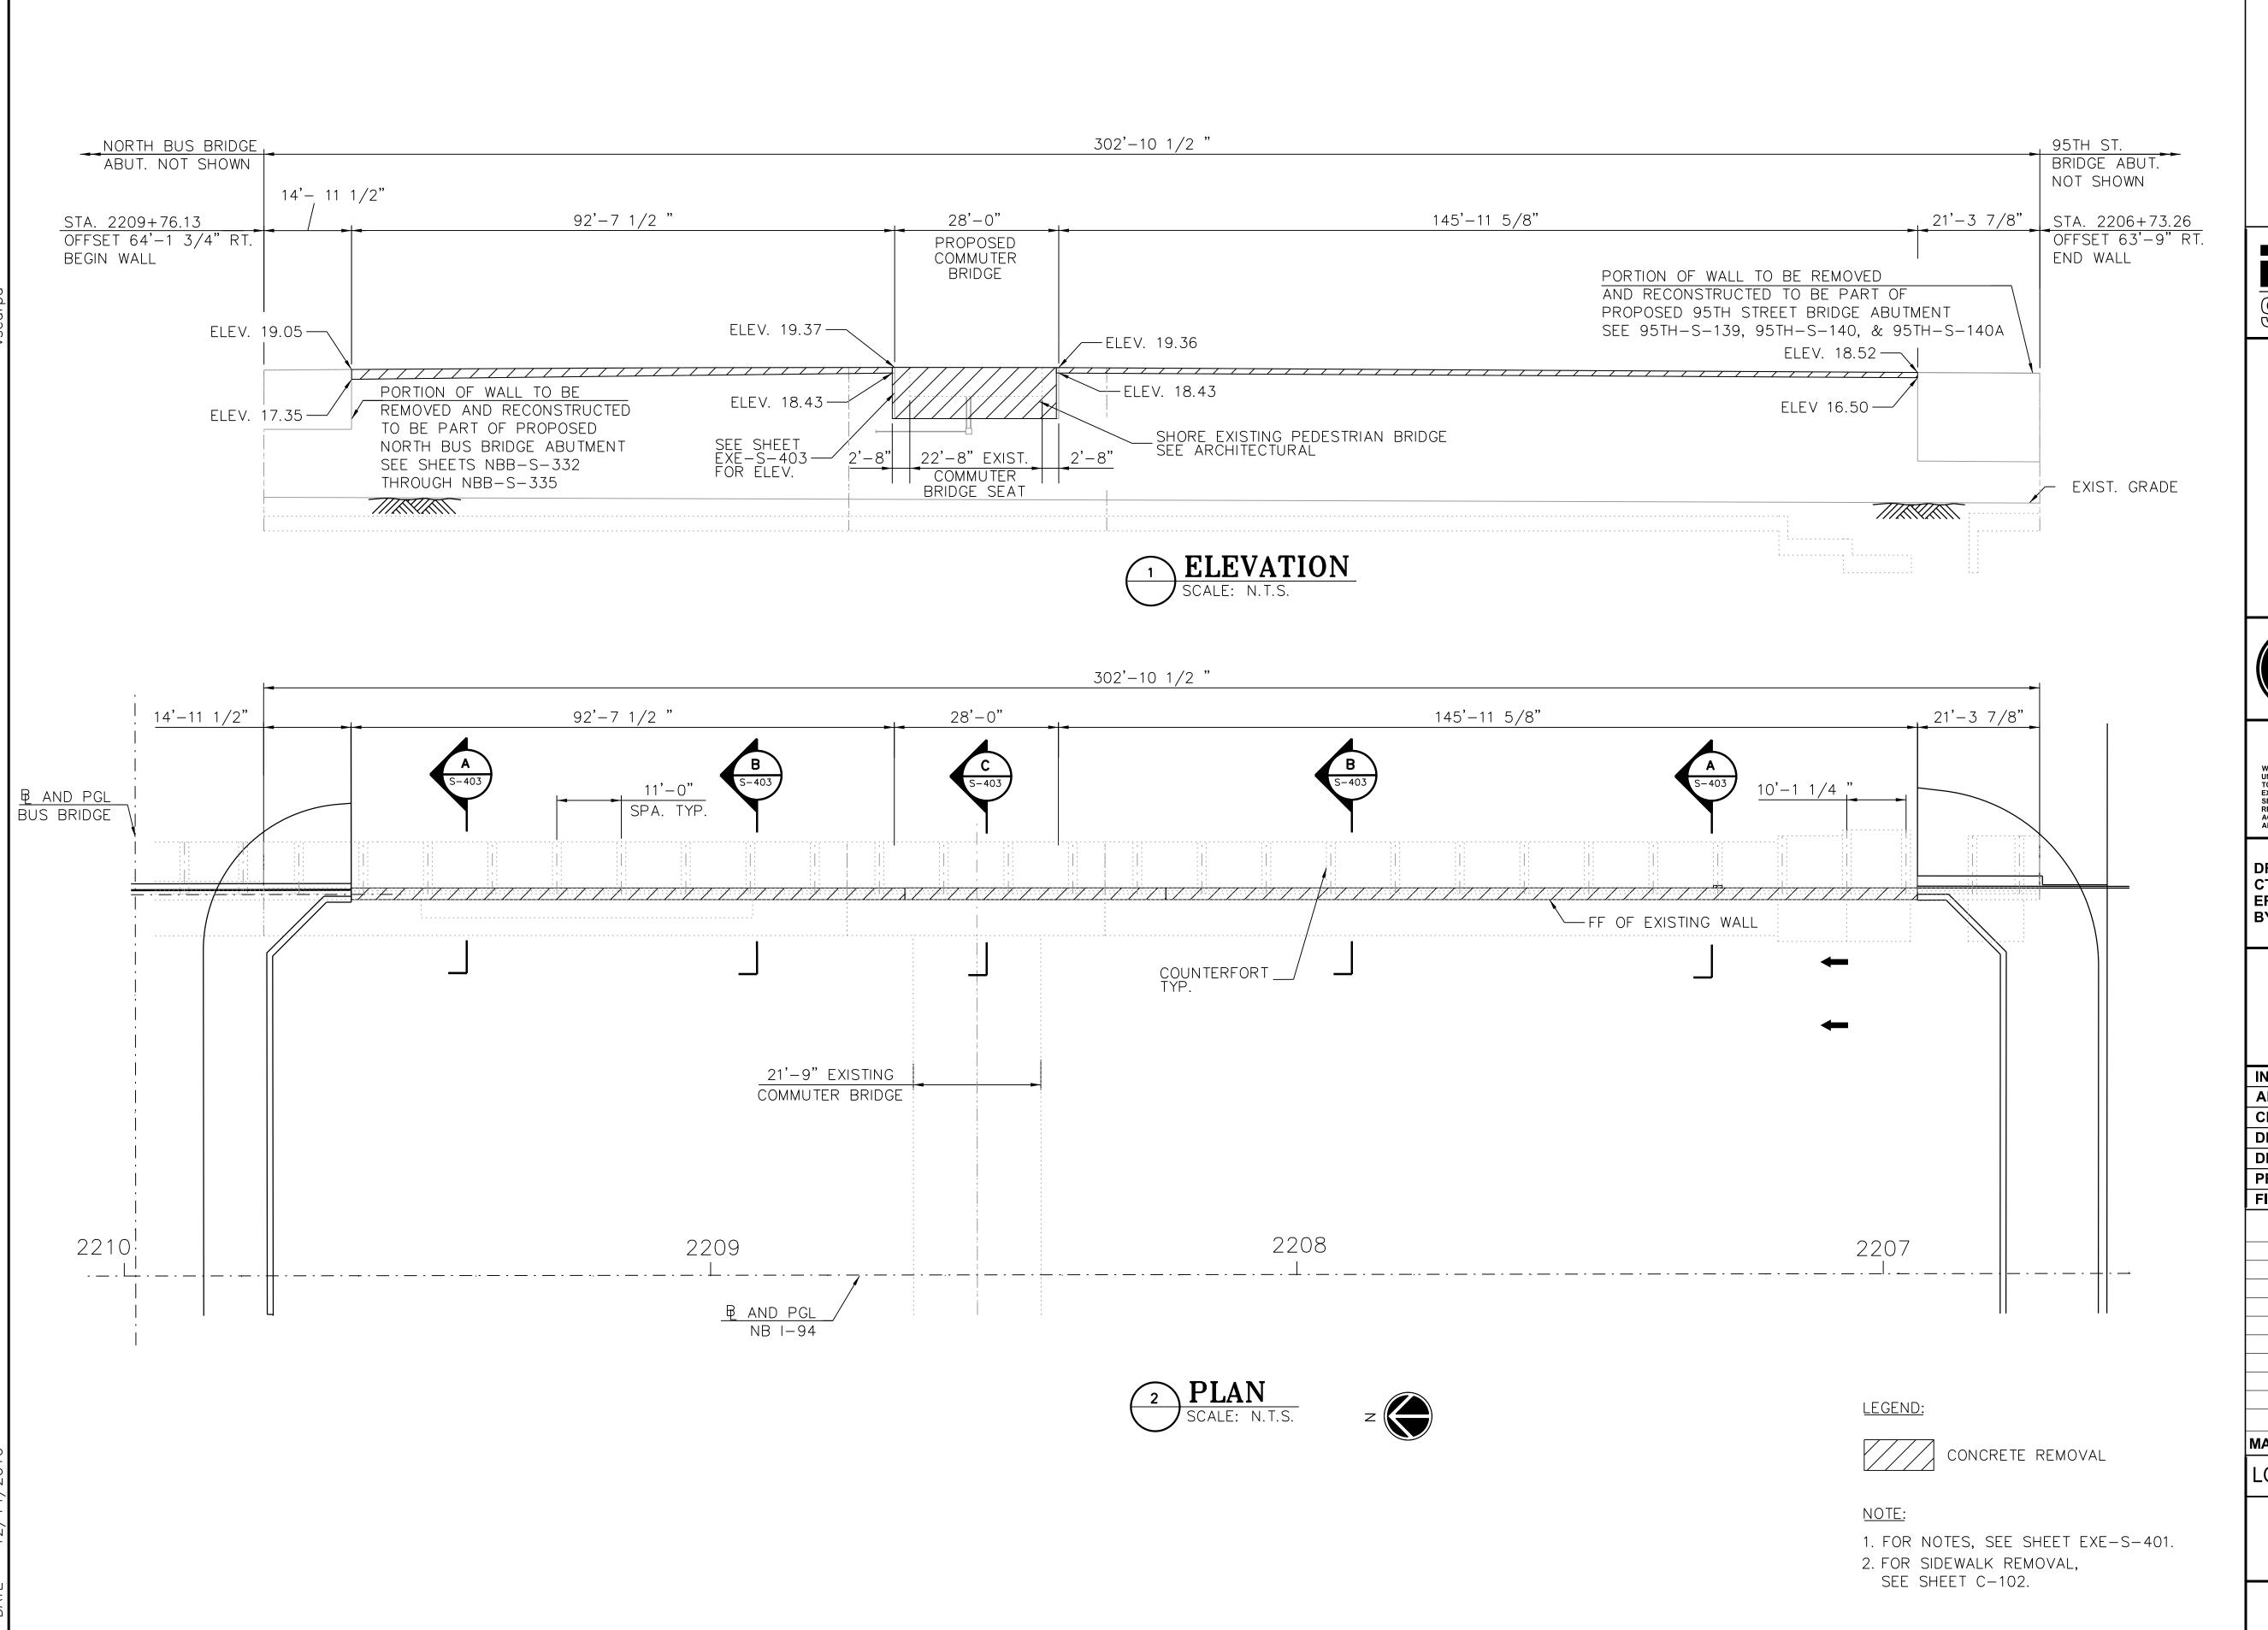





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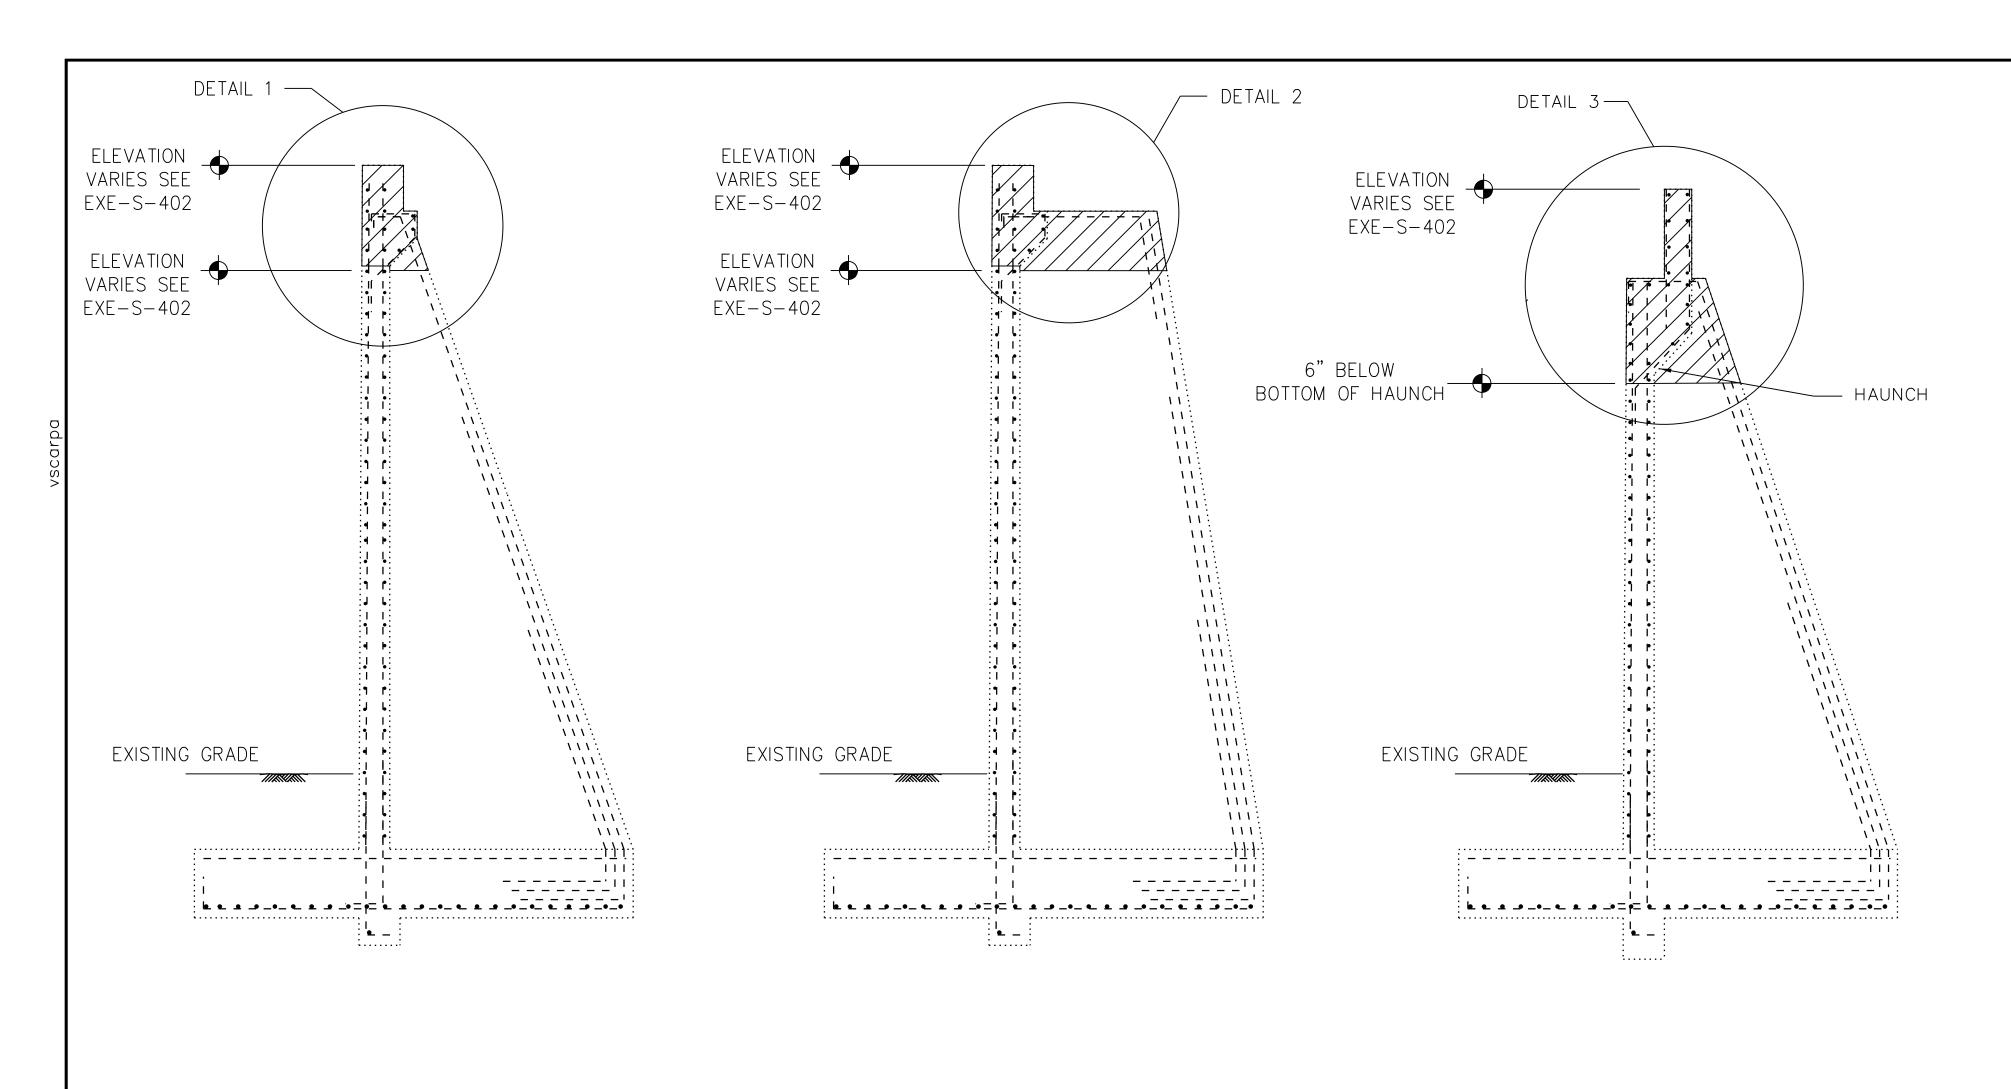
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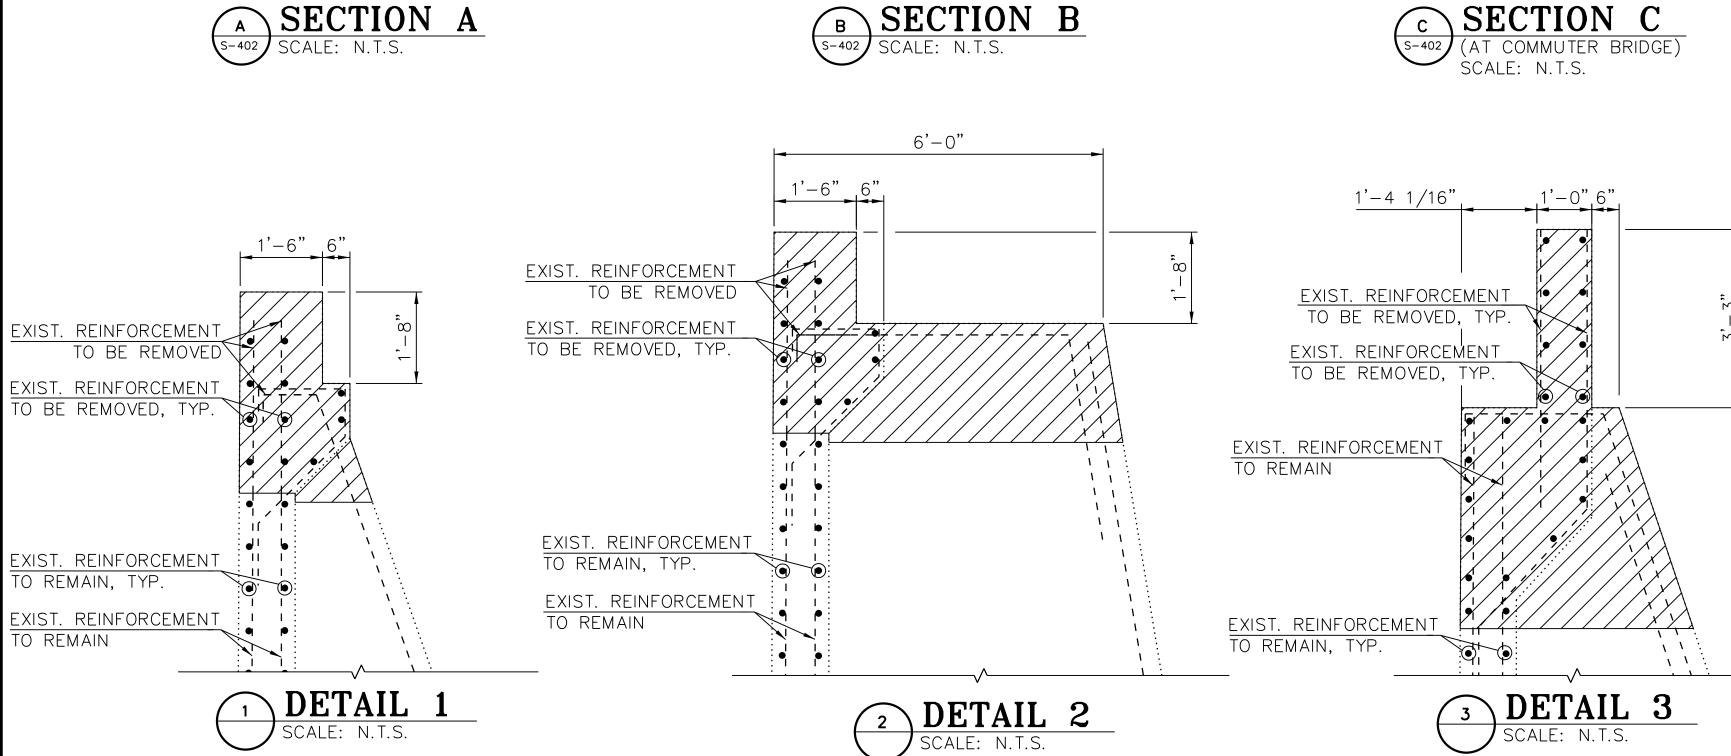
# 95th Terminal Improvement

15 West 95th Street (South Terminal) Chicago, IL 60628

IN CH	ARGE	S. KADERBEI	<b>K</b>
APPR	OVED BY	D.ZROKA	
CHEC	KED BY	P.MAID	
DESIG	ENED BY	L.SOMMER	
DRAV	N BY	T.SLEDGE	
PROJ	ECT NO.	2012-0021	
FILE N	NAME	File Name	
	2/9/17	ISSUED FOR CO	NSTRUCTION
MARK	DATE	DESCRIPTION	
IVIARN	DAIE	DESCRIPTION	
LOC	LOCATION IDENTIFIER: DR095		

EXISTING EAST RETAINING WALL REMOVAL PLAN AND ELEVATION





# **ENGINEERING**

#### **SENSITIVE SECURITY INFORMATION**

**AUTHORITY** 

**CHICAGO TRANSIT** 

UNDER 49 CFR PARTS 15 AND 1520. NO PART OF THIS RECORD MAY BE DISCLOSED TO PERSONS WITHOUT A "NEED TO KNOW" AS DEFINED IN CFR PARTS 15 AND 1520, EXCEPT WITH THE WRITTEN PERMISSION OF THE ADMINISTRATOR OF THE TRANSPORTATION SECURITY ADMINISTRATION OR THE SECRETARY OF TRANSPORTATION. UNAUTHOR RELEASE MAY RESULT IN CIVIL PENALTY OR OTHER ACTION. FOR U.S. GOVERNMENT

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### 95th Terminal Improvement 15 West 95th Street (South Terminal) Chicago, IL 60628

IN CHARGE S. KADERBEK APPROVED BY D.ZROKA CHECKED BY P.MAID **DESIGNED BY L.SOMMER** DRAWN BY T.SLEDGE PROJECT NO. 2012-0021 FILE NAME File Name 2/9/17 ISSUED FOR CONSTRUCTION

LOCATION IDENTIFIER: **DR095** 

DESCRIPTION

MARK

DATE

EXISTING EAST RETAINING WALL REMOVAL SECTIONS & DETAILS

EXE-S-403

1. EXISTING REINFORCEMENT EXTENDED INTO NEW CONCRETE SHALL BE CLEANED, STRAIGHTENED, AND

INCORPORATED INTO THE NEW CONSTRUCTION.

2. ANY REINFORCEMENT BARS THAT ARE DAMAGED DURING CONCRETE REMOVAL OPERATIONS SHALL BE REPAIRED OR REPLACED USING AN APPROVED

BAR SPLICER OR ANCHORAGE SYSTEM.


GROUT AT NO ADDITIONAL COST.

3. SAWCUT WALL TO PROVIDE CLEAN BEARING

SURFACE FOR MOMENT SLABS. DAMAGED CONCRETE TO BE REPAIRED WITH NON-SHRINK


NOTES

LEGEND:

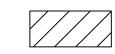

CONCRETE REMOVAL

# EXISTING ELEVATION OF EAST RETAINING WALL (LOOKING EAST) SCALE: N.T.S.

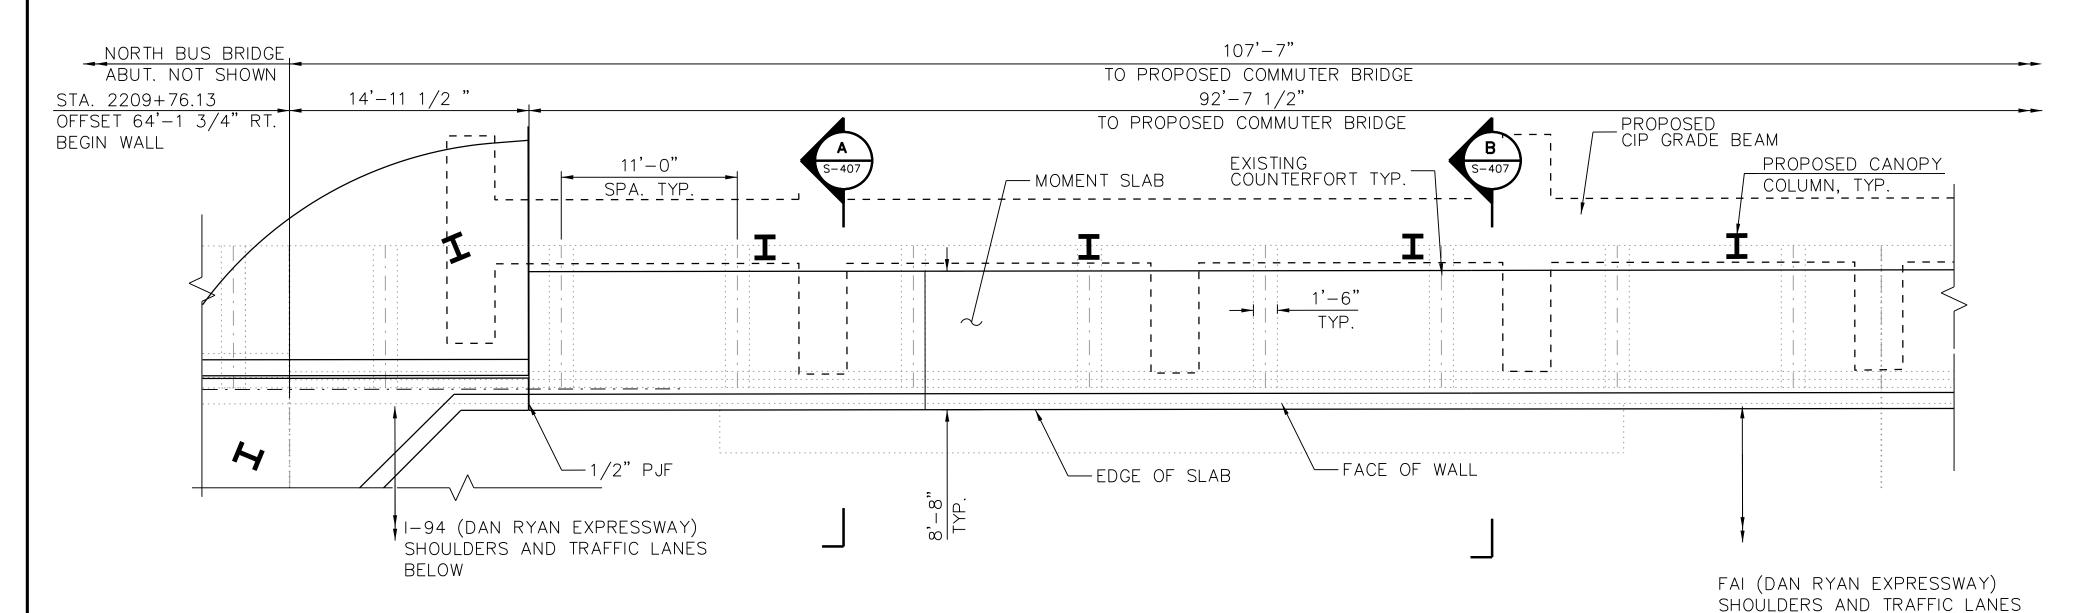

EXISTING EAST RETAINING WALL PLAN
SCALE: N.T.S.



#### NOTES:

- 1. FOR PORTION OF WALL TO BE REMOVED AND RECONSTRUCTED TO BE PART OF PROPOSED NORTH BUS BRIDGE ABUTMENT, SEE NORTH BUS BRIDGE PLANS.
- 2. FOR PORTION OF WALL TO BE REMOVED AND RECONSTRUCTED TO BE PART OF PROPOSED COMMUTER BRIDGE ABUTMENT, SEE SHEETS EXE-S-405 AND EXE-S-407.
- 3. FOR STRUCTURAL REPAIR OF CONCRETE DETAILS, SEE SHEET 95TH-S-150A
- 4. FOR EXPANSION JOINT DETAILS, SEE SHEET 95TH-S-122.
- 5. THE ENTIRE EXPOSED FACE OF WALLS SHALL HAVE WATERPROOF COATING APPLIED AS PER STRUCTURAL REPAIR OF CONCRETE SECTION 03 74 00.

- 6. FOR PROPOSED CANOPY FOUNDATIONS AND GRADE BEAMS, SEE S-1300 SERIES.
- 7. FOR MOMENT SLAB DETAILS, SEE S-1403A.

LEGEND:



STRUCTURAL REPAIR OF CONCRETE (DEPTH GREATER THAN 5 INCHES)



STRUCTURAL REPAIR OF CONCRETE (DEPTH EQUAL TO OR LESS THAN 5 INCHES)



·

SF - SQUARE FOOT

LF - LINEAR FOOT

FHP SNN





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# 95th Terminal Improvement 15 West 95th Street (South Terminal) Chicago, IL 60628

IN CHARGE S. KADERBEK
APPROVED BY D.ZROKA
CHECKED BY P.MAID
DESIGNED BY L.SOMMER
DRAWN BY T.SLEDGE
PROJECT NO. 2012-0021


FILE NAME		File Name
	2/9/17	ISSUED FOR CONSTRUCTION

LOCATION IDENTIFIER: DR095

MARK DATE DESCRIPTION

EXISTING EAST RETAINING WALL PLAN & ELEVATION (SHEET 1 OF 3)

# TEXISTING ELEVATION OF EAST RETAINING WALL (LOOKING EAST) SCALE: N.T.S.

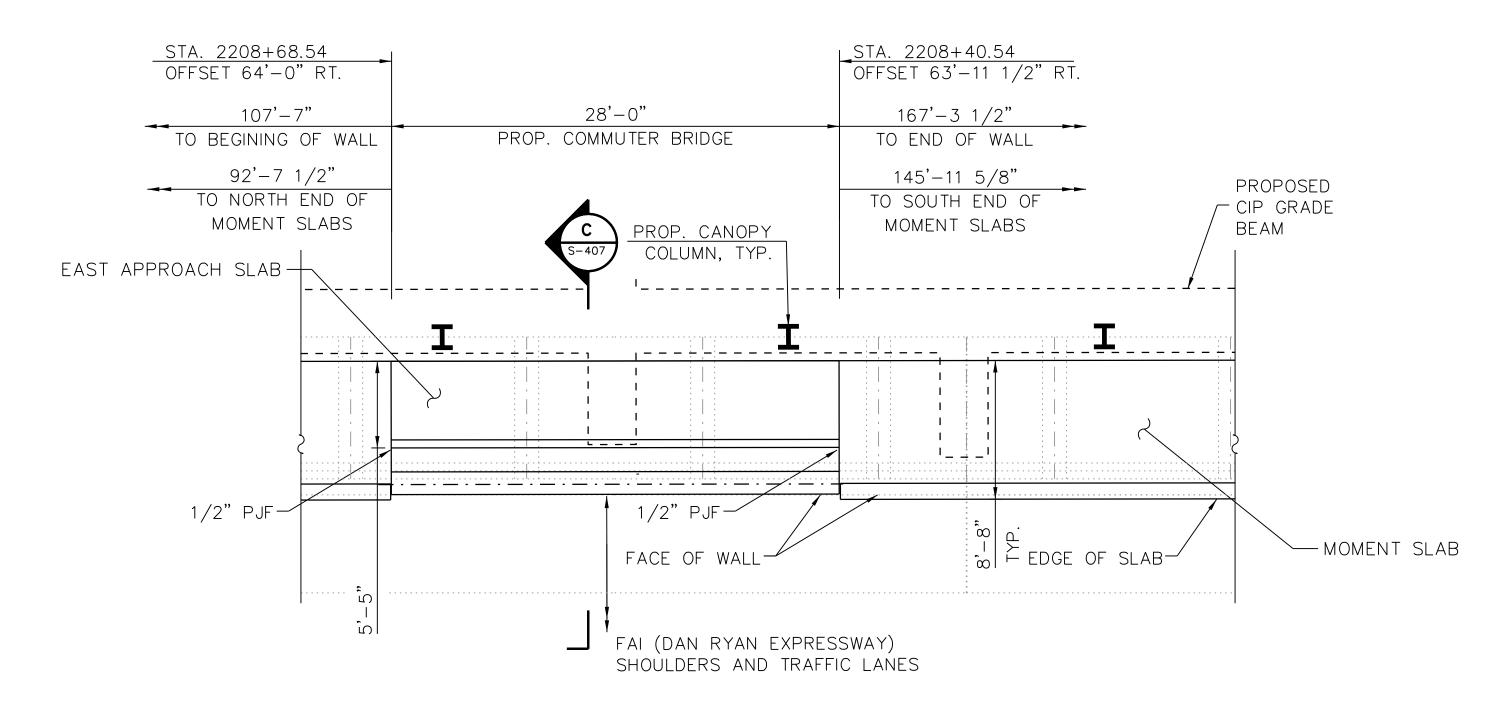


EXISTING EAST RETAINING WALL PLAN SCALE: N.T.S.



NOTES:


- 1. FOR PORTION OF WALL TO BE REMOVED AND RECONSTRUCTED TO BE PART OF PROPOSED NORTH BUS BRIDGE ABUTMENT, SEE NORTH BUS BRIDGE PLANS.
- 2. FOR STRUCTURAL REPAIR OF CONCRETE DETAILS, SEE SHEET 95TH-S-150A
- 3. THE ENTIRE EXPOSED FACE OF WALLS SHALL HAVE WATERPROOF COATING APPLIED AS PER STRUCTURAL REPAIR OF CONCRETE SECTION 03 74 00.
- 4. SEE SHEET C-200 TO C-203 FOR PENETRATION LOCATIONS.
- 5. FOR PROPOSED CANOPY FOUNDATIONS AND GRADE BEAMS, SEE S-1300 SERIES.
- 6. FOR MOMENT SLAB DETAILS, SEE S-1403A.

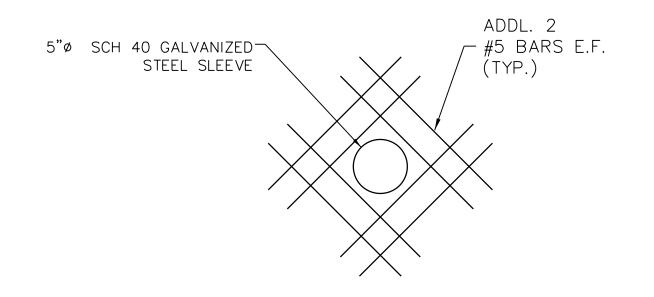

# 3 PENETRATION DETAIL

NOTE: GROUT BETWEEN PIPE AND SLEEVE AS REQUIRED.

#### <u>LEGEND:</u>

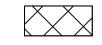

STRUCTURAL REPAIR OF CONCRETE (DEPTH GREATER THAN 5 INCHES)



STRUCTURAL REPAIR OF CONCRETE (DEPTH EQUAL TO OR LESS THAN 5 INCHES)



EPOXY SEAL (WIDTH >0.06")

- SQUARE FOOT

LINEAR FOOT





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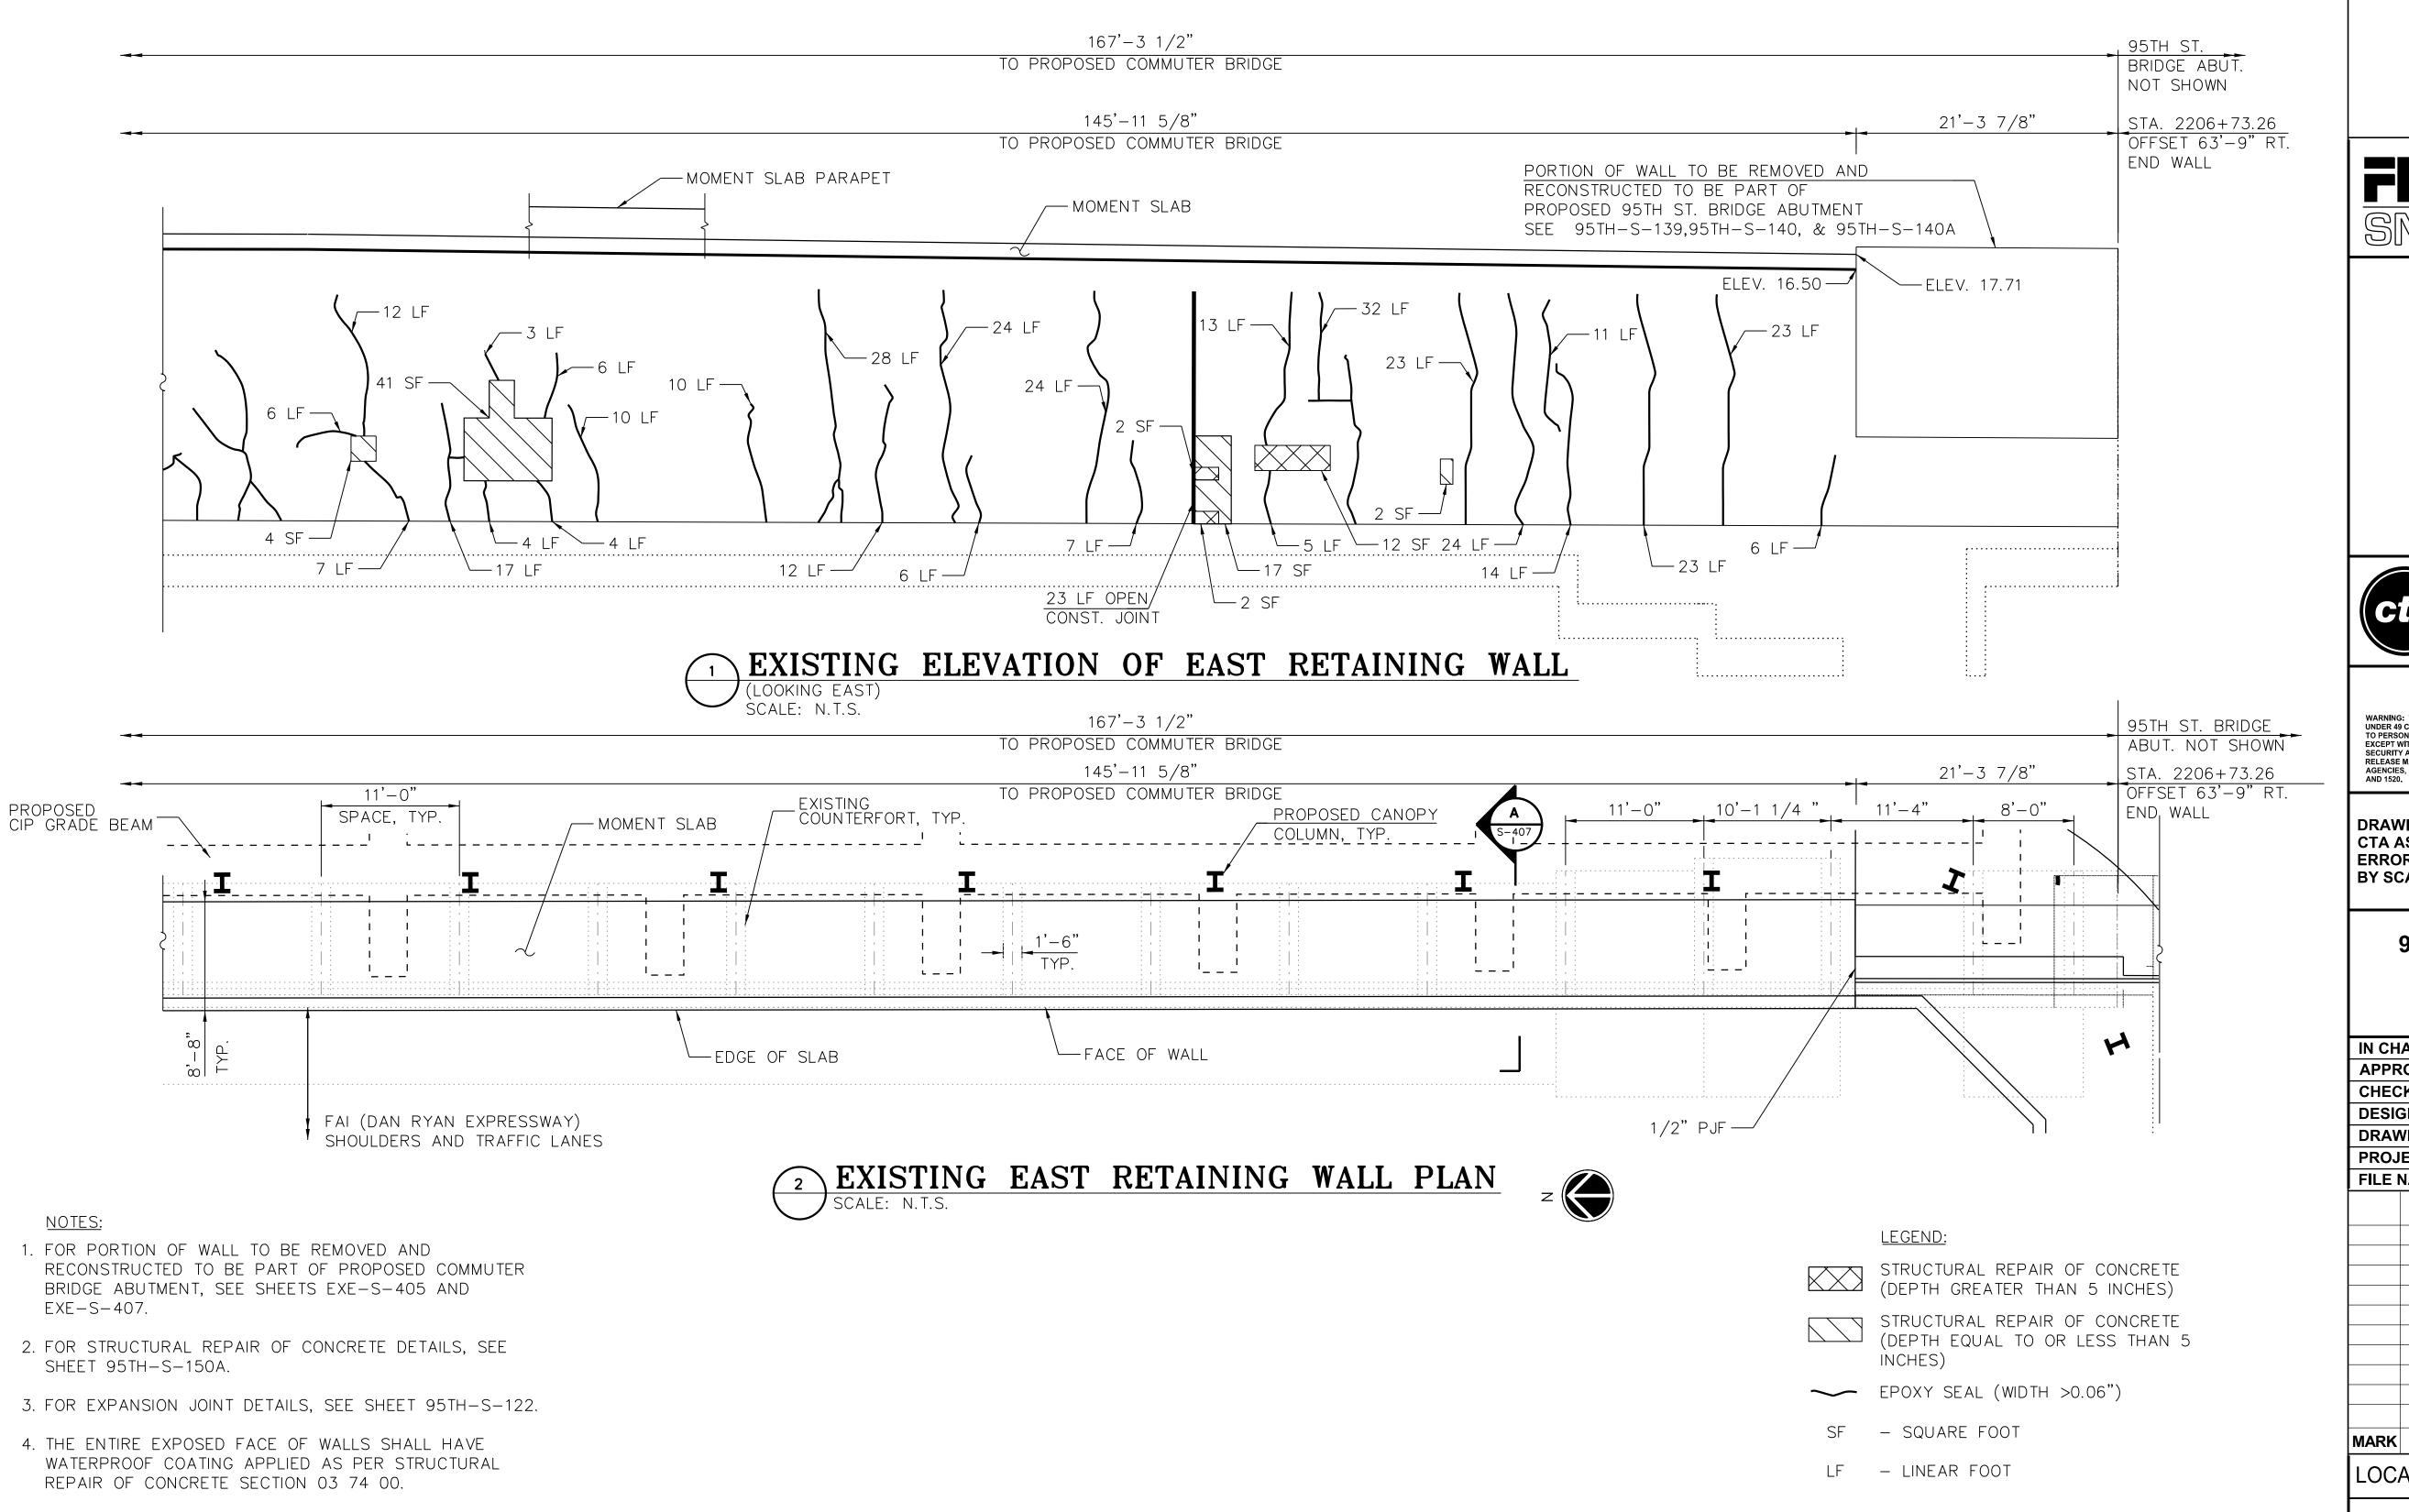
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# 95th Terminal Improvement

15 West 95th Street (South Terminal) Chicago, IL 60628

IN CHARGE		S. KADERBEK
APPROVED BY		D.ZROKA
CHECKED BY		P.MAID
DESIG	ENED BY	L.SOMMER
DRAW	/N BY	T.SLEDGE
PROJ	ECT NO.	2012-0021
FILE	NAME	File Name
	2/9/17	ISSUED FOR CONSTRUCTION
MARK	DATE	DESCRIPTION
LOCA	ATION IDE	ENTIFIER: <b>DR095</b>

EXISTING EAST RETAINING WALL PLAN & ELEVATION (SHEET 2 OF 3)



FFP SIN SEXP.



#### SENSITIVE SECURITY INFORMATION

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# 95th Terminal Improvement 15 West 95th Street (South Terminal) Chicago, IL 60628

IN CHARGE S. KADERBEK

APPROVED BY D.ZROKA

CHECKED BY P.MAID

DESIGNED BY L.SOMMER

DRAWN BY T.SLEDGE

PROJECT NO. 2012-0021

FILE NAME File Name

2/9/17 ISSUED FOR CONSTRUCTION
ARK DATE DESCRIPTION

LOCATION IDENTIFIER: DR095


EXISTING EAST RETAINING WALL PLAN & ELEVATION (SHEET 3 OF 3)

EXE-S-406

5. FOR PROPOSED CANOPY FOUNDATIONS AND GRADE BEAMS,

6. FOR MOMENT SLAB DETAILS, SEE S-1403A.

SEE S-1300 SERIES.

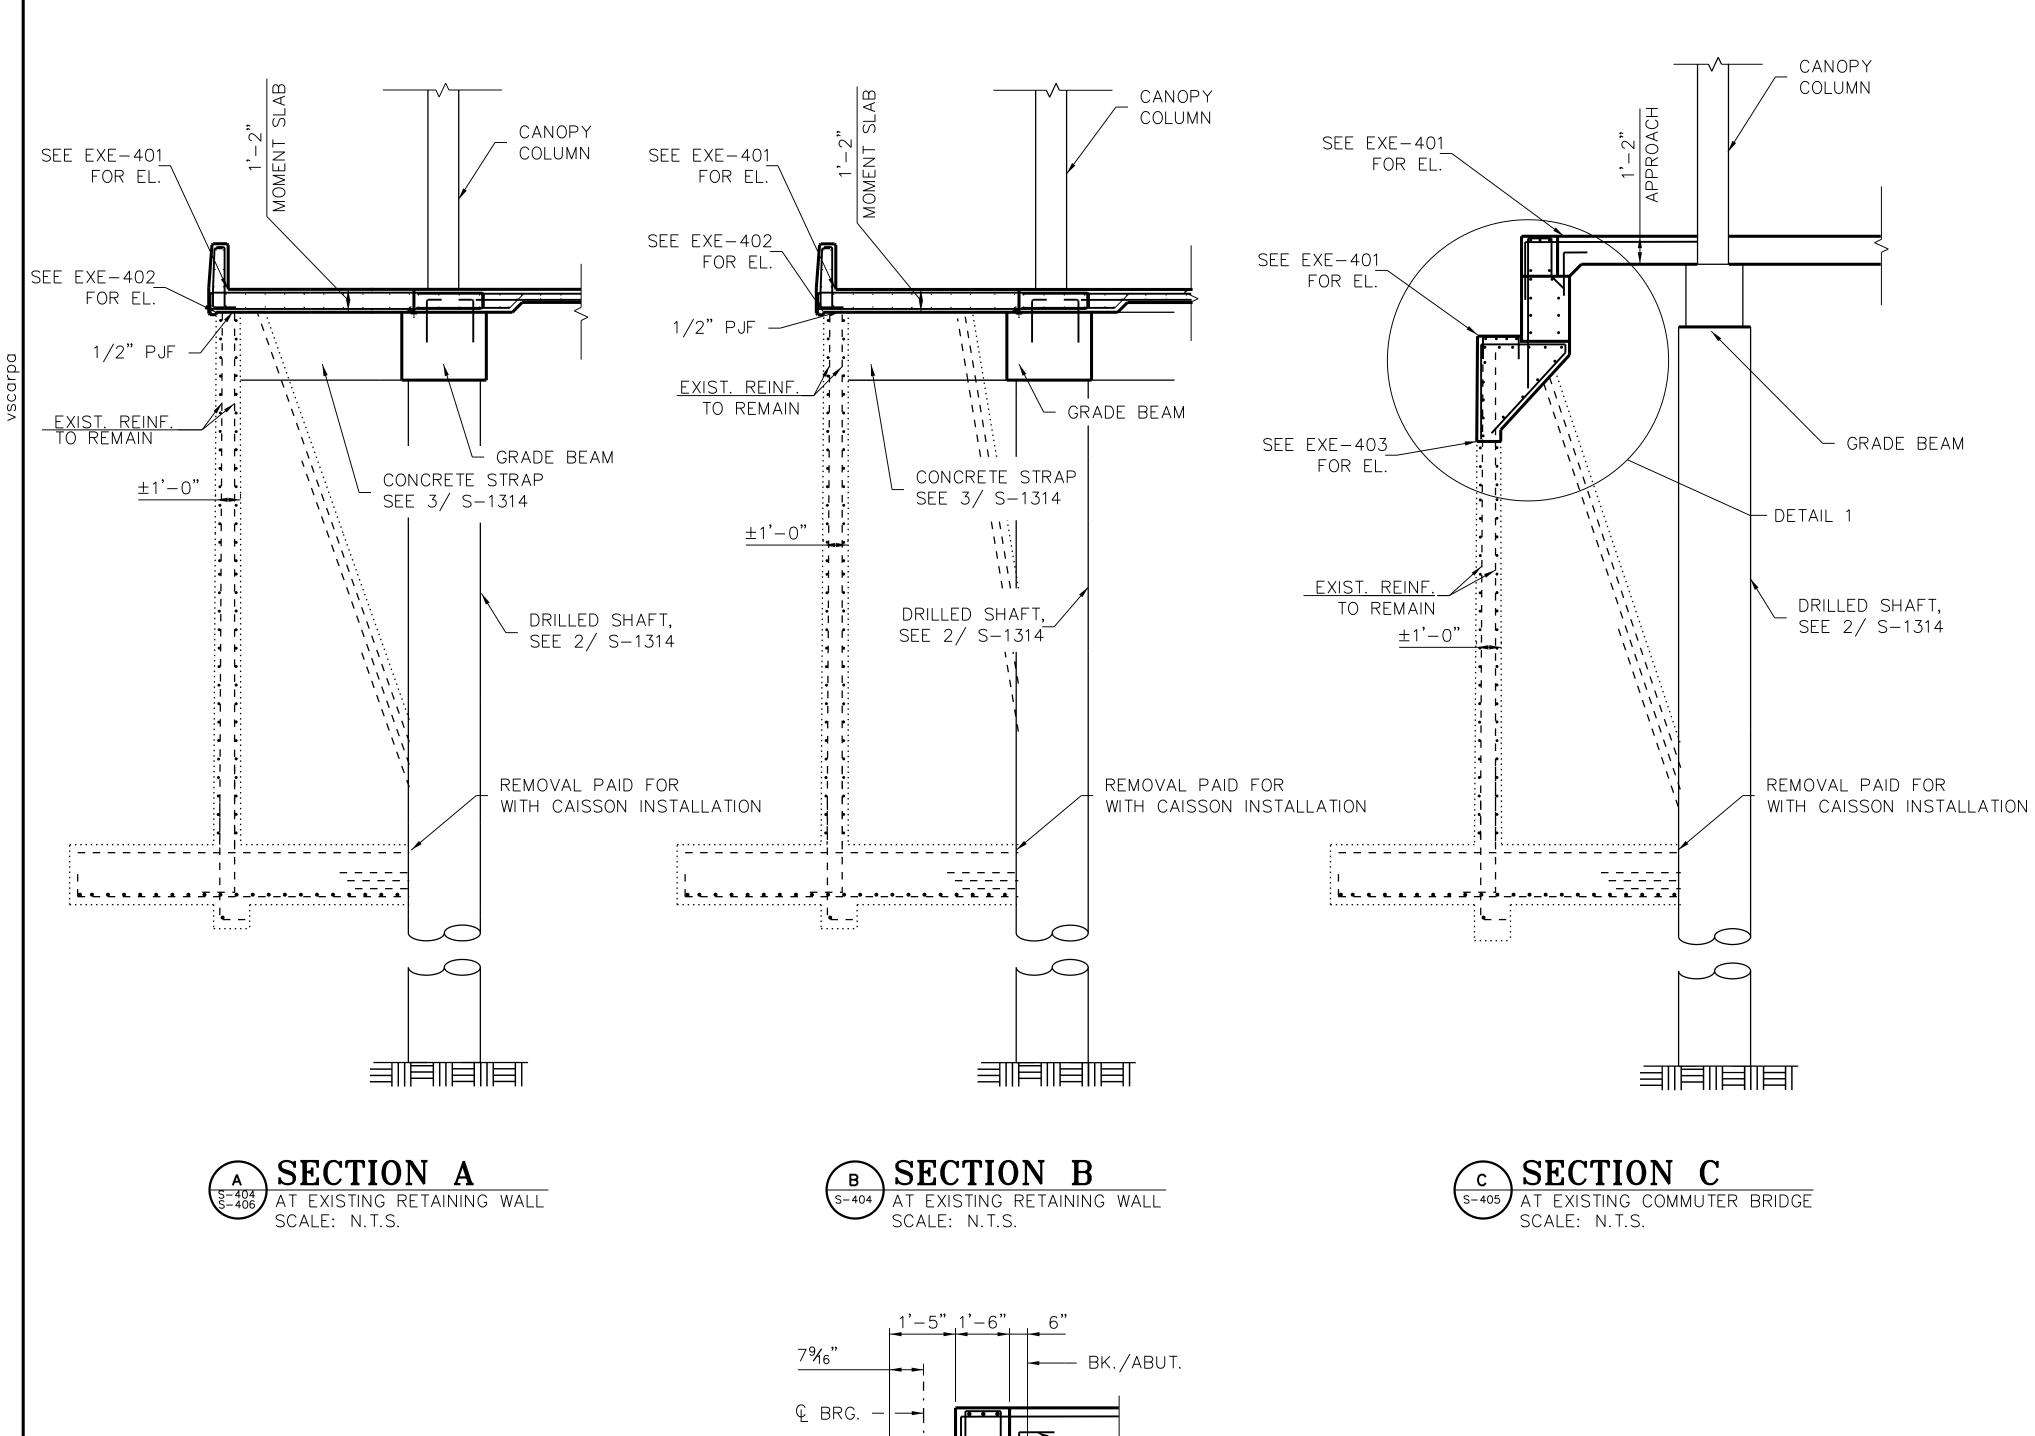



- 1. FOR SIDEWALK, PARAPET AND FENCE, SEE CIVIL, BUILDING AND ARCHITECTURAL PLANS.
- 2. FOR COMMUTER BRIDGE AND RETAINING WALL EXCAVATION AND CELLULAR CONCRETE FILL, SEE SHEETS EXE-S-408 AND EXE-S-409.
- 3. FOR MOMENT SLAB DETAILS, SEE S-1403A.
- 4. COORDINATE CAST IN ANCHORS WITH COMMUTER BRIDGE DRAWINGS.





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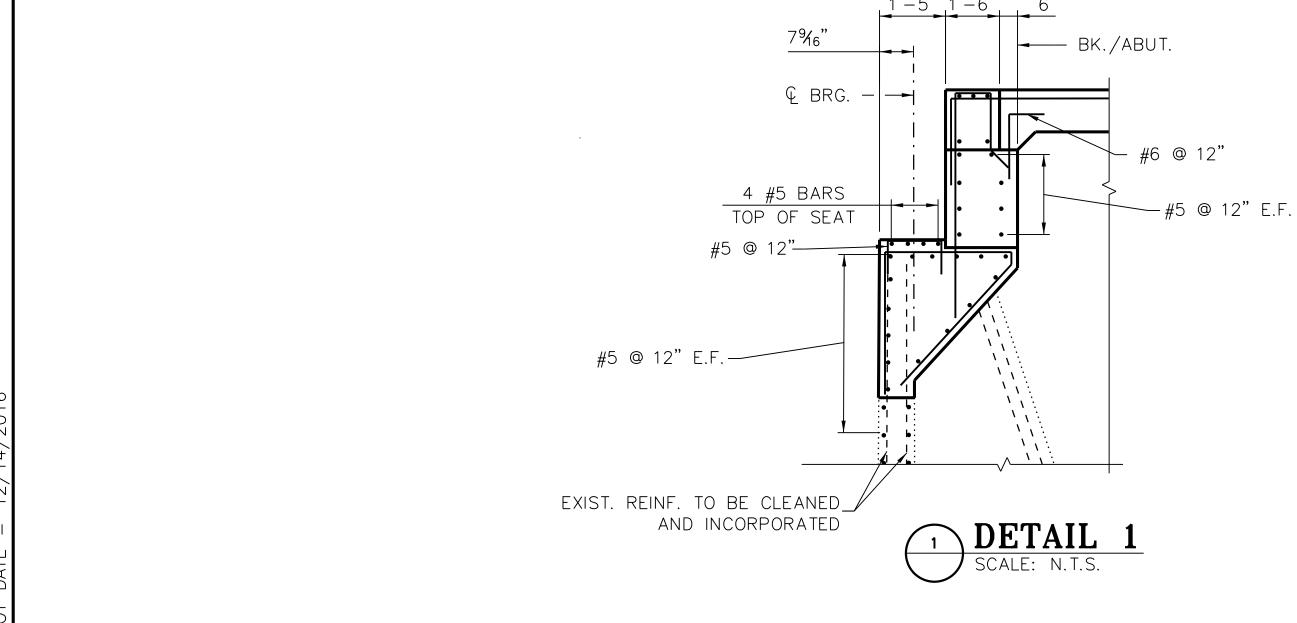
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# 95th Terminal Improvement

15 West 95th Street (South Terminal) Chicago, IL 60628

IN CH	ARGE	S. KADERBEK	
APPROVED BY		D.ZROKA	
CHEC	KED BY	P.MAID	
DESIG	SNED BY	L.SOMMER	
DRAV	VN BY	T.SLEDGE	
PROJ	ECT NO.	2012-0021	
FILE I	NAME	File Name	
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	2/9/17	ISSUED FOR CON	STRUCTION
	DATE	DESCRIPTION	


EXISTING EAST RETAINING WALL SECTIONS & DETAILS





#### CONSTRUCTION SEQUENCE:

- 1. REMOVE EXISTING PAVEMENT (SEE CIVIL PLANS)
- 2.EXCAVATE BEHIND EXISTING RETAINING WALL TO THE LIMITS SHOWN ON THE PLANS.
- 3. REMOVE PORTION OF RETAINING WALL AS SHOWN ON SHEET EXE-S-403.
- 4.RECONSTRUCT BACKWALL AS SHOWN ON SHEETS EXE-S-407
- 5. BACKFILL WITH APPROVED LIGHTWEIGHT CELLULAR CONCRETE IN LIFTS NOT EXCEEDING FOUR (4) FEET.
- 6.CONSTRUCT APPROACH SLAB, CLOSURE POUR AND SIDEWALK.

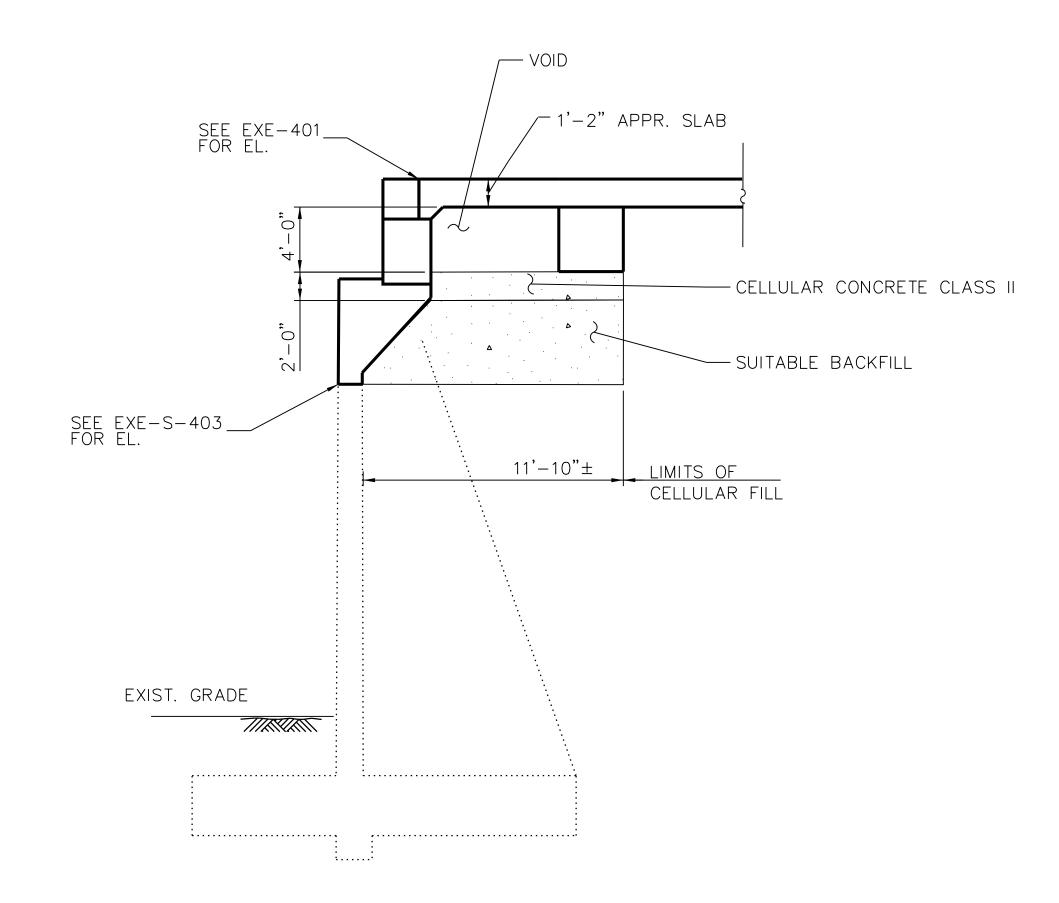

# SECTION C - LIGHTWEIGHT CELLULAR CONCRETE AT PROPOSED COMMUTER BRIDGE SCALE: N.T.S.

LEGEND:

STRUCTURE EXCAVATION

CELLULAR CONCRETE

FFP SIN \*\*



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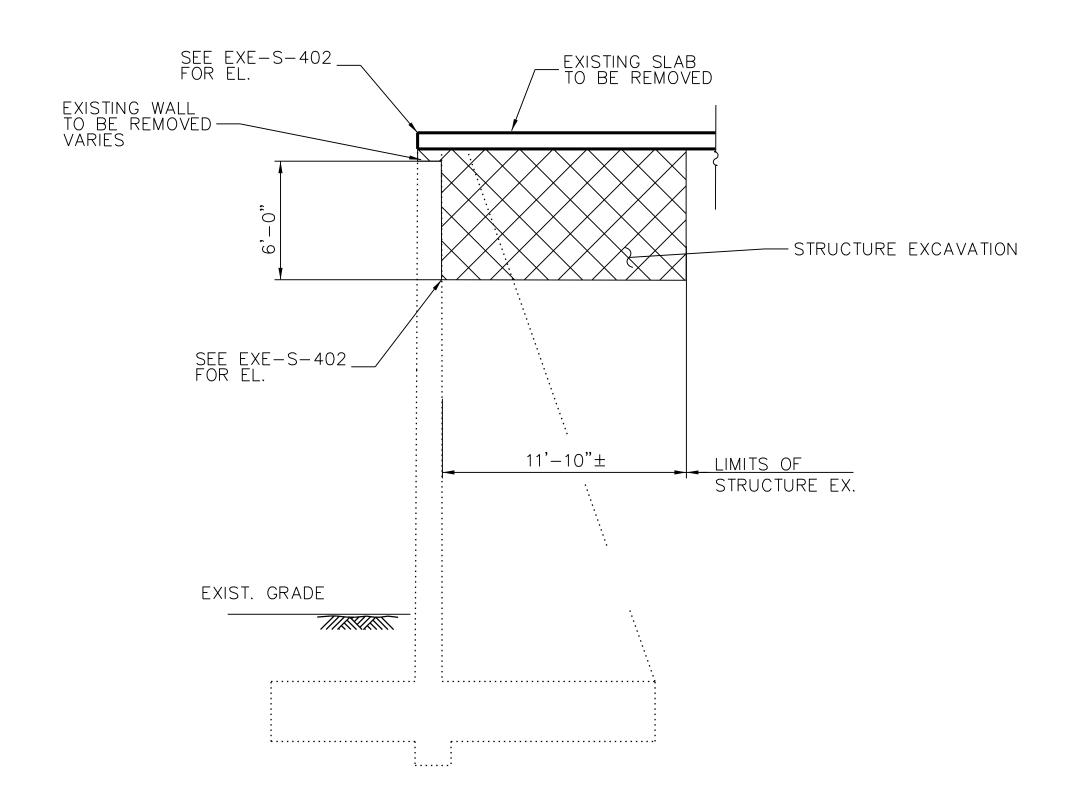
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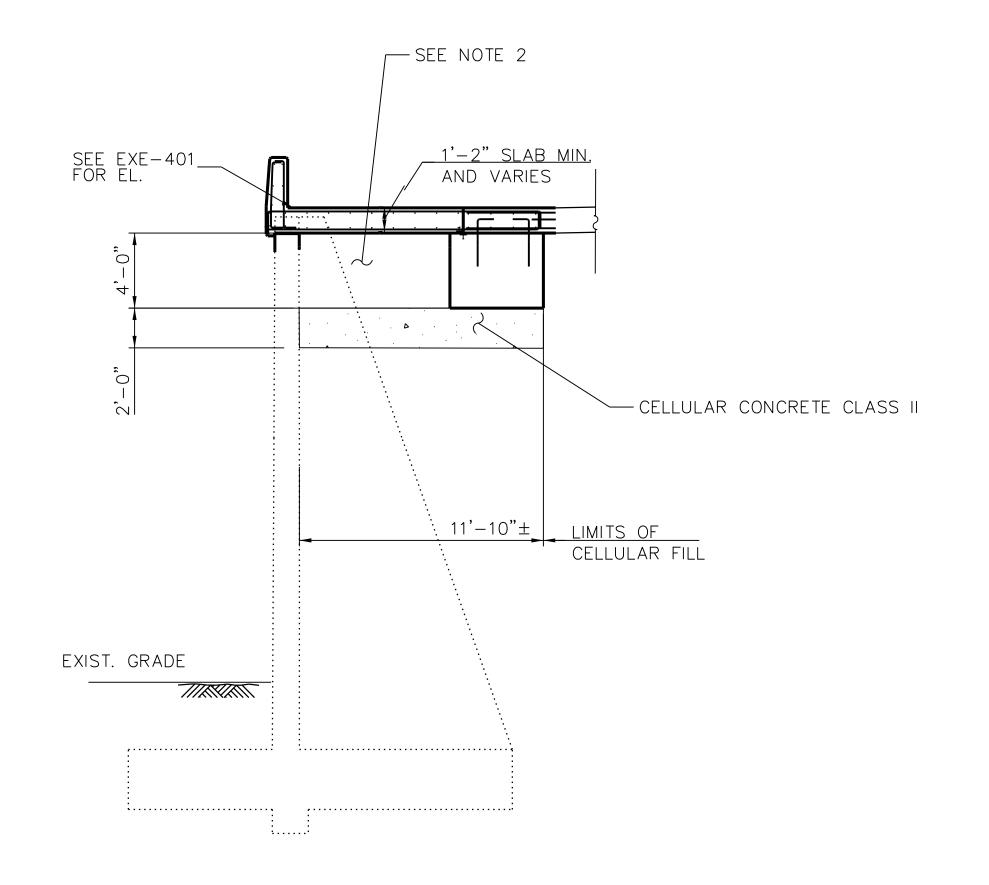
# 95th Terminal Improvement

15 West 95th Street (South Terminal) Chicago, IL 60628

IN CH	ARGE	S. KADERBE	K
APPROVED BY		D.ZROKA	
CHEC	KED BY	P.MAID	
DESIC	SNED BY	L.SOMMER	
DRAWN BY		T.SLEDGE	
PROJECT NO.		2012-0021	
FILE I	NAME	File Name	
	2/9/17	ISSUED FOR CO	ONSTRUCTION
MARK	DATE	DESCRIPTION	I
LOC	LOCATION IDENTIFIER: DR095		

COMMUTER BRIDGE EXCAVATION & CELLULAR CONCRETE





# SECTION A - EXCAVATION AT EXISTING RETAINING WALL SCALE: N.T.S.

SECTION A - LIGHTWEIGHT CELLULAR CONCRETE

AT EXISTING RETAINING WALL
SCALE: N.T.S.

#### CONSTRUCTION SEQUENCE:

- 1. REMOVE EXISTING PAVEMENT (SEE CIVIL PLANS)
- 2.EXCAVATE BEHIND EXISTING RETAINING WALL TO THE LIMITS SHOWN ON THE PLANS.
- 3. REMOVE PORTION OF RETAINING WALL AS SHOWN ON SHEET EXE-S-403.
- 4.RECONSTRUCT BACKWALL AS SHOWN ON SHEETS EXE-S-407
- 5. BACKFILL WITH APPROVED CELLULAR FILL IN LIFTS NOT EXCEEDING THREE (3) FEET.
- 6.CONSTRUCT MOMENT SLABS.

#### NOTES:

 NO FILL EXCEPT WHERE NEEDED TO MATCH 95TH STREET BRIDGE ABUTMENT GRADE.

#### LEGEND:

STRUCTURE EXCAVATION

. CELLULAR FILL

FFP SNN \*\*



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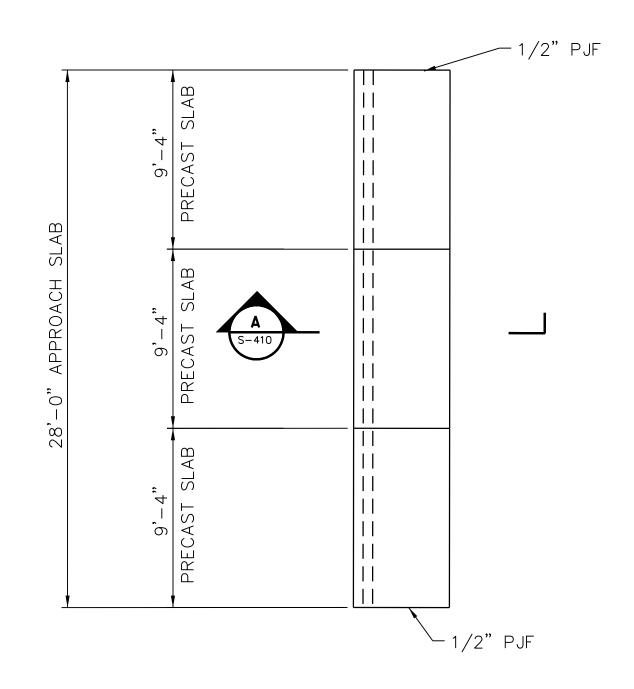
#### 95th Terminal Improvement

15 West 95th Street (South Terminal) Chicago, IL 60628


IN CHARGE		S. KADERBEK
APPROVED BY		D.ZROKA
CHECKED BY		P.MAID
DESIGNED BY		L.SOMMER
DRAWN BY		T.SLEDGE
PROJECT NO.		2012-0021
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LOCATION IDENTIFIER: DR095


EXISTING RETAINING WALL EXCAVATION AND CELLULAR CONCRETE






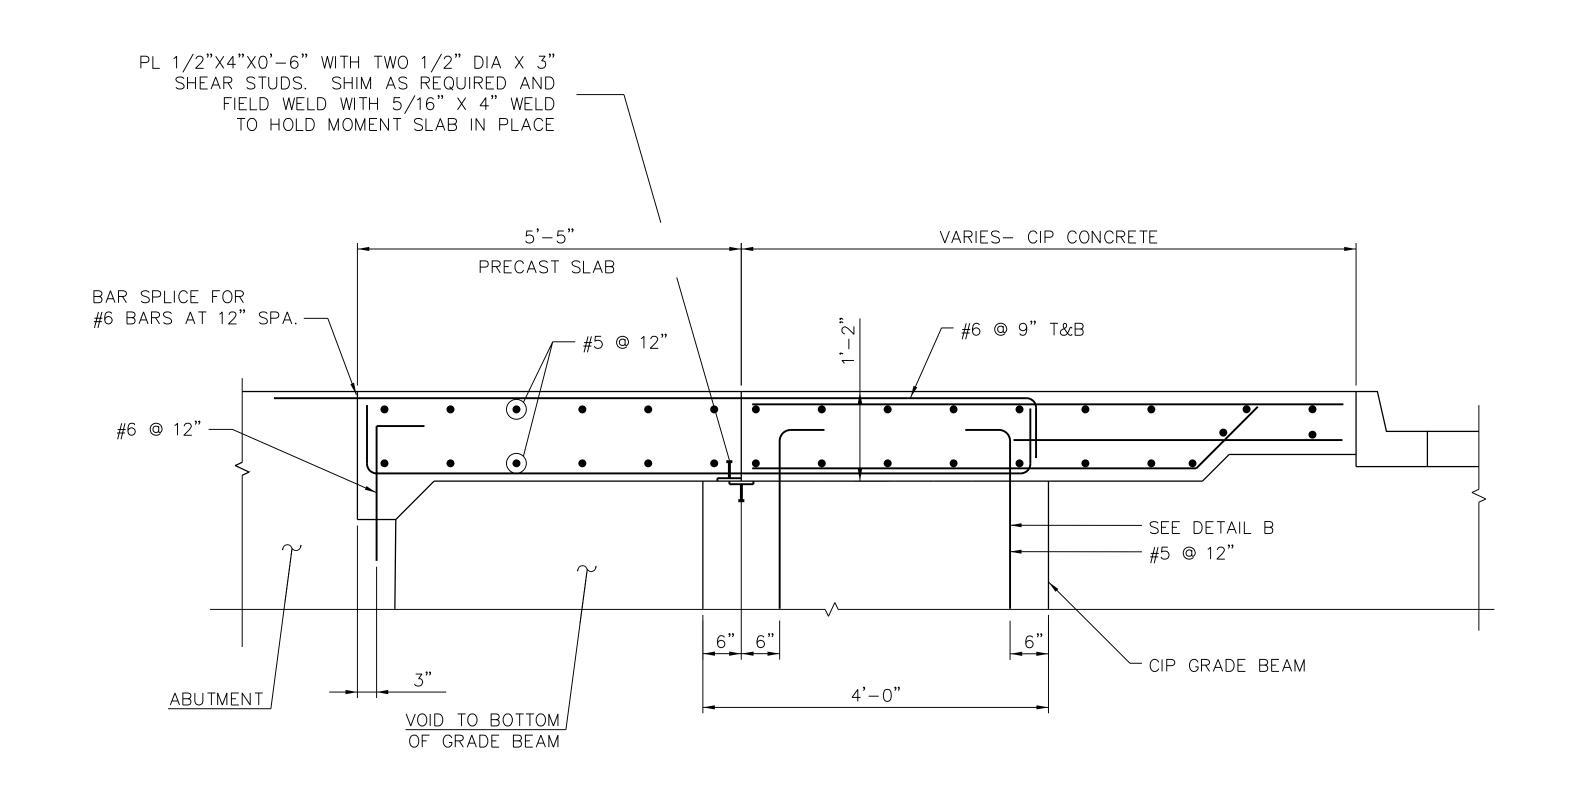

# APPROACH SLAB SECTION SCALE: N.T.S.

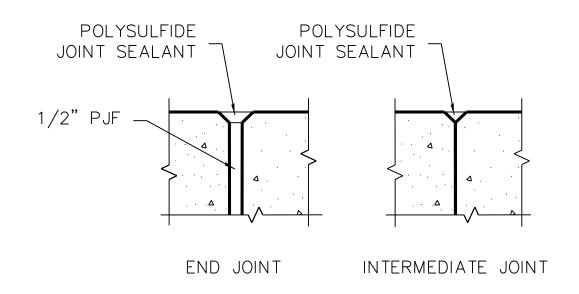



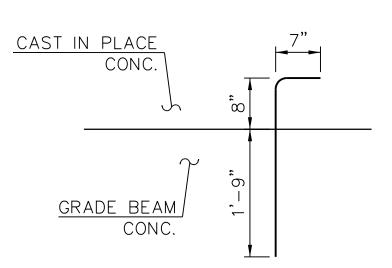

B DETAIL B
SCALE: N.T.S.





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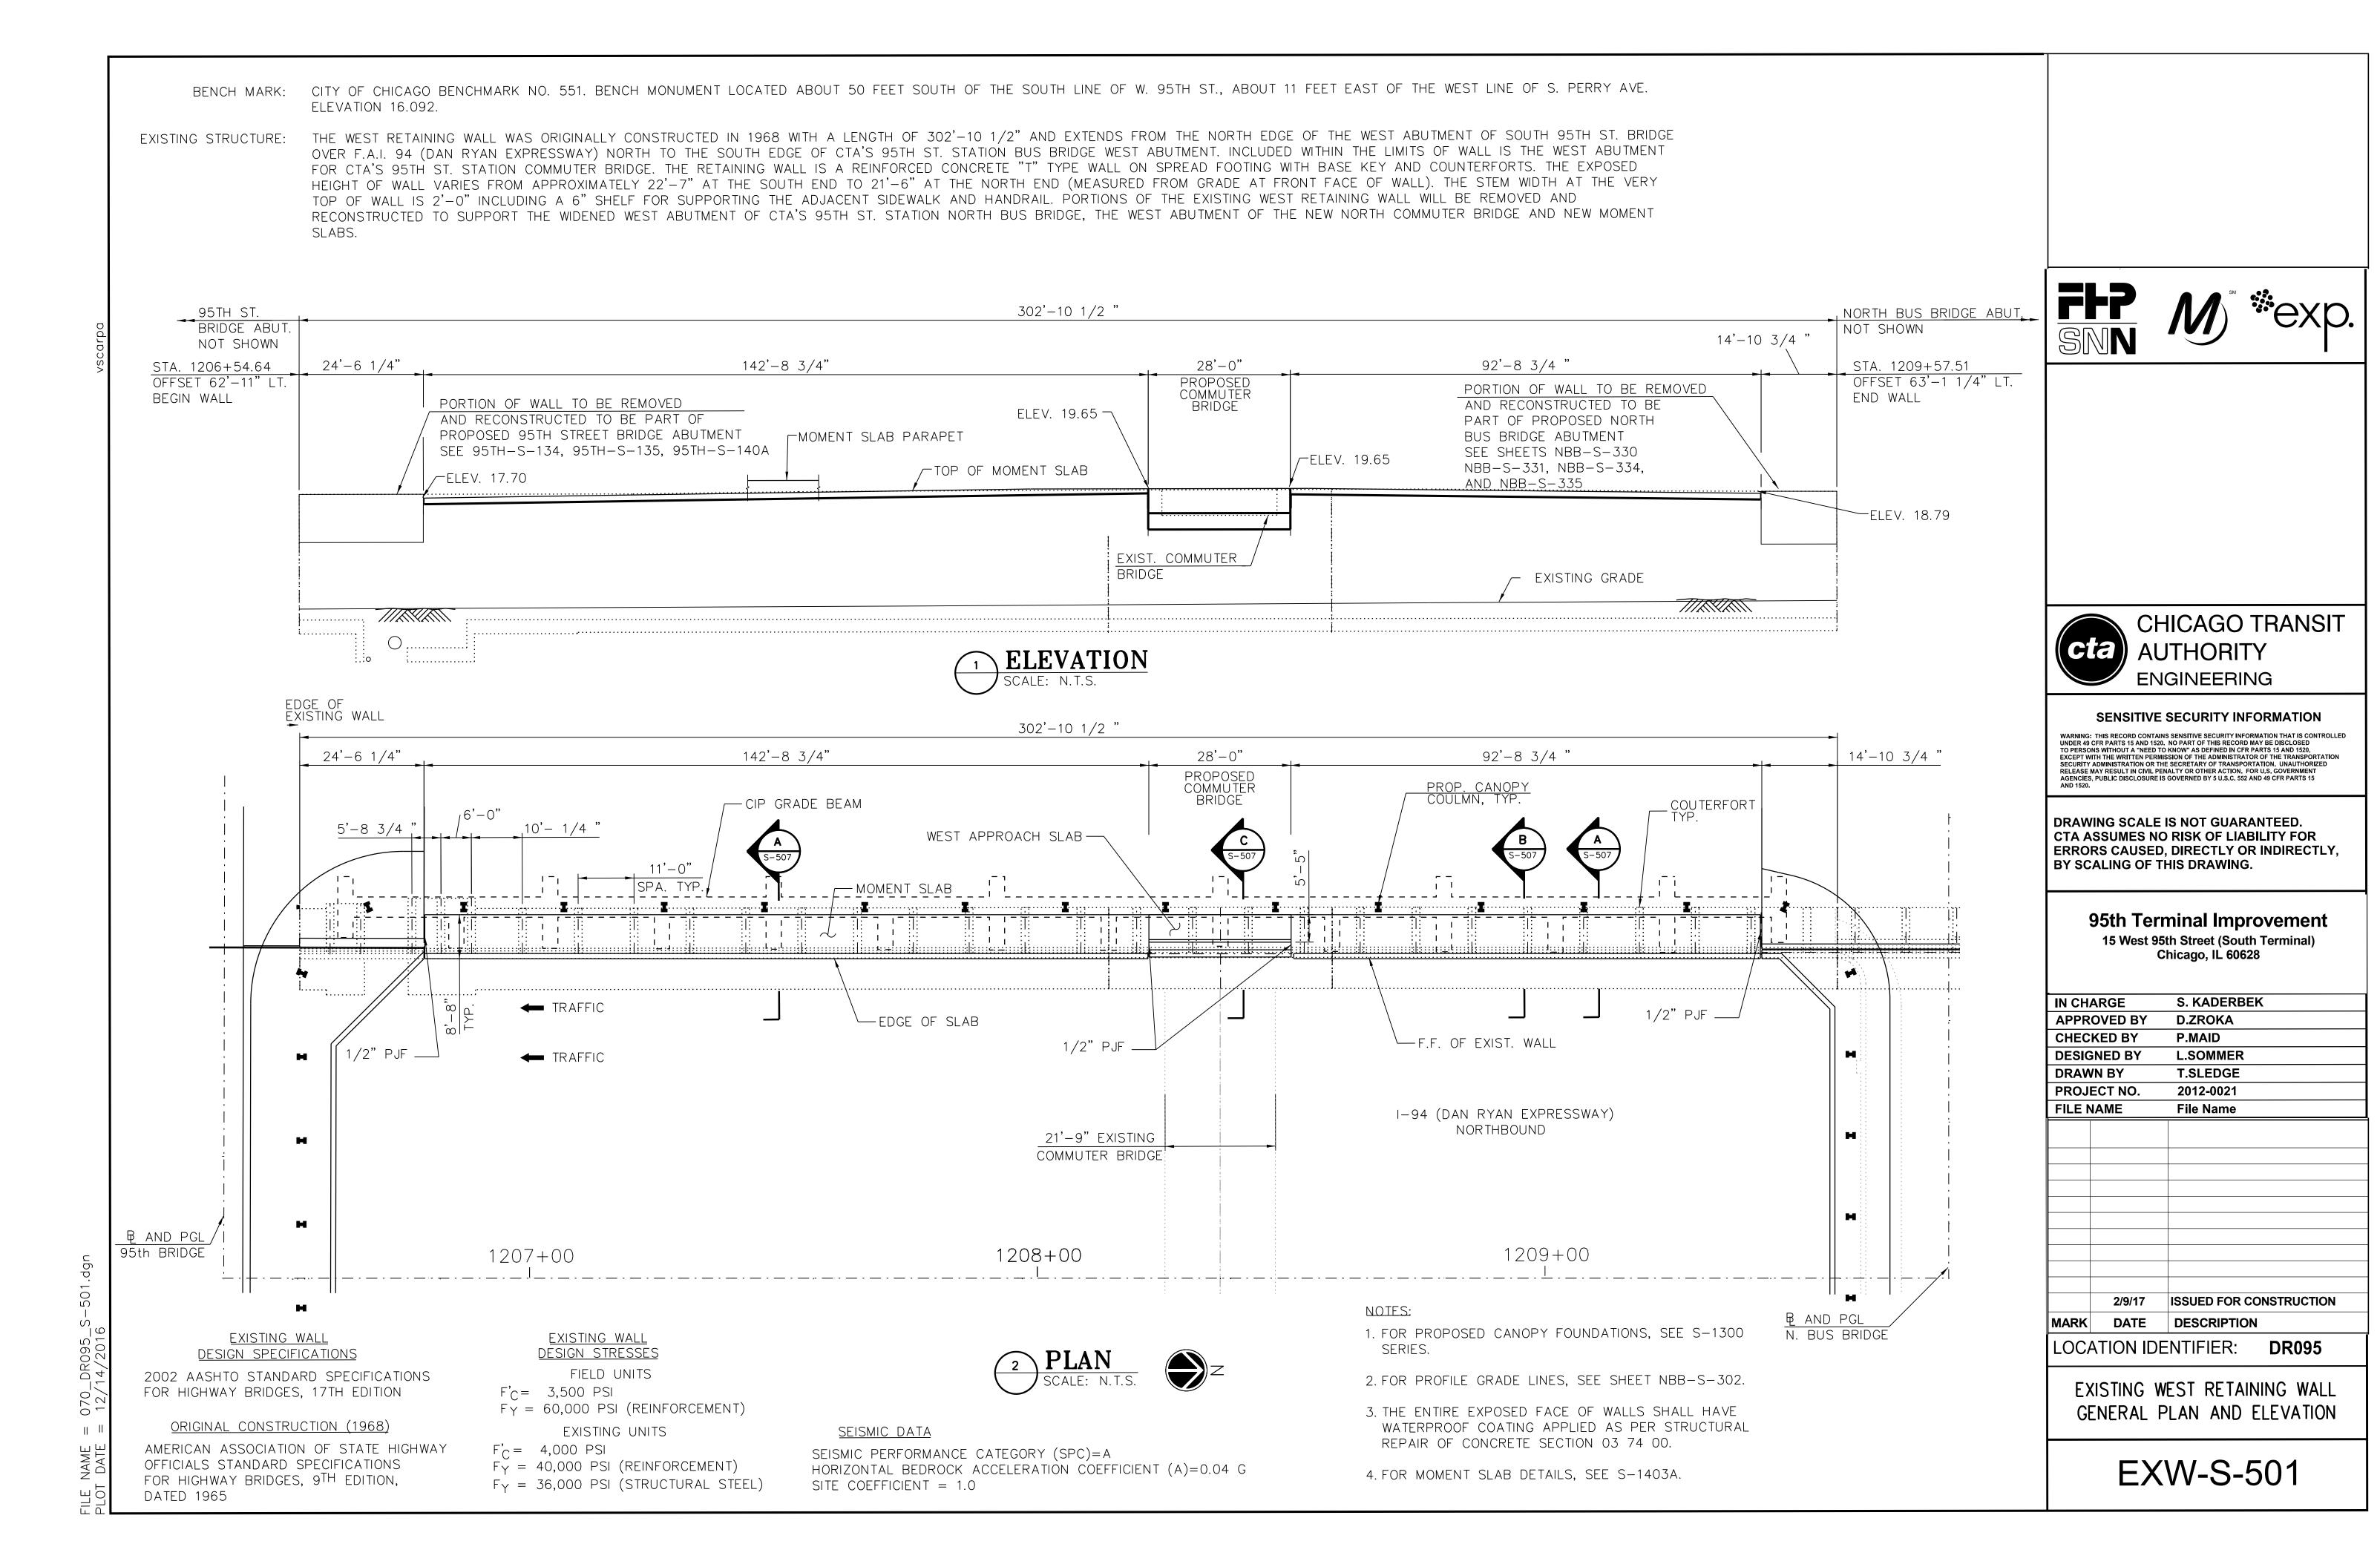
# 95th Terminal Improvement


15 West 95th Street (South Terminal) Chicago, IL 60628

IN CHARGE		S. KADERBEK
APPROVED BY		D.ZROKA
CHEC	KED BY	P.MAID
DESIG	NED BY	L.SOMMER
DRAW	/N BY	T.SLEDGE
PROJECT NO.		2012-0021
FILE N	IAME	File Name
	2/9/17	ISSUED FOR CONSTRUCTION
MARK	DATE	DESCRIPTION
		FNTIFIFR DR095

| LOCATION IDENTIFIER: DRU95

COMMUTER BRIDGE EAST APPROACH SLAB



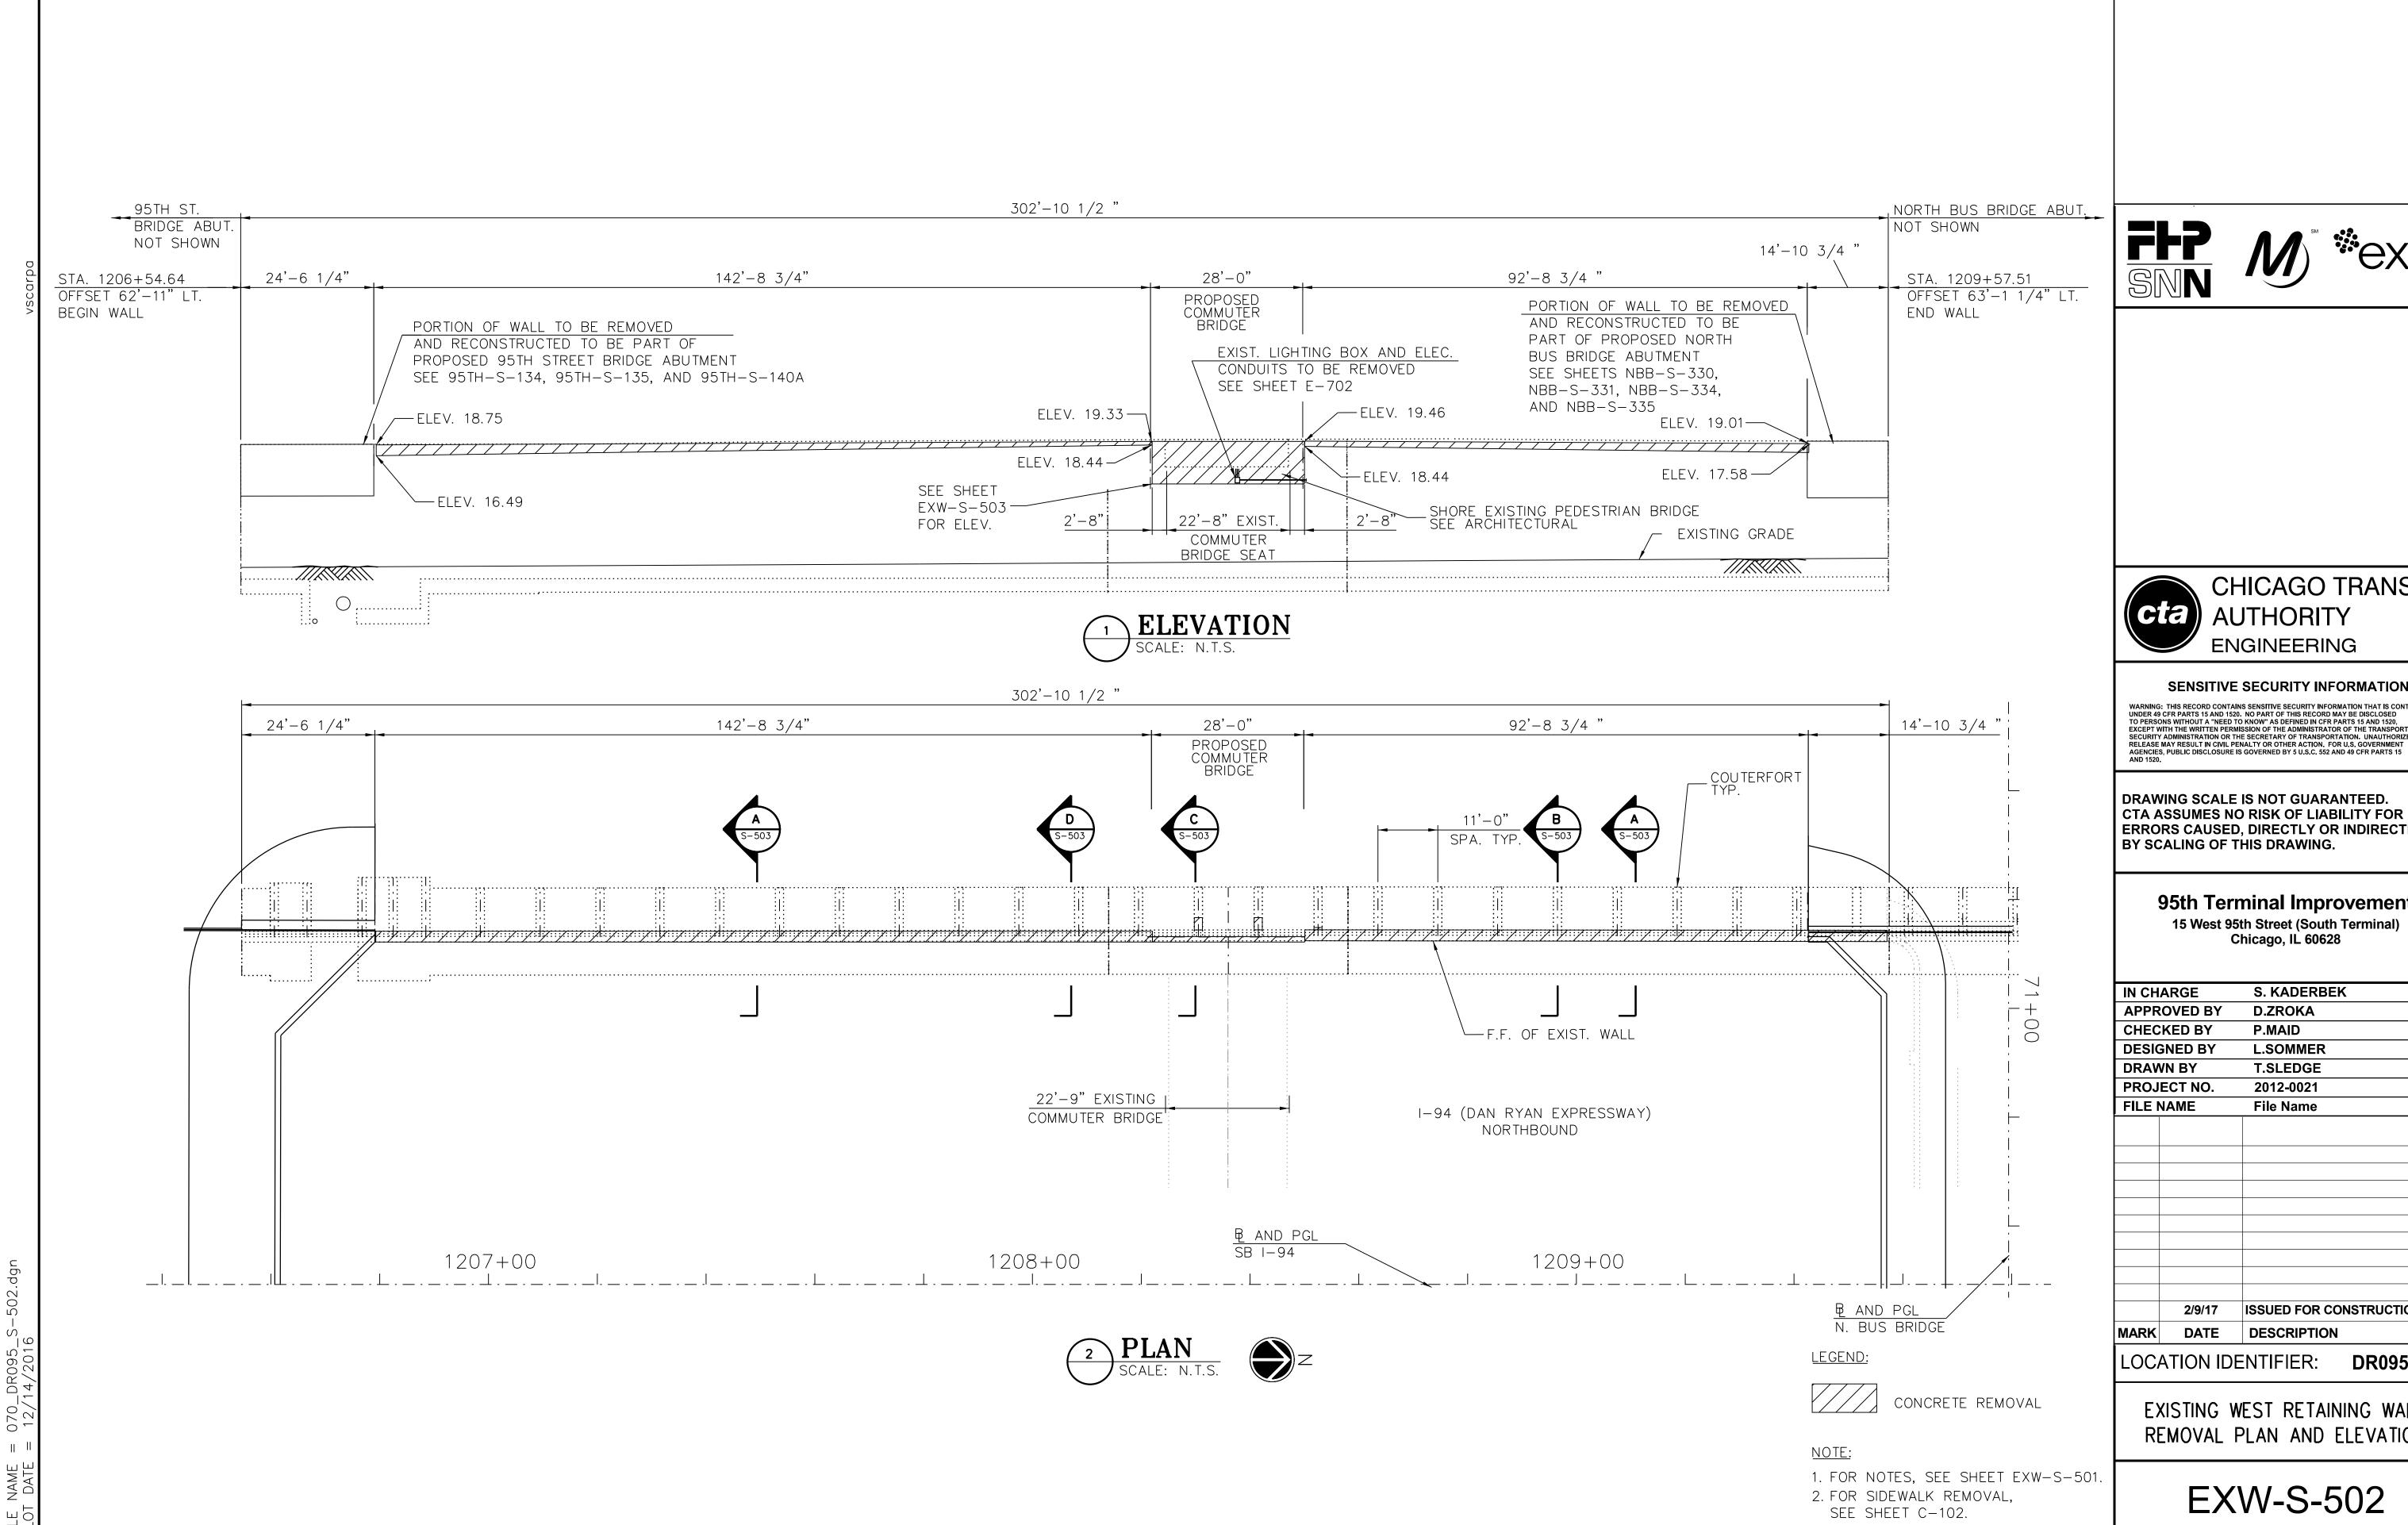



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## 95th Terminal Improvement


S. KADERBEK L.SOMMER **T.SLEDGE** 2012-0021

2/9/17 ISSUED FOR CONSTRUCTION

**DR095** 

EXISTING WEST RETAINING WALL REMOVAL PLAN AND ELEVATION

EXW-S-502

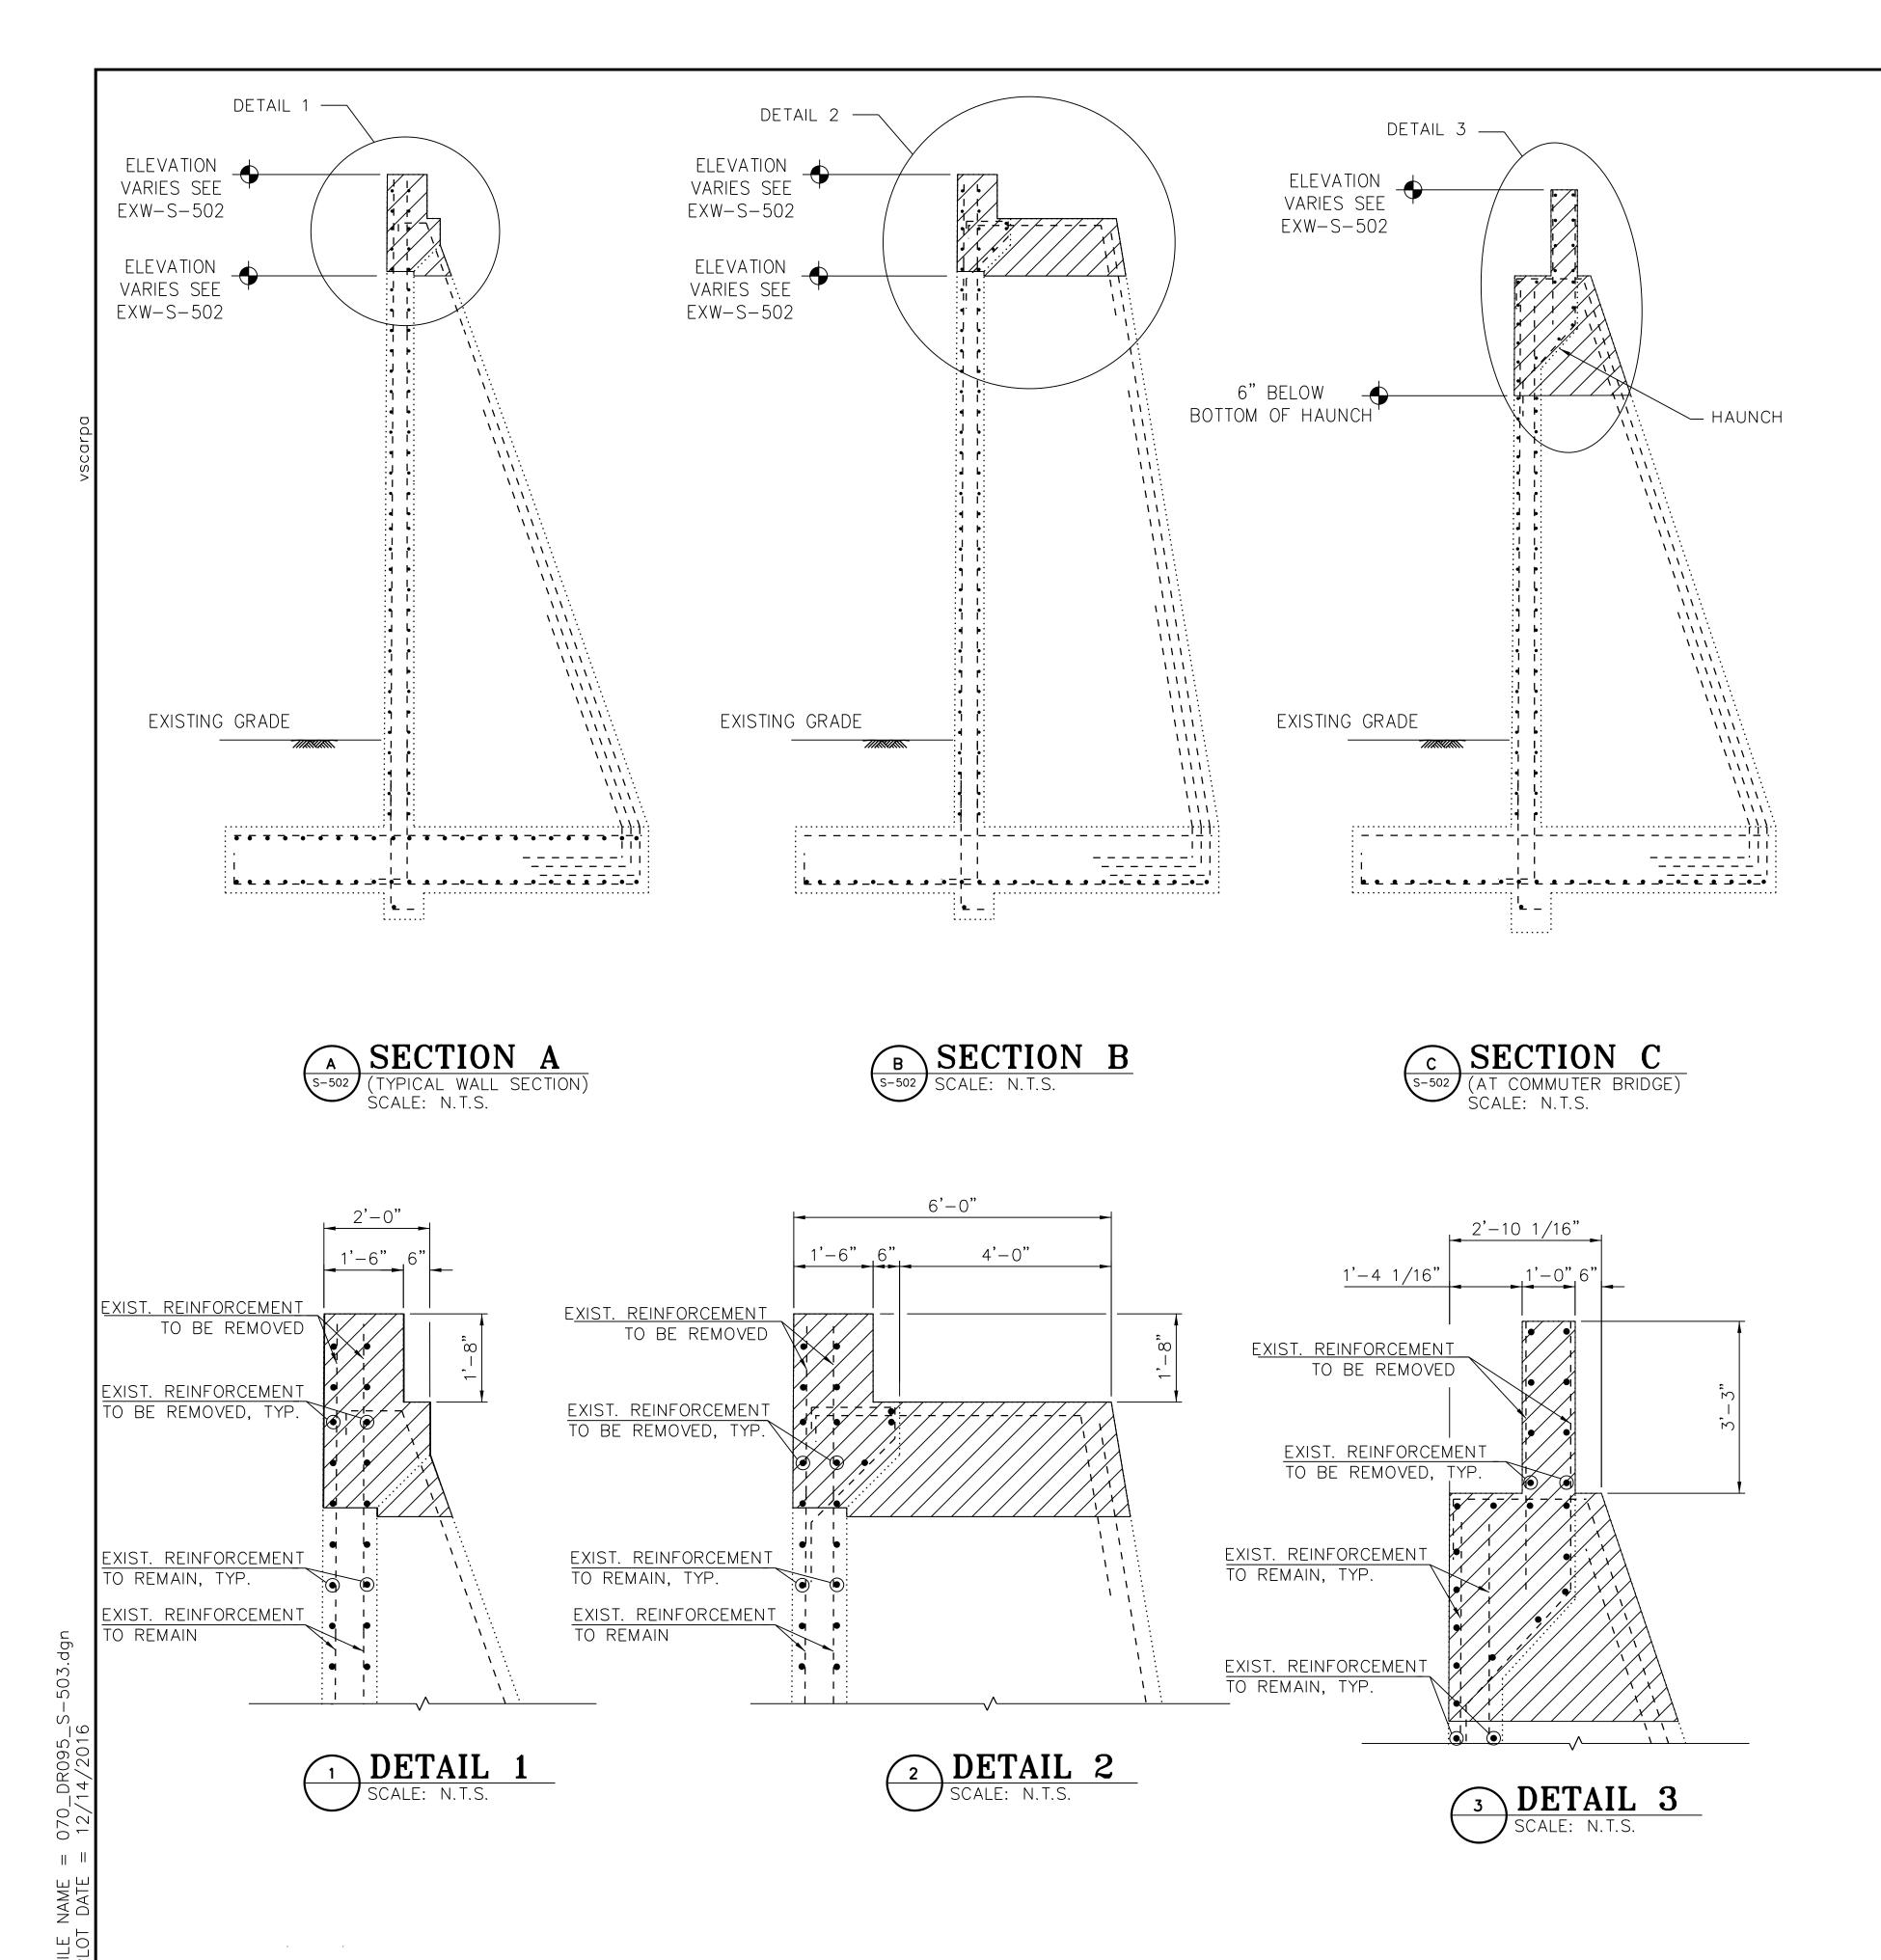





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1. EXISTING REINFORCEMENT EXTENDED INTO NEW CONCRETE SHALL BE

ANY REINFORCEMENT BARS THAT ARE DAMAGED DURING CONCRETE REMOVAL OPERATIONS SHALL BE REPAIRED OR REPLACED USING AN

SLABS. DAMAGED CONCRETE TO BE REPAIRED WITH NON-SHRINK

LEGEND:

CONCRETE REMOVAL

CLEANED, STRAIGHTENED, AND INCORPORATED INTO THE NEW

3. SAWCUT WALL TO PROVIDE CLEAN BEARING SURFACE FOR MOMENT

APPROVED BAR SPLICER OR ANCHORAGE SYSTEM.

GROUT AT NO ADDITIONAL COST.

CONSTRUCTION.

# 95th Terminal Improvement 15 West 95th Street (South Terminal) Chicago, IL 60628

IN CHARGE S. KADERBEK

APPROVED BY D.ZROKA

CHECKED BY P.MAID

DESIGNED BY L.SOMMER

DRAWN BY T.SLEDGE

PROJECT NO. 2012-0021

FILE NAME File Name


2/9/17 ISSUED FOR CONSTRUCTION

MARK DATE DESCRIPTION

LOCATION IDENTIFIER: DR095

EXISTING WEST RETAINING WALL REMOVAL SECTIONS & DETAILS

EXW-S-503

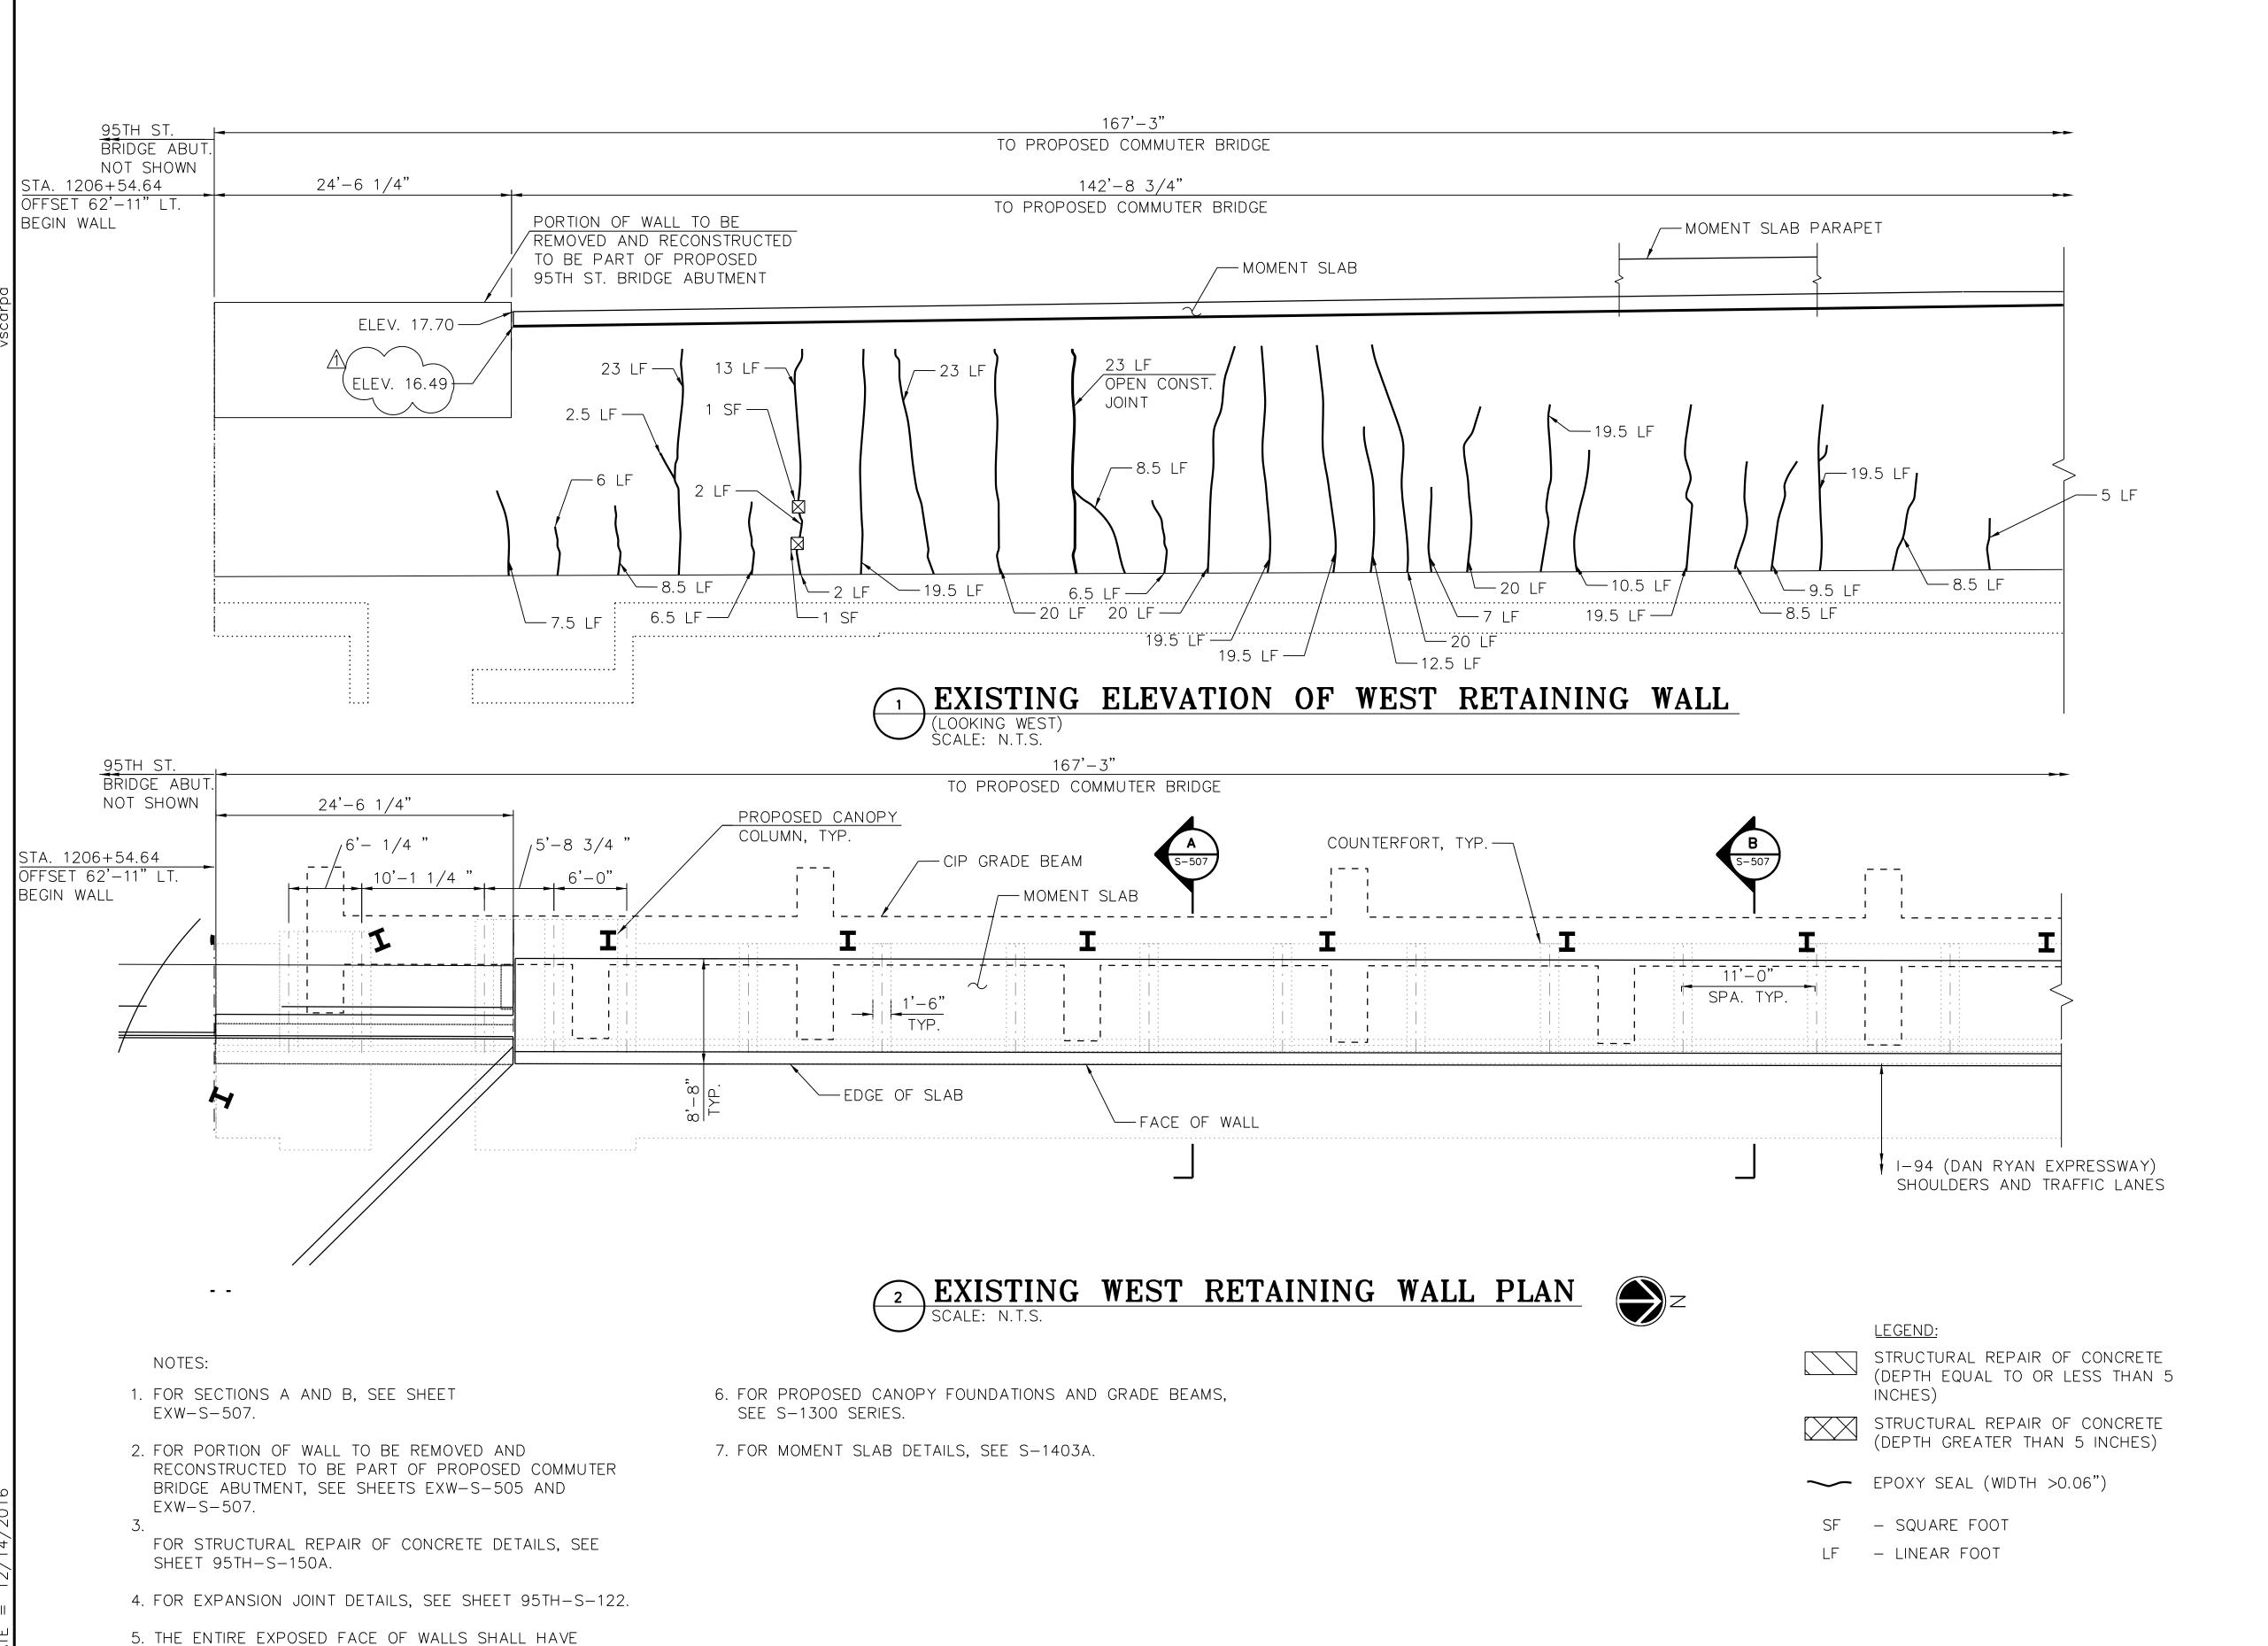

FFP SIN SEXP.



#### SENSITIVE SECURITY INFORMATION

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BY SCALING OF THIS DRAWING.

# 95th Terminal Improvement 15 West 95th Street (South Terminal) Chicago, IL 60628

Chicago, IL 60628

IN CHARGE S. KADERBEK

	ARGE	3. NADERDEN
APPR	OVED BY	D.ZROKA
CHEC	KED BY	P.MAID
DESIG	SNED BY	L.SOMMER
DRAV	VN BY	T.SLEDGE
PROJ	ECT NO.	2012-0021
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	0/0/47	ISSUED FOR CONSTRUCTION
	2/9/17	ISSUED FOR CONSTRUCTION
MARK	DATE	DESCRIPTION
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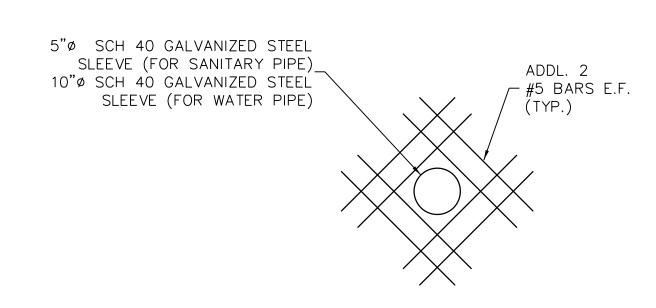
LOCATION IDENTIFIER: DR095

EXISTING WEST RETAINING WALL PLAN & ELEVATION (SHEET 1 OF 3)

EXW-S-504

WATERPROOF COATING APPLIED AS PER STRUCTURAL


REPAIR OF CONCRETE SECTION 03 74 00.



PENETRATION DETAIL

NOTE: GROUT BETWEEN PIPE AND SLEEVE AS REQUIRED.

EXISTING ELEVATION OF WEST RETAINING WALL (LOOKING WEST) SCALE: N.T.S.

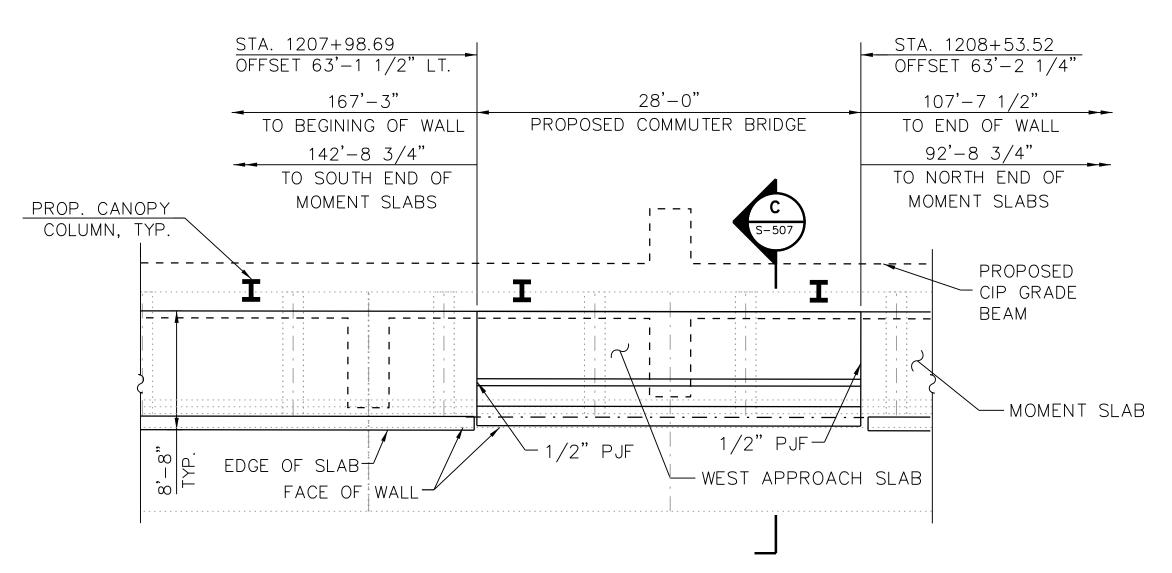

EXISTING WEST RETAINING WALL PLAN
SCALE: N.T.S.



NOTES:

- 1. FOR STRUCTURAL REPAIR OF CONCRETE DETAILS, SEE SHEET 95TH-S-150A.
- 2. THE ENTIRE EXPOSED FACE OF WALLS SHALL HAVE WATERPROOF COATING APPLIED AS PER STRUCTURAL REPAIR OF CONCRETE SECTION 03 74 00.
- 3. SEE SHEET C-200 TO C-203 FOR PENETRATION LOCATIONS.
- 4. FOR PROPOSED CANOPY FOUNDATIONS AND GRADE BEAMS, SEE S-1300 SERIES.
- 5. FOR MOMENT SLAB DETAILS, SEE S-1403A.

LEGEND:



STRUCTURAL REPAIR OF CONCRETE (DEPTH EQUAL TO OR LESS THAN 5 INCHES)



STRUCTURAL REPAIR OF CONCRETE (DEPTH GREATER THAN 5 INCHES)



SF - SQUARE FOOT

LF - LINEAR FOOT







#### **SENSITIVE SECURITY INFORMATION**

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TO PERSONS WITHOUT A "NEED TO KNOW" AS DEFINED IN CFR PARTS 15 AND 1520,

EXCEPT WITH THE WRITTEN PERMISSION OF THE ADMINISTRATOR OF THE TRANSPORTATION EALER I WITH THE WRITTEN PERMISSION OF THE ADMINISTRATOR OF THE TRANSPOR SECURITY ADMINISTRATION OR THE SECRETARY OF TRANSPORTATION. UNAUTHORIX RELEASE MAY RESULT IN CIVIL PENALTY OR OTHER ACTION. FOR U.S. GOVERNMENT AGENCIES, PUBLIC DISCLOSURE IS GOVERNED BY 5 U.S.C. 552 AND 49 CFR PARTS 15 AND 1520.

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### 95th Terminal Improvement 15 West 95th Street (South Terminal) Chicago, IL 60628


IN CHARGE	S. KADERBEK
APPROVED BY	D.ZROKA
CHECKED BY	P.MAID
DESIGNED BY	L.SOMMER
DRAWN BY	T.SLEDGE
PROJECT NO.	2012-0021
FILE NAME	File Name

2/9/17 ISSUED FOR CONSTRUCTION DATE DESCRIPTION MARK

LOCATION IDENTIFIER: **DR095** 

EXISTING WEST RETAINING WALL PLAN & ELEVATION (SHEET 2 OF 3)

EXW-S-505

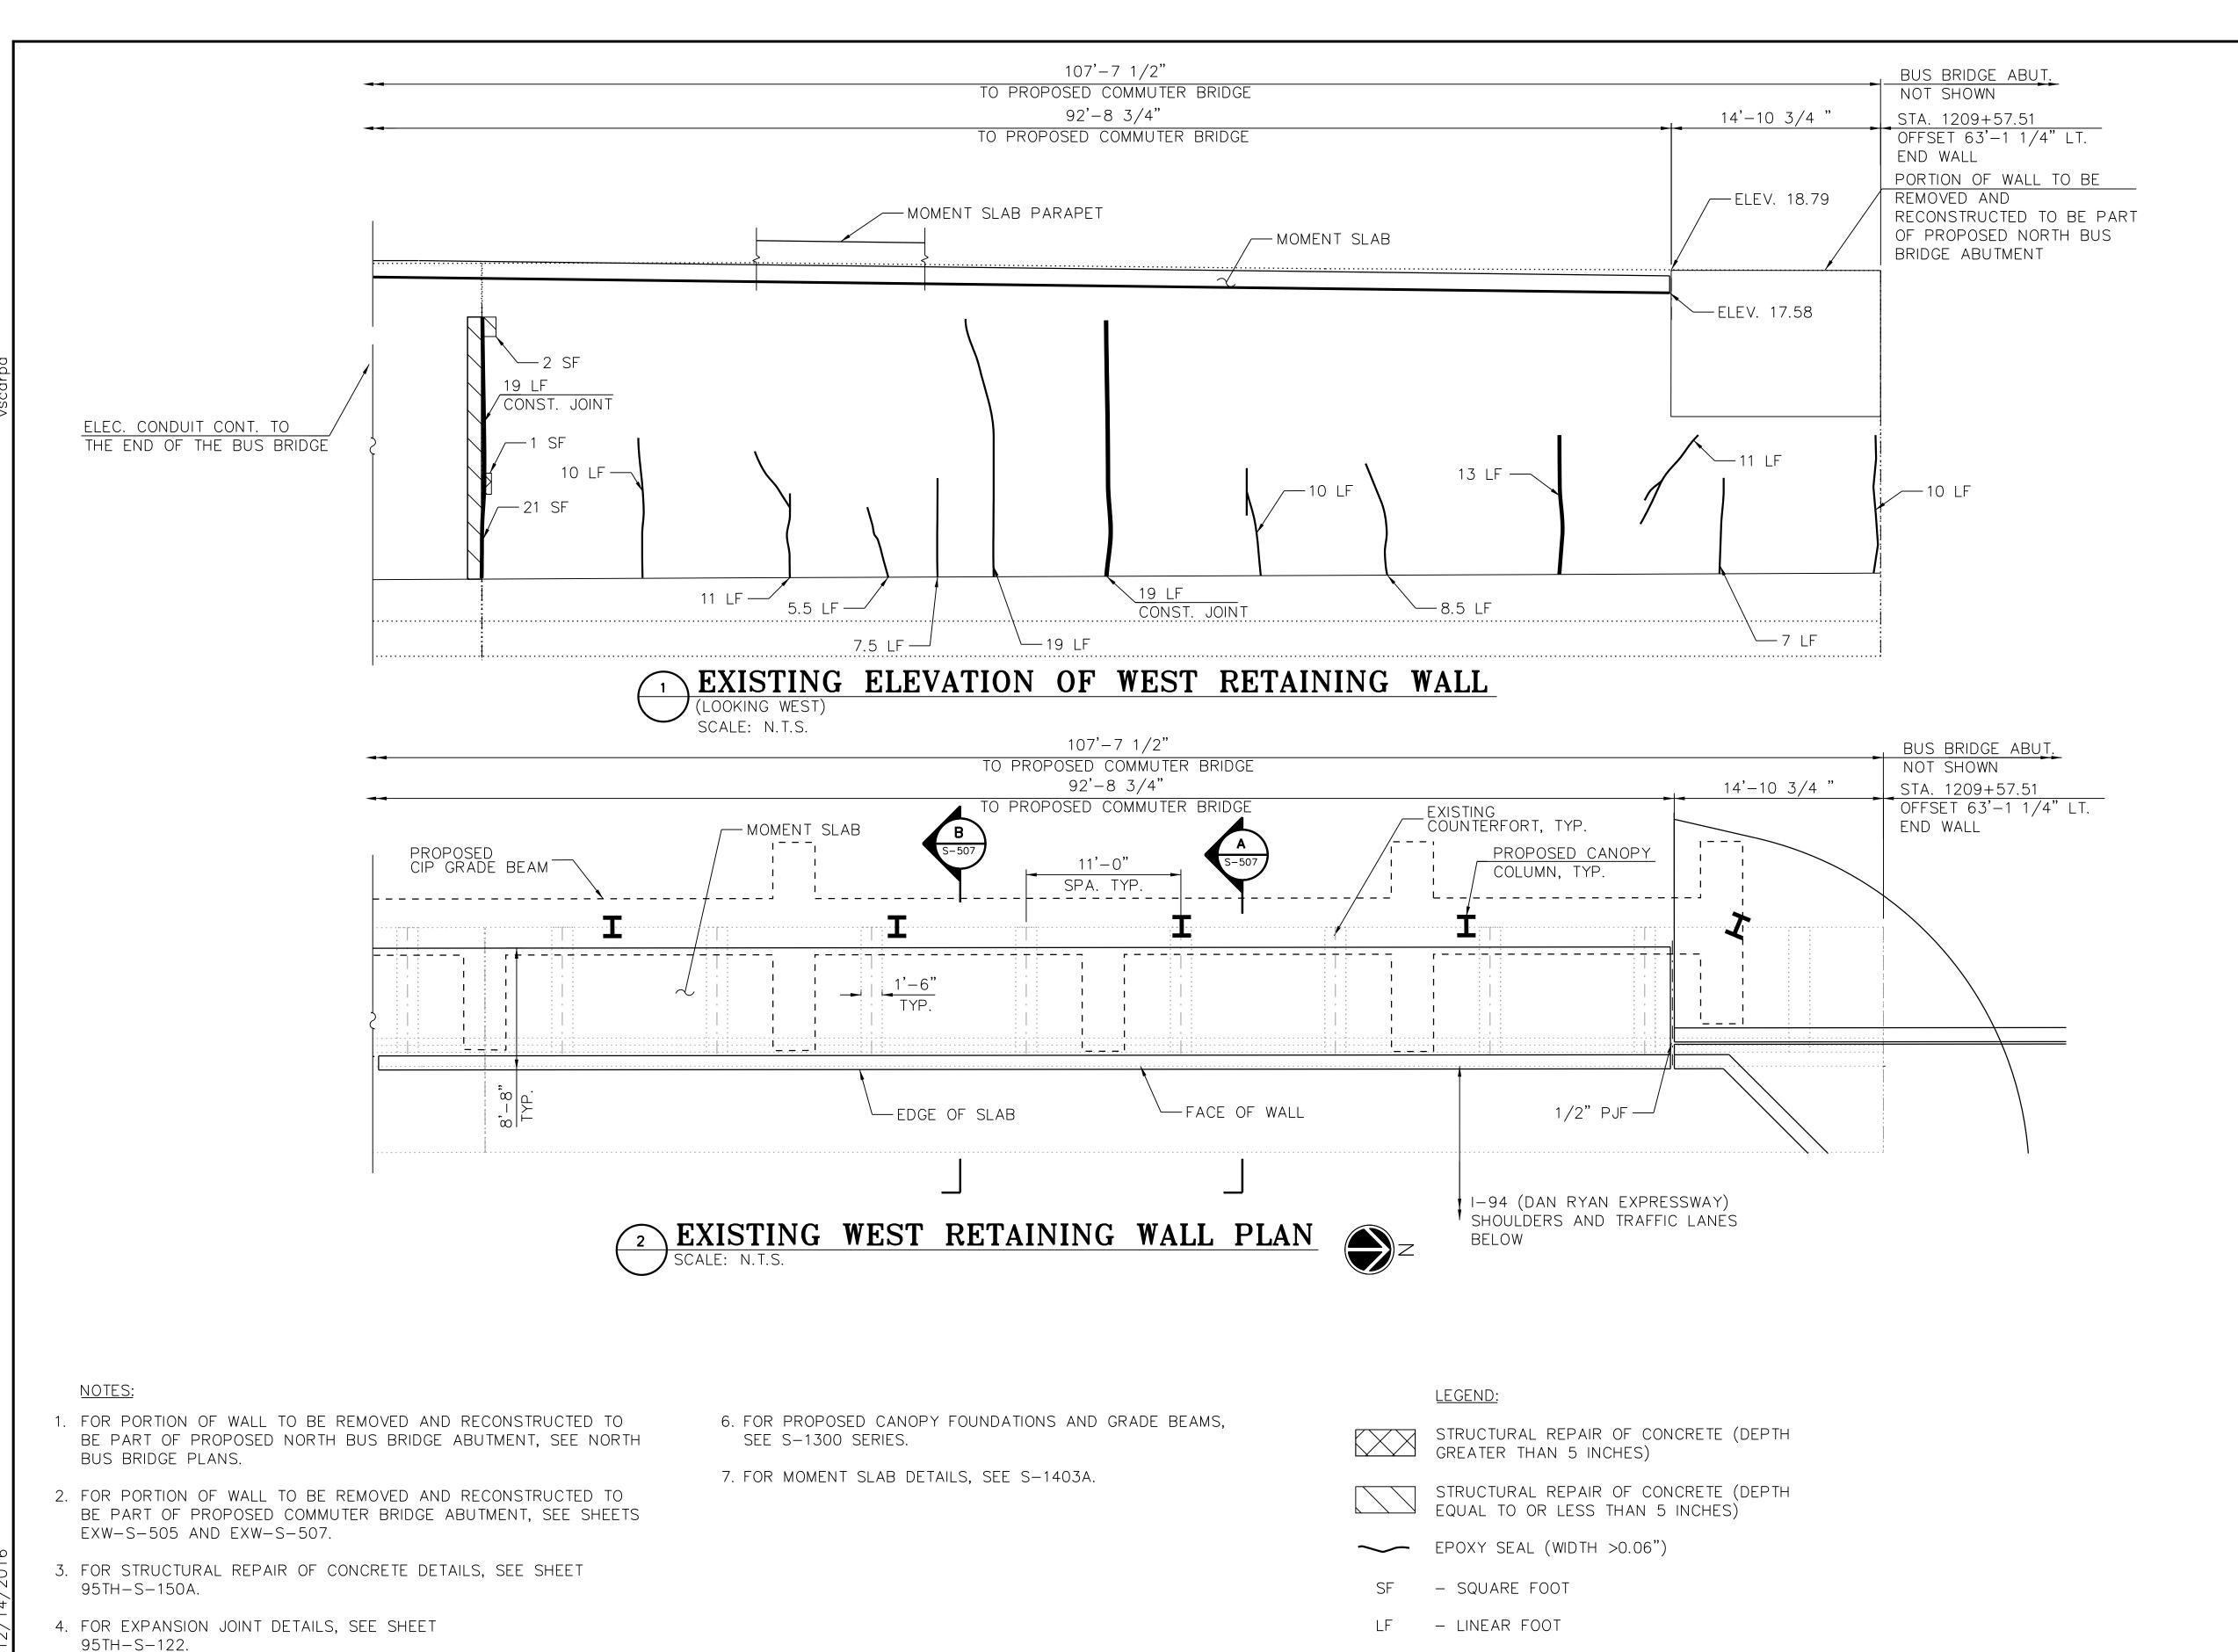

FFP M \*exp



#### SENSITIVE SECURITY INFORMATION

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# 95th Terminal Improvement 15 West 95th Street (South Terminal) Chicago, IL 60628

IN CH	ARGE	S. KADERBEK
APPR	OVED BY	D.ZROKA
CHEC	KED BY	P.MAID
DESIG	NED BY	L.SOMMER
DRAW	/N BY	T.SLEDGE
PROJ	ECT NO.	2012-0021
FILE N	NAME	File Name
	2/9/17	ISSUED FOR CONSTRUCTION
MARK	DATE	DESCRIPTION


LOCATION IDENTIFIER: **DR095** 

EXISTING WEST RETAINING WALL PLAN & ELEVATION (SHEET 3 OF 3)

EXW-S-506

5. THE ENTIRE EXPOSED FACE OF WALLS SHALL HAVE WATERPROOF COATING APPLIED AS PER STRUCTURAL REPAIR OF CONCRETE

SECTION 03 74 00.

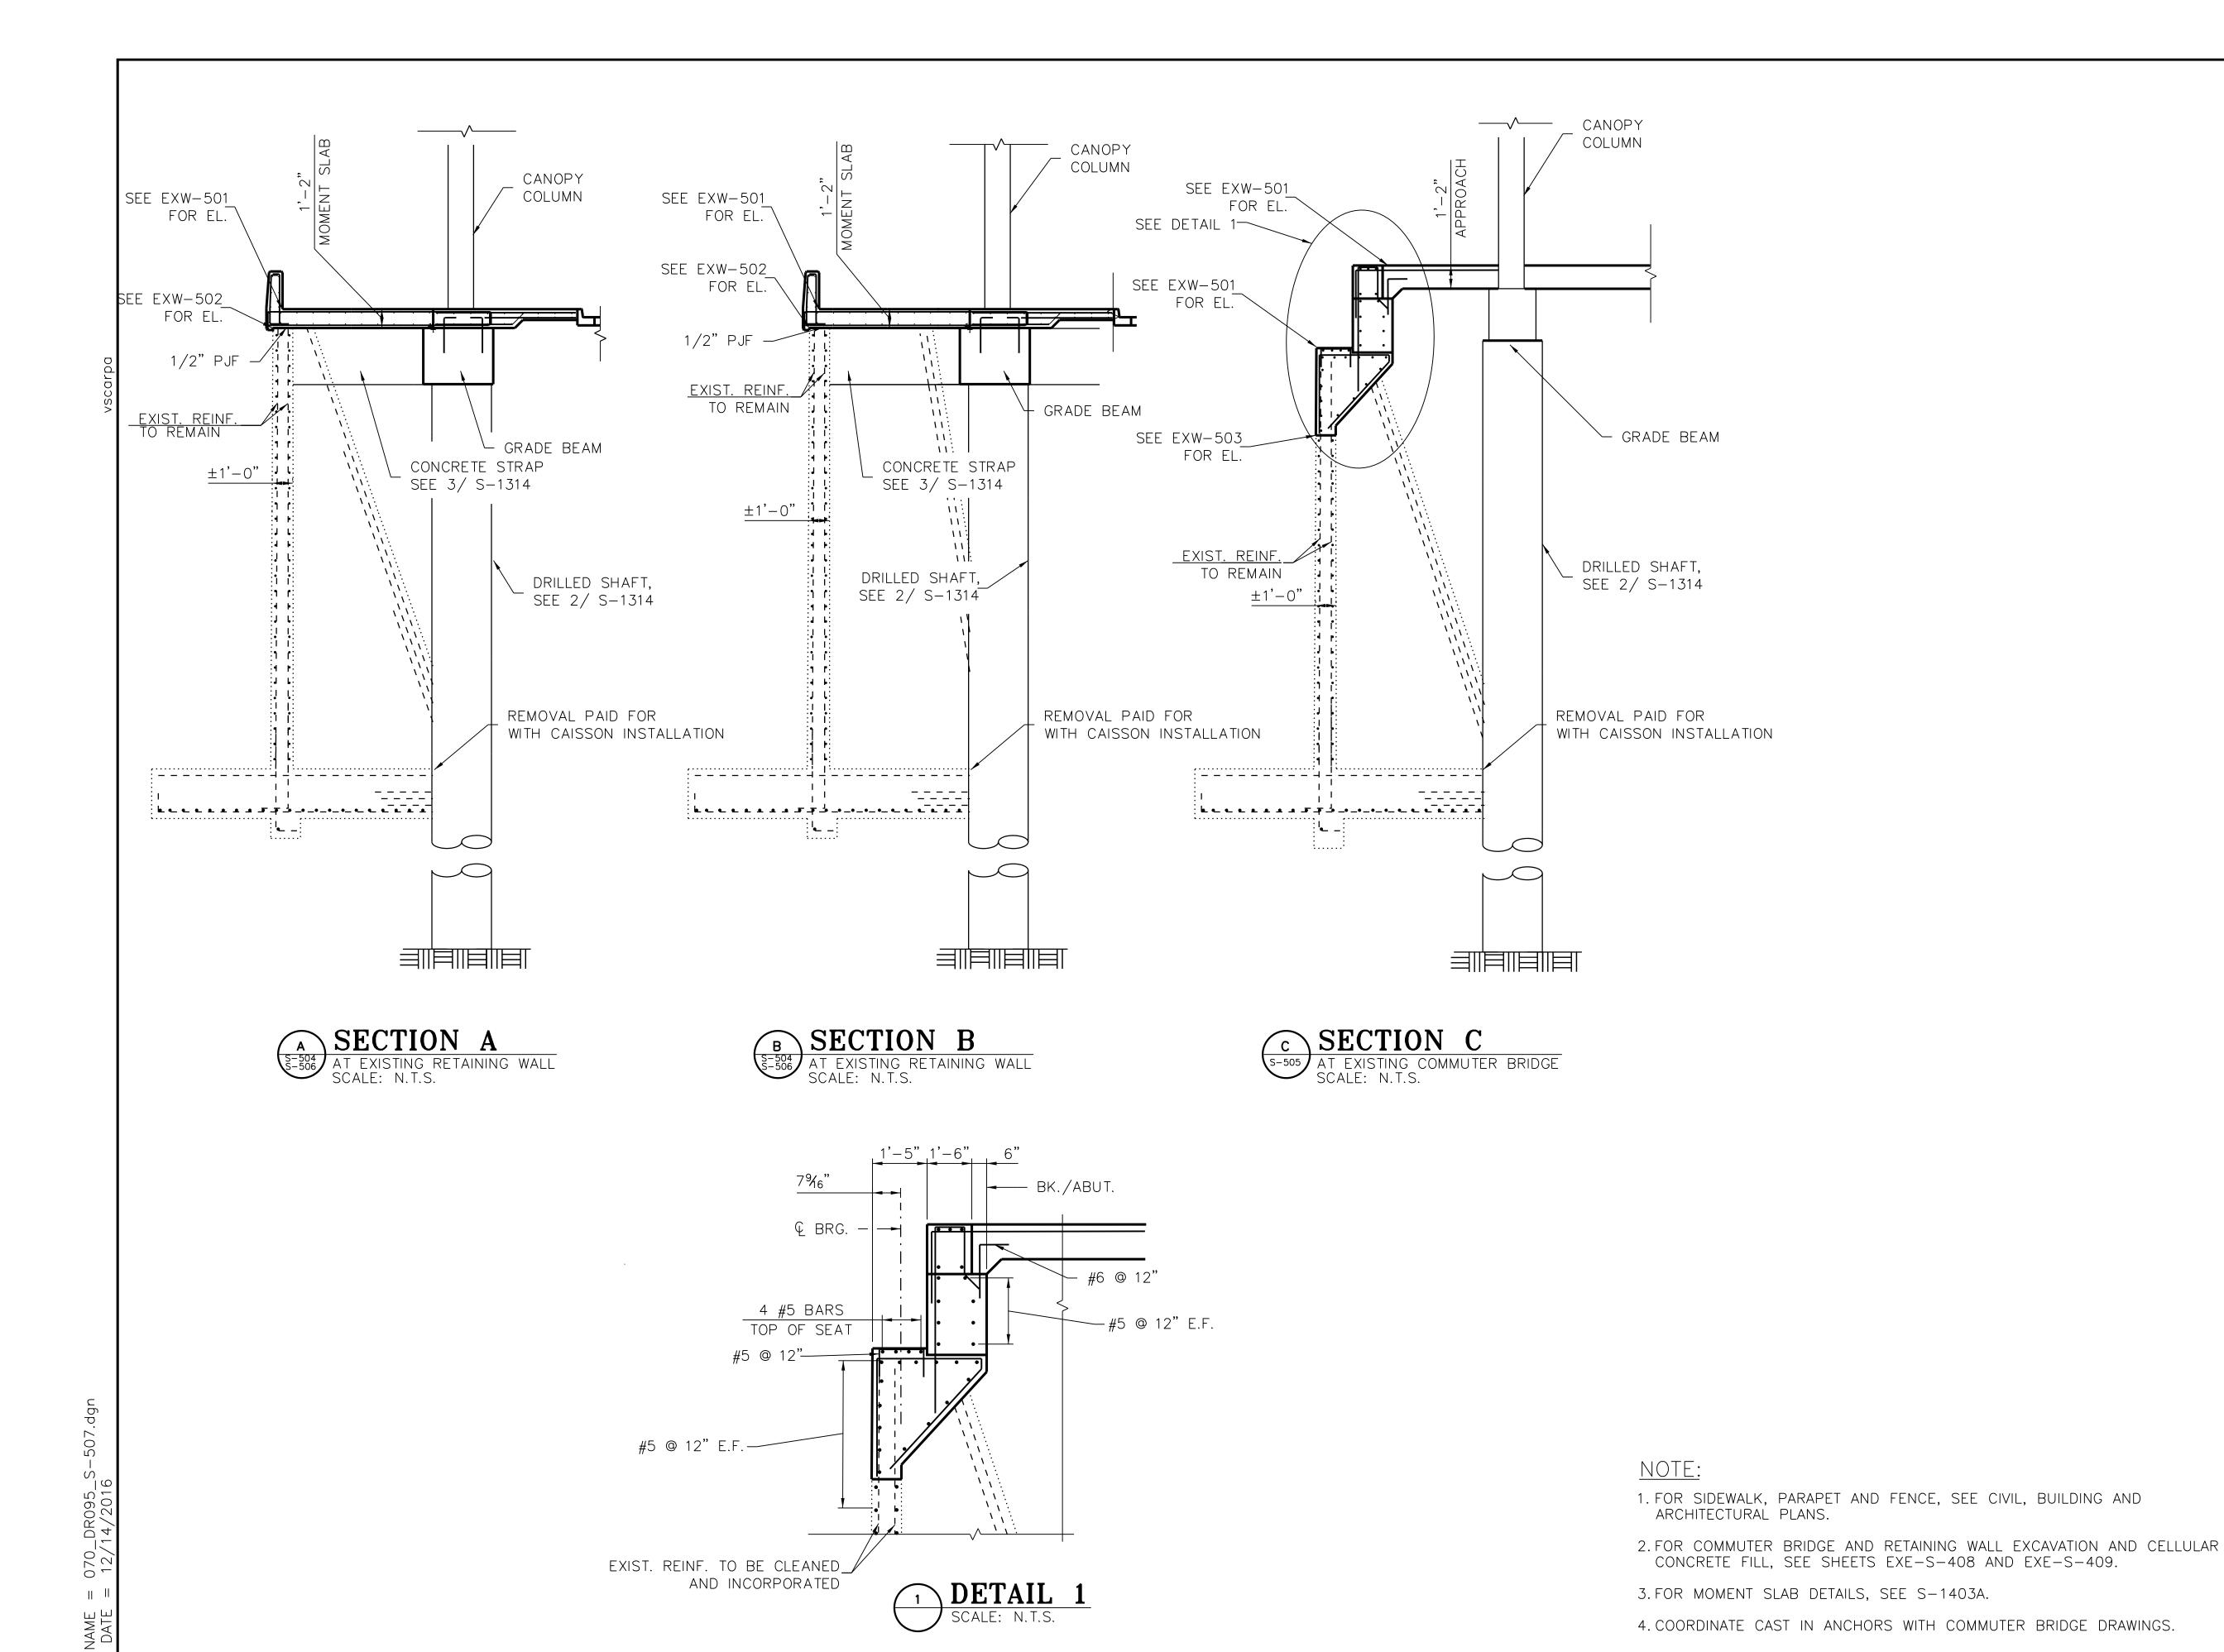



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## 95th Terminal Improvement


15 West 95th Street (South Terminal) Chicago, IL 60628

MARK	DATE	DESCRIPTION
	2/9/17	ISSUED FOR CONSTRUCTION
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FILE N	AME	File Name
PROJECT NO.		2012-0021
DRAW	N BY	T.SLEDGE
DESIG	NED BY	L.SOMMER
CHECK	KED BY	P.MAID
APPRO	OVED BY	D.ZROKA
IN CHA	NRGE	S. KADERBEK


LOCATION IDENTIFIER: **DR095** 

EXISTING WEST RETAINING WALL SECTIONS & DETAILS


EXW-S-507

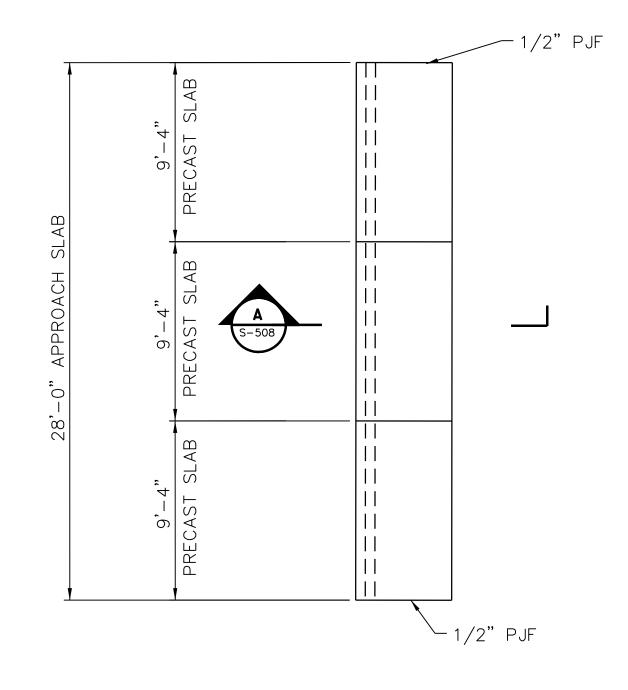




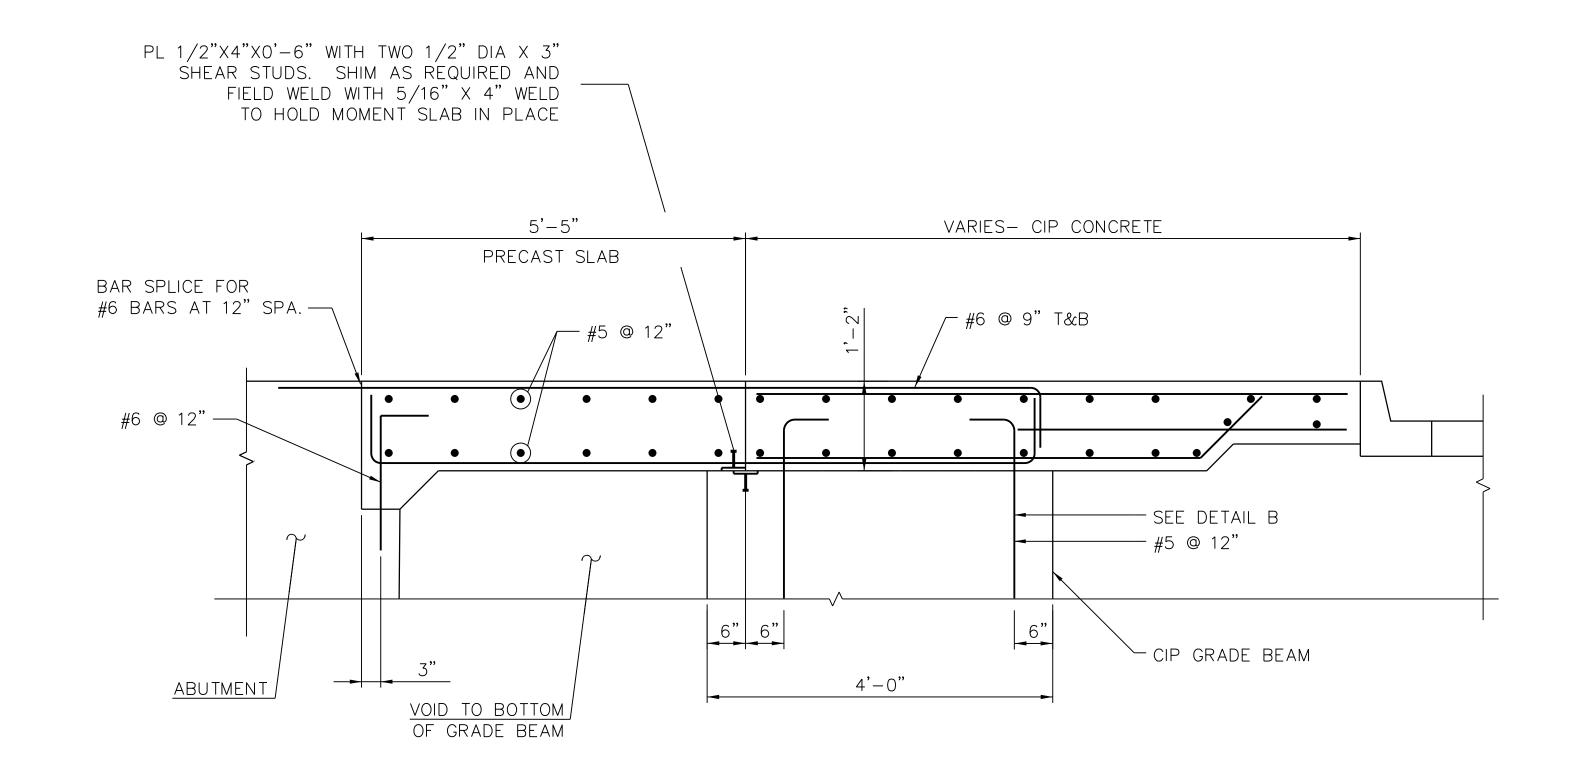



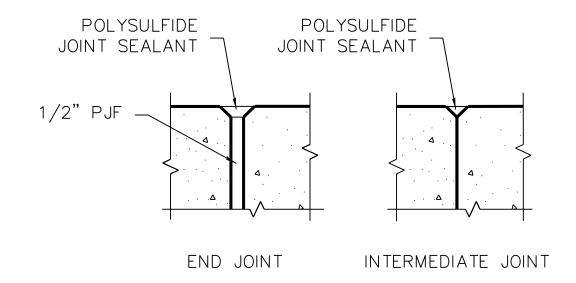



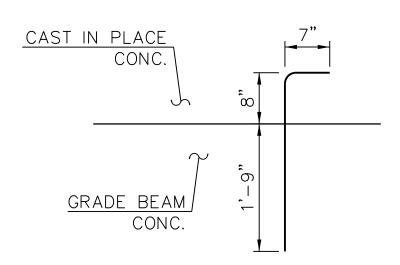









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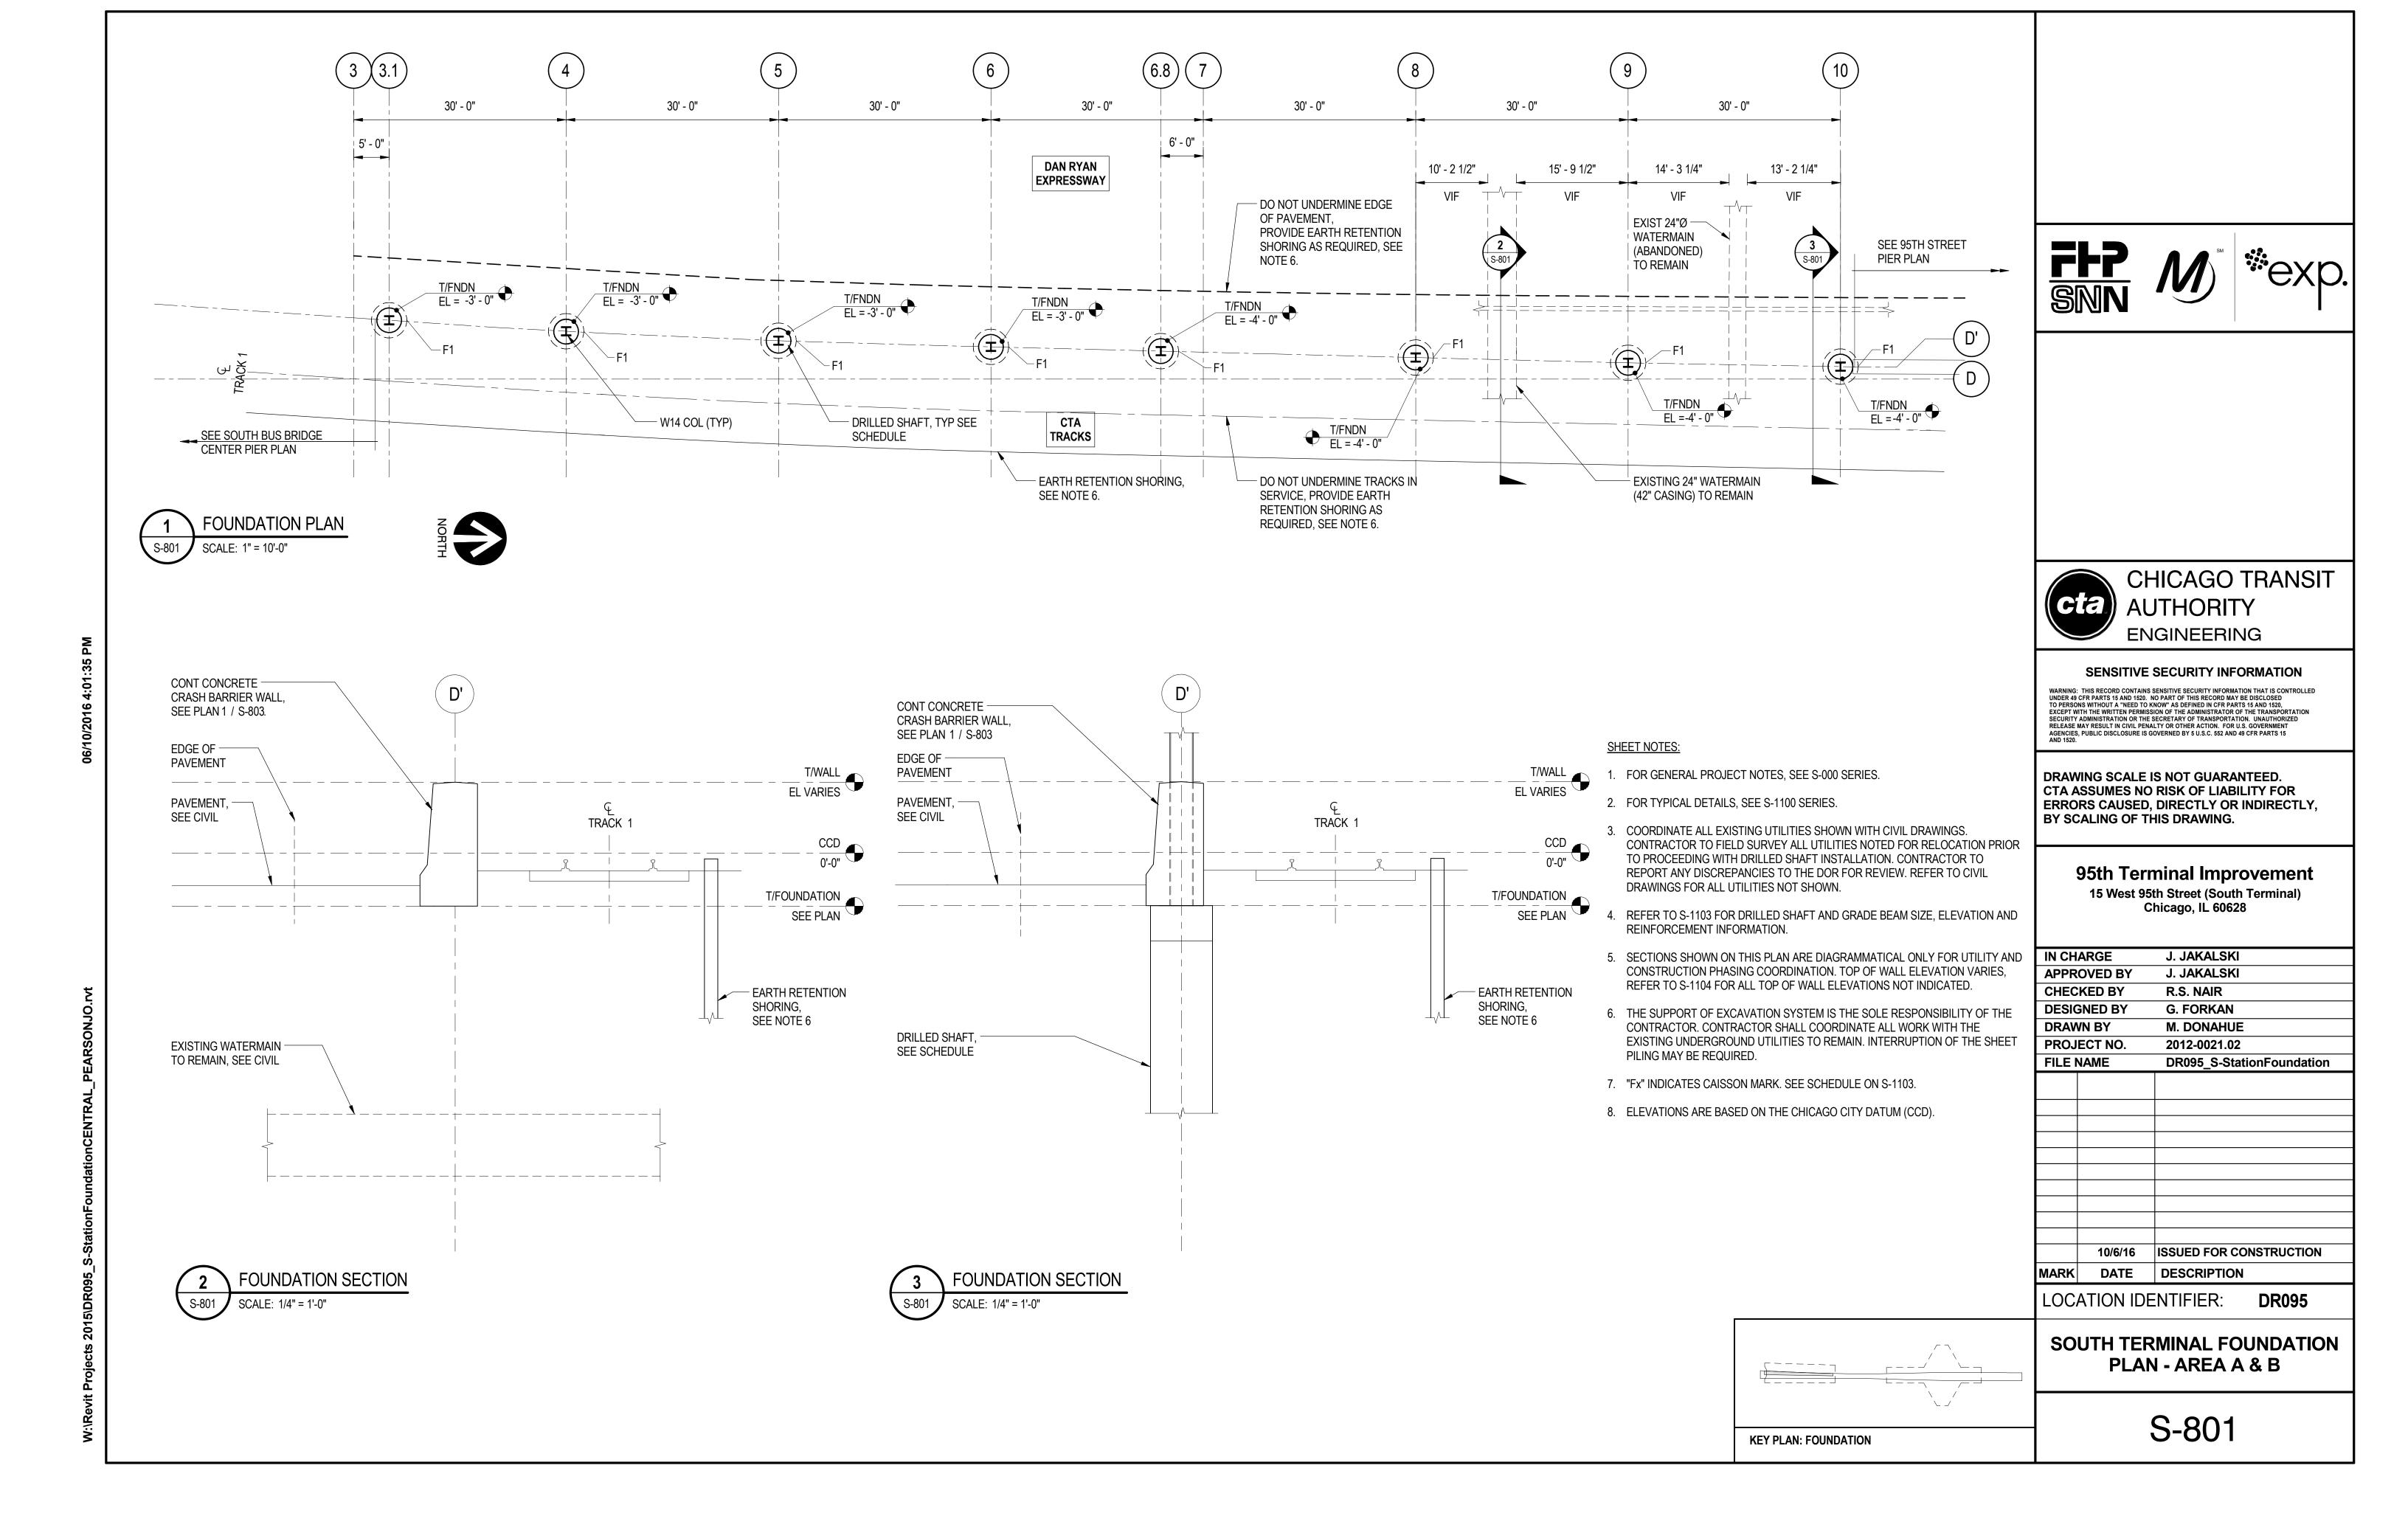
## 95th Terminal Improvement


15 West 95th Street (South Terminal) Chicago, IL 60628

IN CH	ARGE	S. KADERBEK
APPR	OVED BY	D.ZROKA
CHEC	KED BY	P.MAID
DESIG	ENED BY	L.SOMMER
DRAW	/N BY	T.SLEDGE
PROJ	ECT NO.	2012-0021
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COMMUTER BRIDGE WEST APPROACH SLAB

EXW-S-508




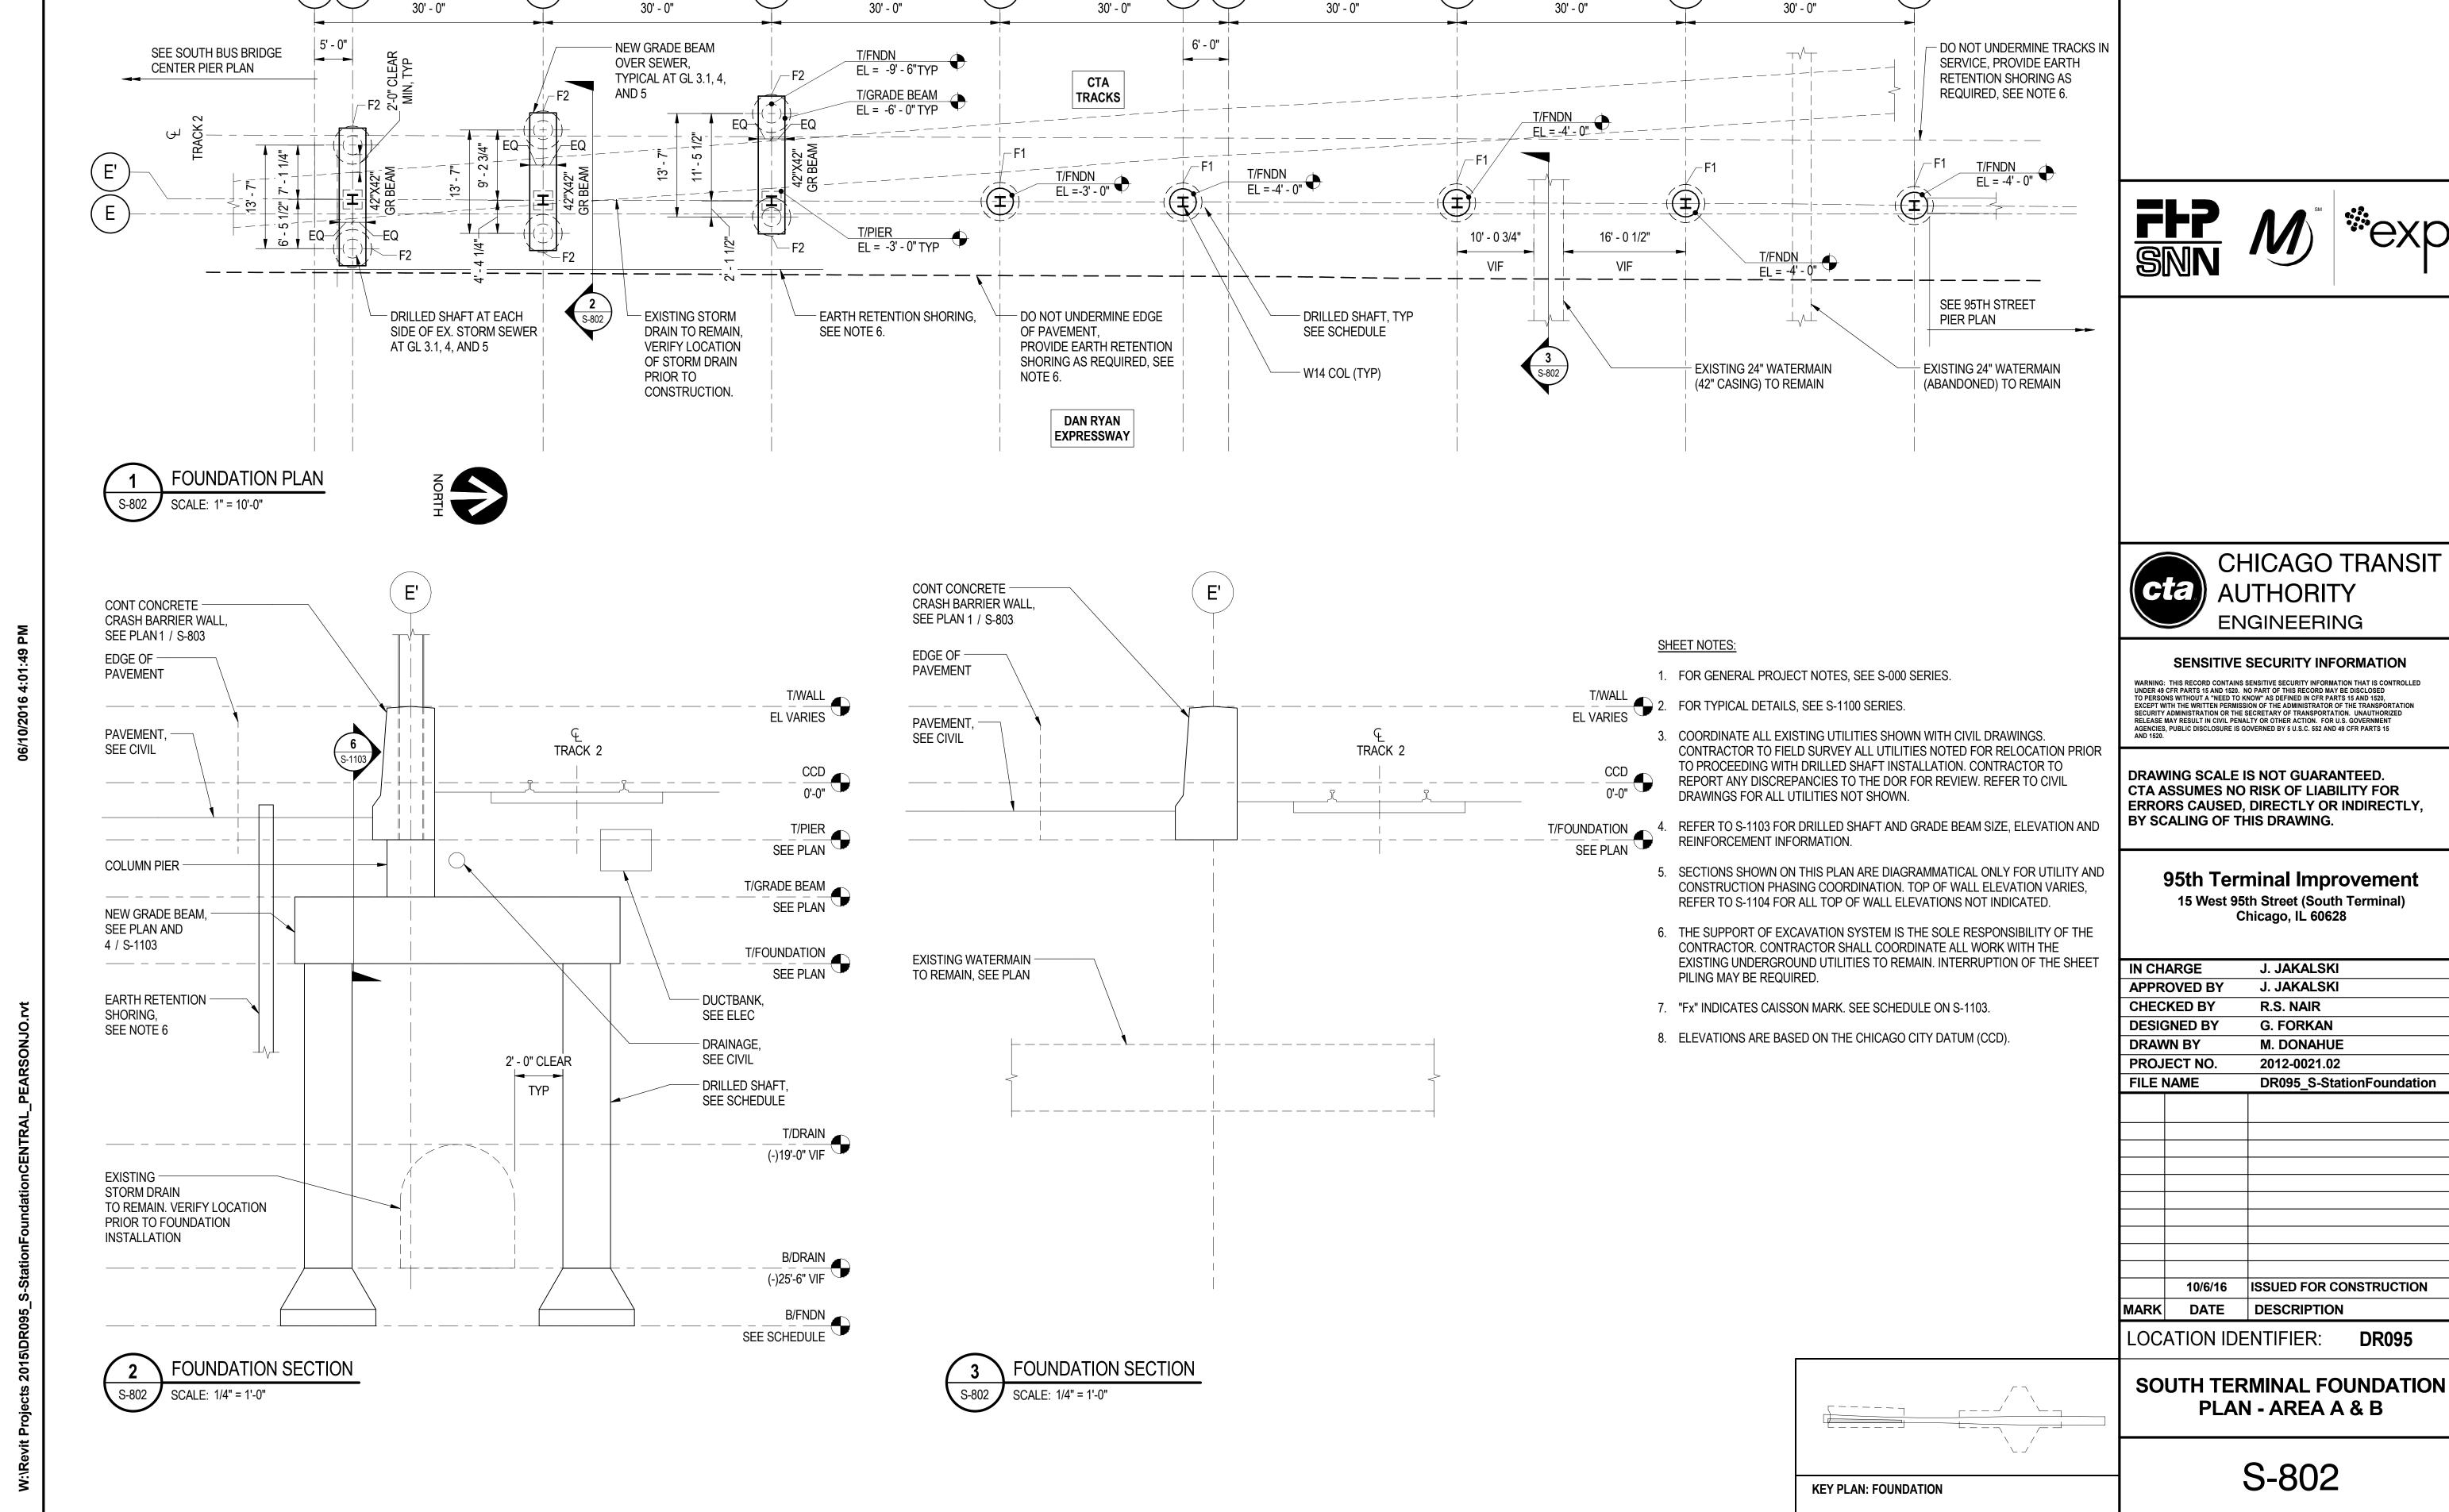


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CHICAGO TRANSIT

IN CH	ARGE	J. JAKALSKI
APPR	OVED BY	J. JAKALSKI
CHEC	KED BY	R.S. NAIR
DESIG	SNED BY	G. FORKAN
DRAWN BY		M. DONAHUE
PROJ	ECT NO.	2012-0021.02
FILE	NAME	DR095_S-StationFoundation
	10/6/16	ISSUED FOR CONSTRUCTION
MARK	DATE	DESCRIPTION

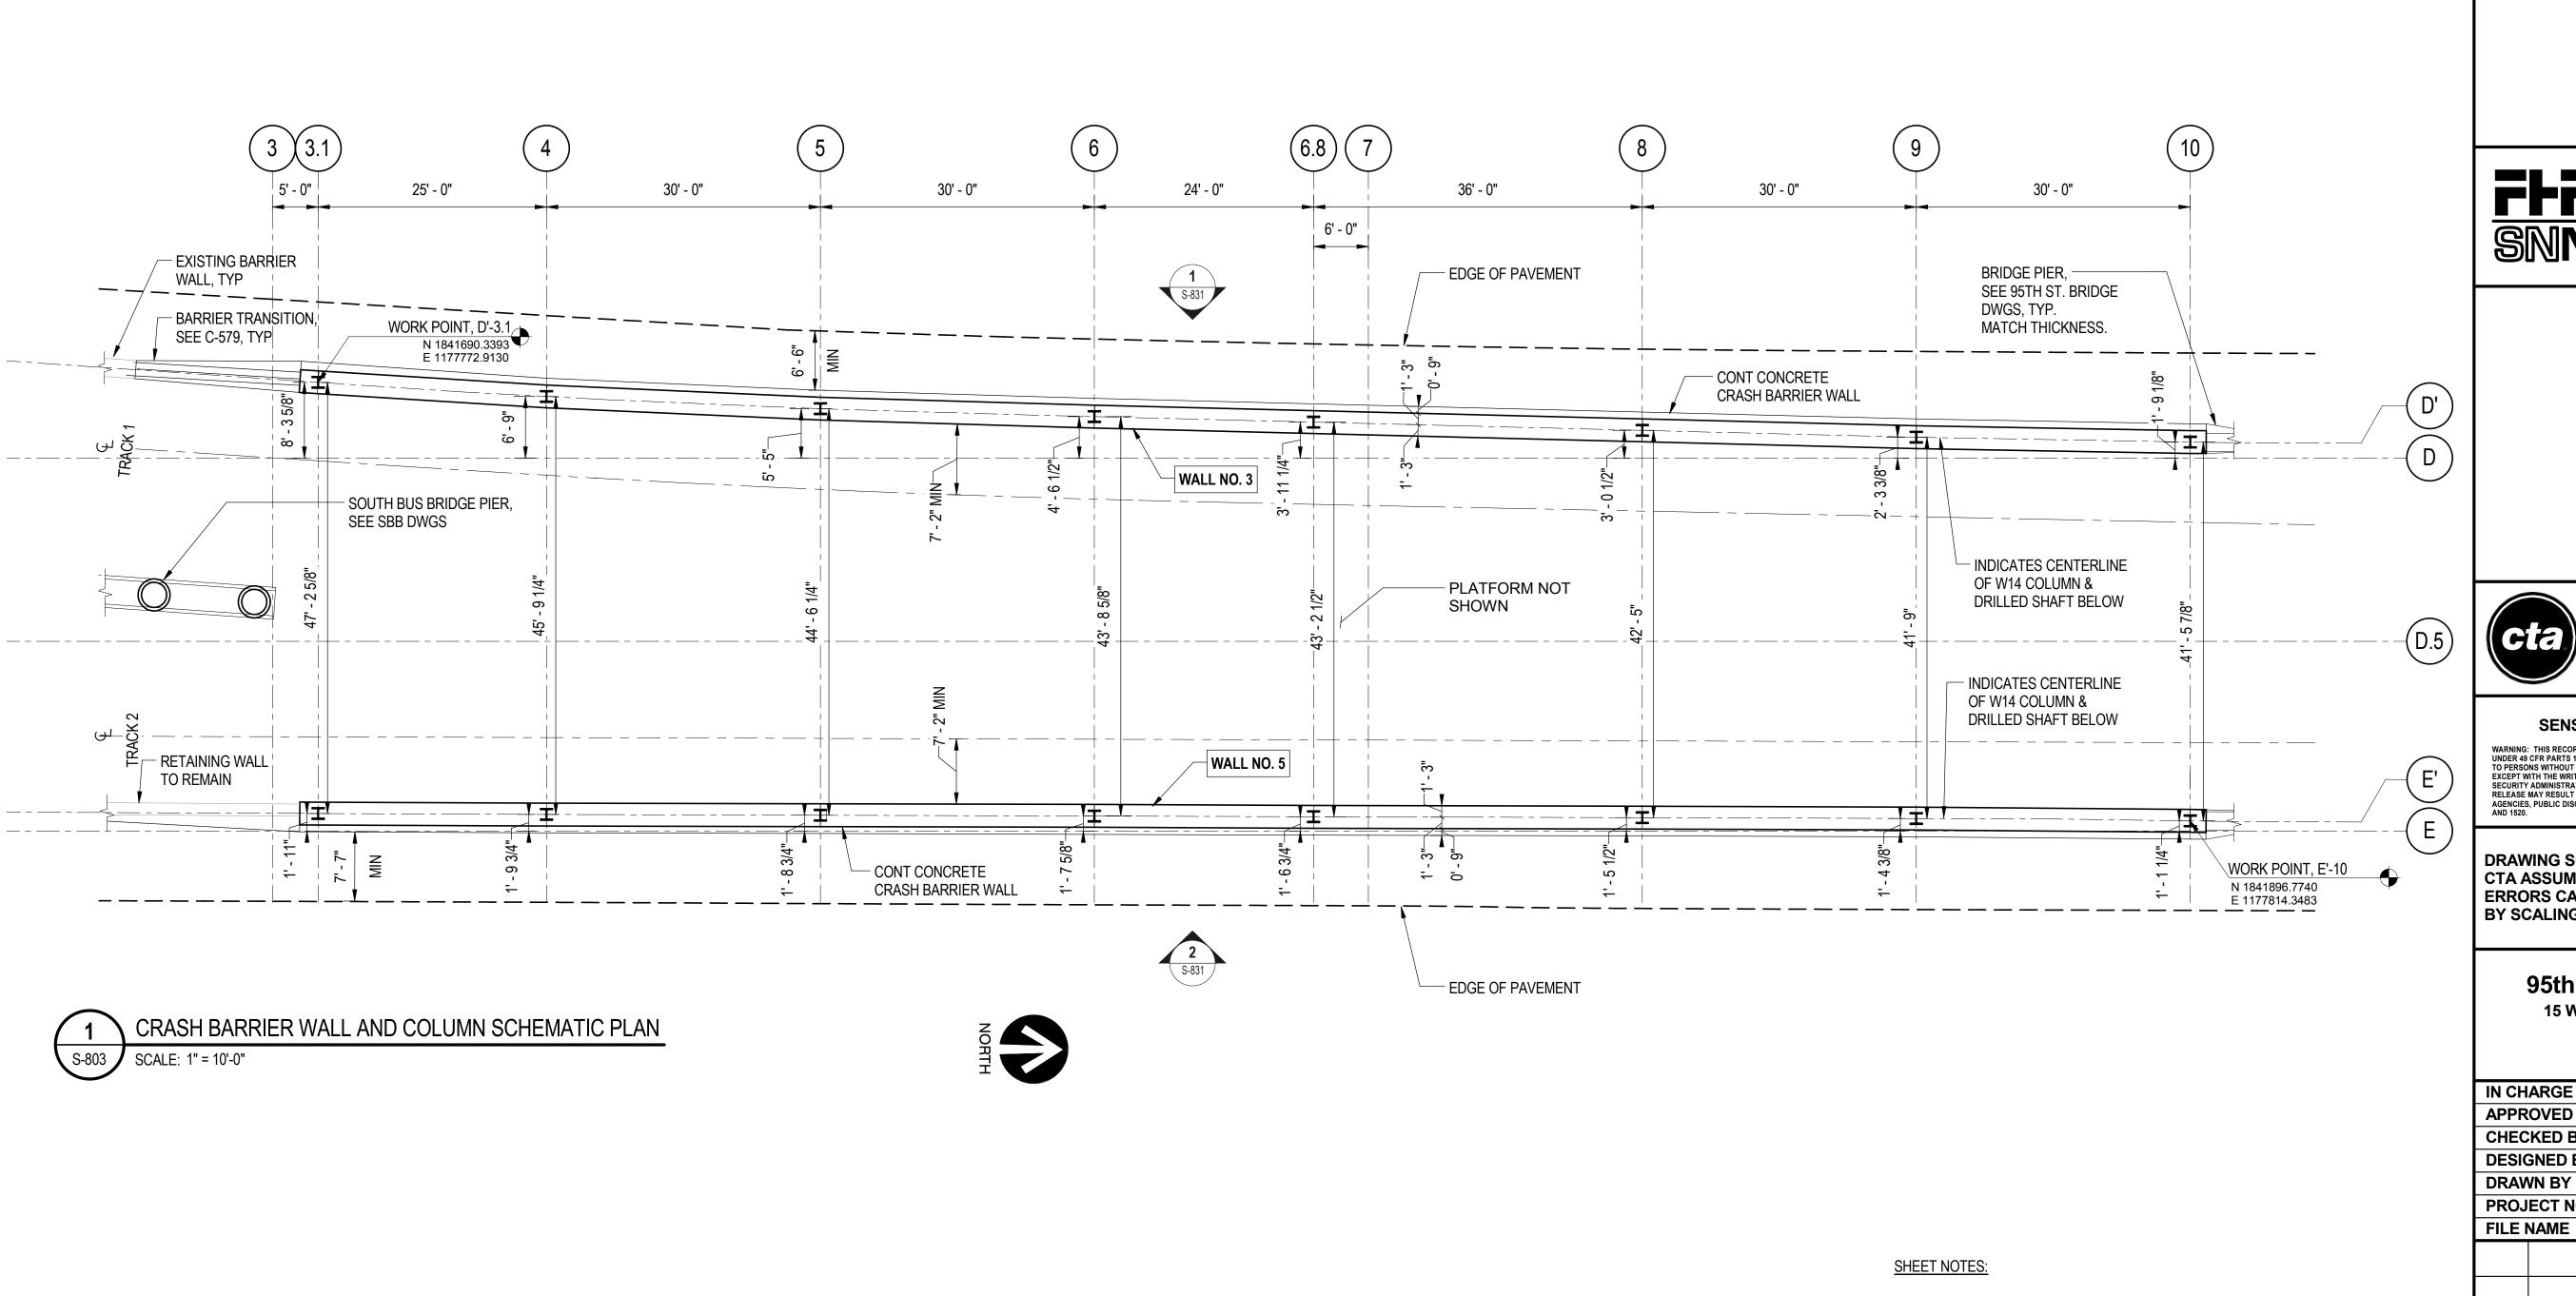

- 1. FOR GENERAL PROJECT NOTES, SEE S-000 SERIES.
- 2. FOR TYPICAL DETAILS, SEE S-1100 SERIES.
- 3. REFER TO S-1104 FOR WALL REINFORCEMENT AND DETAILS.
- 4. PROVIDE CONTROL JOINT AT 15'-0" O.C. MAX. TYP, SEE S-1112.
- 5. ALL EXPOSED EDGES SHALL BE CHAMFERED 3/4", INCLUDING THE TOP OF THE WALL AND AT THE INTERFACE WITH BRIDGE PIERS.

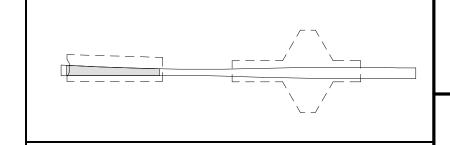

**KEY PLAN: CRASH BARRIER WALLS** 





SENSITIVE SECURITY INFORMATION


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95th Terminal Improvement 15 West 95th Street (South Terminal) Chicago, IL 60628

IN CH	ARGE	J. JAKALSKI
APPR	OVED BY	J. JAKALSKI
CHEC	KED BY	R.S. NAIR
DESIG	ENED BY	G. FORKAN
DRAW	/N BY	M. DONAHUE
PROJ	ECT NO.	2012-0021.02
FILE N	NAME	DR095_S-StationFoundation
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LOC	ATION IDE	NTIFIER: <b>DR095</b>


**SOUTH TERMINAL CRASH** BARRIER WALL AND COLUMN **LOCATION PLAN** 



KEY PLAN: WALKWAY / PLATFORM LEVEL

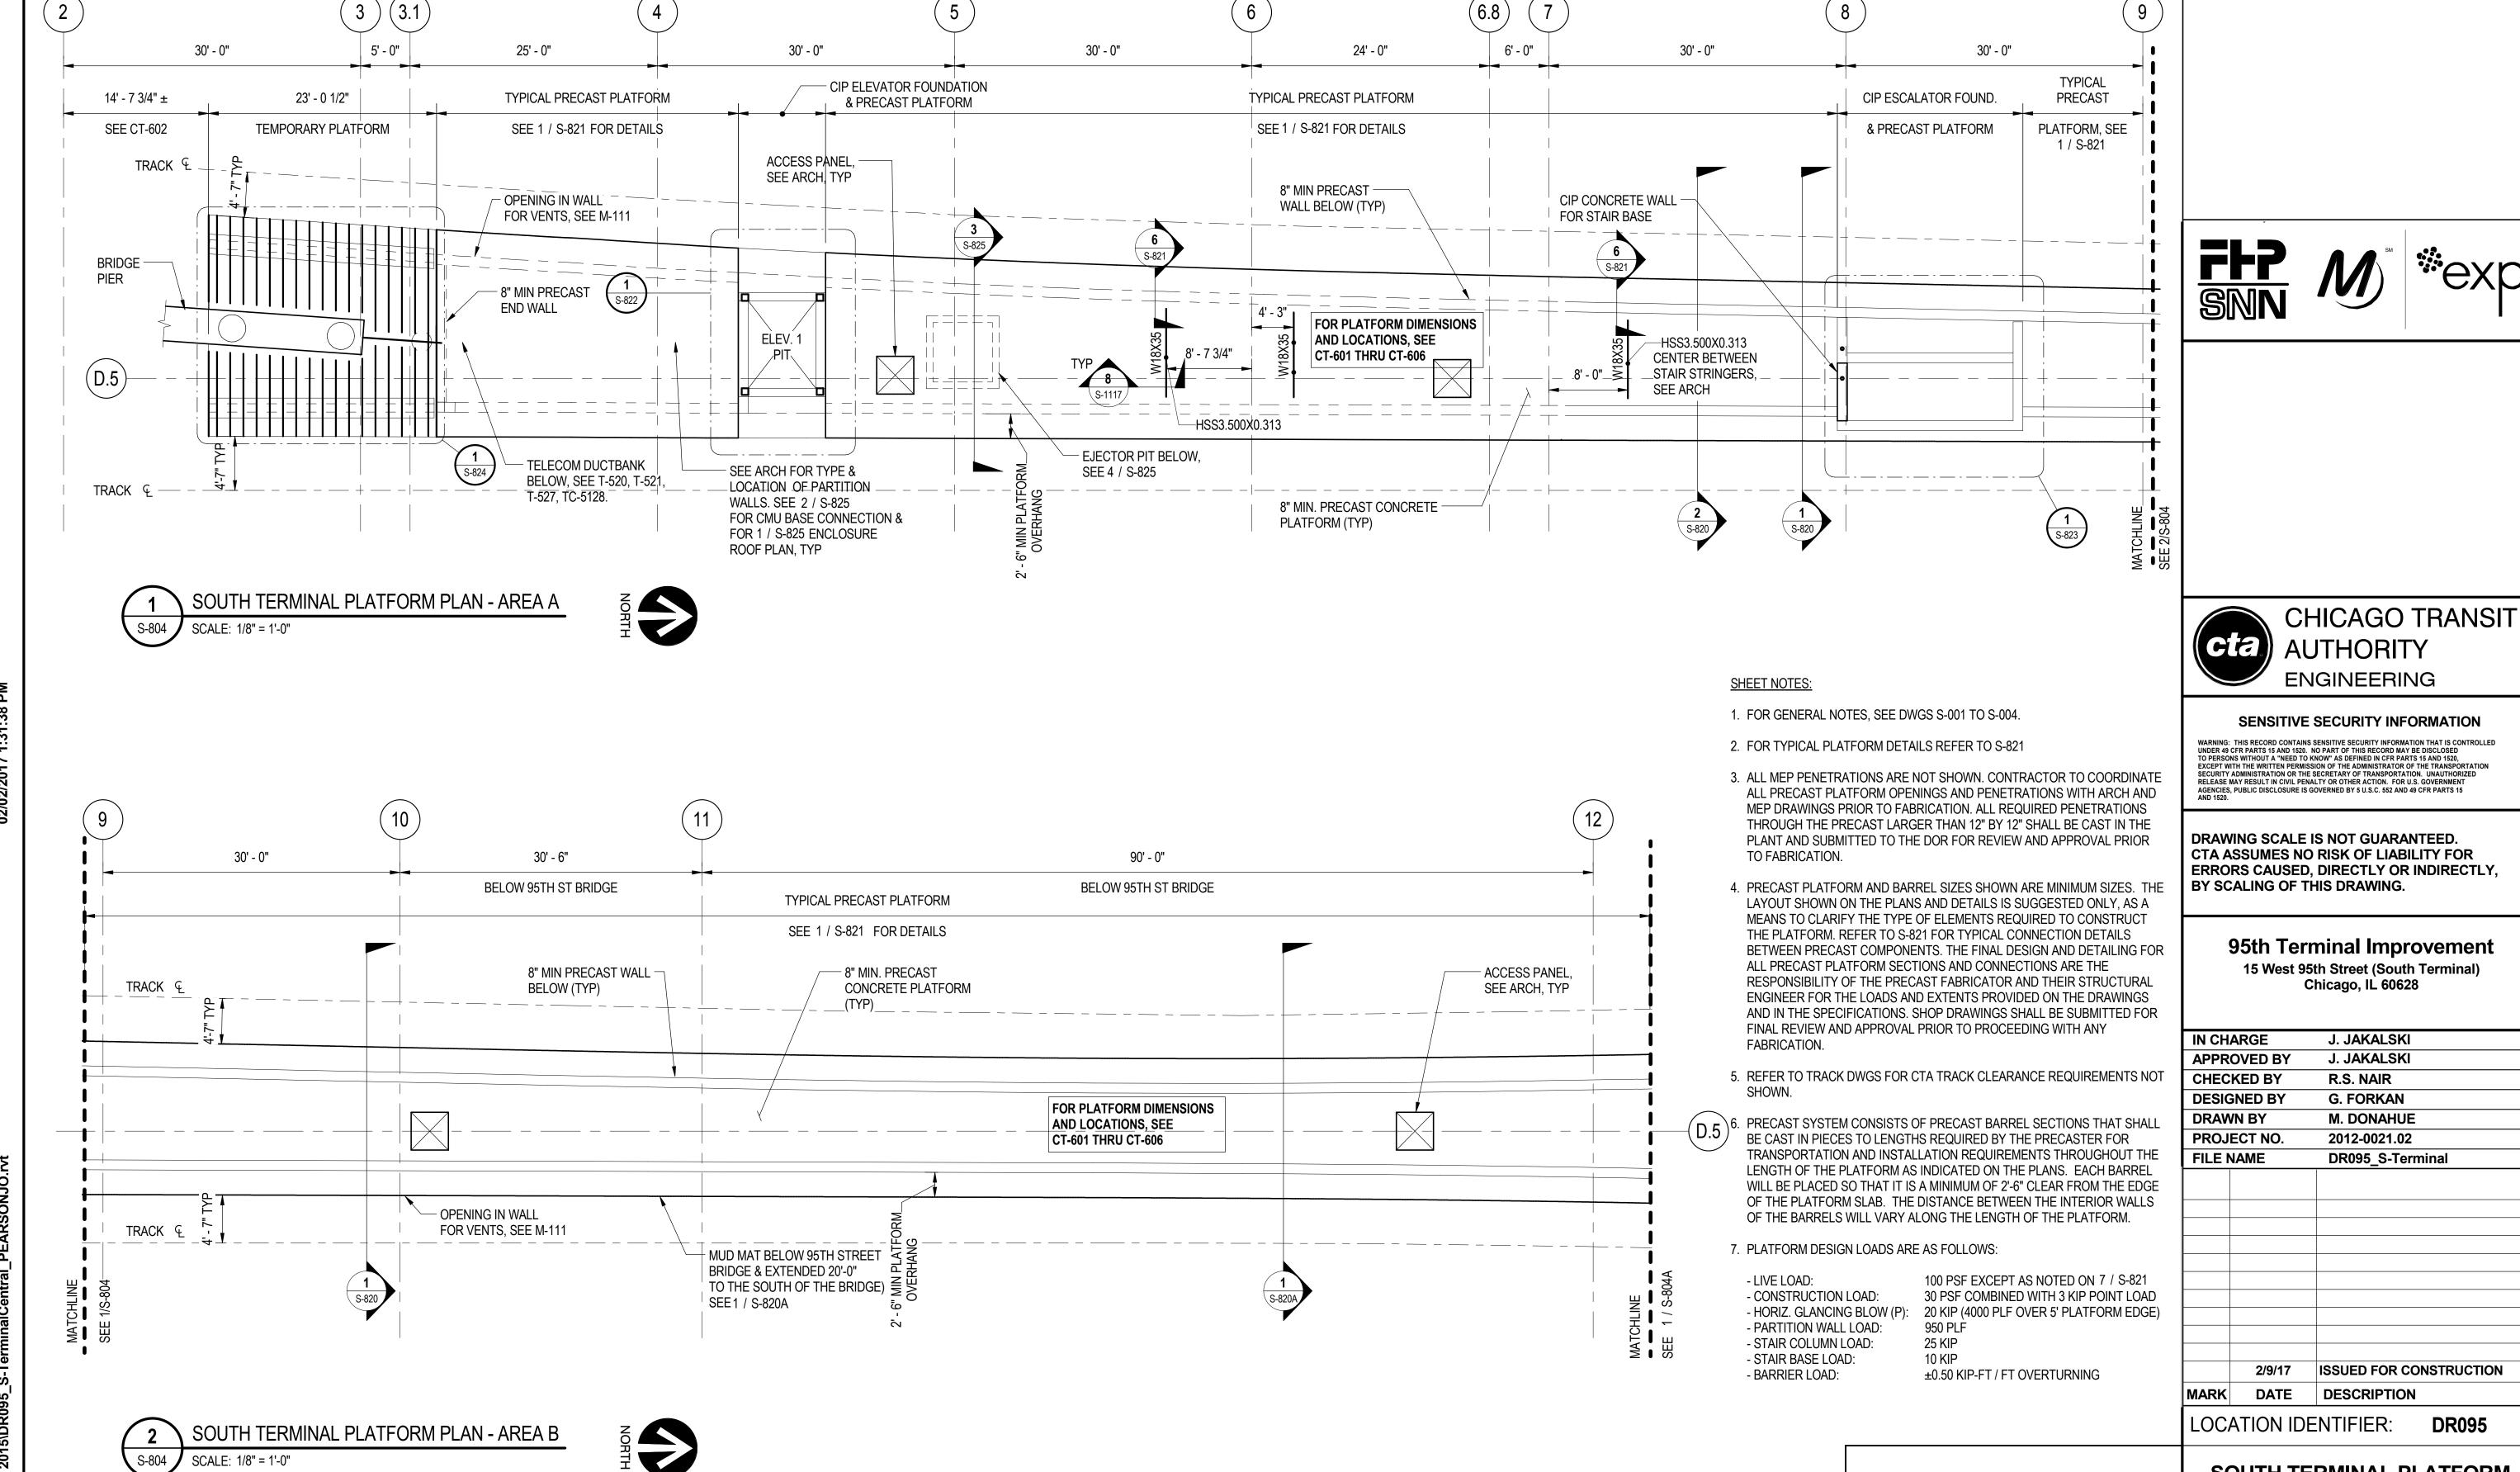SOUTH TERMINAL PLATFORM PLAN - AREA A & B



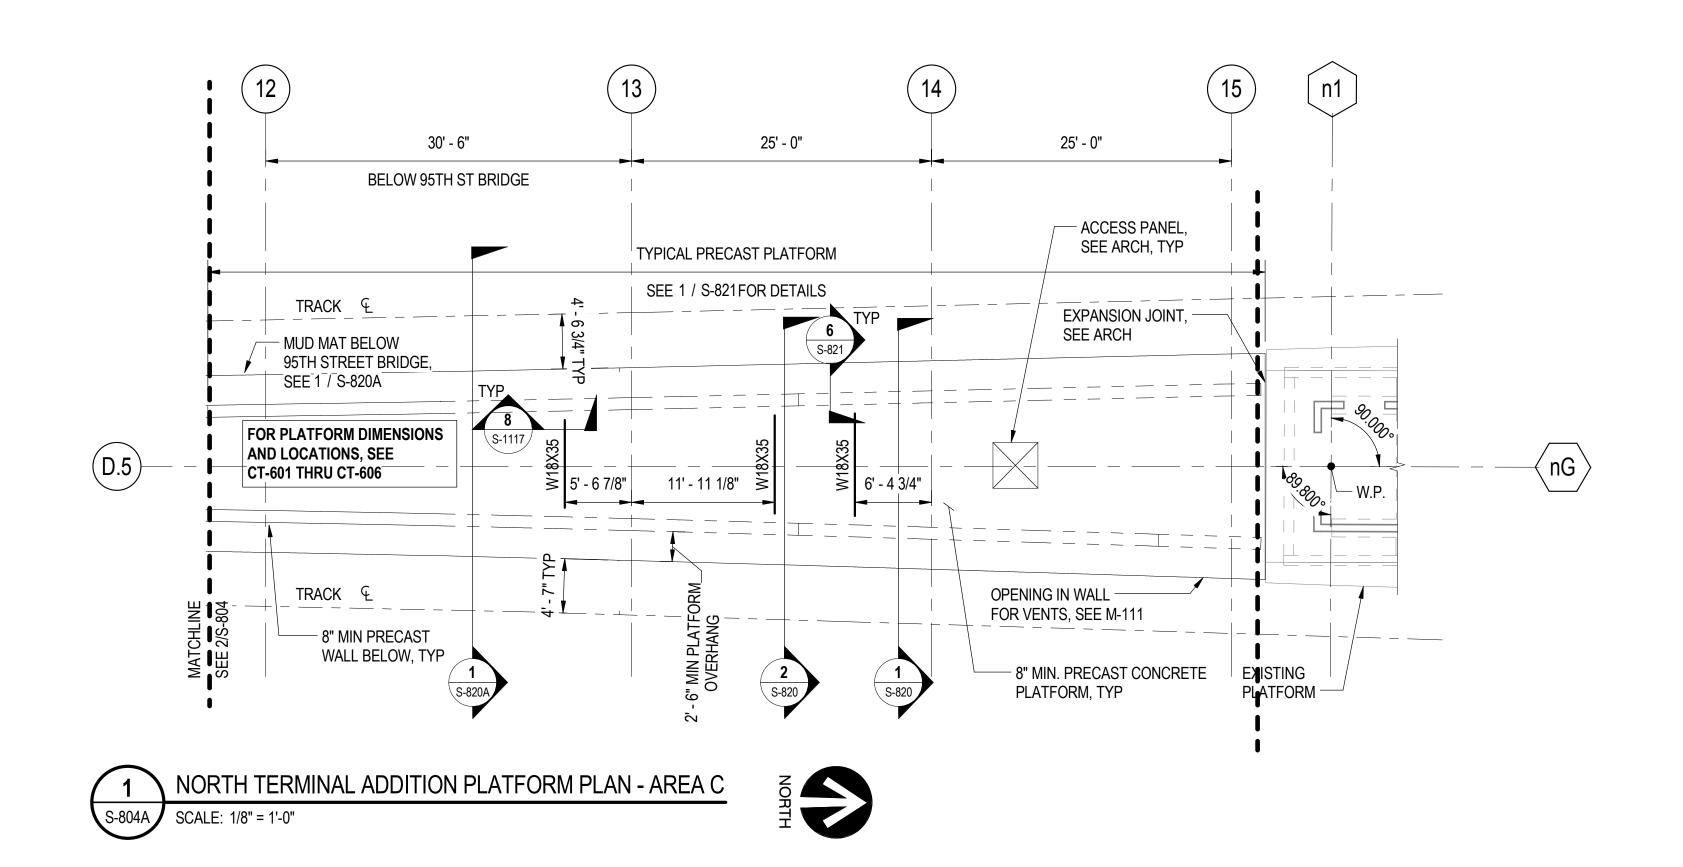



SHEET NOTES:


- 1. FOR GENERAL NOTES, SEE DWGS S-001 TO S-004.
- 2. FOR TYPICAL PLATFORM DETAILS REFER TO S-821
- 3. ALL MEP PENETRATIONS ARE NOT SHOWN. CONTRACTOR TO COORDINATE ALL PRECAST PLATFORM OPENINGS AND PENETRATIONS WITH ARCH AND MEP DRAWINGS PRIOR TO FABRICATION. ALL REQUIRED PENETRATIONS THROUGH THE PRECAST LARGER THAN 12" BY 12" SHALL BE CAST IN THE PLANT AND SUBMITTED TO THE DOR FOR REVIEW AND APPROVAL PRIOR TO FABRICATION.
- 4. PRECAST PLATFORM AND BARREL SIZES SHOWN ARE MINIMUM SIZES. THE LAYOUT SHOWN ON THE PLANS AND DETAILS IS SUGGESTED ONLY, AS A MEANS TO CLARIFY THE TYPE OF ELEMENTS REQUIRED TO CONSTRUCT THE PLATFORM. REFER TO S-821 FOR TYPICAL CONNECTION DETAILS BETWEEN PRECAST COMPONENTS. THE FINAL DESIGN AND DETAILING FOR ALL PRECAST PLATFORM SECTIONS AND CONNECTIONS ARE THE RESPONSIBILITY OF THE PRECAST FABRICATOR AND THEIR STRUCTURAL ENGINEER FOR THE LOADS AND EXTENTS PROVIDED ON THE DRAWINGS AND IN THE SPECIFICATIONS. SHOP DRAWINGS SHALL BE SUBMITTED FOR FINAL REVIEW AND APPROVAL PRIOR TO PROCEEDING WITH ANY FABRICATION.
- 5. REFER TO TRACK DWGS FOR CTA TRACK CLEARANCE REQUIREMENTS NOT
- 6. PRECAST SYSTEM CONSISTS OF PRECAST BARREL SECTIONS THAT SHALL BE CAST IN PIECES TO LENGTHS REQUIRED BY THE PRECASTER FOR TRANSPORTATION AND INSTALLATION REQUIREMENTS THROUGHOUT THE LENGTH OF THE PLATFORM AS INDICATED ON THE PLANS. EACH BARREL WILL BE PLACED SO THAT IT IS A MINIMUM OF 2'-6" CLEAR FROM THE EDGE OF THE PLATFORM SLAB. THE DISTANCE BETWEEN THE INTERIOR WALLS OF THE BARRELS WILL VARY ALONG THE LENGTH OF THE PLATFORM.
- 7. PLATFORM DESIGN LOADS ARE AS FOLLOWS:

- LIVE LOAD: - CONSTRUCTION LOAD: - PARTITION WALL LOAD: - STAIR COLUMN LOAD: - STAIR BASE LOAD: - BARRIER LOAD:

100 PSF EXCEPT AS NOTED ON 7 / S-821 30 PSF COMBINED WITH 3 KIP POINT LOAD - HORIZ. GLANCING BLOW (P): 20 KIP (4000 PLF OVER 5' PLATFORM EDGE) 950 PLF 25 KIP

10 KIP

±0.50 KIP-FT / FT OVERTURNING

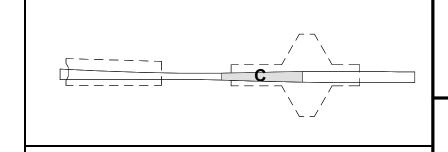

**KEY PLAN: WALKWAY / PLATFORM LEVEL** 



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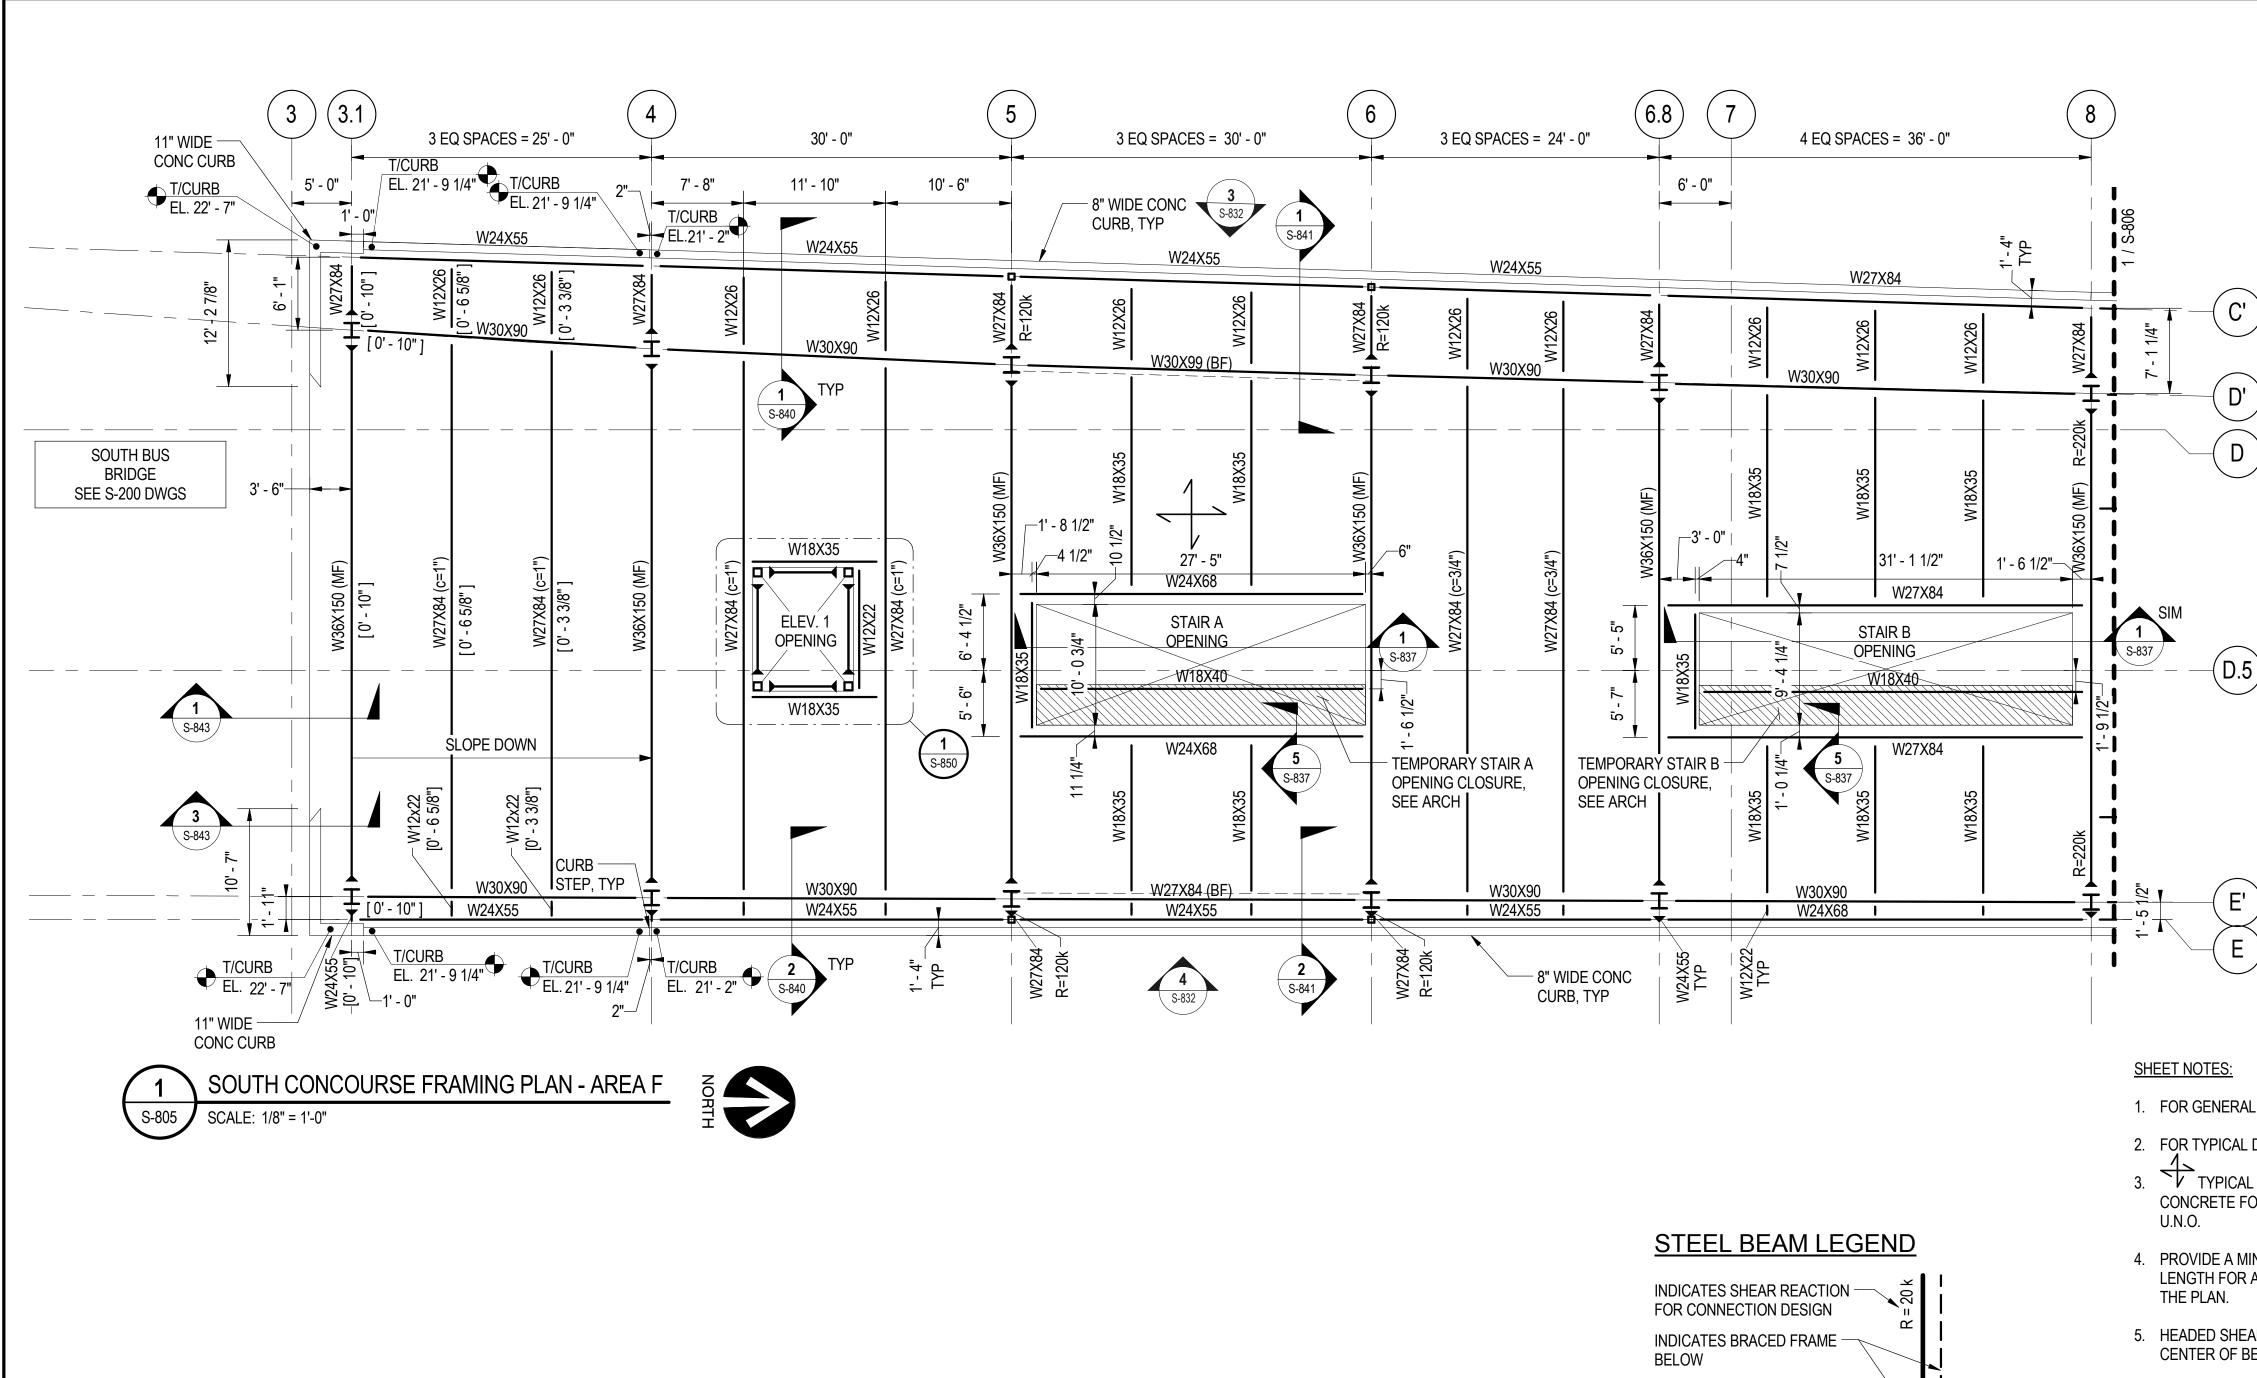
### 95th Terminal Improvement


15 West 95th Street (South Terminal) Chicago, IL 60628

IN CH	ARGE	J. JAKALSKI	
APPR	OVED BY	J. JAKALSKI	
CHEC	KED BY	R.S. NAIR	
DESIG	ENED BY	G. FORKAN	
DRAWN BY		C. BOVE	
PROJECT NO.		2012-0021.02	
FILE NAME		DR095_S-Ter	minal
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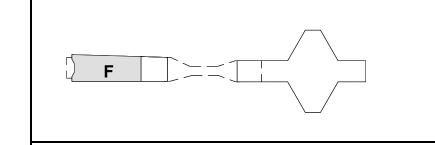
NORTH TERMINAL ADDITION PLATFORM PLAN - AREA C

S-804A



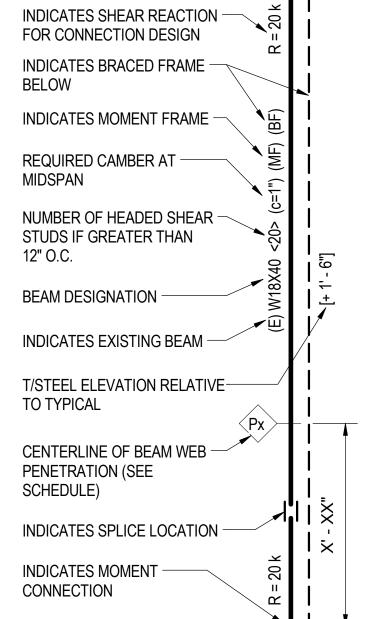

- 1. FOR GENERAL NOTES, SEE DWGS S-001 TO S-004.
- 2. FOR TYPICAL DETAILS REFER TO S-1112 TO S-1120.
- 3. TYPICAL FLOOR CONSTRUCTION: 8" NORMAL WEIGHT CONCRETE FORMED SLAB W/ #4 BARS T&B EA. WAY @ 12" O.C.
- 4. PROVIDE A MINIMUM OF 1 SHEAR STUD PER FOOT OF BEAM LENGTH FOR ALL BEAMS WHERE STUDS ARE NOT INDICATED ON
- 5. HEADED SHEAR STUDS ARE 3/4" DIA X 6" LONG, STUD WELDED TO CENTER OF BEAM TOP FLANGE AT 12" O.C. MIN.
- 6. FOR TOP OF FINISHED FLOOR ELEVATIONS AND INFORMATION REGARDING FLOOR PENETRATIONS FOR STAIRS, ESCALATORS, AND ELEVATORS, SEE ARCH DWGS.
- 7. FOR EXACT LOCATION OF ALL STEEL AROUND VERTICAL CIRCULATION OPENINGS, COORDINATE WITH VERTICAL CIRCULATION MANUFACTURER REQUIREMENTS.
- 8. TOP OF STEEL IS 19' 4 1/2" CCD TYPICAL UNO.
- 9. SEE S-833 & S-834 FOR MOMENT FRAME ELEVATIONS.
- 10. SEE MEP DRAWINGS FOR LOCATIONS OF FLOOR PENETRATIONS, SEE 5 / S-1115 & 2 / S-1113
- 11. ALL CONCOURSE LEVEL STEEL FRAMING TO BE GALVANIZED
- 12. STEEL BEAMS SHALL BE LATERALLY BRACED DURING SLAB PLACEMENT.



**KEY PLAN: CONCOURSE LEVEL** 





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## 95th Terminal Improvement

15 West 95th Street (South Terminal) Chicago, IL 60628


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DRAWN BY PROJECT NO.		2012-0021.02
		M. DONAHUE
DESIG	NED BY	G. FORKAN
CHEC	KED BY	R.S. NAIR
APPR	OVED BY	J. JAKALSKI
N CH	ARGE	J. JAKALSKI

**DR095** LOCATION IDENTIFIER:

SOUTH TERMINAL CONCOURSE FRAMING PLAN - AREA F






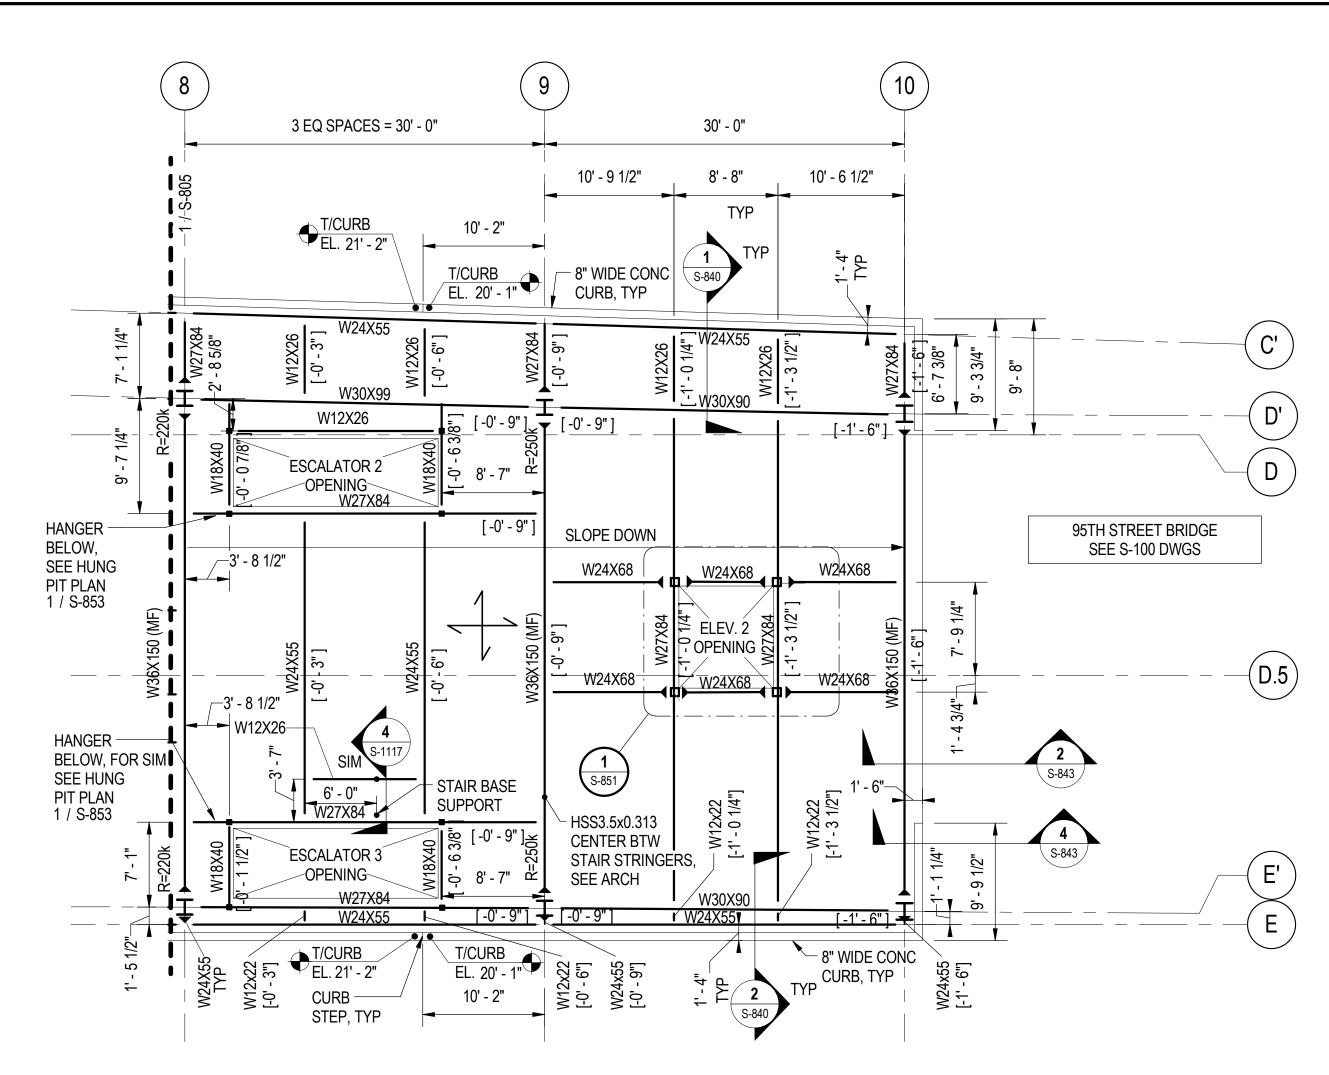

S-806 SCALE: 1/8" = 1'-0"




### STEEL BEAM LEGEND

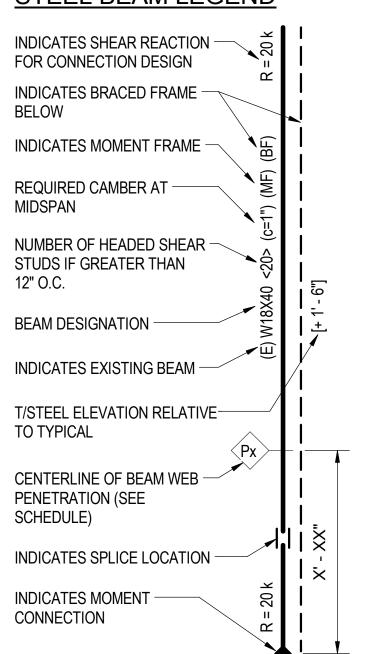

### SHEET NOTES:

- 1. FOR GENERAL NOTES, SEE DWGS S-001 TO S-004.
- 2. FOR TYPICAL DETAILS REFER TO S-1112 TO S-1120.
- 3. TYPICAL FLOOR CONSTRUCTION: 8" NORMAL WEIGHT CONCRETE FORMED SLAB W/ #4 BARS T&B EA. WAY @ 12" O.C. U.N.O.
- 4. PROVIDE A MINIMUM OF 1 SHEAR STUD PER FOOT OF BEAM LENGTH FOR ALL BEAMS WHERE STUDS ARE NOT INDICATED ON THE PLAN.
- 5. HEADED SHEAR STUDS ARE 3/4" DIA X 6" LONG, STUD WELDED TO CENTER OF BEAM TOP FLANGE AT 12" O.C. MIN.
- 6. FOR TOP OF FINISHED FLOOR ELEVATIONS AND INFORMATION REGARDING FLOOR PENETRATIONS FOR STAIRS, ESCALATORS, AND ELEVATORS, SEE ARCH DWGS.
- 7. FOR EXACT LOCATION OF ALL STEEL AROUND VERTICAL CIRCULATION OPENINGS, COORDINATE WITH VERTICAL CIRCULATION MANUFACTURER REQUIREMENTS.
- 8. TOP OF STEEL IS 19' 4 1/2" CCD TYPICAL UNO.
- 9. SEE S-833 & S-834 FOR MOMENT FRAME ELEVATIONS.
- 10. SEE MEP DRAWINGS FOR LOCATIONS OF FLOOR PENETRATIONS, SEE 5 / S-1115 & 2 / S-1113
- 11. ALL CONCOURSE LEVEL STEEL FRAMING TO BE GALVANIZED
- 12. STEEL BEAMS SHALL BE LATERALLY BRACED DURING SLAB PLACEMENT.

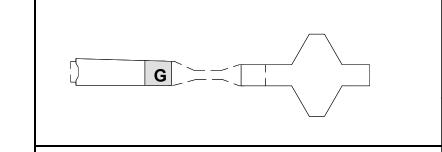

**KEY PLAN: CONCOURSE LEVEL** 

M) \*ex



#### **SENSITIVE SECURITY INFORMATION**

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## 95th Terminal Improvement


15 West 95th Street (South Terminal) Chicago, IL 60628

	IN CH	ARGE	J. JAKALSKI	
	APPR	OVED BY	J. JAKALSKI	
)	CHEC	KED BY	R.S. NAIR	
	DESIG	ENED BY	G. FORKAN	
	DRAW	/N BY	M. DONAHUE	
	PROJ	ECT NO.	2012-0021.02	
	FILE	NAME	DR095_S-Termi	nal
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	LOC	ATION IDE	ENTIFIER:	DR095

SOUTH TERMINAL CONCOURSE FRAMING PLAN - AREA G






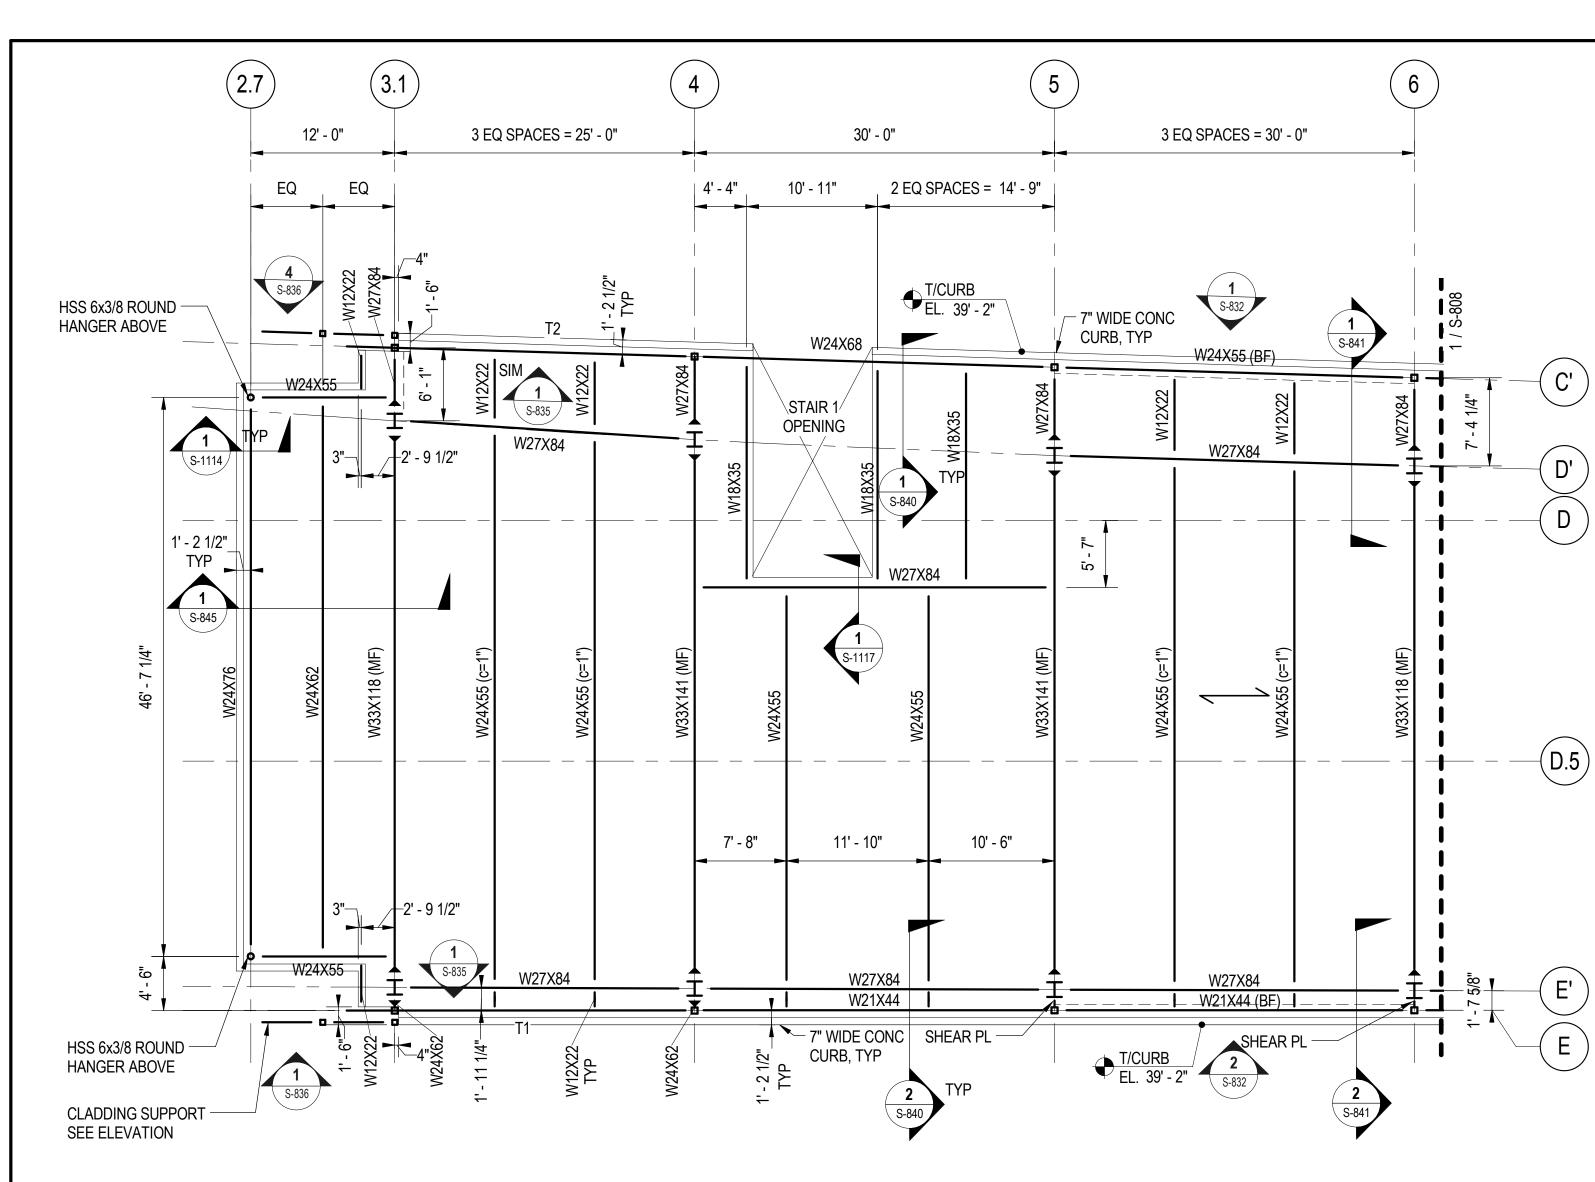






### STEEL BEAM LEGEND

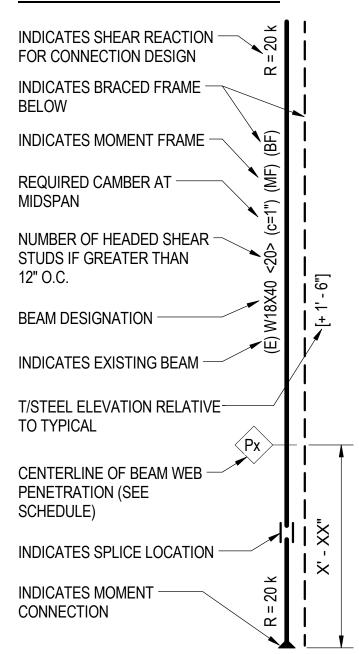

#### SHEET NOTES:

- 1. FOR GENERAL NOTES, SEE DWGS S-001 TO S-004.
- 2. FOR TYPICAL DETAILS REFER TO S-1112 TO S-1120.
- 3. TYPICAL FLOOR CONSTRUCTION: 3" 18 GAGE GALVANIZED COMPOSITE STEEL DECK W/ 3-1/2" MIN. LWC TOPPING (TOTAL THICKNESS = 6 1/2" MIN. REINF. W/ 6X6 W2.6XW2.6 WWF. FASTEN DECK AT STEEL SUPPORTS w/ 3/4" PUDDLE WELDS AT 12" O.C. & PROVIDE 2 WELDED SIDELAPS.
- 4. PROVIDE A MINIMUM OF 1 SHEAR STUD PER FOOT OF BEAM LENGTH FOR ALL BEAMS WHERE STUDS ARE NOT INDICATED ON THE PLAN.
- HEADED SHEAR STUDS ARE 3/4" DIA X 5 1/4" LONG, ATTACHED TO THE BEAM TOP FLANGE PER THE TYPICAL COMPOSITE SLAB DETAIL.
- 6. FOR EXACT LOCATION OF ALL STEEL AROUND VERTICAL CIRCULATION OPENINGS, COORDINATE WITH VERTICAL CIRCULATION MANUFACTURER REQUIREMENTS.
- 7. TOP OF STEEL IS 38' 1 1/2" CCD TYPICAL UNO.
- 8. Tx INDICATES STEEL TRUSS. SEE 1 / S-835 FOR SIZE AND INFORMATION.
- 9. SEE S-833 & S-834 FOR MOMENT FRAME ELEVATIONS.
- 10. FOR TOP OF FINISHED FLOOR ELEVATIONS AND INFORMATION REGARDING FLOOR PENETRATIONS FOR STAIRS, ESCALATORS, AND ELEVATORS, SEE ARCH DWGS.
- 11. SEE MEP DRAWINGS FOR LOCATIONS OF FLOOR PENETRATIONS, SEE 5 / S-1115.

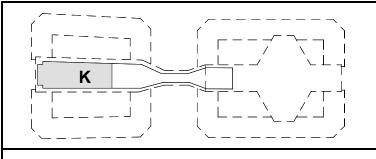

**KEY PLAN: SECOND FLOOR LEVEL** 





**SENSITIVE SECURITY INFORMATION** 

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95th Terminal Improvement


15 West 95th Street (South Terminal) Chicago, IL 60628

IN CH	ARGE	J. JAKALSKI
APPRO	OVED BY	J. JAKALSKI
CHEC	KED BY	R.S. NAIR
DESIG	ENED BY	G. FORKAN
DRAW	/N BY	M. DONAHUE
PROJI	ECT NO.	2012-0021.02
FILE NAME		DR095_S-Terminal
	2/9/17	ISSUED FOR CONSTRUCTION
		ISSUED FOR CONSTRUCTION
MARK	DATE	DESCRIPTION
LOCA	ATION IDE	ENTIFIER: <b>DR095</b>

SOUTH TERMINAL SECOND

FLOOR FRAMING PLAN - AREA K




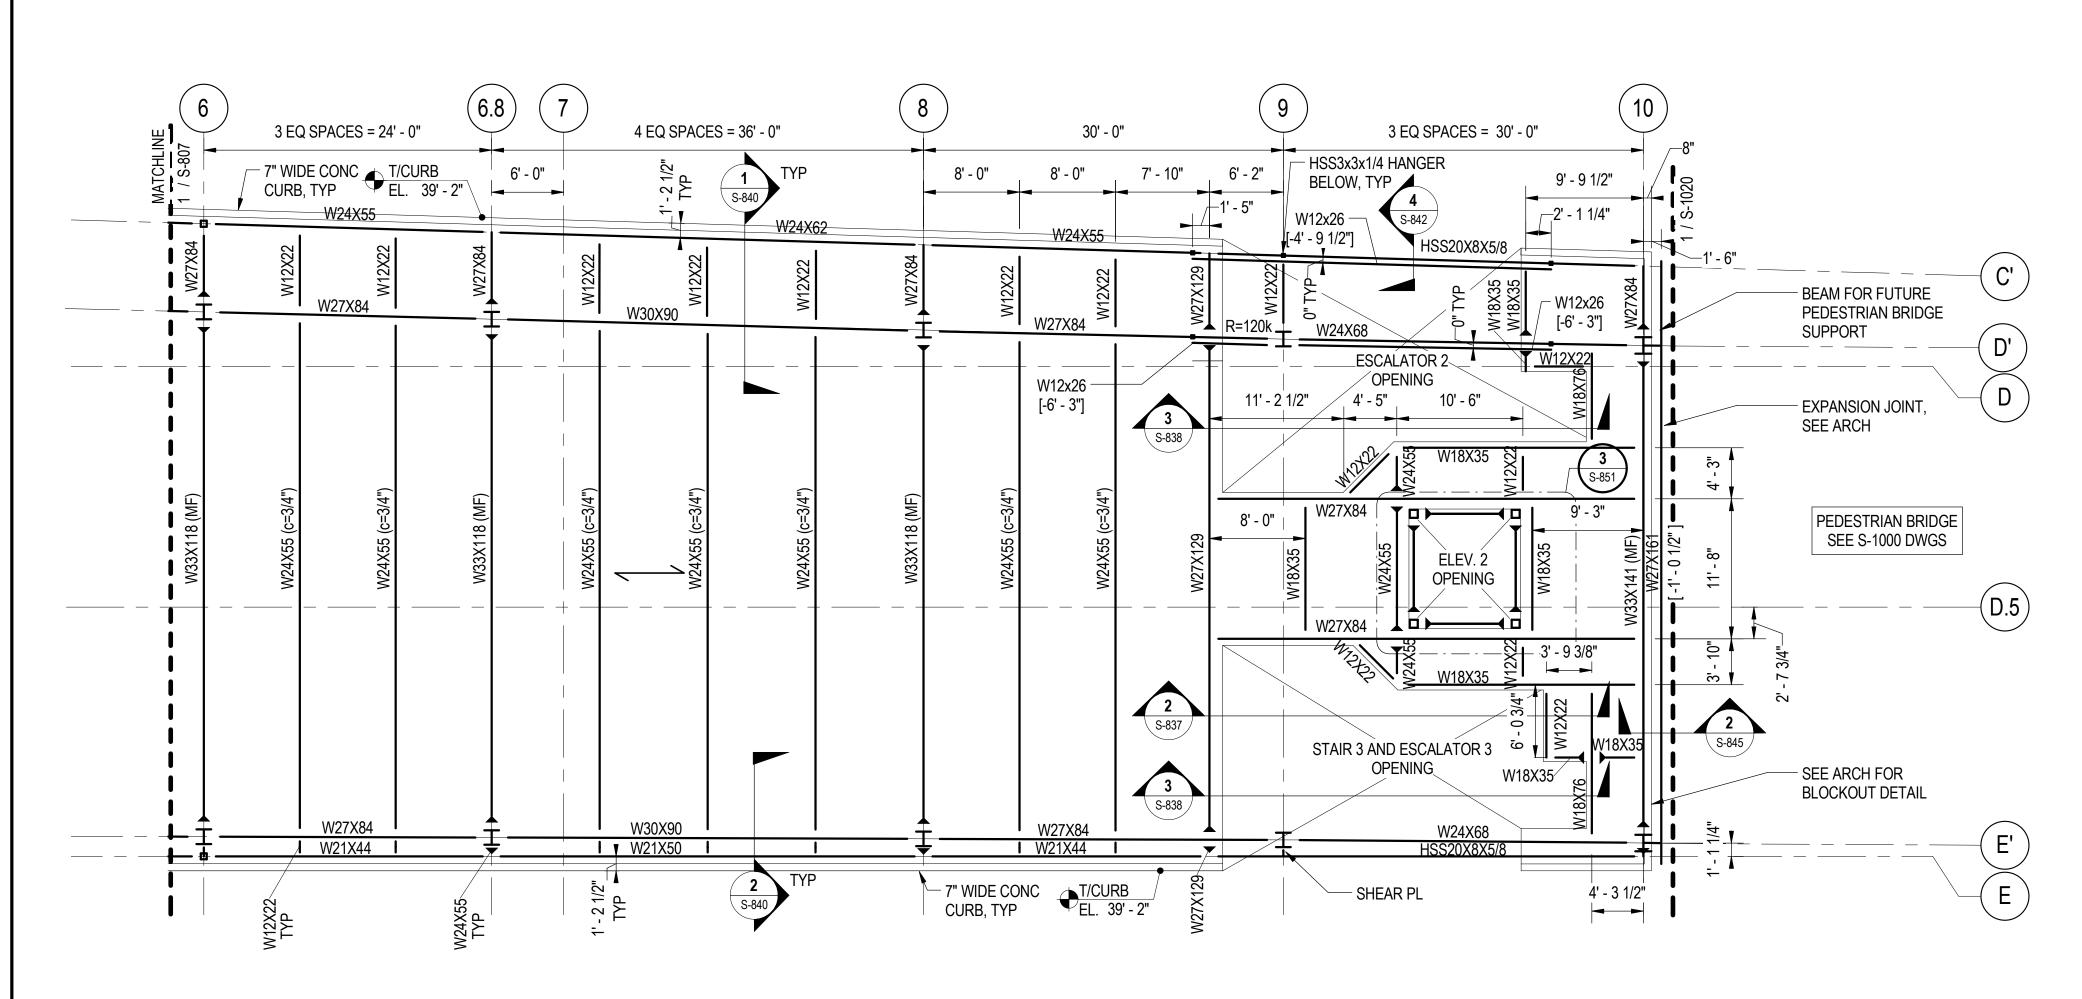

SOUTH TERMINAL LEVEL 2 FRAMING PLAN - AREA L




### STEEL BEAM LEGEND

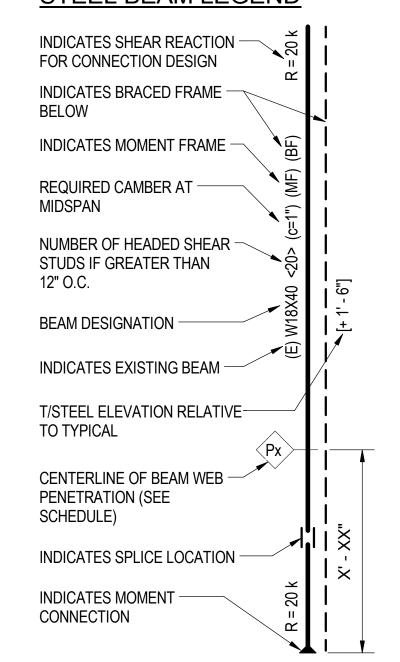

**SHEET NOTES:** 

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- 2. FOR TYPICAL DETAILS REFER TO S-1112 TO S-1120.
- 3. TYPICAL FLOOR CONSTRUCTION: 3" 18 GAGE GALVANIZED COMPOSITE STEEL DECK W/ 3-1/2" MIN. LWC TOPPING (TOTAL THICKNESS = 6 1/2" MIN. REINF. W/ 6X6 W2.6XW2.6 WWF. FASTEN DECK AT STEEL SUPPORTS w/ 3/4" PUDDLE WELDS AT 12" O.C. & PROVIDE 2 WELDED SIDELAPS.
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- 7. TOP OF STEEL IS 38' 1 1/2" CCD TYPICAL UNO.
- 8. SEE S-833 & S-834 FOR MOMENT FRAME ELEVATIONS.
- 9. FOR INFORMATION REGARDING FLOOR PENETRATIONS FOR STAIRS, ESCALATORS, AND ELEVATORS, SEE ARCH DWGS.
- 10. SEE MEP DRAWINGS FOR LOCATIONS OF FLOOR PENETRATIONS, SEE5 / S-1115.

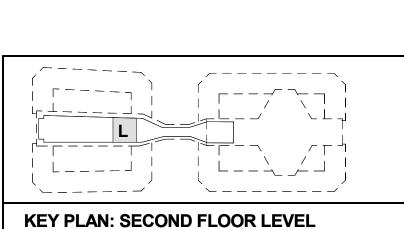

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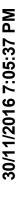
95th Terminal Improvement

15 West 95th Street (South Terminal) Chicago, IL 60628


IN CHA	RGE	J. JAKALSKI
APPRO	VED BY	J. JAKALSKI
CHECK	ED BY	R.S. NAIR
DESIG	NED BY	G. FORKAN
DRAW	N BY	C. BOVE
PROJE	CT NO.	2012-0021.02
FILE N	AME	DR095_S-Terminal
	2/9/17	ISSUED FOR CONSTRUCTION
		+

LOCATION IDENTIFIER: **DR095** 

SOUTH TERMINAL SECOND FLOOR FRAMING PLAN - AREA L





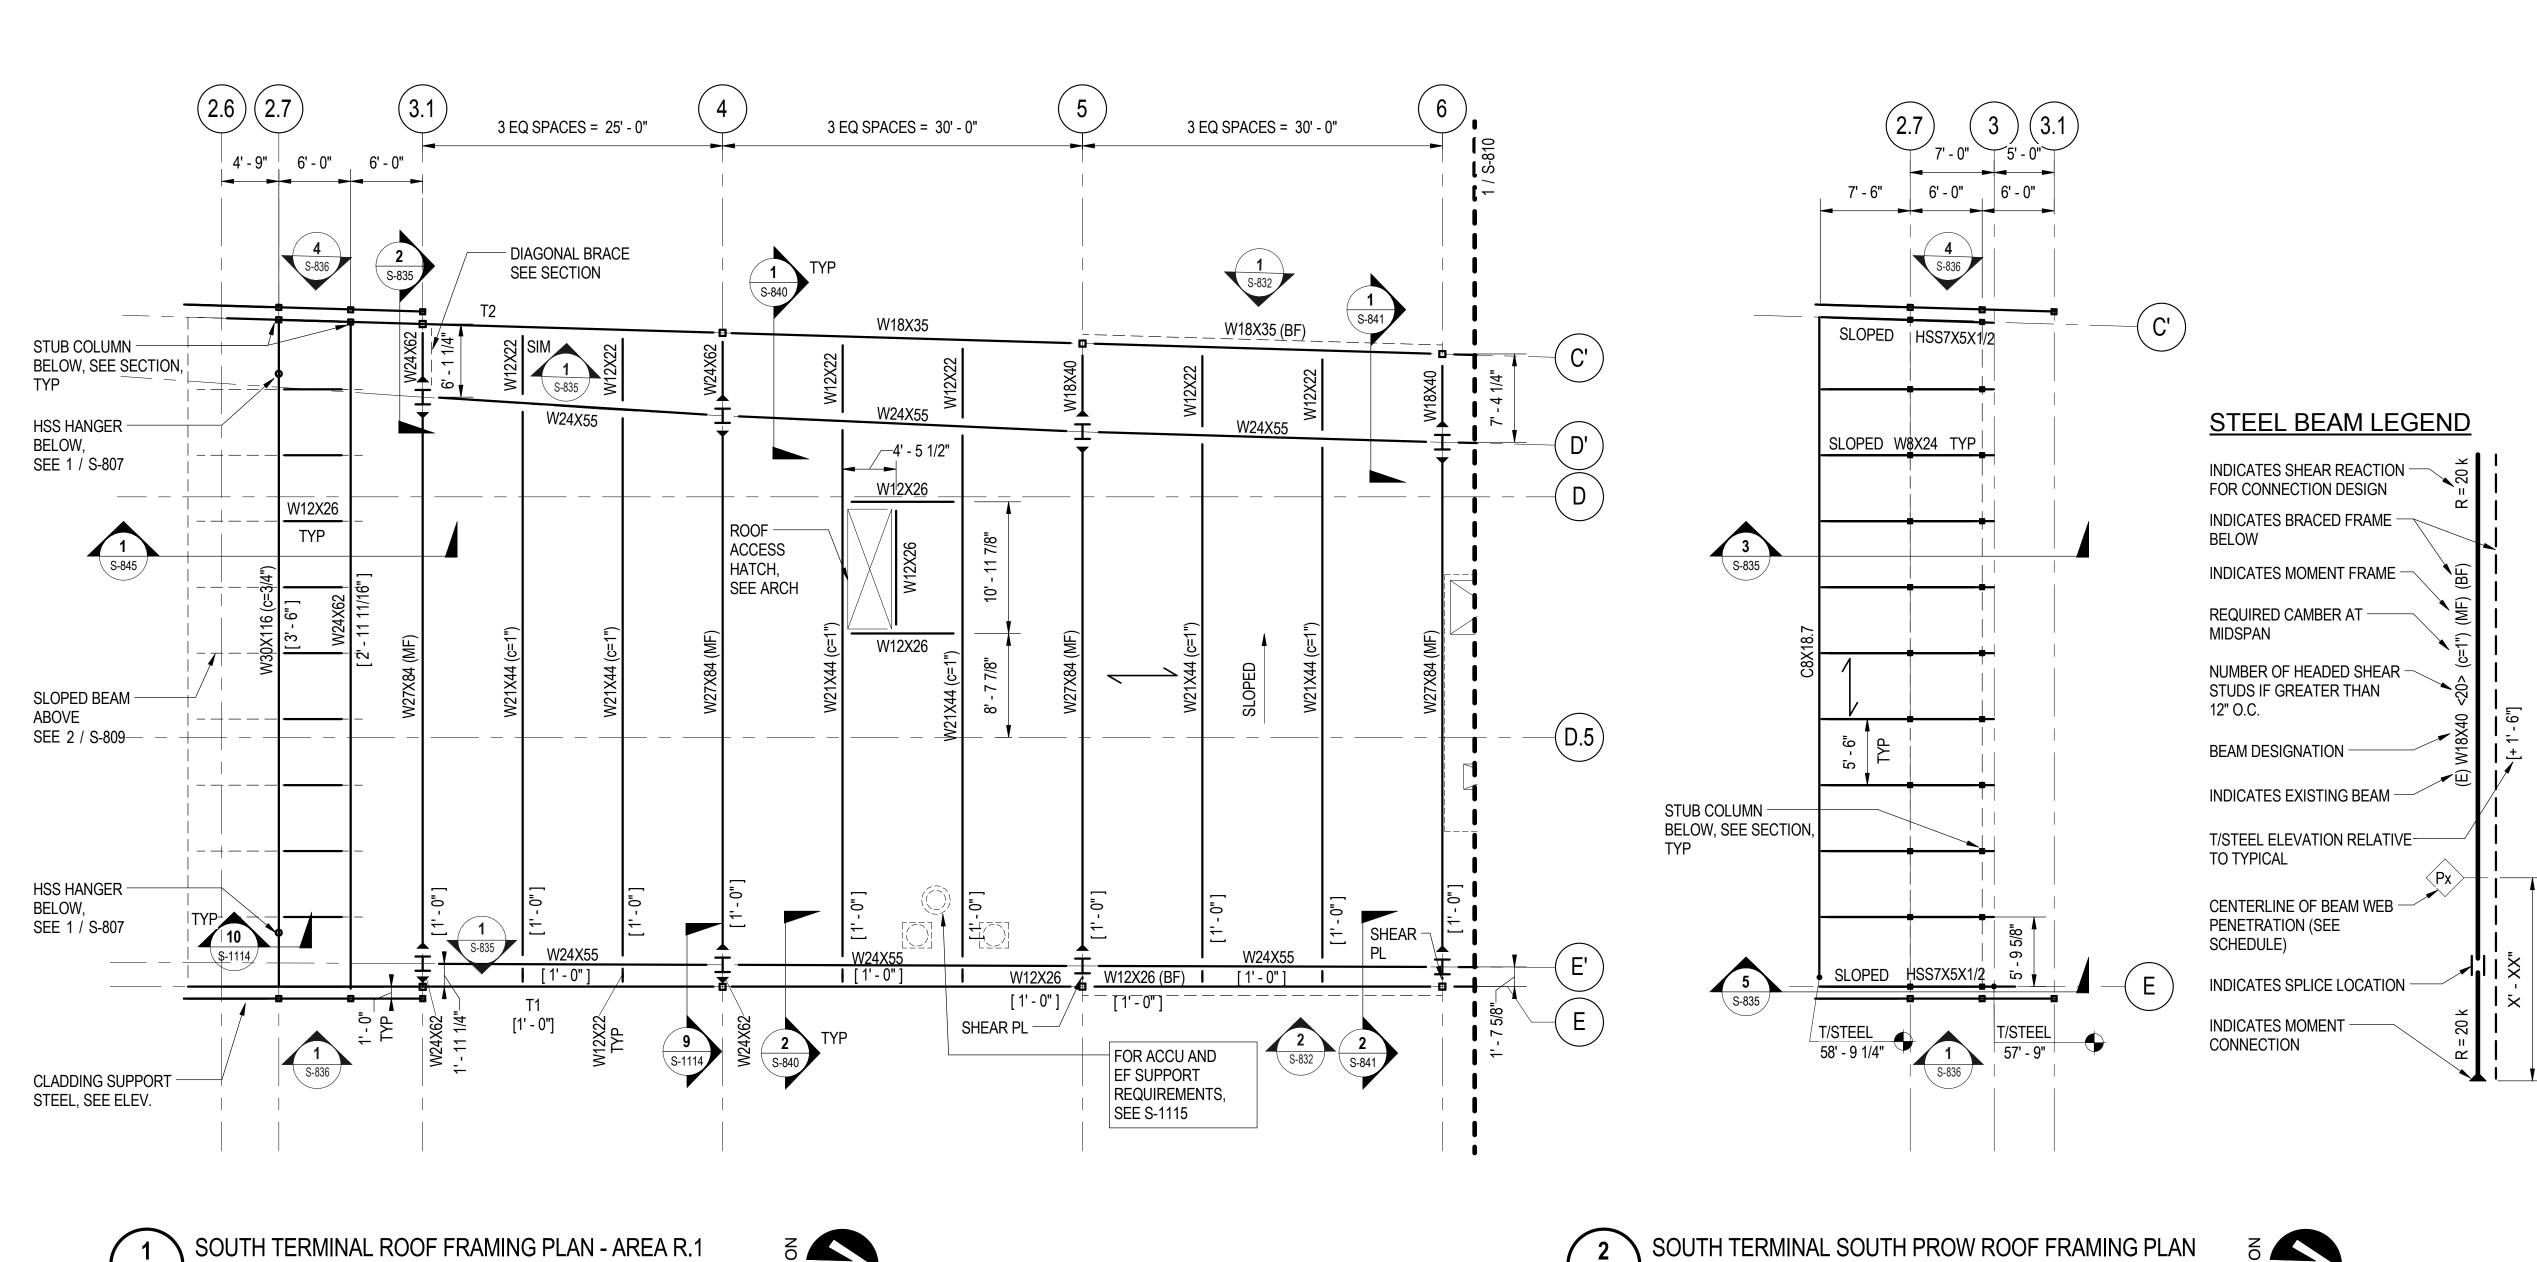

SCALE: 1/8" = 1'-0"








### SHEET NOTES:

- 1. FOR GENERAL NOTES, SEE DWGS S-001 TO S-004.
- 2. FOR TYPICAL DETAILS REFER TO S-1112 TO S-1120.
- 3. TYPICAL ROOF CONSTRUCTION: 3" 18 GAGE GALVANIZED STEEL ROOF DECK. FASTEN AT STEEL SUPPORTS w/ 5/8" PUDDLE WELDS AT 8" O.C. & PROVIDE (3) #10 SCREW SIDELAP FASTENERS.
- 4. FOR EXACT LOCATION OF ALL STEEL AROUND VERTICAL CIRCULATION OPENINGS, COORDINATE WITH VERTICAL CIRCULATION MANUFACTURER REQUIREMENTS.
- 5. TOP OF STEEL IS 54' 0" CCD TYPICAL UNO.
- 6. Tx INDICATES STEEL TRUSS. SEE1 / S-835 FOR SIZE AND INFORMATION.
- 7. SEE S-833 & S-834 FOR MOMENT FRAME ELEVATIONS.
- 8. FOR INFORMATION REGARDING ROOF PENETRATIONS FOR STAIRS, ESCALATORS, AND ELEVATORS, SEE ARCH DWGS.
- 9. SEE MEP DRAWINGS FOR LOCATIONS OF ROOF PENETRATIONS, SEE . 2 / S-1115

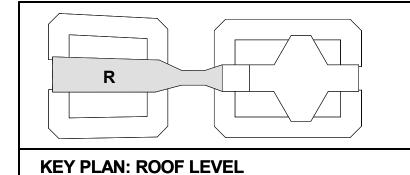







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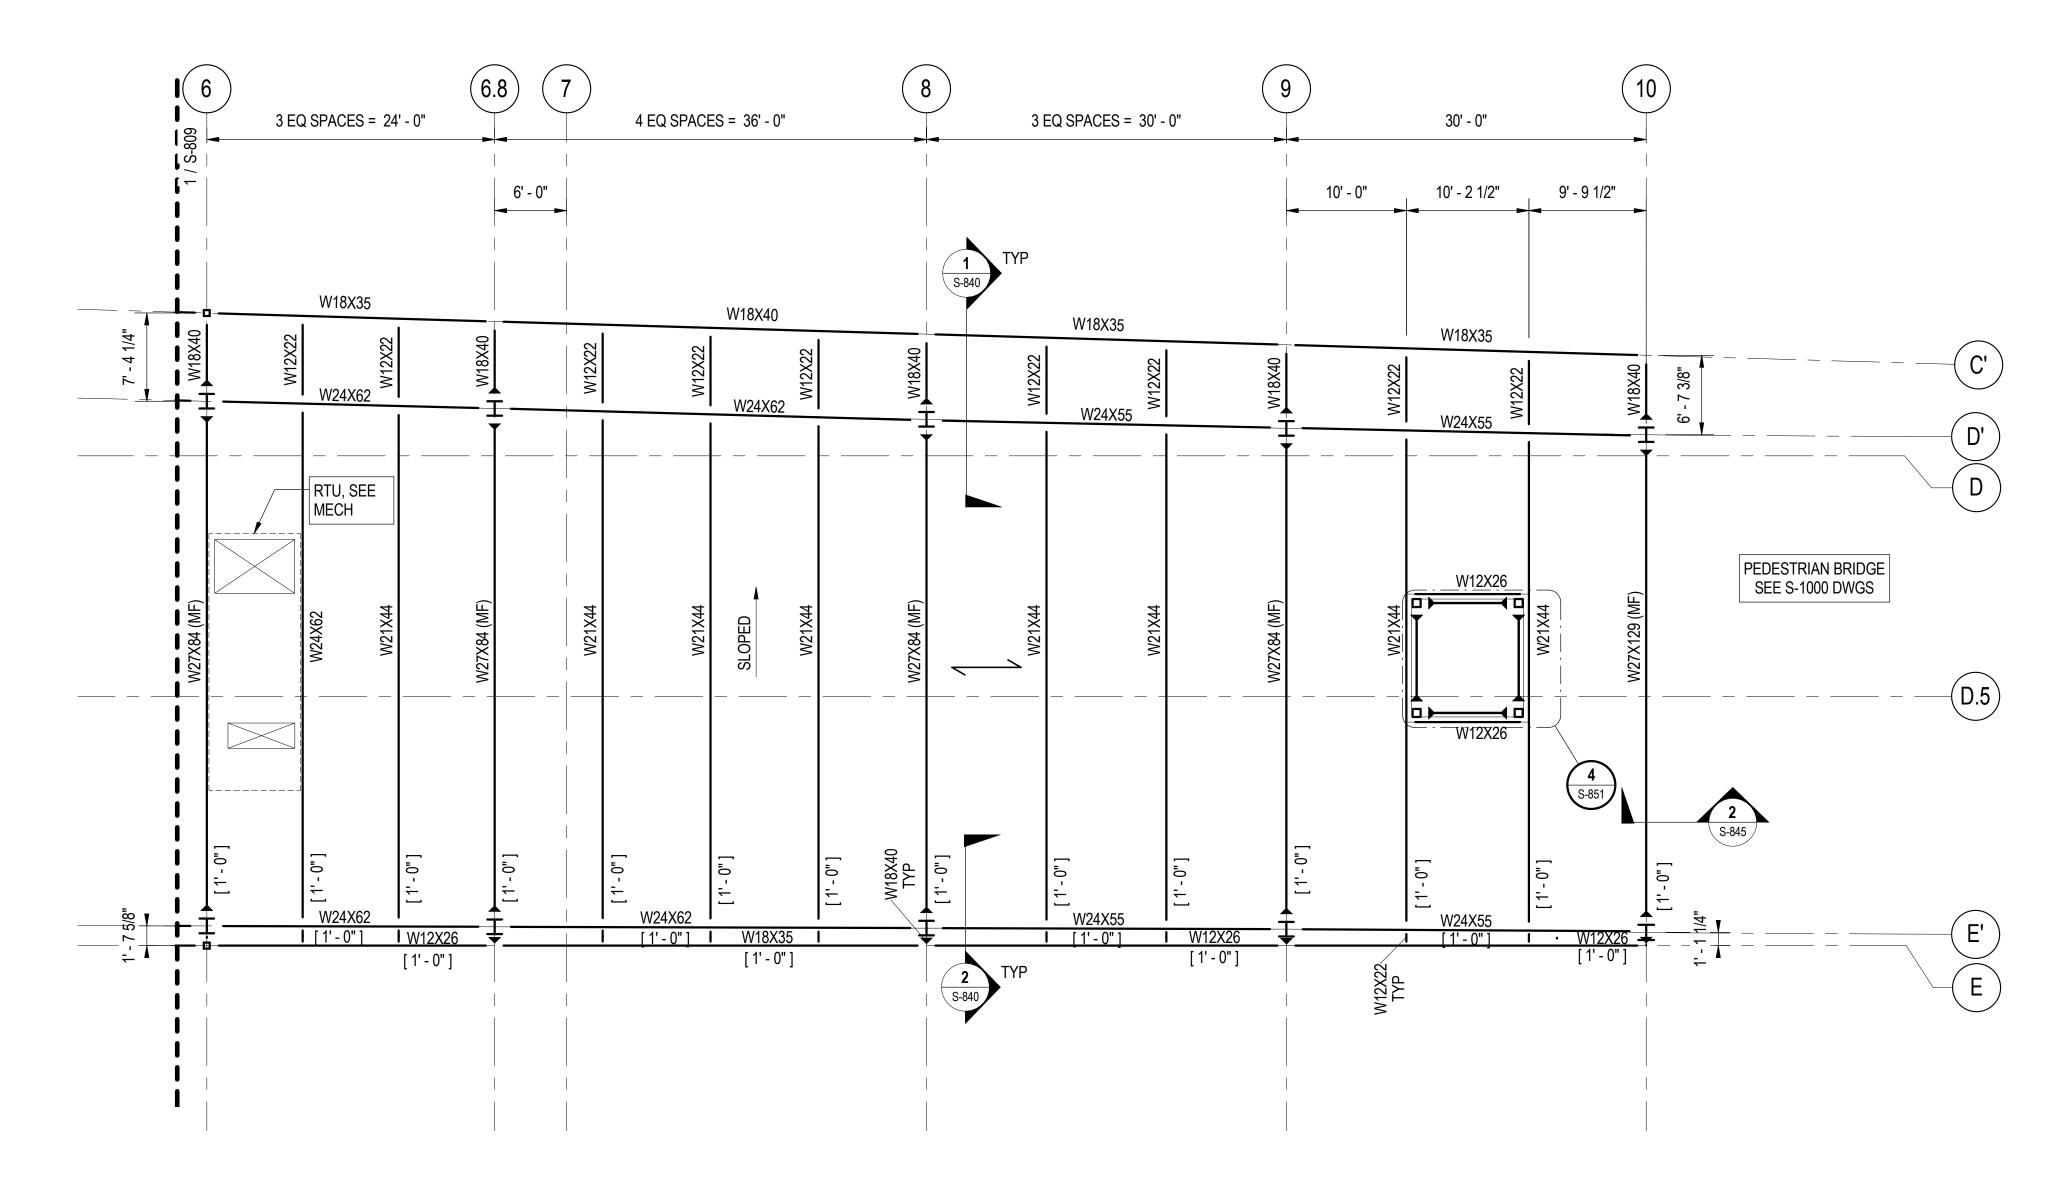
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95th Terminal Improvement

15 West 95th Street (South Terminal) Chicago, IL 60628

IN CH	ARGE	J. JAKALSKI
APPR	OVED BY	J. JAKALSKI
CHEC	KED BY	R.S. NAIR
DESIG	ENED BY	G. FORKAN
DRAW	/N BY	M. DONAHUE
PROJ	ECT NO.	2012-0021.02
FILE	NAME	DR095_S-Terminal
	2/9/17	ISSUED FOR CONSTRUCTION
MARK	DATE	DESCRIPTION
LOC	ATION IDE	ENTIFIER: <b>DR095</b>

**SOUTH TERMINAL ROOF** FRAMING PLAN - AREA R.1



SOUTH TERMINAL ROOF FRAMING PLAN - AREA R.2


SCALE: 1/8" = 1'-0"



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- 3. TYPICAL ROOF CONSTRUCTION: 3" 18 GAGE GALVANIZED STEEL ROOF DECK. FASTEN AT STEEL SUPPORTS w/ 5/8" PUDDLE WELDS AT 8" O.C. & PROVIDE (3) #10 SCREW SIDELAP FASTENERS.
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- 6. SEE S-833 & S-834 FOR MOMENT FRAME ELEVATIONS.
- 7. FOR INFORMATION REGARDING ROOF PENETRATIONS FOR STAIRS, ESCALATORS, AND ELEVATORS, SEE ARCH DWGS.
- 8. SEE MEP DRAWINGS FOR LOCATIONS OF ROOF PENETRATIONS, SEE 2 / S-1115.





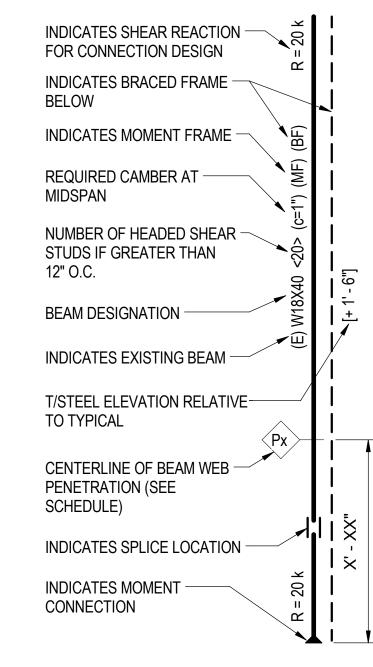





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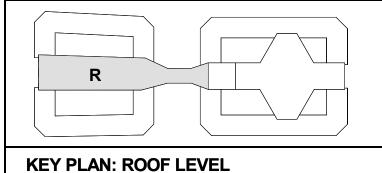
95th Terminal Improvement


15 West 95th Street (South Terminal) Chicago, IL 60628

IN CHARGE  APPROVED BY  J. JAKALSKI  CHECKED BY  R.S. NAIR  DESIGNED BY  G. FORKAN  DRAWN BY  M. DONAHUE  PROJECT NO. 2012-0021.02  FILE NAME  DR095_S-Terminal  2/9/17 ISSUED FOR CONSTRUCTION  MARK  DATE  DR095  L OCATION IDENTIFIER:  DR095			
CHECKED BY DESIGNED BY G. FORKAN DRAWN BY M. DONAHUE PROJECT NO. 2012-0021.02 FILE NAME DR095_S-Terminal	IN CH	ARGE	J. JAKALSKI
DESIGNED BY G. FORKAN DRAWN BY M. DONAHUE PROJECT NO. 2012-0021.02 FILE NAME DR095_S-Terminal  2/9/17 ISSUED FOR CONSTRUCTION MARK DATE DESCRIPTION	APPR	OVED BY	J. JAKALSKI
DRAWN BY M. DONAHUE PROJECT NO. 2012-0021.02 FILE NAME DR095_S-Terminal  2/9/17 ISSUED FOR CONSTRUCTION MARK DATE DESCRIPTION	CHEC	KED BY	R.S. NAIR
PROJECT NO. 2012-0021.02  FILE NAME DR095_S-Terminal  2/9/17 ISSUED FOR CONSTRUCTION  MARK DATE DESCRIPTION	DESIC	ENED BY	G. FORKAN
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2/9/17 ISSUED FOR CONSTRUCTION MARK DATE DESCRIPTION	PROJ	ECT NO.	2012-0021.02
MARK DATE DESCRIPTION	FILE N	VAME	DR095_S-Terminal
MARK DATE DESCRIPTION			
		2/9/17	ISSUED FOR CONSTRUCTION
LOCATION IDENTIFIER DR095	MARK	DATE	DESCRIPTION
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LOCATION IDENTIFIER: DR095

SOUTH TERMINAL ROOF FRAMING PLAN - AREA R.2





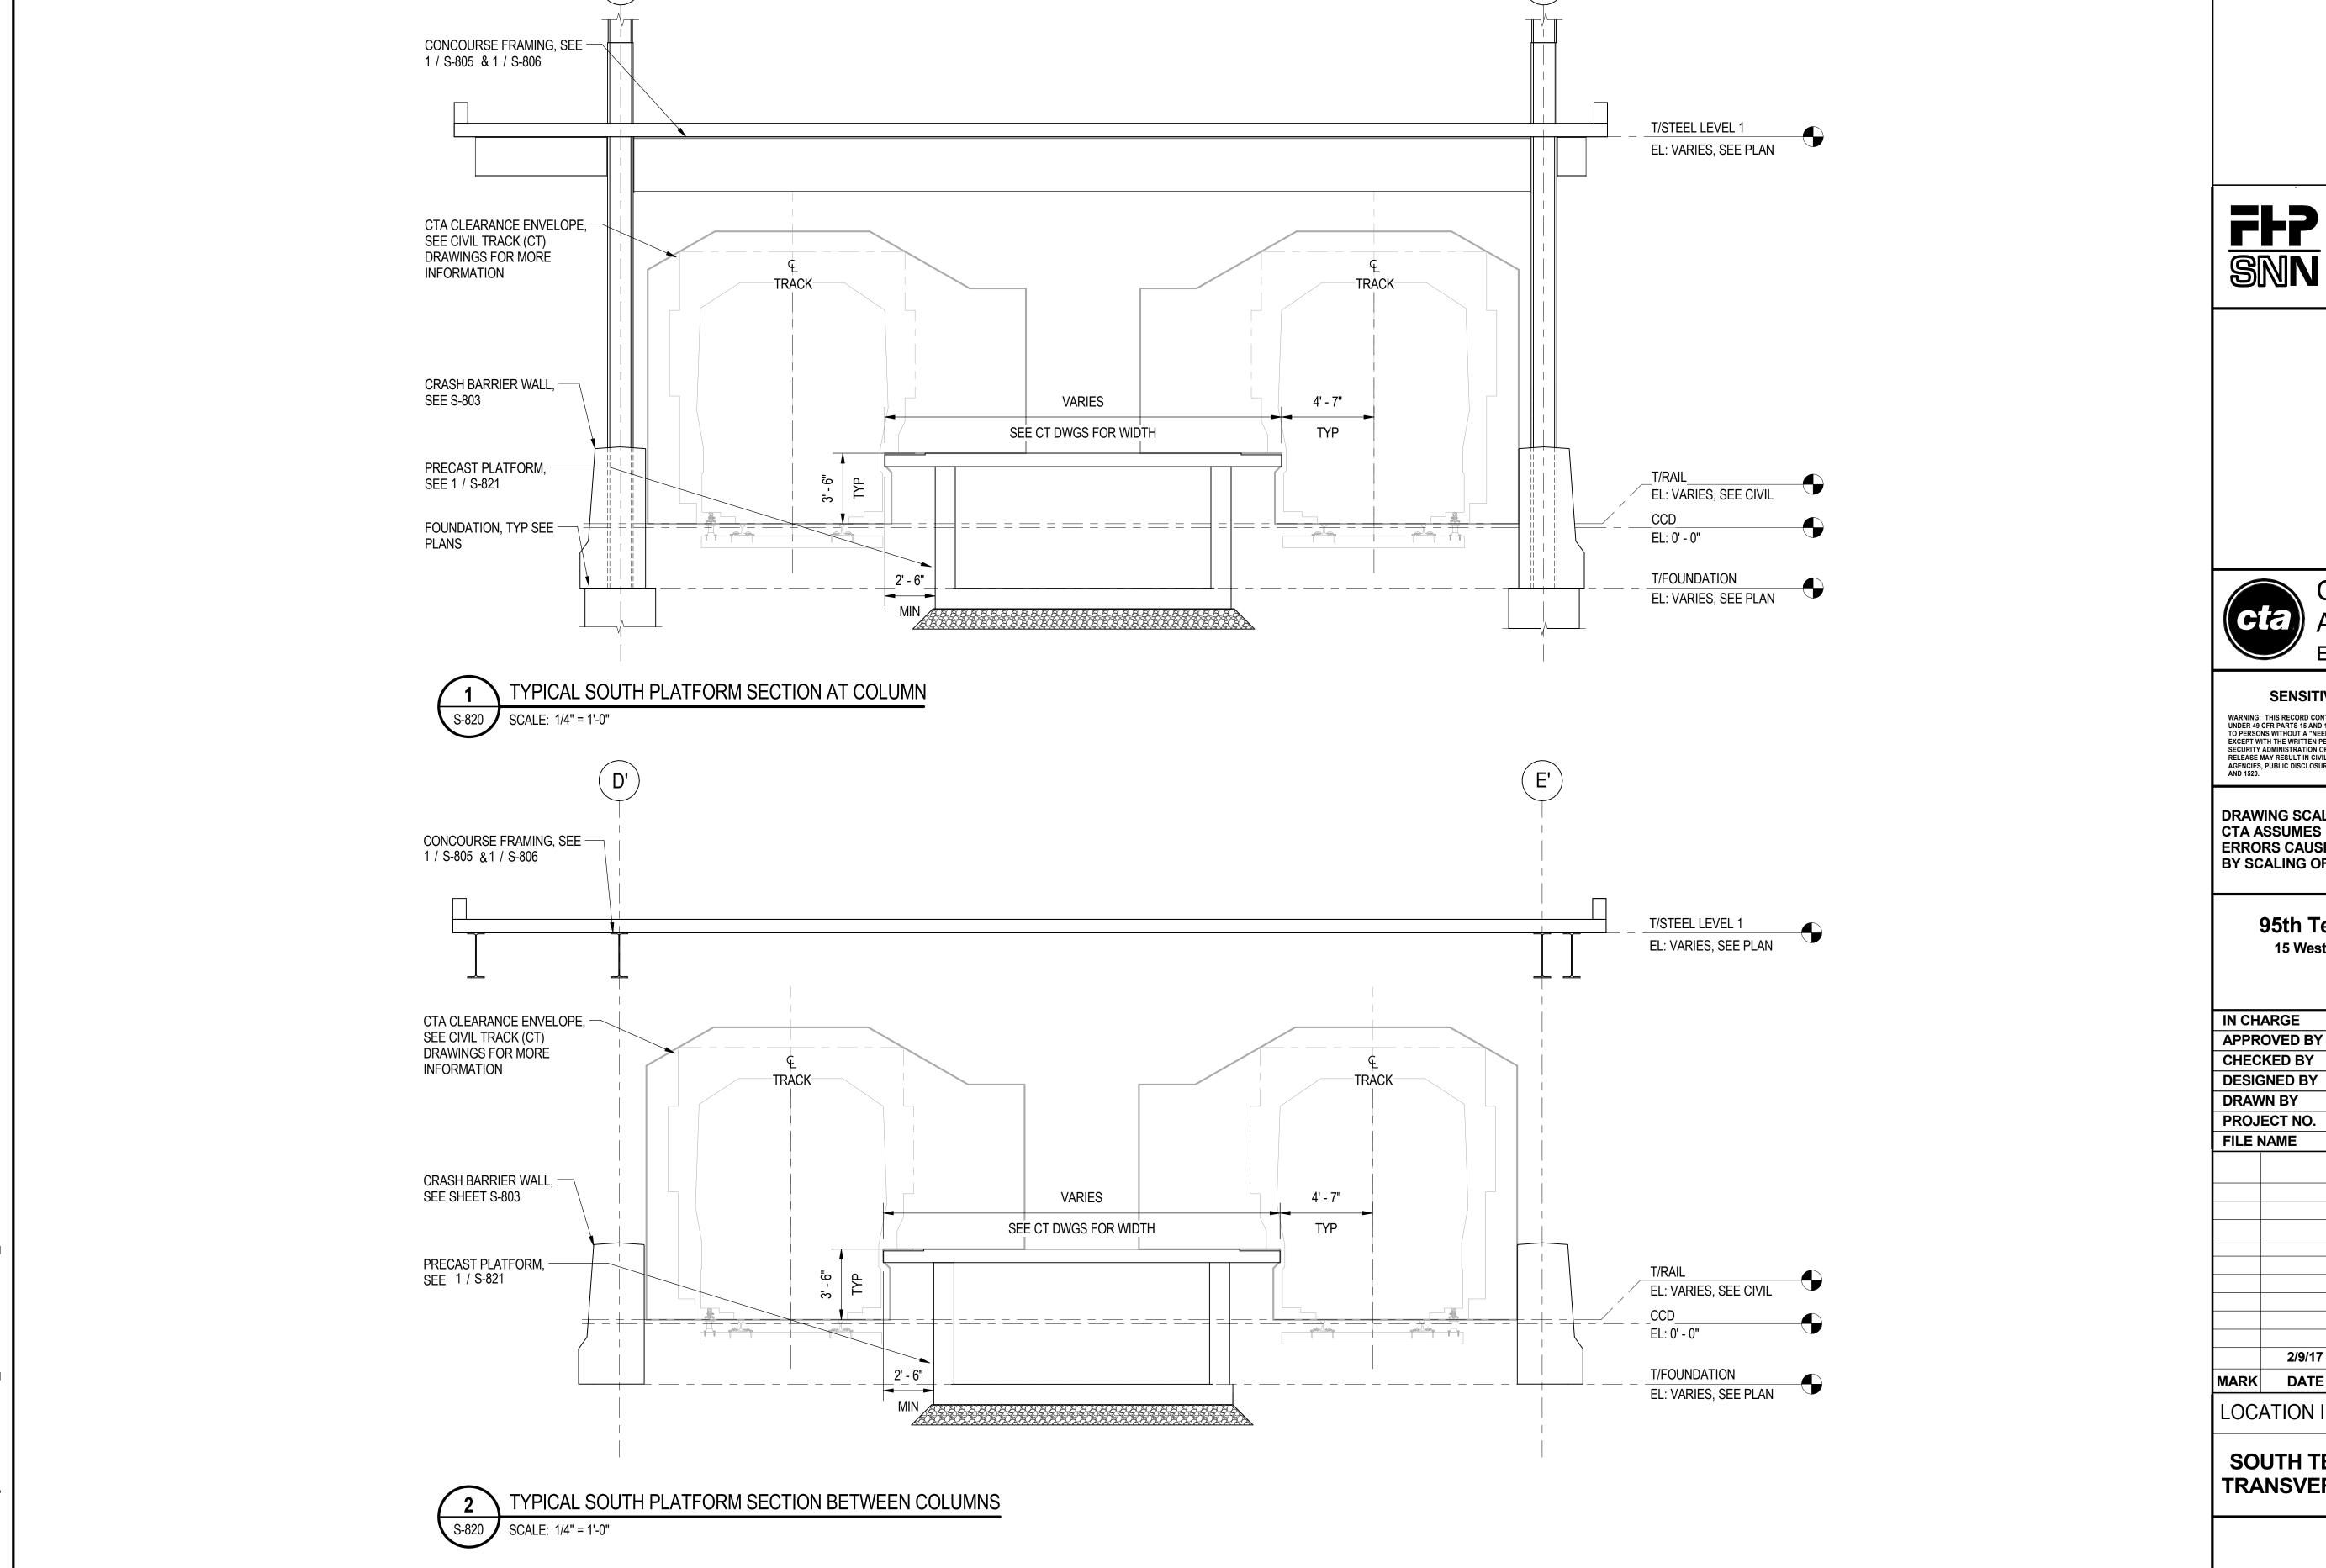

WARNING: THIS RECORD CONTAINS SENSITIVE SECURITY INFORMATION THAT IS CONTROLLED UNDER 49 CFR PARTS 15 AND 1520. NO PART OF THIS RECORD MAY BE DISCLOSED TO PERSONS WITHOUT A "NEED TO KNOW" AS DEFINED IN CFR PARTS 15 AND 1520, EXCEPT WITH THE WRITTEN PERMISSION OF THE ADMINISTRATOR OF THE TRANSPORTATION SECURITY ADMINISTRATION OR THE SECRETARY OF TRANSPORTATION. UNAUTHORIZED RELEASE MAY RESULT IN CIVIL PENALTY OR OTHER ACTION. FOR U.S. GOVERNMENT AGENCIES, PUBLIC DISCLOSURE IS GOVERNED BY 5 U.S.C. 552 AND 49 CFR PARTS 15 AND 1520.


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## 95th Terminal Improvement

15 West 95th Street (South Terminal) Chicago, IL 60628

IN CH	ARGE	J. JAKALSKI
APPR	OVED BY	J. JAKALSKI
CHEC	KED BY	R.S. NAIR
DESIG	NED BY	G. FORKAN
DRAW	N BY	J. PEARSON
PROJI	ECT NO.	2012-0021.02
FILE N	IAME	DR095_S-Terminal
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SOUTH TERMINAL FOUNDATION TRANSVERSE BUILDING SECTION



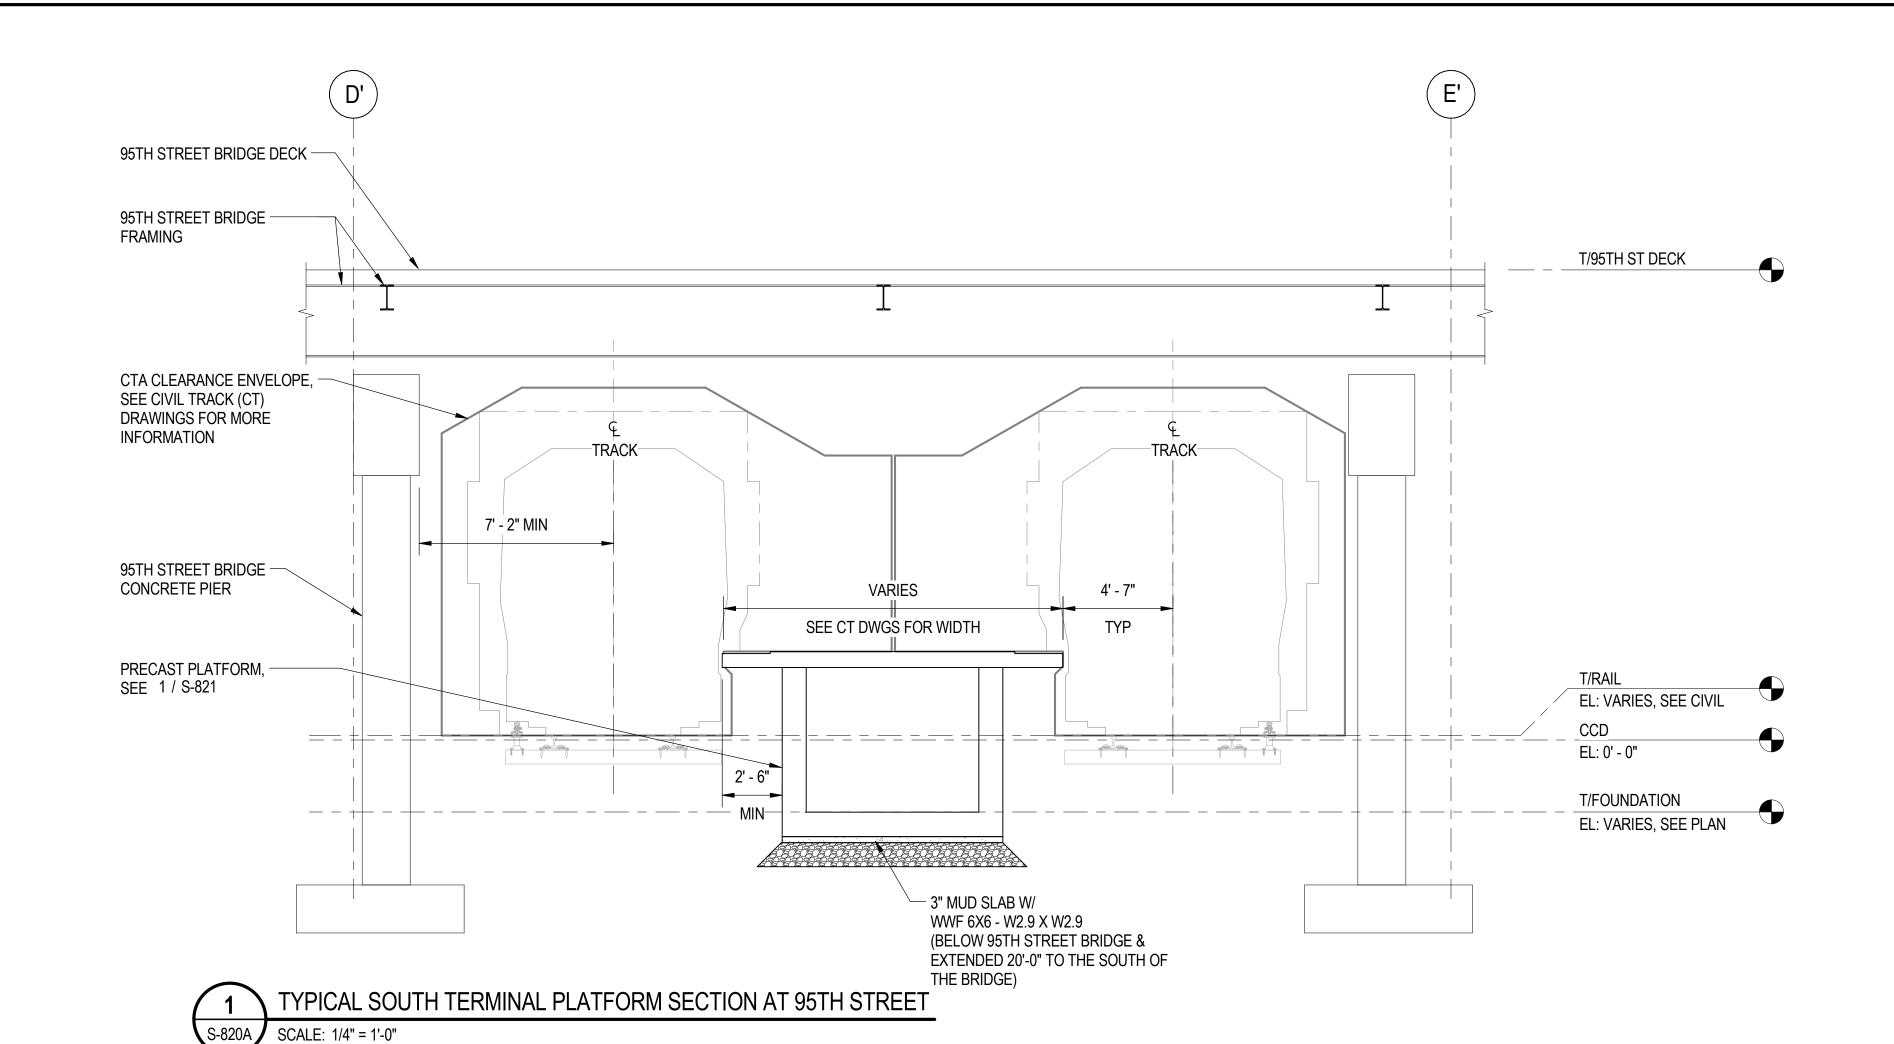

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## 95th Terminal Improvement 15 West 95th Street (South Terminal)


15 West 95th Street (South Terminal) Chicago, IL 60628

<b>IN CHARG</b>	E	J. JAKALSKI
APPROVE	D BY	J. JAKALSKI
CHECKED	BY	R.S. NAIR
DESIGNED	BY	G. FORKAN
DRAWN B	Y	J. PEARSON
PROJECT	NO.	2012-0021.02
FILE NAME		DR095_S-Terminal
2	2/9/17	ISSUED FOR CONSTRUCTION
<del></del>	DATE	DESCRIPTION

LOCATION IDENTIFIER: DR095

SOUTH TERMINAL FOUNDATION TRANSVERSE BUILDING SECTION AT 95TH STREET

S-820A

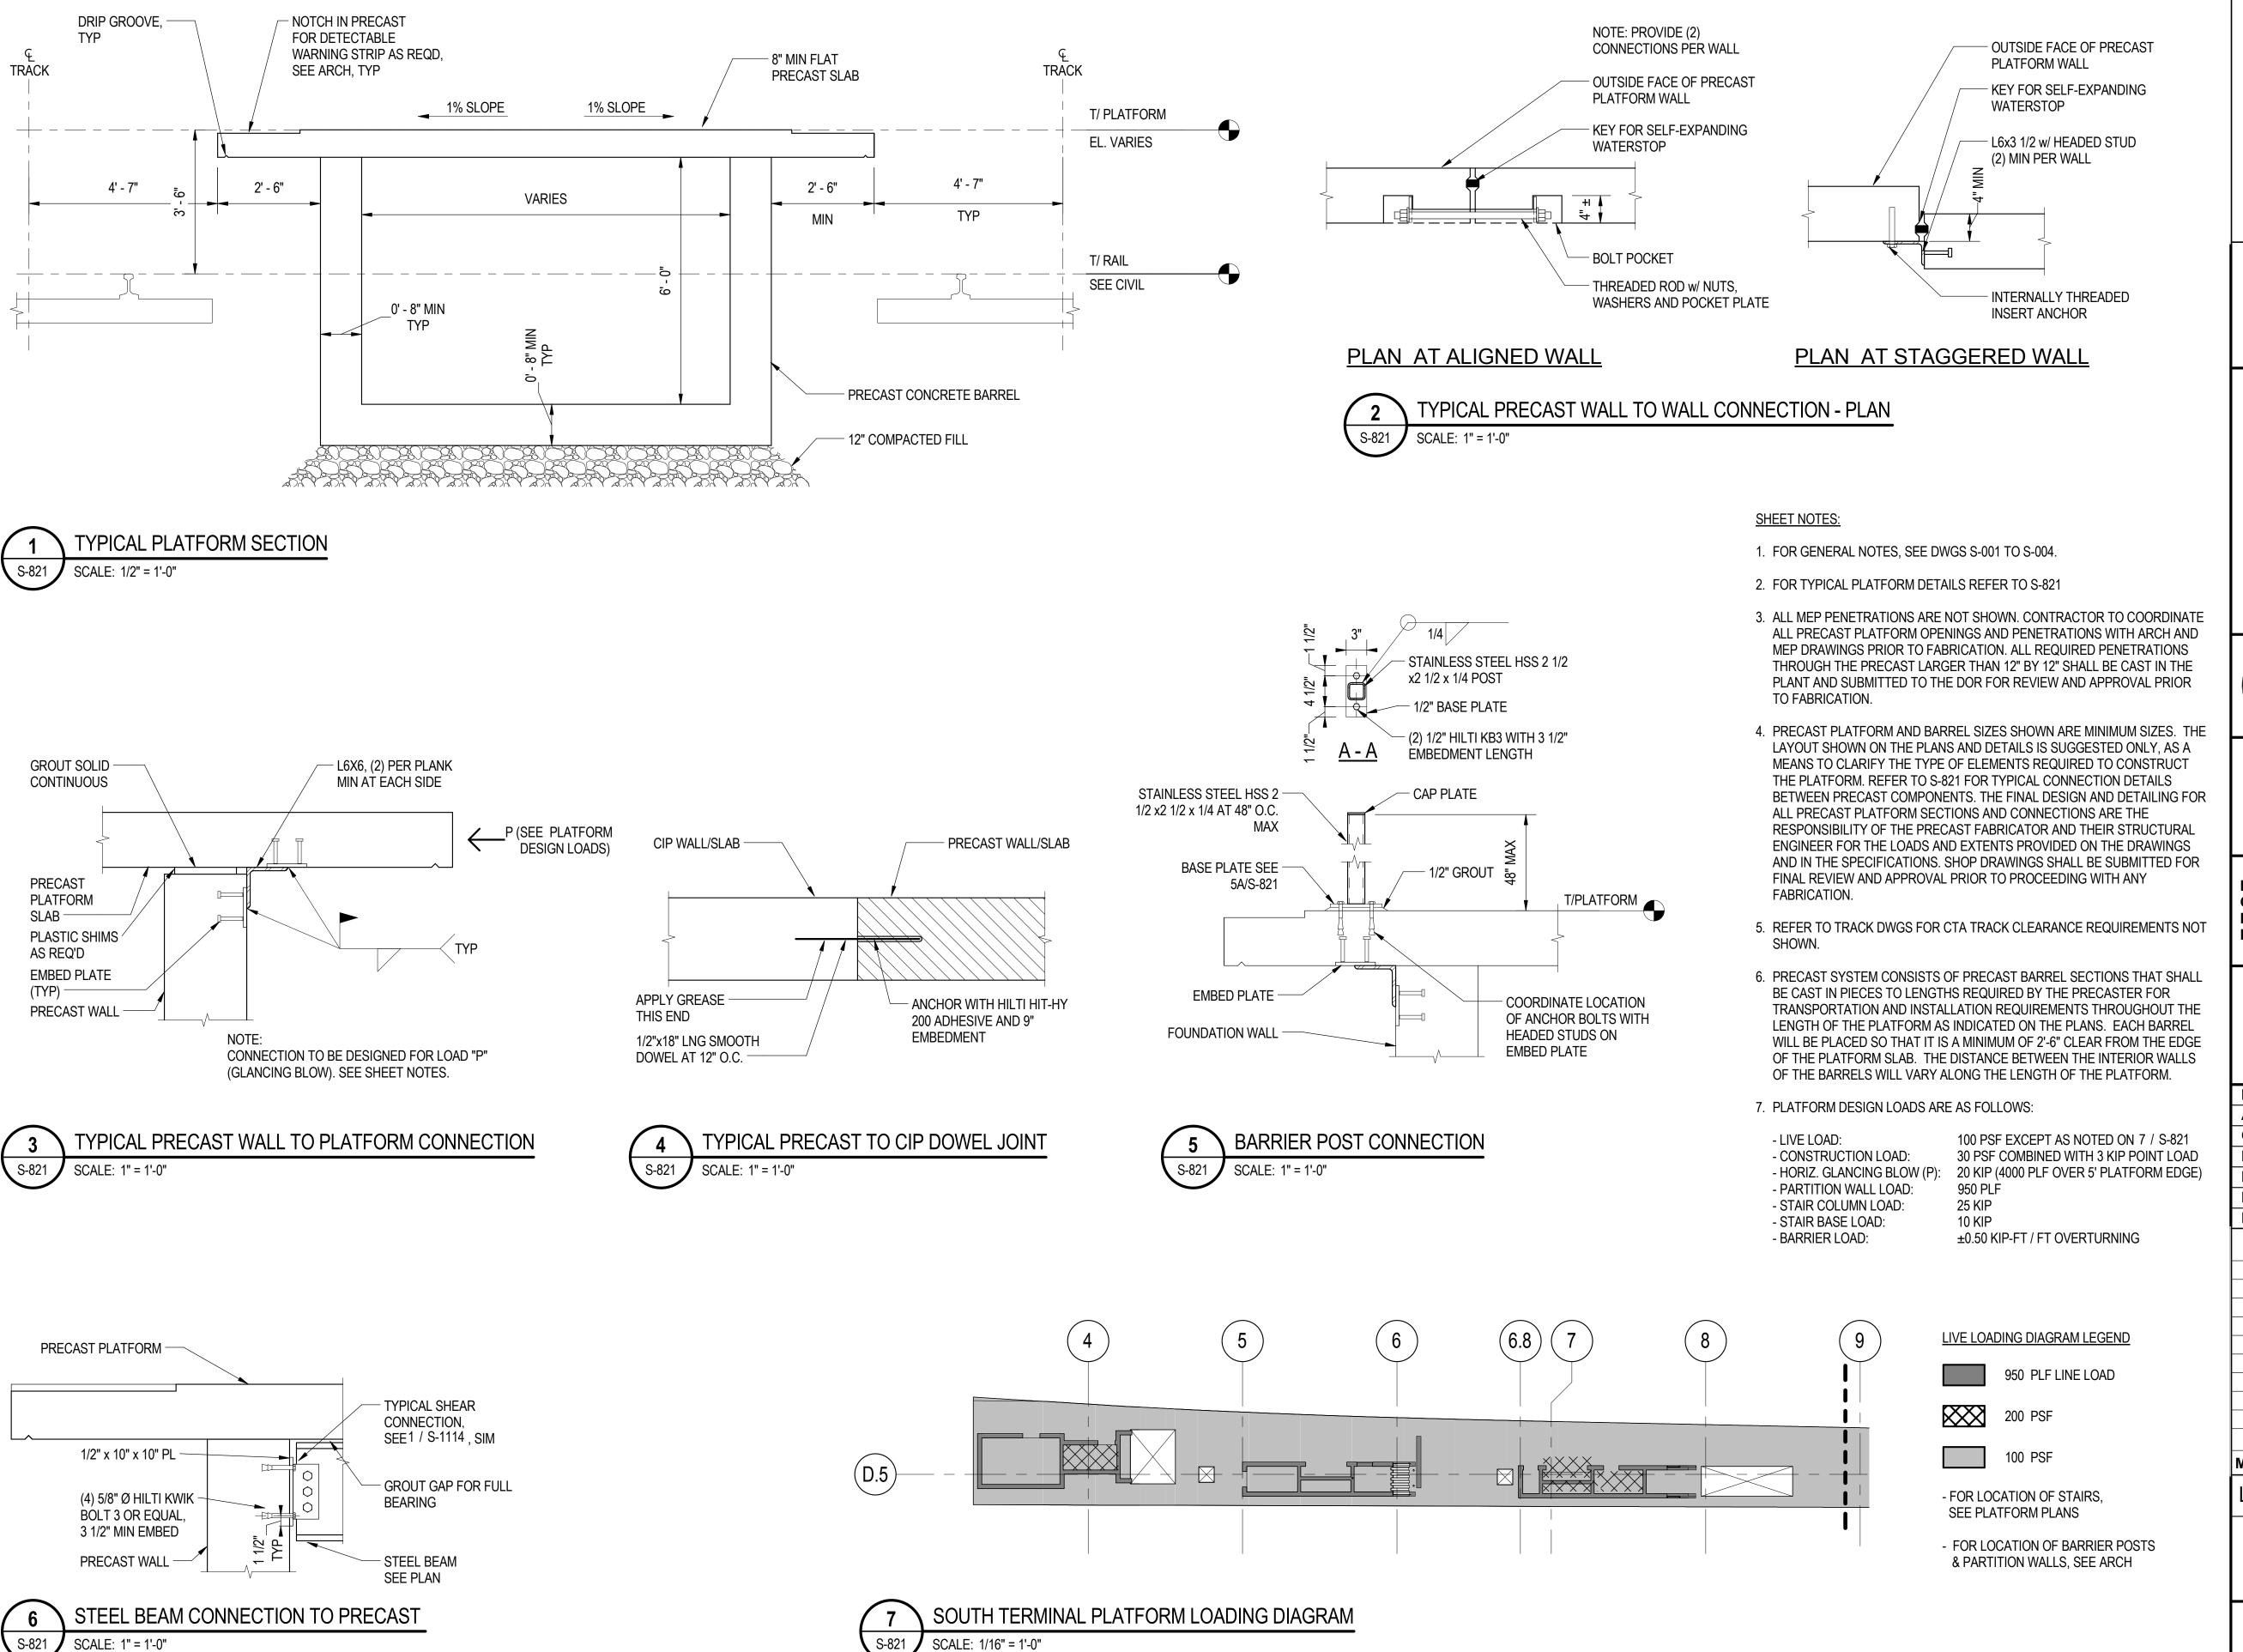

FP M \*exp



#### SENSITIVE SECURITY INFORMATION

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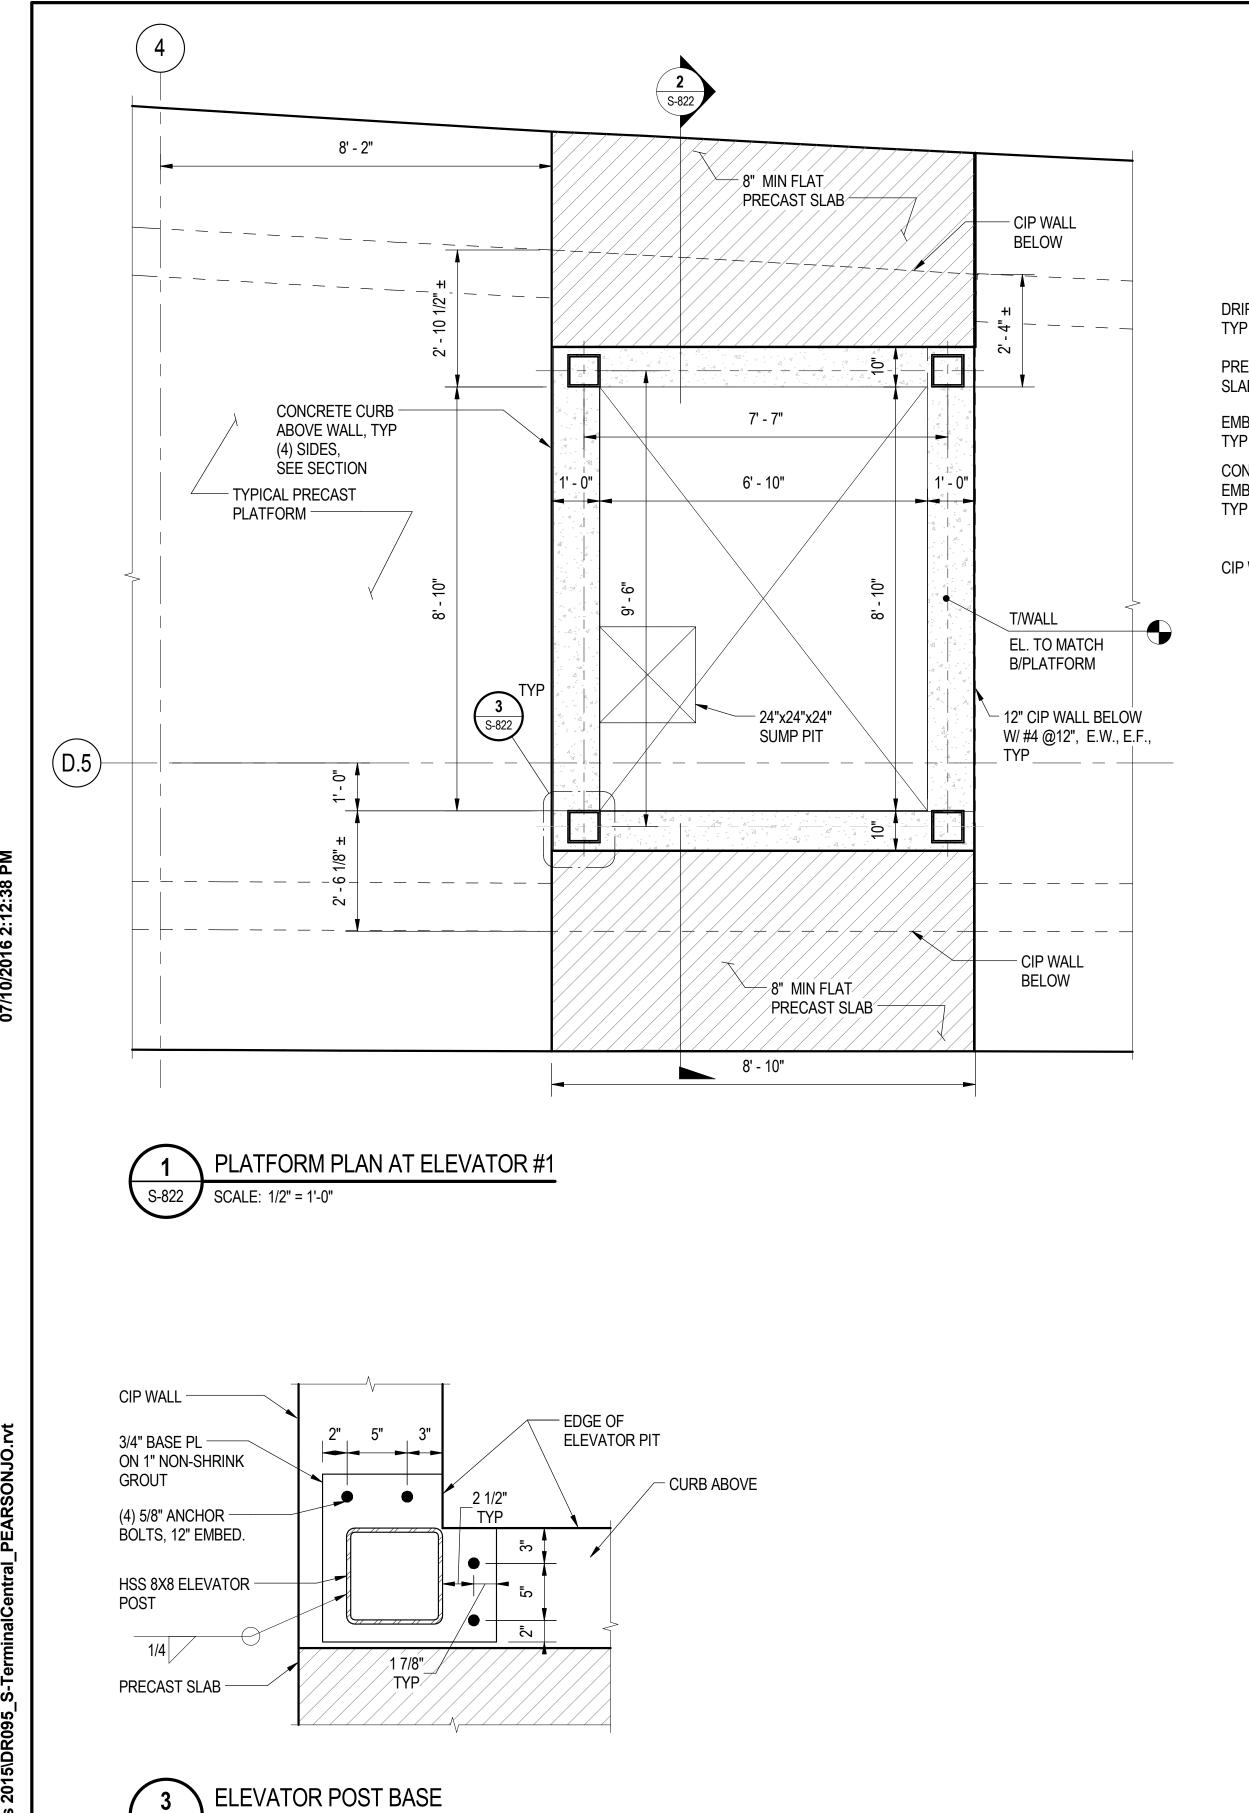
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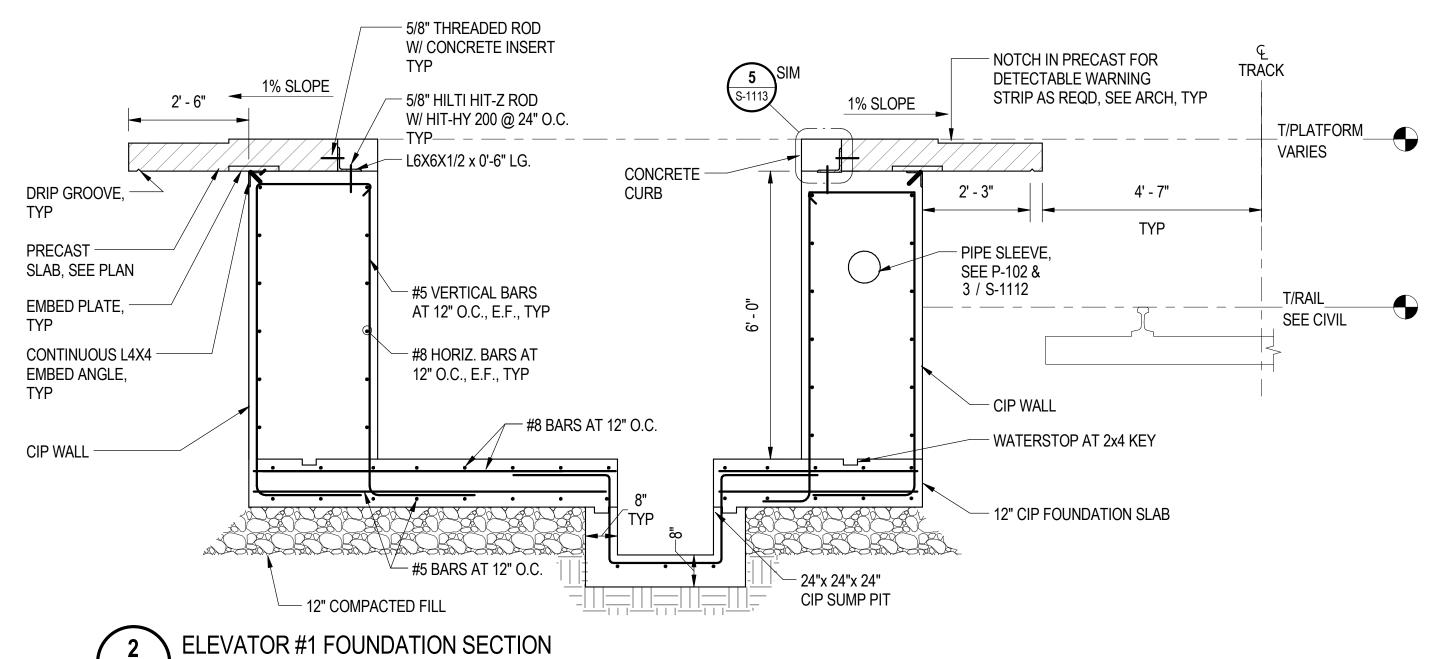
## 95th Terminal Improvement

15 West 95th Street (South Terminal) Chicago, IL 60628

IN CH	ARGE	J. JAKALSKI
APPR	OVED BY	J. JAKALSKI
CHECKED BY DESIGNED BY		R.S. NAIR
		G. FORKAN
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SOUTH TERMINAL TYPICAL PLATFORM SECTIONS & DETAILS





SCALE: 1/2" = 1'-0"

CHICAGO TRANSIT
AUTHORITY
ENGINEERING

SENSITIVE SECURITY INFORMATION

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95th Terminal Improvement
15 West 95th Street (South Terminal)

15 West 95th Street (South Terminal) Chicago, IL 60628

IN CH	ARGE	J. JAKALSKI
APPR	OVED BY	J. JAKALSKI
CHEC	KED BY	R.S. NAIR
DESIG	ENED BY	G. FORKAN
DRAW	/N BY	C. BOVE
PROJ	ECT NO.	2012-0021.02
FILE N	NAME	DR095_S-Terminal
	2/9/17	ISSUED FOR CONSTRUCTIO
MARK	DATE	DESCRIPTION
	DATE	

LOCATION IDENTIFIER:

SOUTH TERMINAL ELEVATOR FOUNDATION


S-822


SHEET NOTES:

1. FOR GENERAL NOTES, SEE DWGS S-001 TO S-004.

2. FOR TYPICAL DETAILS REFER TO S-1112 TO S-1120.

3. CONTRACTOR TO COORDINATE PIT DIMENSIONS WITH FINAL ELEVATOR AND ESCALATOR REQUIREMENTS.

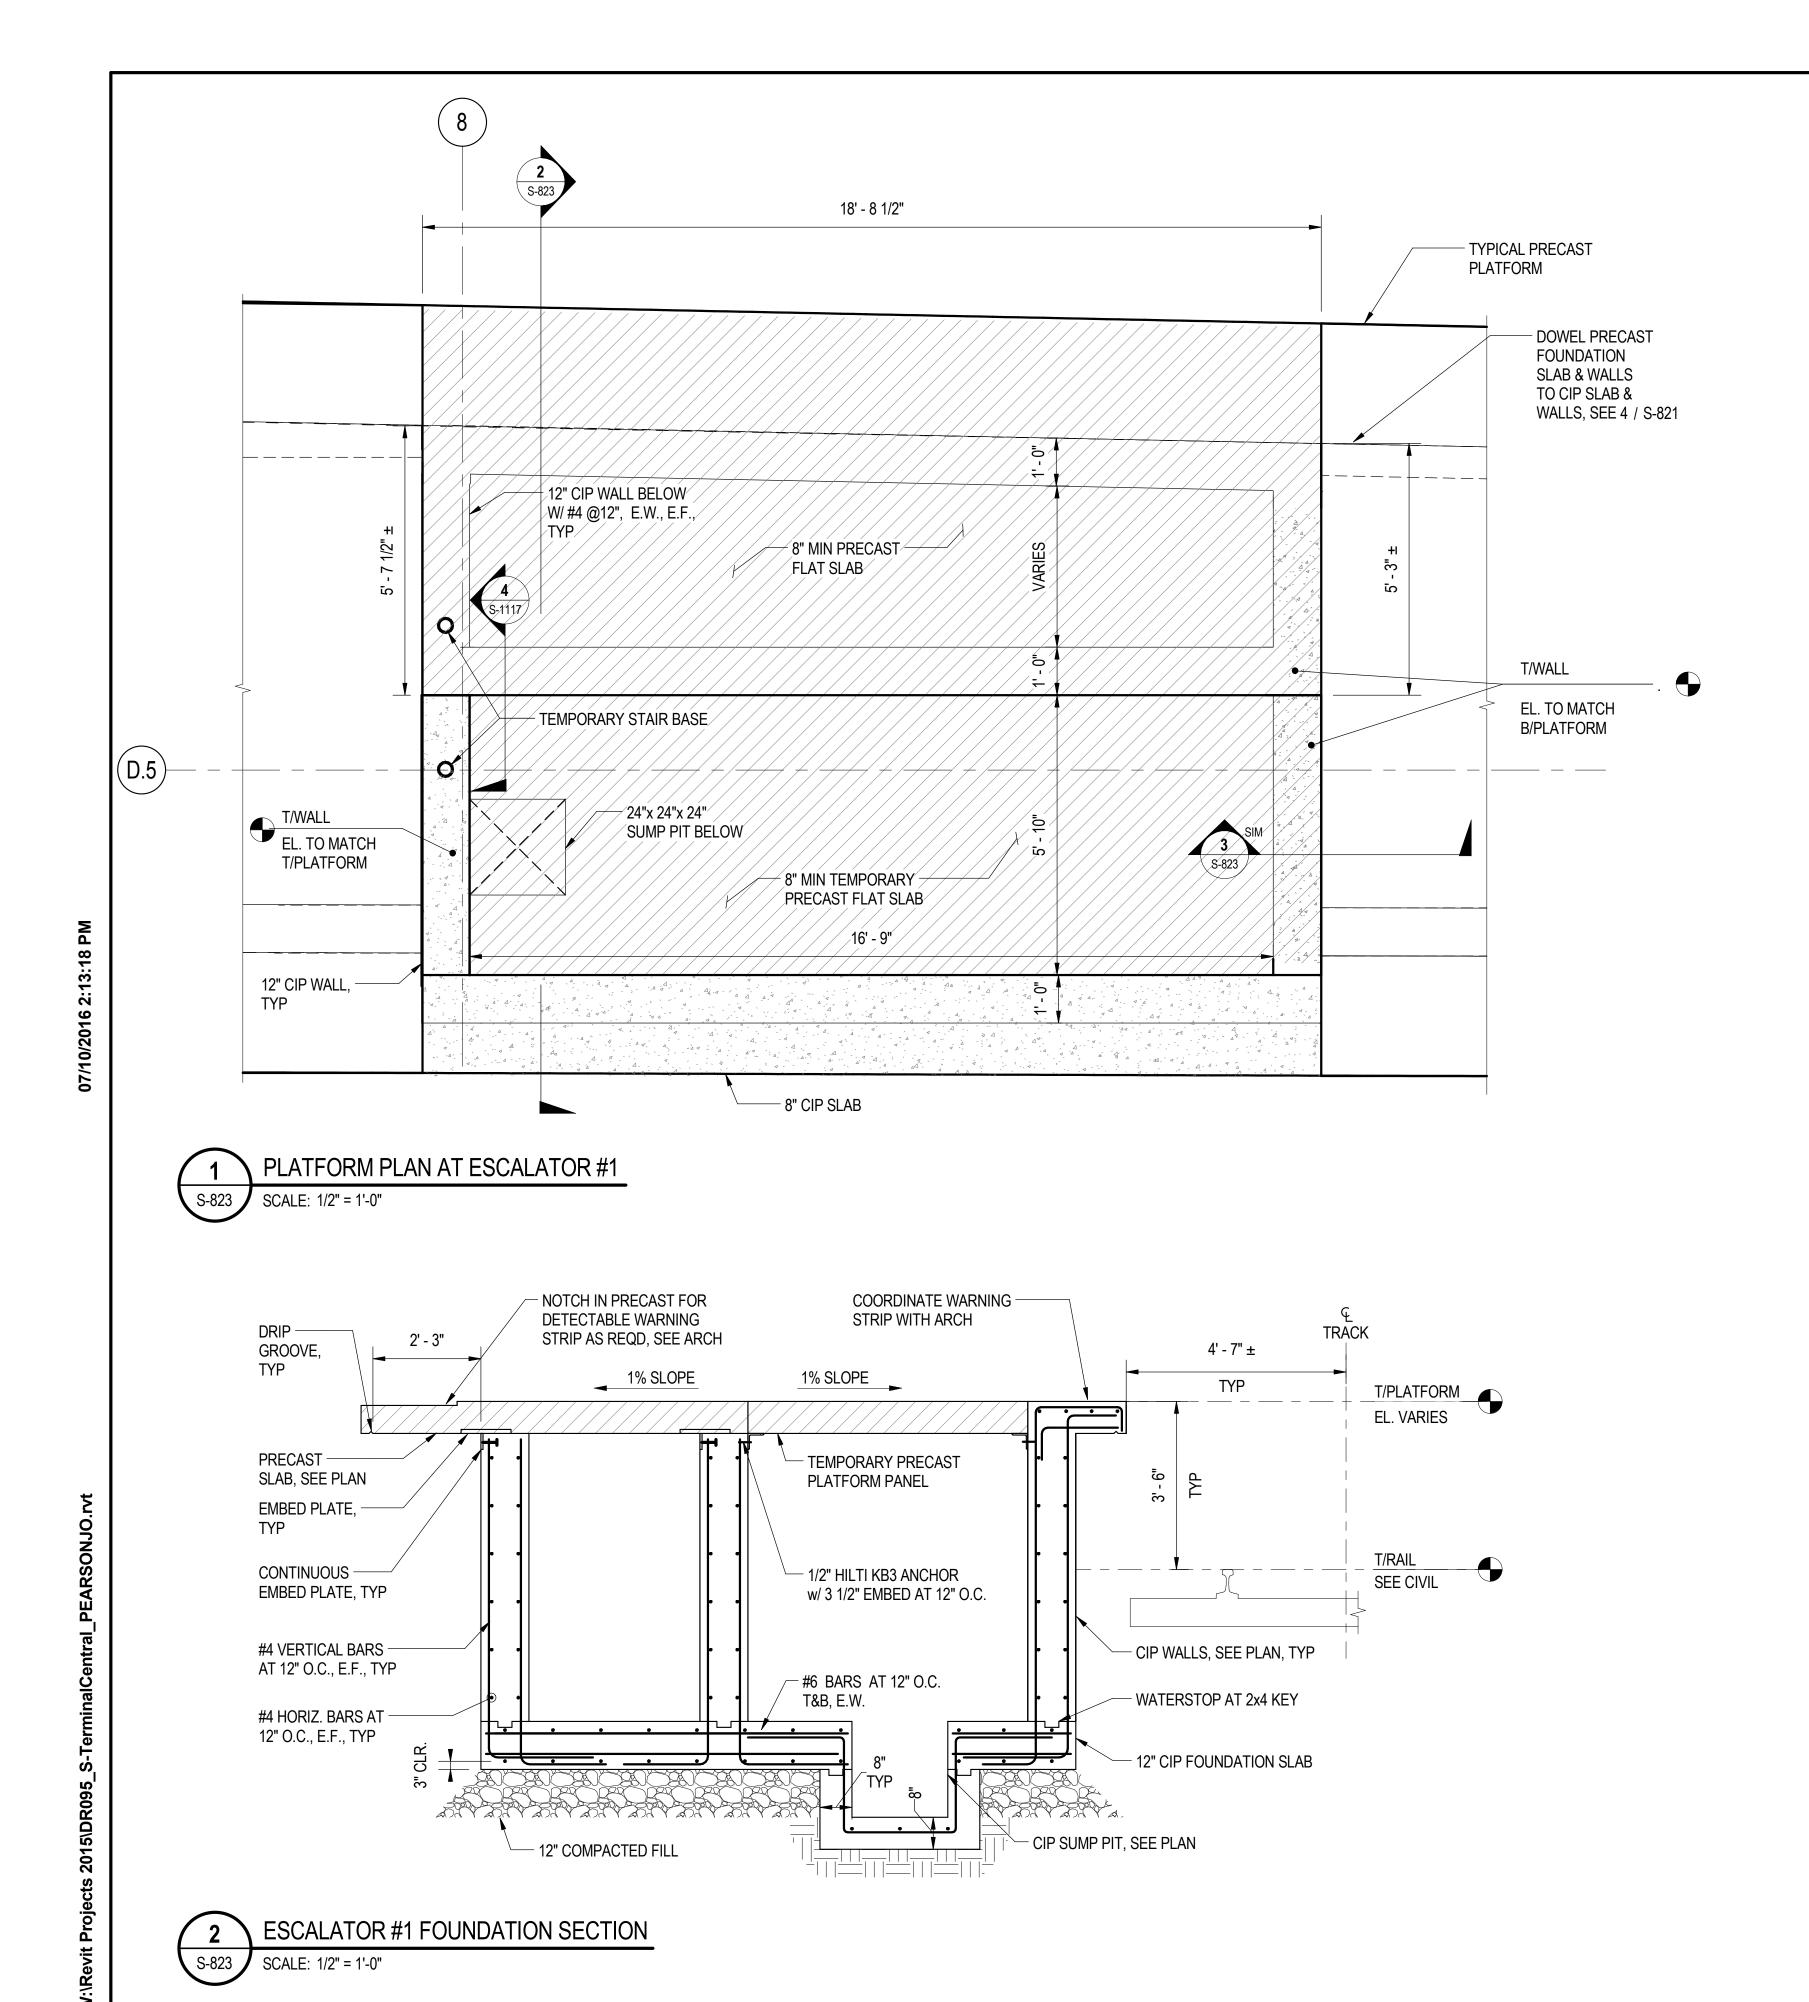

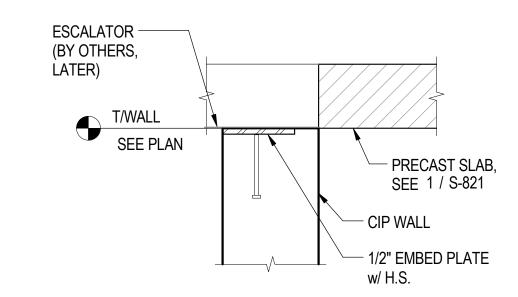

SHEET NOTES:

1. FOR GENERAL NOTES, SEE DWGS S-001 TO S-004.

2. FOR TYPICAL DETAILS REFER TO S-1112 TO S-1120.

ELEVATOR AND ESCALATOR REQUIREMENTS.

3. CONTRACTOR TO COORDINATE PIT DIMENSIONS WITH FINAL

**ESCALATOR #1 BASE CONNECTION** 









#### **SENSITIVE SECURITY INFORMATION**

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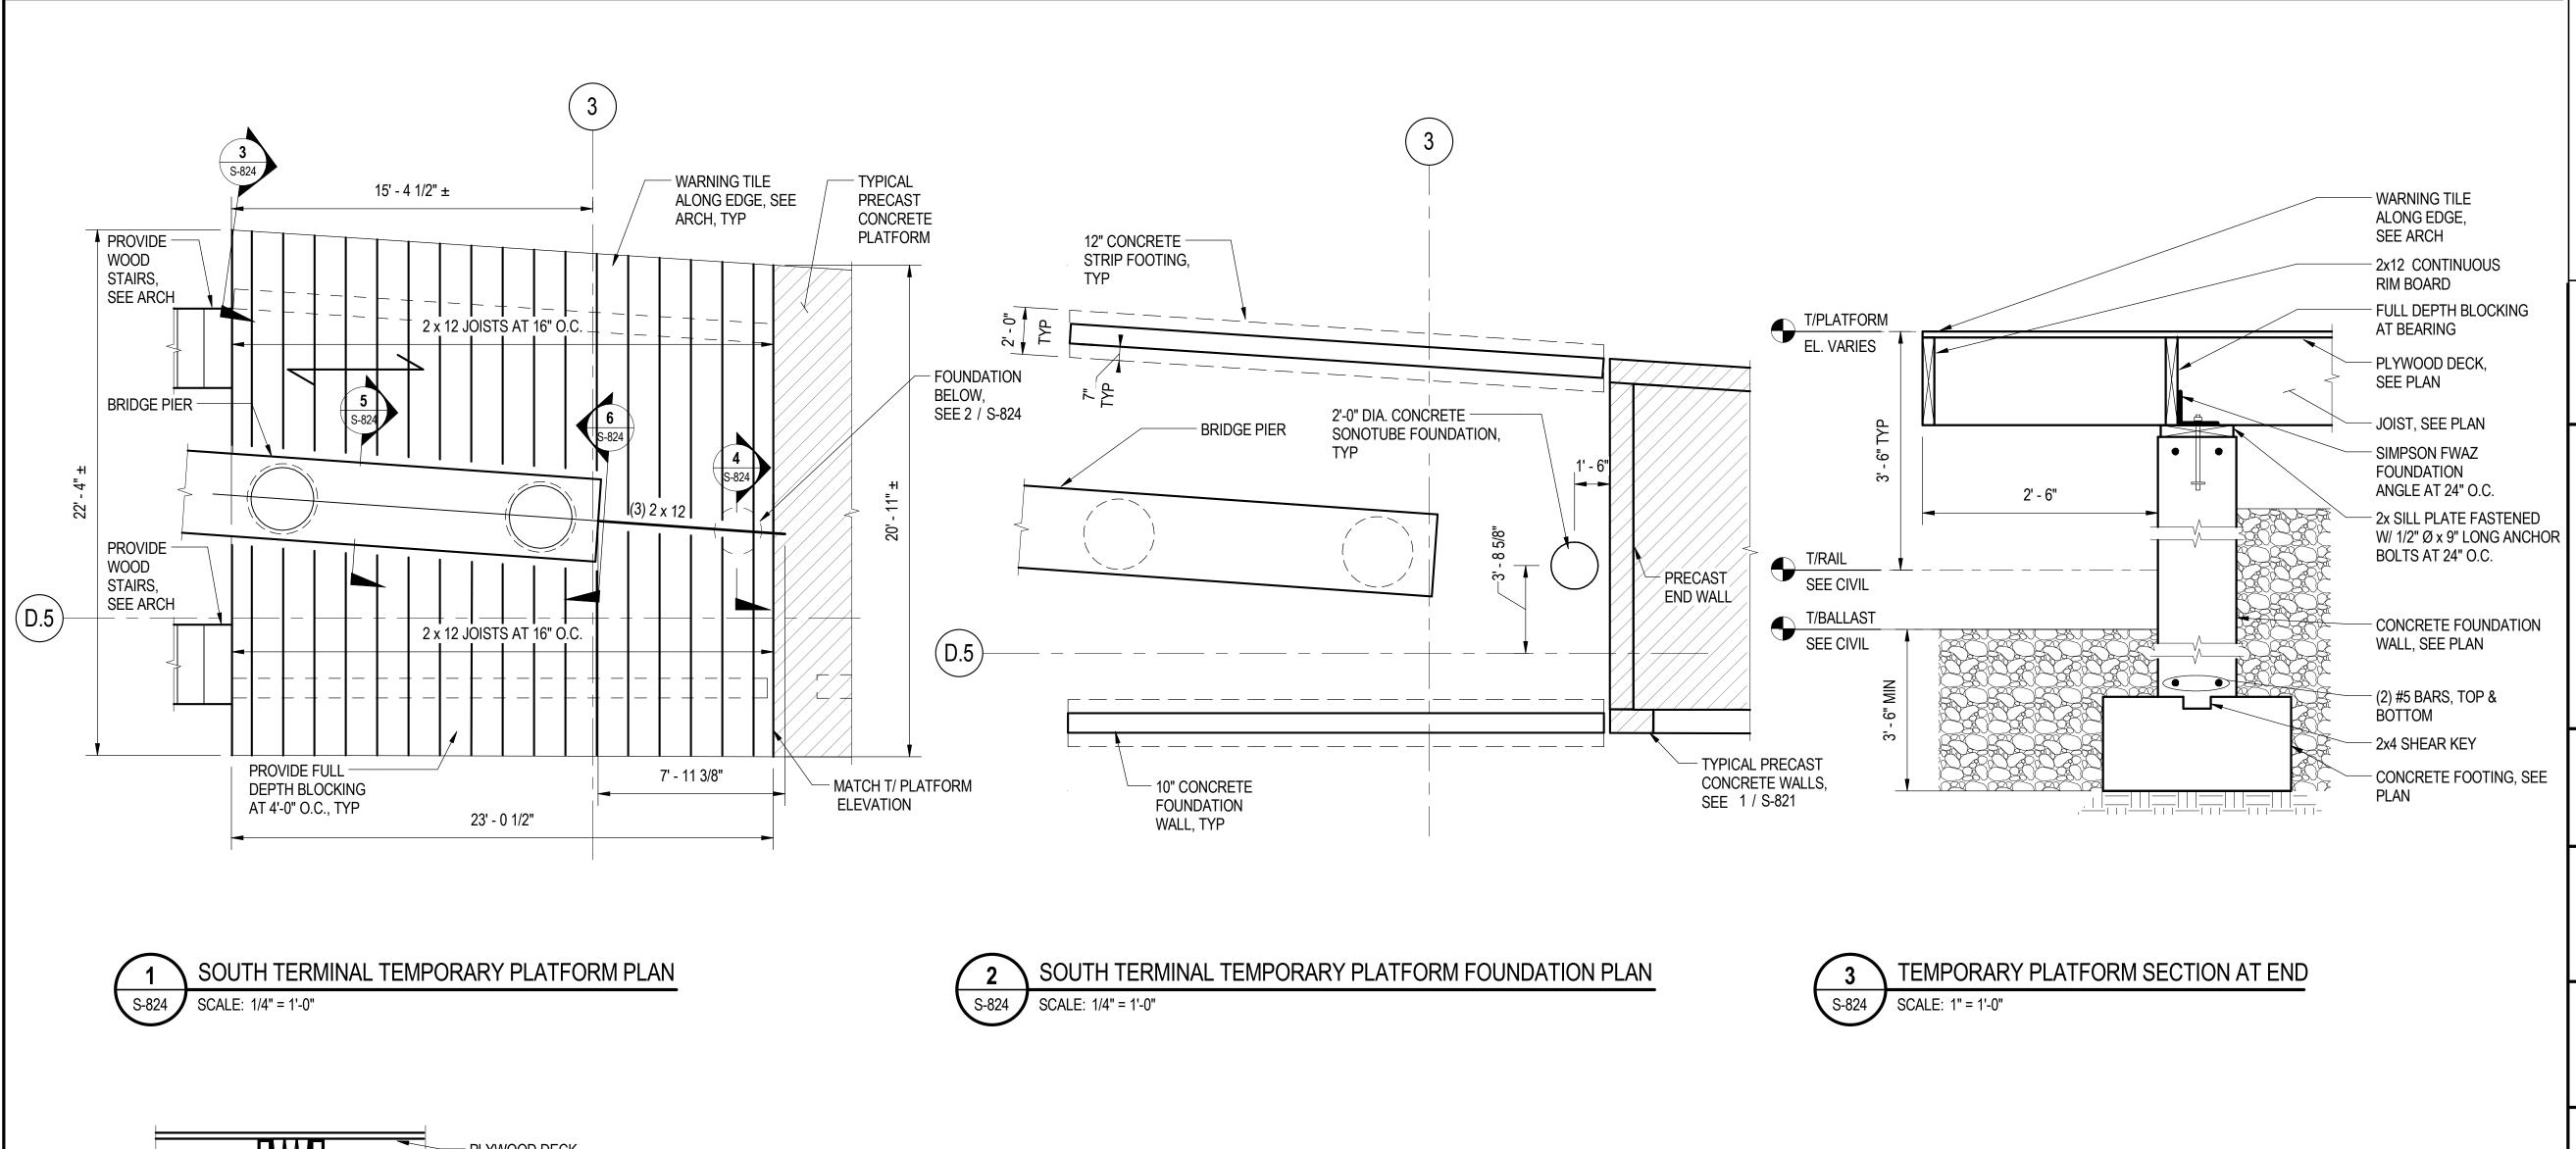
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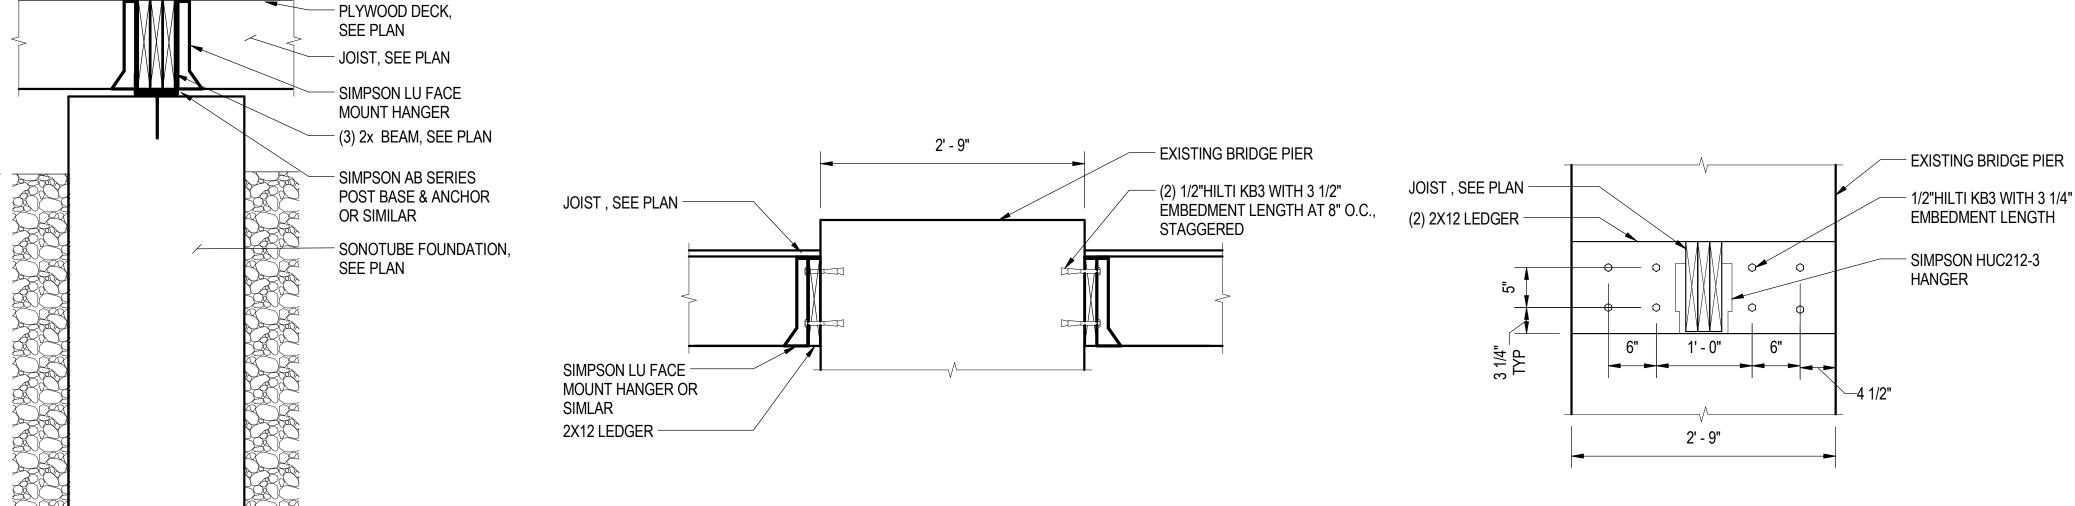
## 95th Terminal Improvement

15 West 95th Street (South Terminal) Chicago, IL 60628

IN CHA	<b>ARGE</b>	J. JAKALSKI
APPRO	OVED BY	J. JAKALSKI
CHEC	KED BY	R.S. NAIR
DESIG	NED BY	G. FORKAN
DRAW	N BY	J. PEARSON
PROJE	ECT NO.	2012-0021.02
FILE N	AME	DR095_S-Terminal
	2/9/17	ISSUED FOR CONSTRUCTION
MARK	DATE	DESCRIPTION
LOCA	ATION IDI	ENTIFIER: <b>DR095</b>

**SOUTH TERMINAL ESCALATOR FOUNDATION** 





TEMPORARY PLATFORM SECTION AT SONOTUBE SCALE: 1" = 1'-0"

TEMPORARY PLATFORM SECTION AT BRIDGE PIER S-824 SCALE: 1" = 1'-0"

TEMPORARY PLATFORM CONNECTION AT BRIDGE PIER S-824 | SCALE: 1" = 1'-0"

### SHEET NOTES:

- 1. FOR GENERAL NOTES, SEE DWGS S-001 TO S-004.
- 2. FOR TYPICAL DETAILS REFER TO S-1112 TO S-1120.
- 3. INDICATES 3/4" EXTERIOR GRADE PLYWOOD FASTENED W/ 10d NAILS AT 6" O.C. EDGE & 12" O.C. FIELD.
- 4. ALL WOOD TO BE PRESSURE TREATED U.N.O.



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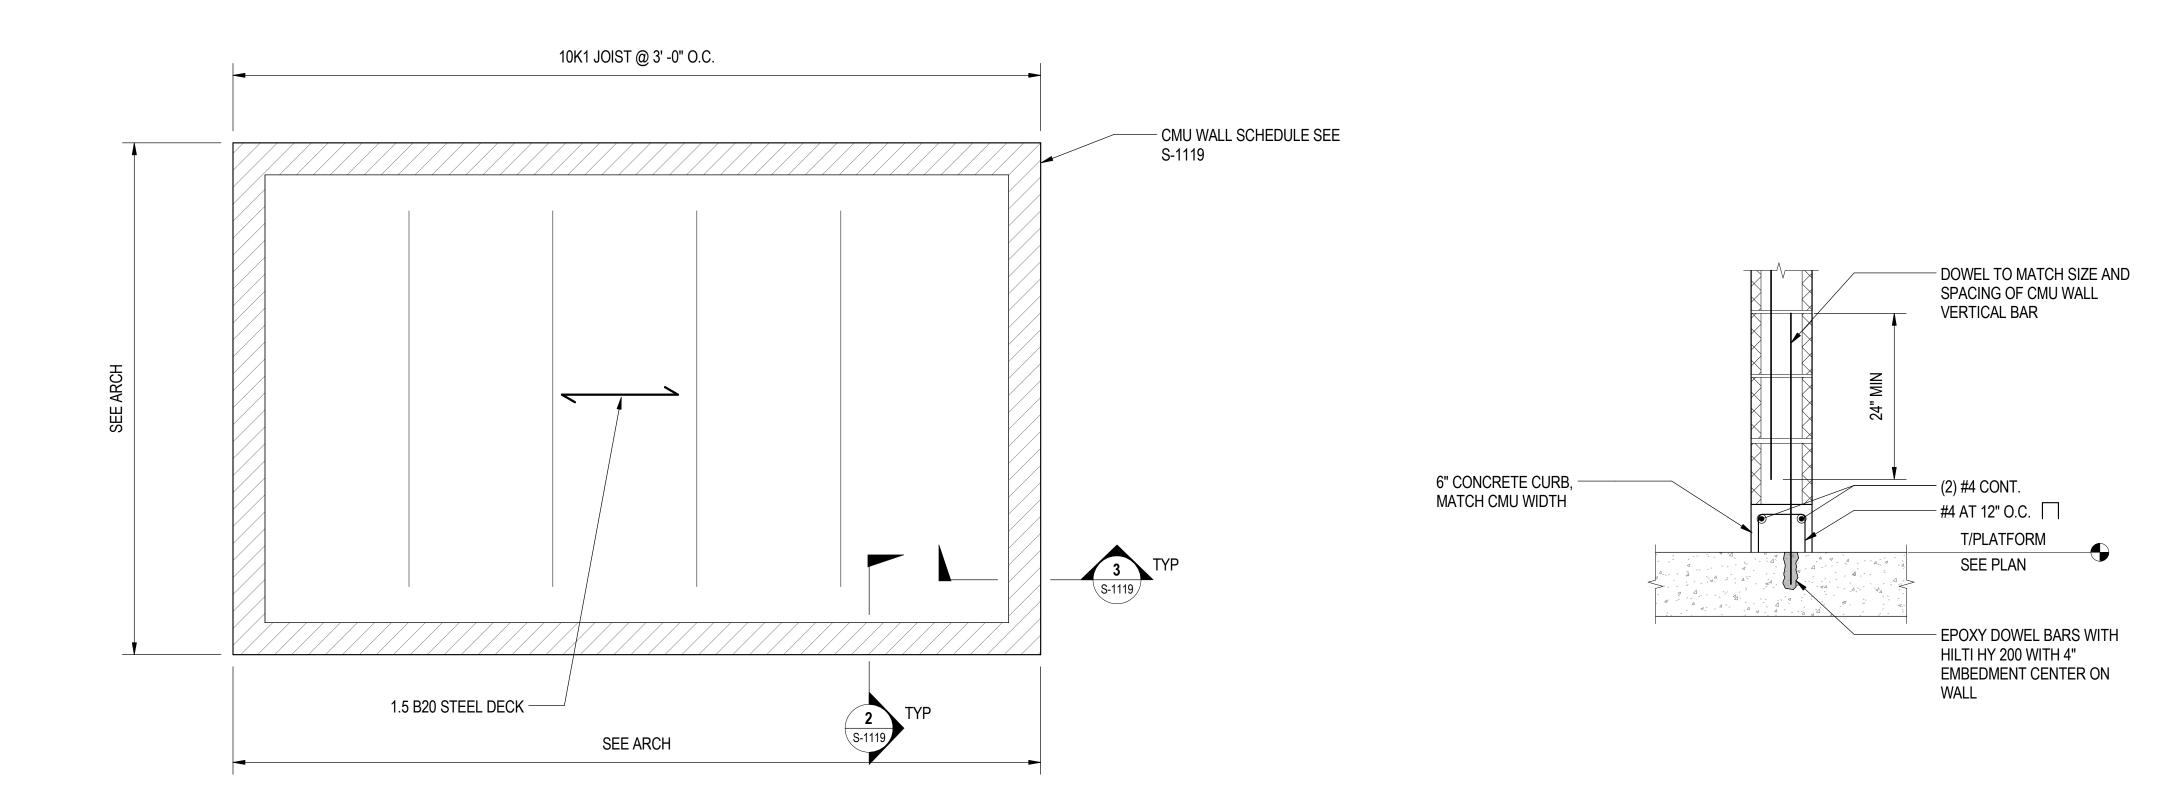
## 95th Terminal Improvement

15 West 95th Street (South Terminal) Chicago, IL 60628

IN CH	ARGE	J. JAKALSKI	
APPR	OVED BY	J. JAKALSKI	
CHEC	KED BY	R.S. NAIR	
DESIG	ENED BY	G. FORKAN	
DRAW	/N BY	C. BOVE	
PROJ	ECT NO.	2012-0021.02	
FILE N	NAME	DR095_S-Terminal	
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LOCATION IDENTIFIEM.


**SOUTH TERMINAL TEMPORARY PLATFORM** 




PLATFORM LEVEL ENCLOSURE ROOF FRAMING PLAN

SCALE: 1/2" = 1'-0"

PLATFORM LEVEL CMU WALL TO PLATFORM SLAB

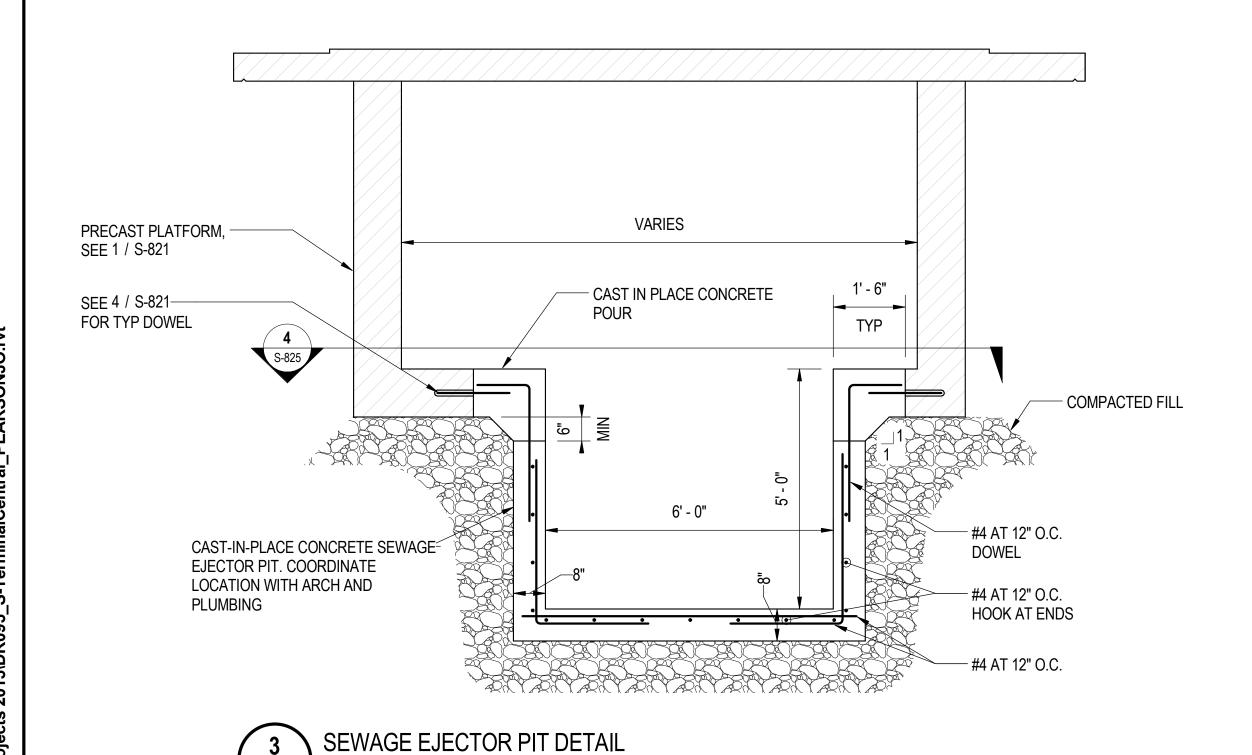

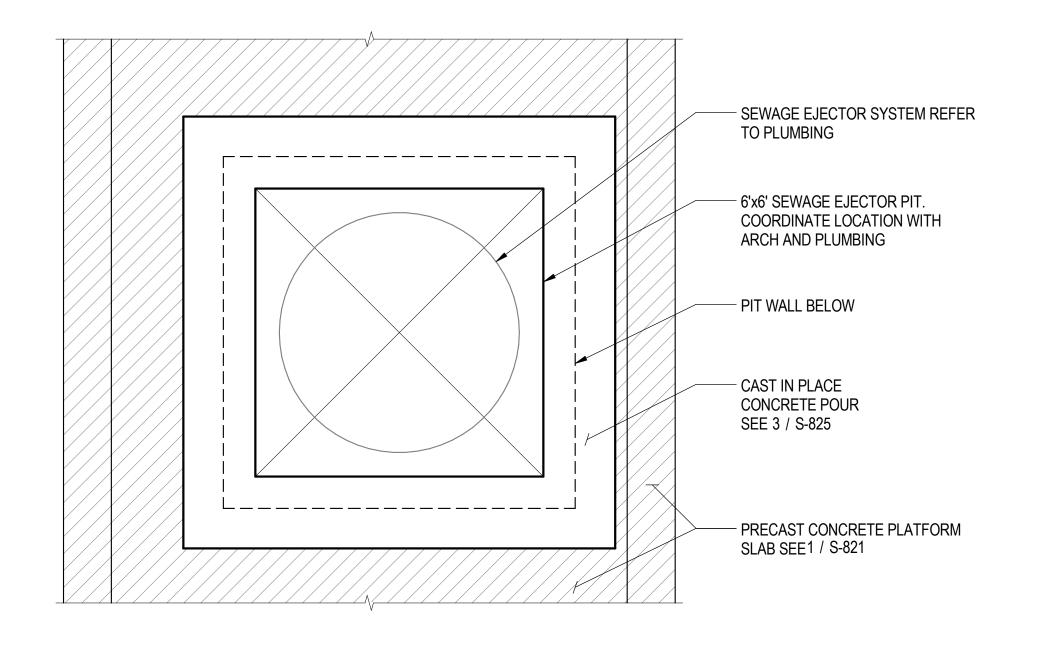

SEWAGE EJECTOR PIT PLAN DETAIL SCALE: 1/2" = 1'-0"









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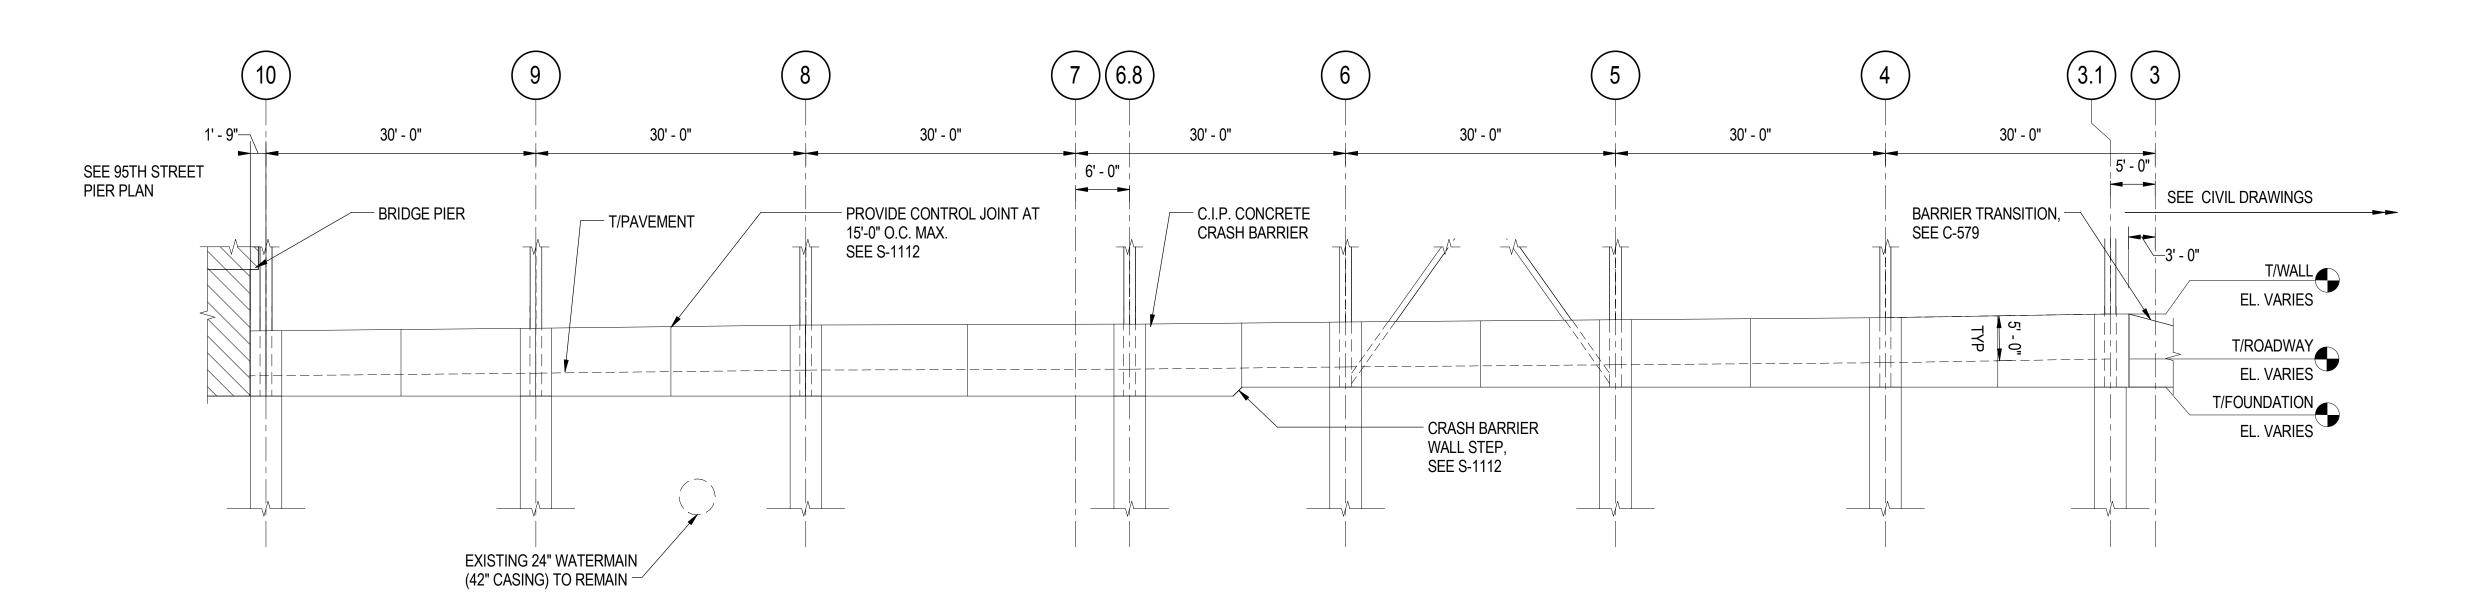
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### 95th Terminal Improvement

15 West 95th Street (South Terminal) Chicago, IL 60628


IN CH	ARGE	J. JAKALSKI
APPR	OVED BY	J. JAKALSKI
CHEC	KED BY	R.S. NAIR
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DRAV	/N BY	C. BOVE
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LOC	ATION IDE	ENTIFIER: <b>DR095</b>

SOUTH TERMINAL PLATFORM **DETAILS** 



S-831 SCALE: 3

WALL NO. 3 - ELEVATION (LOOKING EAST)

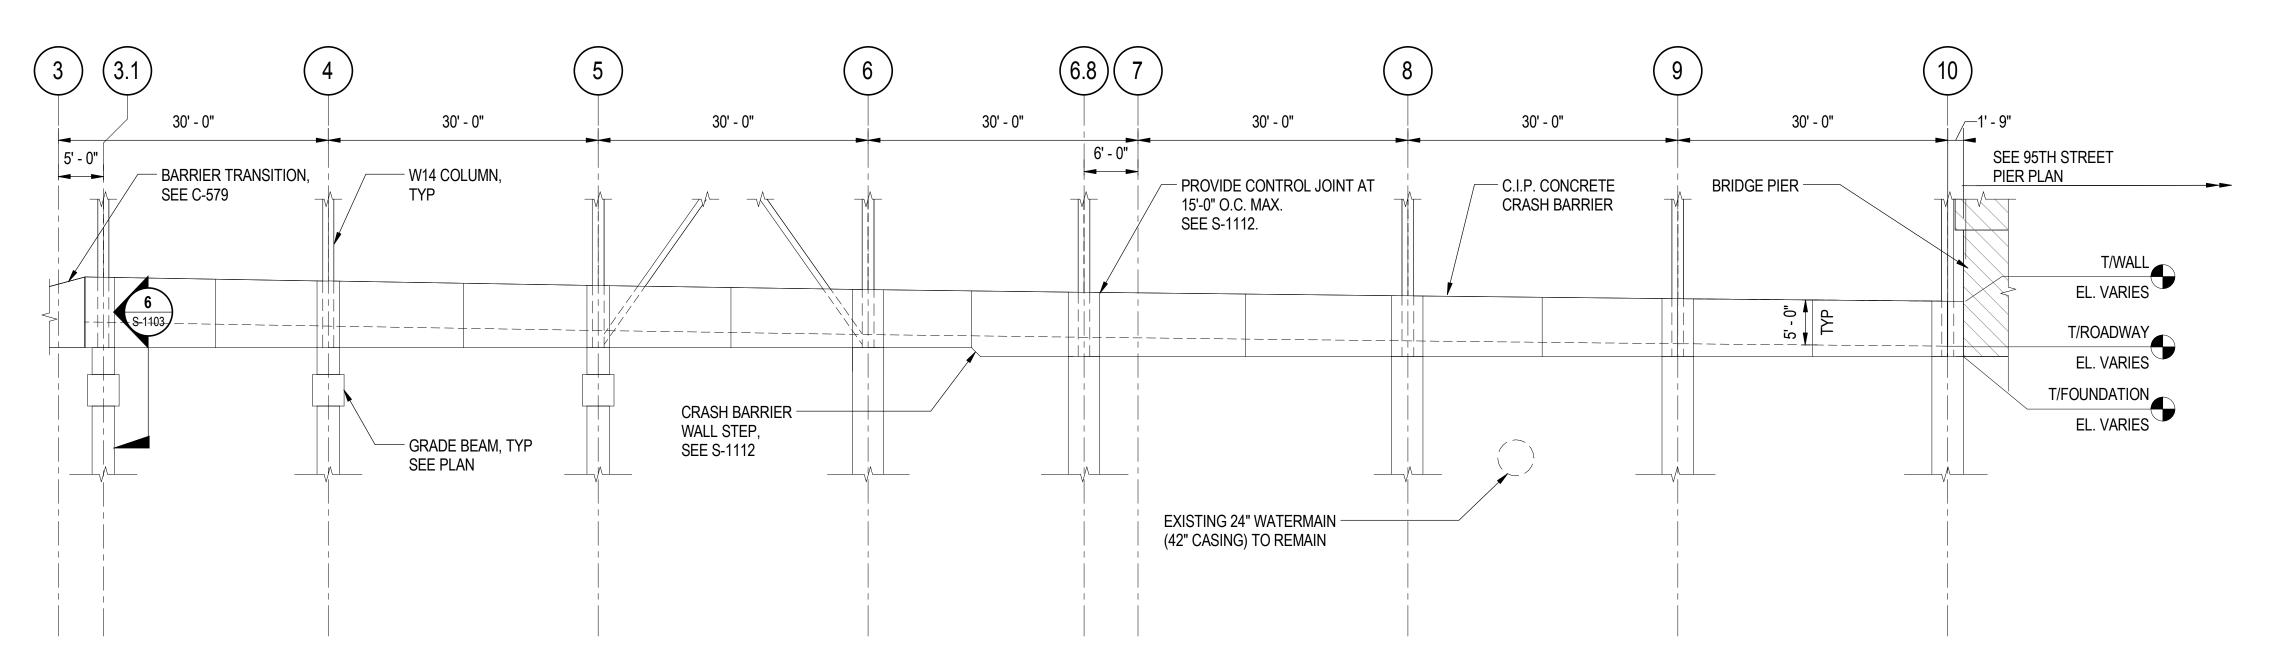

WALL NO. 5 - ELEVATION (LOOKING WEST)

S-831 SCALE: 3/32" = 1'-0"

### SHEET NOTES:

- 1. FOR GENERAL PROJECT NOTES, SEE S-000 SERIES.
- 2. FOR TYPICAL DETAILS, SEE S-1100 SERIES.
- 3. REFER TO S-1104 FOR WALL REINFORCEMENT AND DETAILS.
- 4. PROVIDE CONTROL JOINT AT 15'-0" O.C. MAX. TYP, SEE S-1112.
- 5. ALL EXPOSED EDGES SHALL BE CHAMFERED 3/4", INCLUDING THE TOP OF THE WALL AND AT THE INTERFACE WITH BRIDGE PIERS.









SENSITIVE SECURITY INFORMATION


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95th Terminal Improvement 15 West 95th Street (South Terminal) Chicago, IL 60628

GE ED BY D BY ED BY FNO.	J. JAKALSKI J. JAKALSKI R.S. NAIR G. FORKAN M. DONAHUE 2012-0021.02 DR095_S-StationFoundation
D BY ED BY BY F NO.	R.S. NAIR G. FORKAN M. DONAHUE 2012-0021.02
ED BY BY F NO.	G. FORKAN M. DONAHUE 2012-0021.02
BY ΓNO.	M. DONAHUE 2012-0021.02
ΓNO.	2012-0021.02
ME .	DR095_S-StationFoundation
2/9/17	ISSUED FOR CONSTRUCTION
DATE	DESCRIPTION
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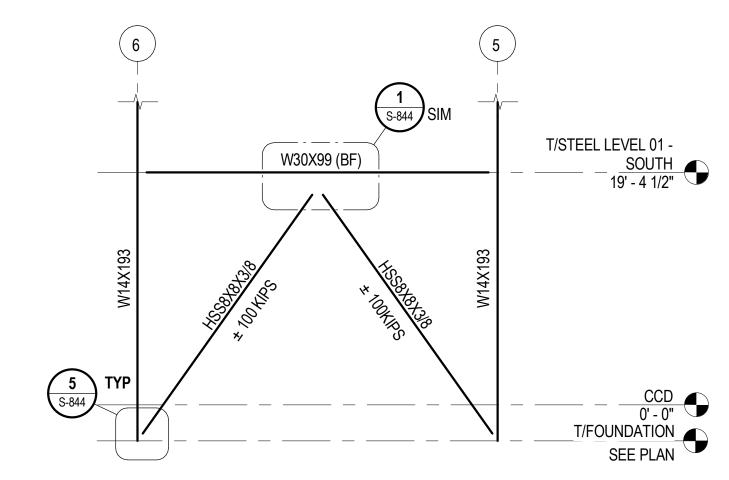
SOUTH TERMINAL CRASH BARRIER WALL ELEVATIONS




T/STEEL ROOF -W12X26 (BF) SOUTH VARIES W21X44 (BF) T/STEEL LEVEL 01 -W24X55 SOUTH 19' - 4 1/2"


BRACED FRAME ELEVATION ALONG GRID C' SCALE: 1/8" = 1'-0"

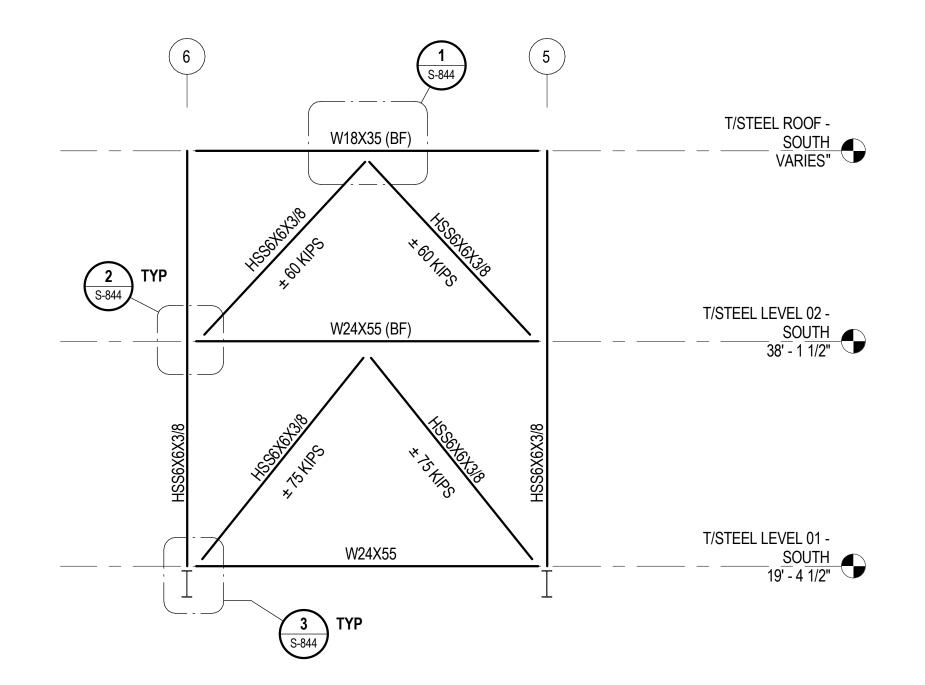BRACED FRAME ELEVATION ALONG GRID E SCALE: 1/8" = 1'-0"



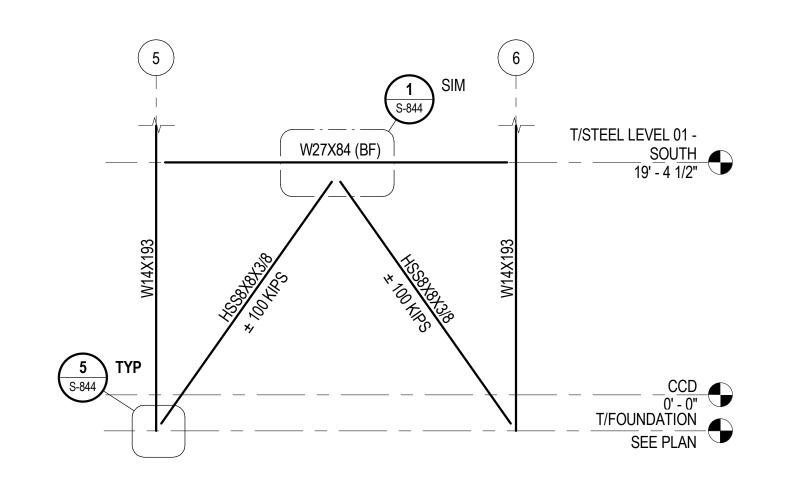

BRACED FRAME ELEVATION ALONG GRID D' S-832 | SCALE: 1/8" = 1'-0"

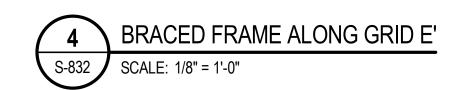

### SHEET NOTES:

- 1. FOR GENERAL NOTES, SEE DWGS S-001 TO S-004.
- 2. BRACE CONNECTIONS TO BE DESIGNED BY LICENSED SE IN THE STATE OF IL TO DEVELOP 100% OF INDICATED BRACE FORCES.
- 3. ALL INDICATED BRACE FORCES ARE FACTORED AXIAL LOADS. FORCES TO BE CONSIDERED EITHER TENSION OR COMPRESSION.
- 4. BRACED FRAME JOINTS SHALL BE DESIGNED USING THE AISC UNIFORM FORCE METHOD TO AVOID MOMENTS AT CONNECTION INTERFACES OR EQUIVALENT UNLESS NOTED OTHERWISE.





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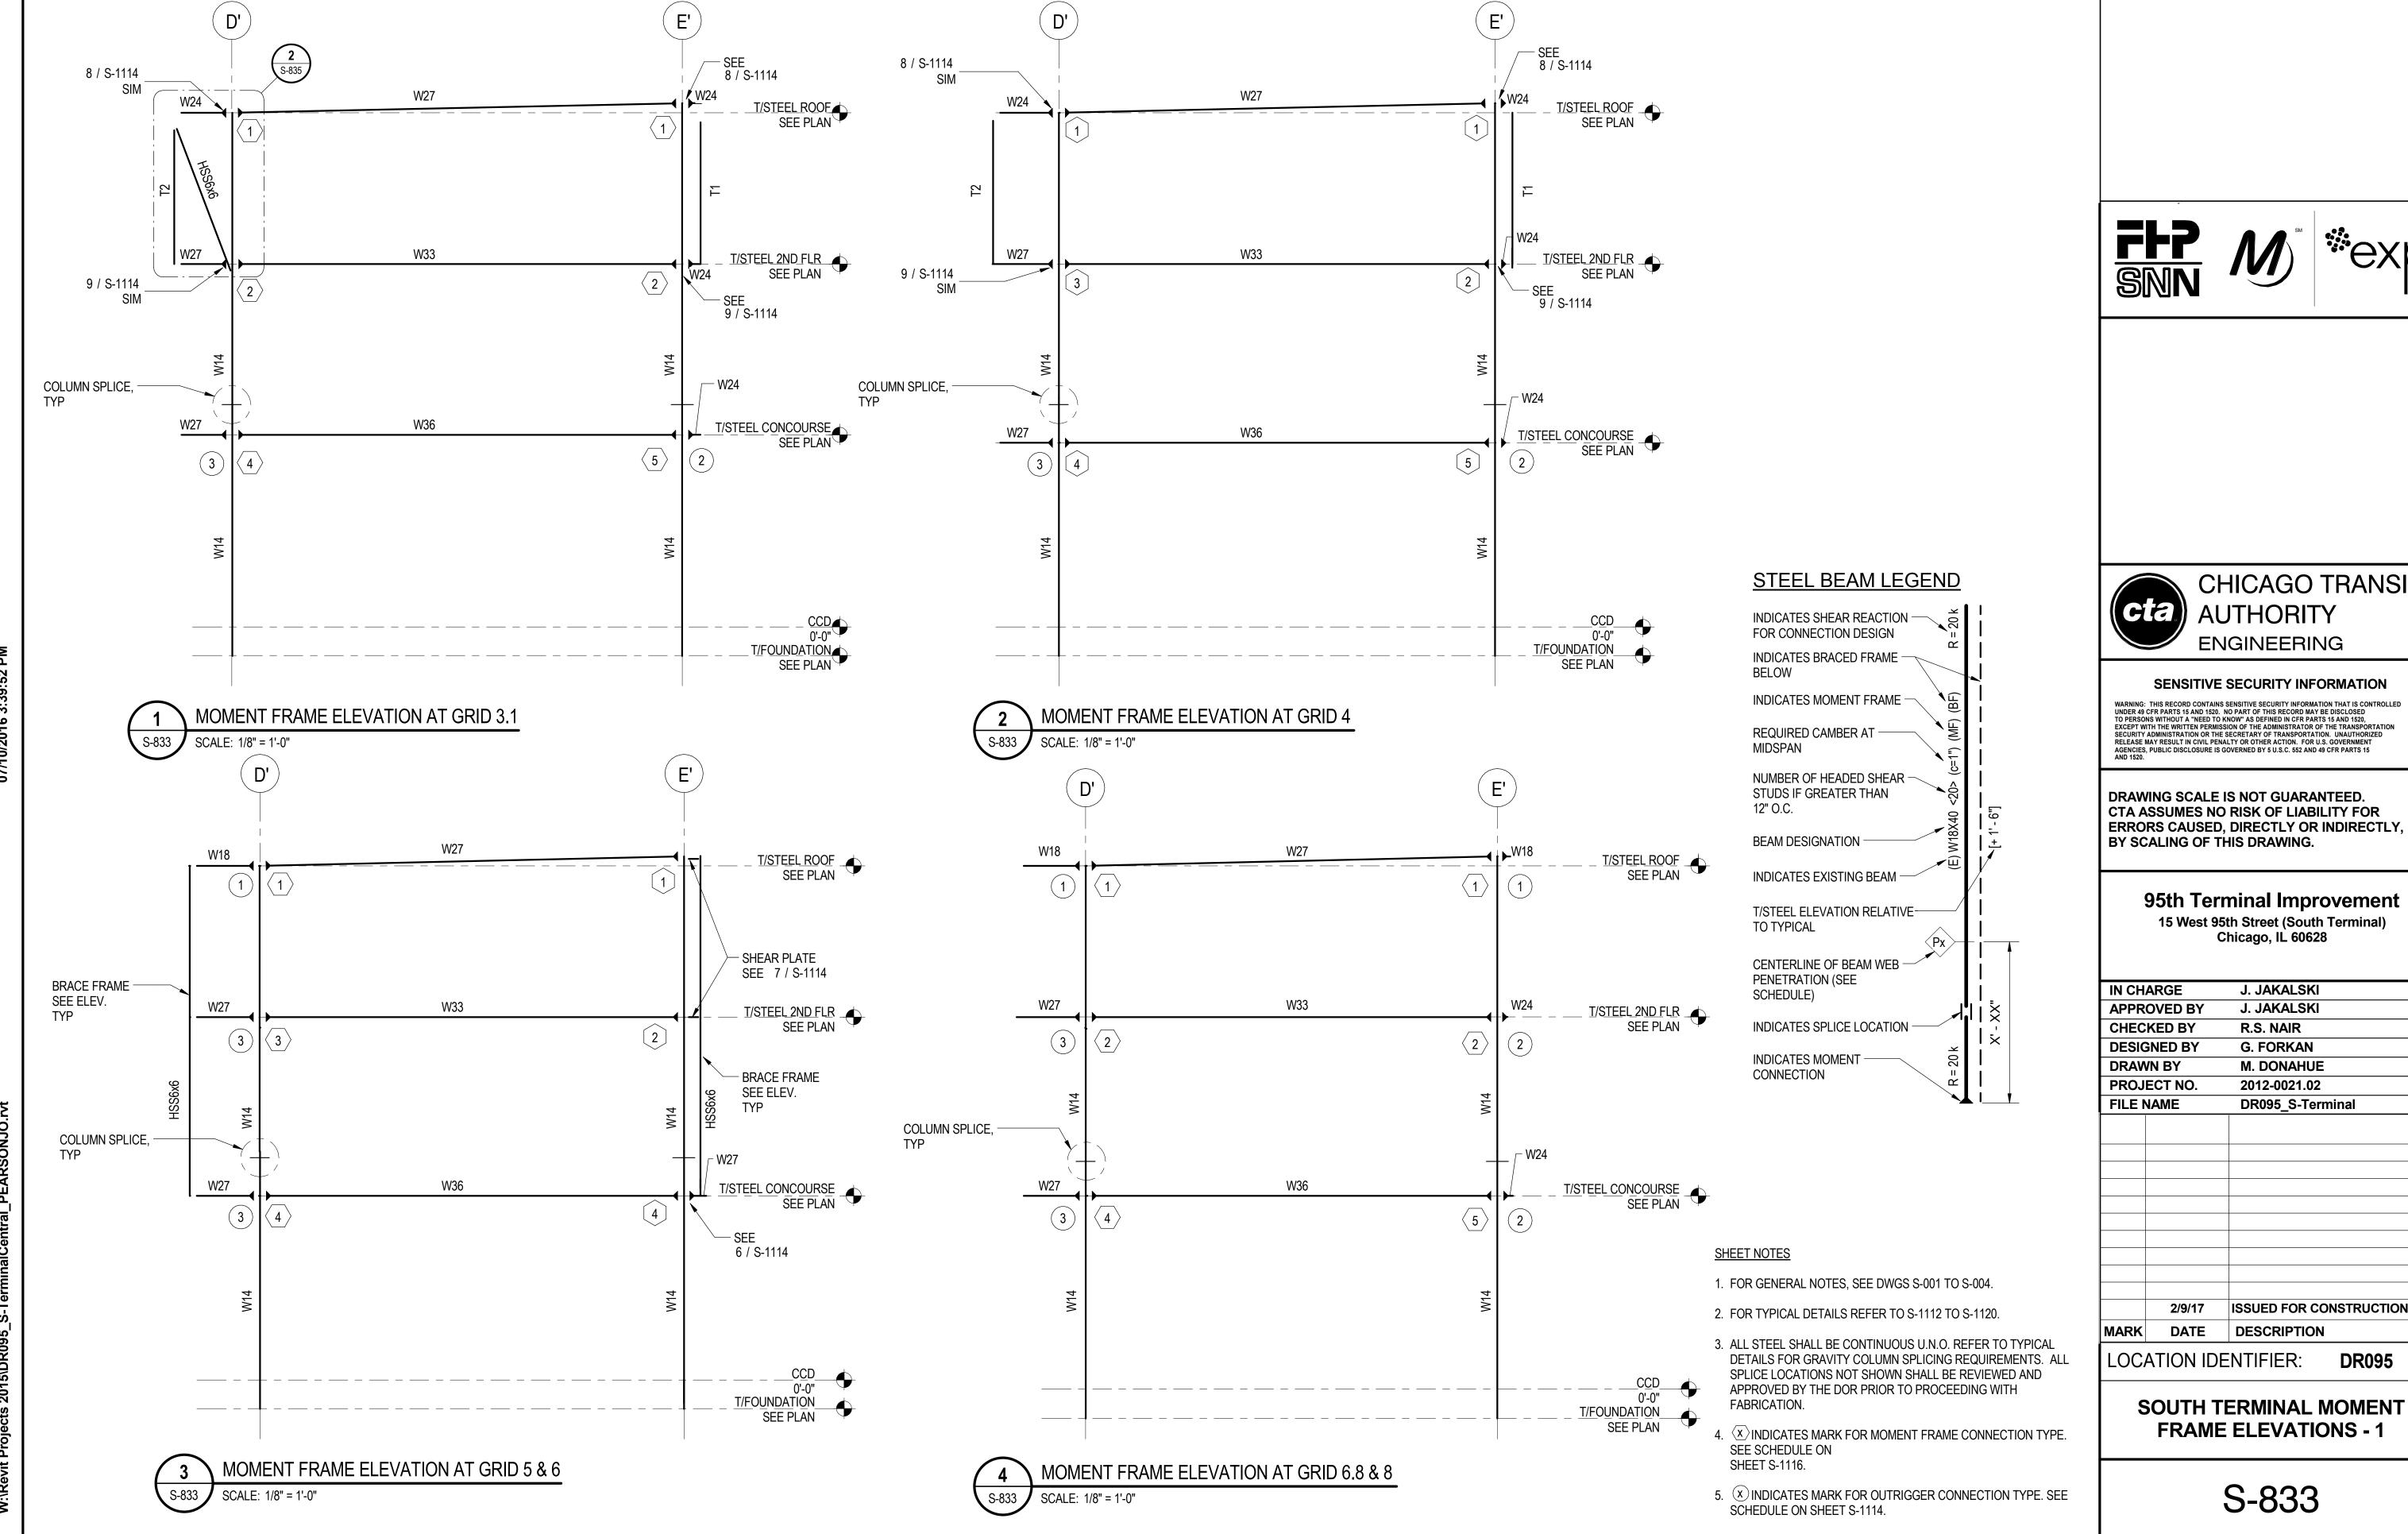
## 95th Terminal Improvement

15 West 95th Street (South Terminal) Chicago, IL 60628

IN CH	ARGE	J. JAKALSKI
APPR	OVED BY	J. JAKALSKI
CHEC	KED BY	R.S. NAIR
DESIG	ENED BY	G. FORKAN
DRAW	/N BY	J. PEARSON
PROJ	ECT NO.	2012-0021.02
FILE	NAME	DR095_S-Terminal
	2/9/17	ISSUED FOR CONSTRUCTION
MARK	DATE	DESCRIPTION

LOCATION IDENTIFIER: **DR095** 

> **SOUTH TERMINAL BRACED FRAME ELEVATIONS**





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## 95th Terminal Improvement


IN CH	ARGE	J. JAKALSKI
APPR	OVED BY	J. JAKALSKI
CHEC	KED BY	R.S. NAIR
DESIG	SNED BY	G. FORKAN
DRAW	VN BY	M. DONAHUE
PROJ	ECT NO.	2012-0021.02
FILE N	NAME	DR095_S-Terminal
	0/0/4	LOCUED FOR CONCERNATION
	2/9/17	ISSUED FOR CONSTRUCTION
MARK	DATE	DESCRIPTION
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DR095


**FRAME ELEVATIONS - 1** 







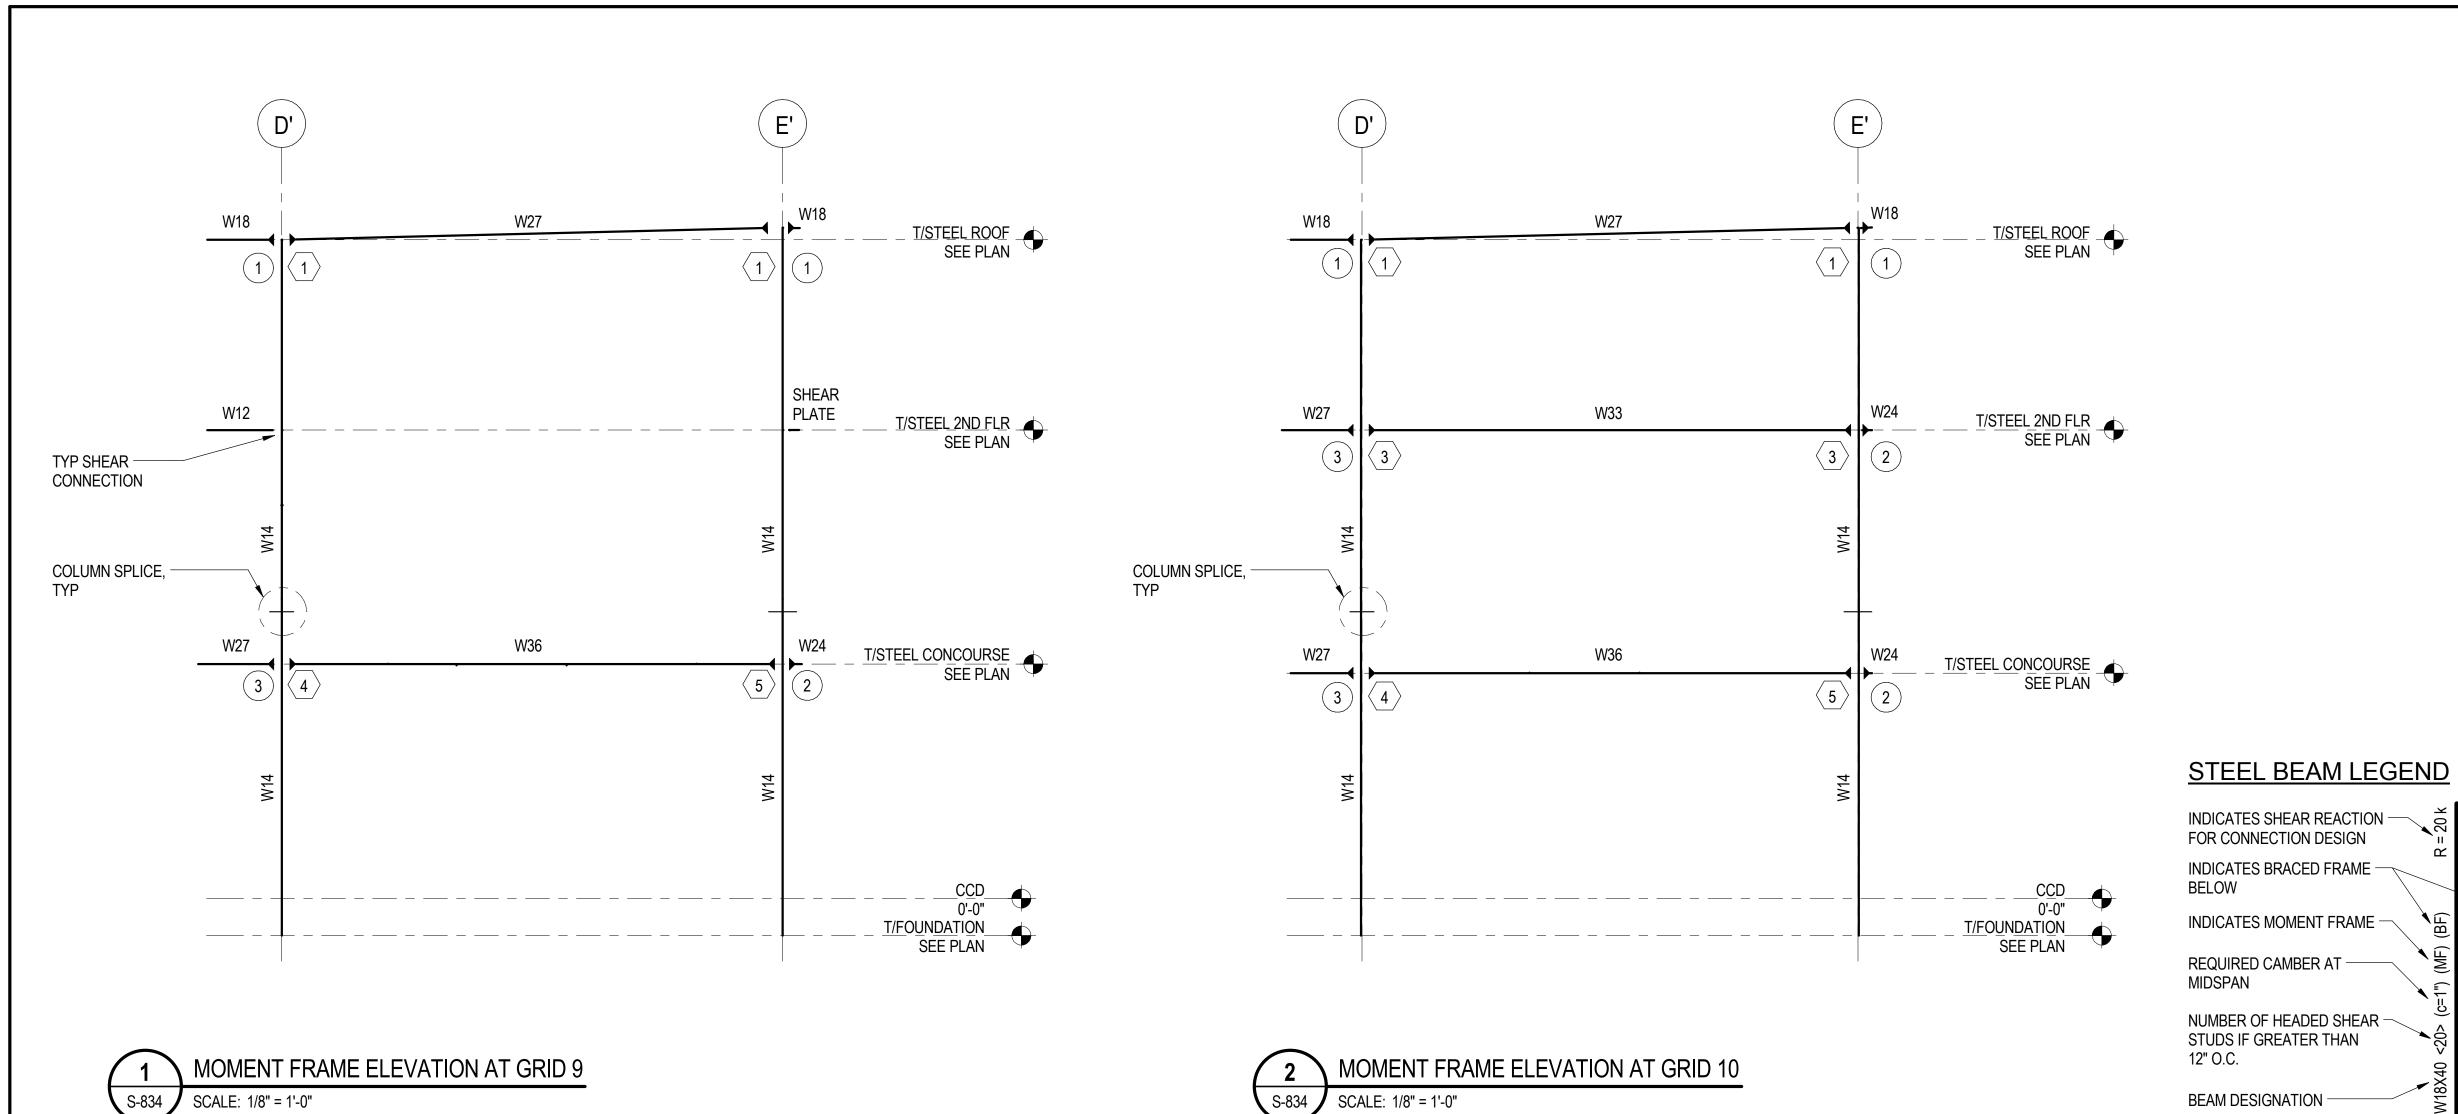

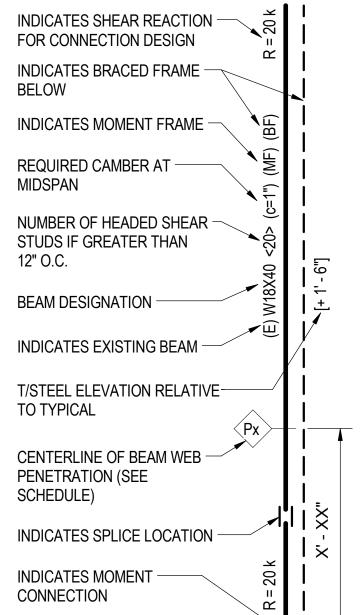

#### SHEET NOTES

- 1. FOR GENERAL NOTES, SEE DWGS S-001 TO S-004.
- 2. FOR TYPICAL DETAILS REFER TO S-1112 TO S-1120.
- 3. ALL STEEL SHALL BE CONTINUOUS U.N.O. REFER TO TYPICAL DETAILS FOR GRAVITY COLUMN SPLICING REQUIREMENTS. ALL SPLICE LOCATIONS NOT SHOWN SHALL BE REVIEWED AND APPROVED BY THE DOR PRIOR TO PROCEEDING WITH FABRICATION.
- 4. X INDICATES MARK FOR MOMENT FRAME CONNECTION TYPE. SEE SCHEDULE ON SHEET S-1116.
- 5. X INDICATES MARK FOR OUTRIGGER CONNECTION TYPE. SEE SCHEDULE ON SHEET S-1114.





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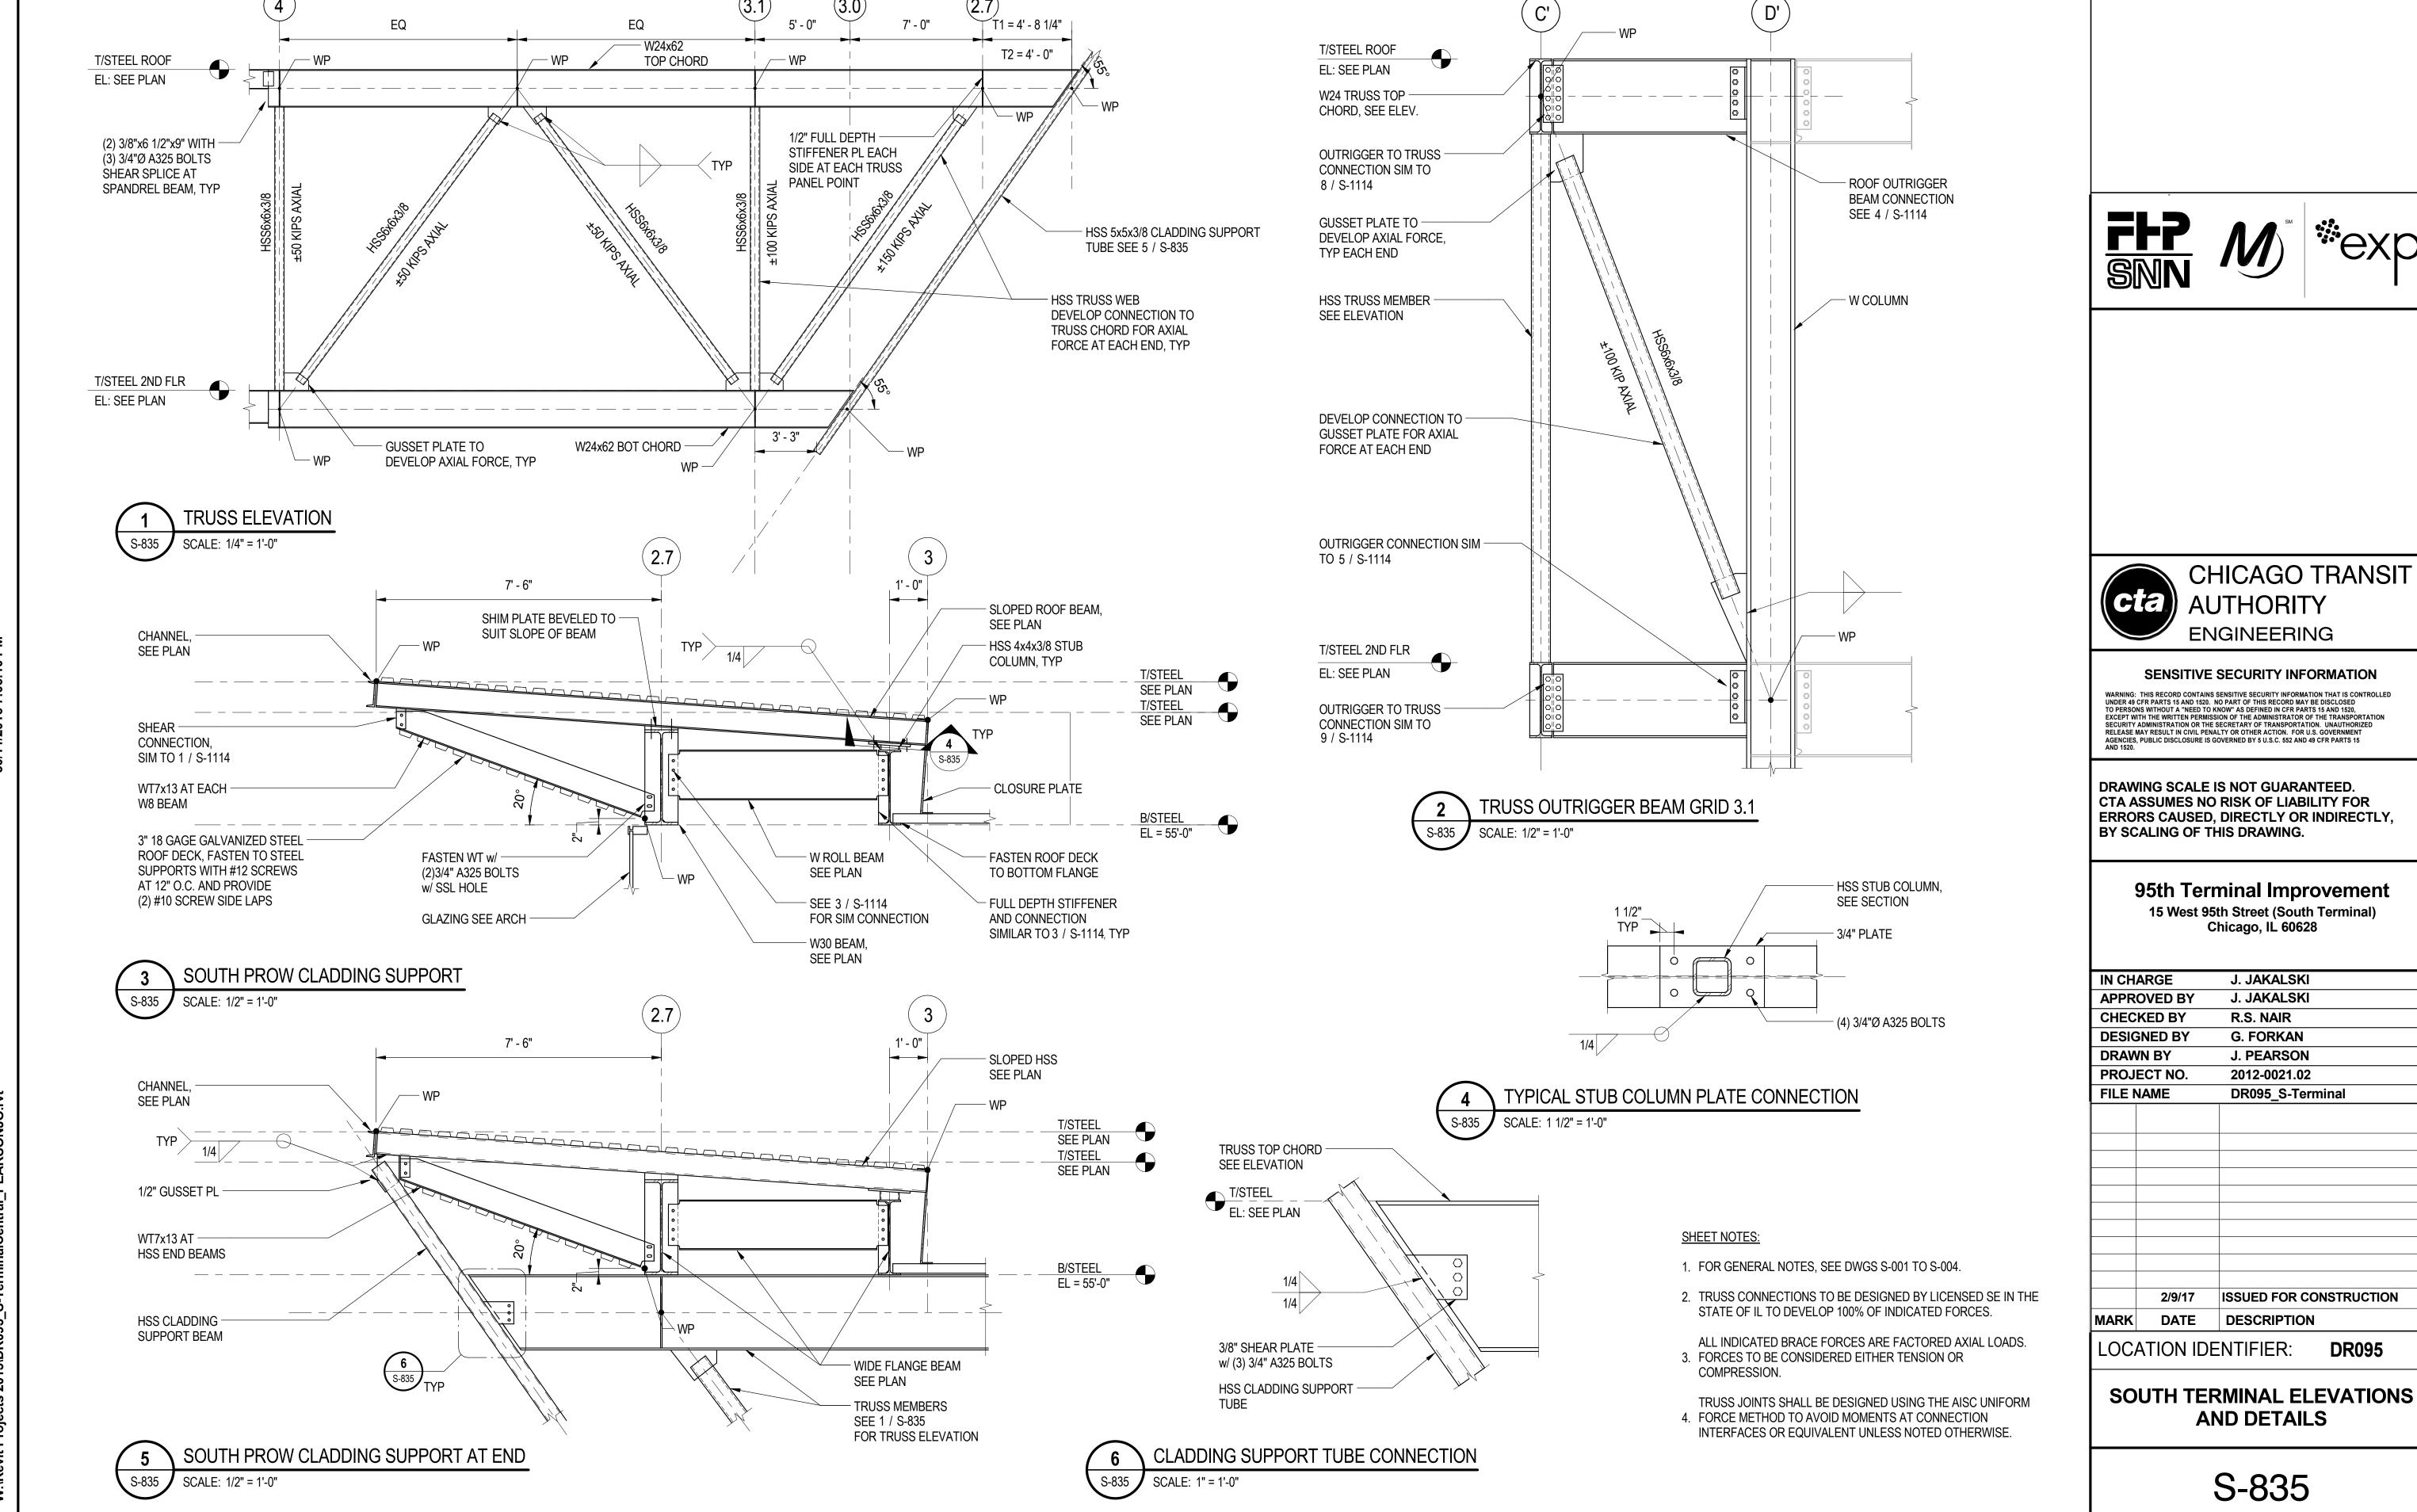
### 95th Terminal Improvement 15 West 95th Street (South Terminal) Chicago, IL 60628

IN CHARGE J. JAKALSKI

APPR	OVED BY	J. JAKALSKI
CHEC	KED BY	R.S. NAIR
DESIG	ENED BY	G. FORKAN
DRAW	/N BY	J. PEARSON
PROJ	ECT NO.	2012-0021.02
FILE	NAME	DR095_S-Terminal
	2/9/17	ISSUED FOR CONSTRUCTION
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LOC	ATION IDE	- ENTIFIER: <b>DR095</b>

LUCATION IDENTIFIER.

**SOUTH TERMINAL MOMENT** FRAME ELEVATIONS - 2





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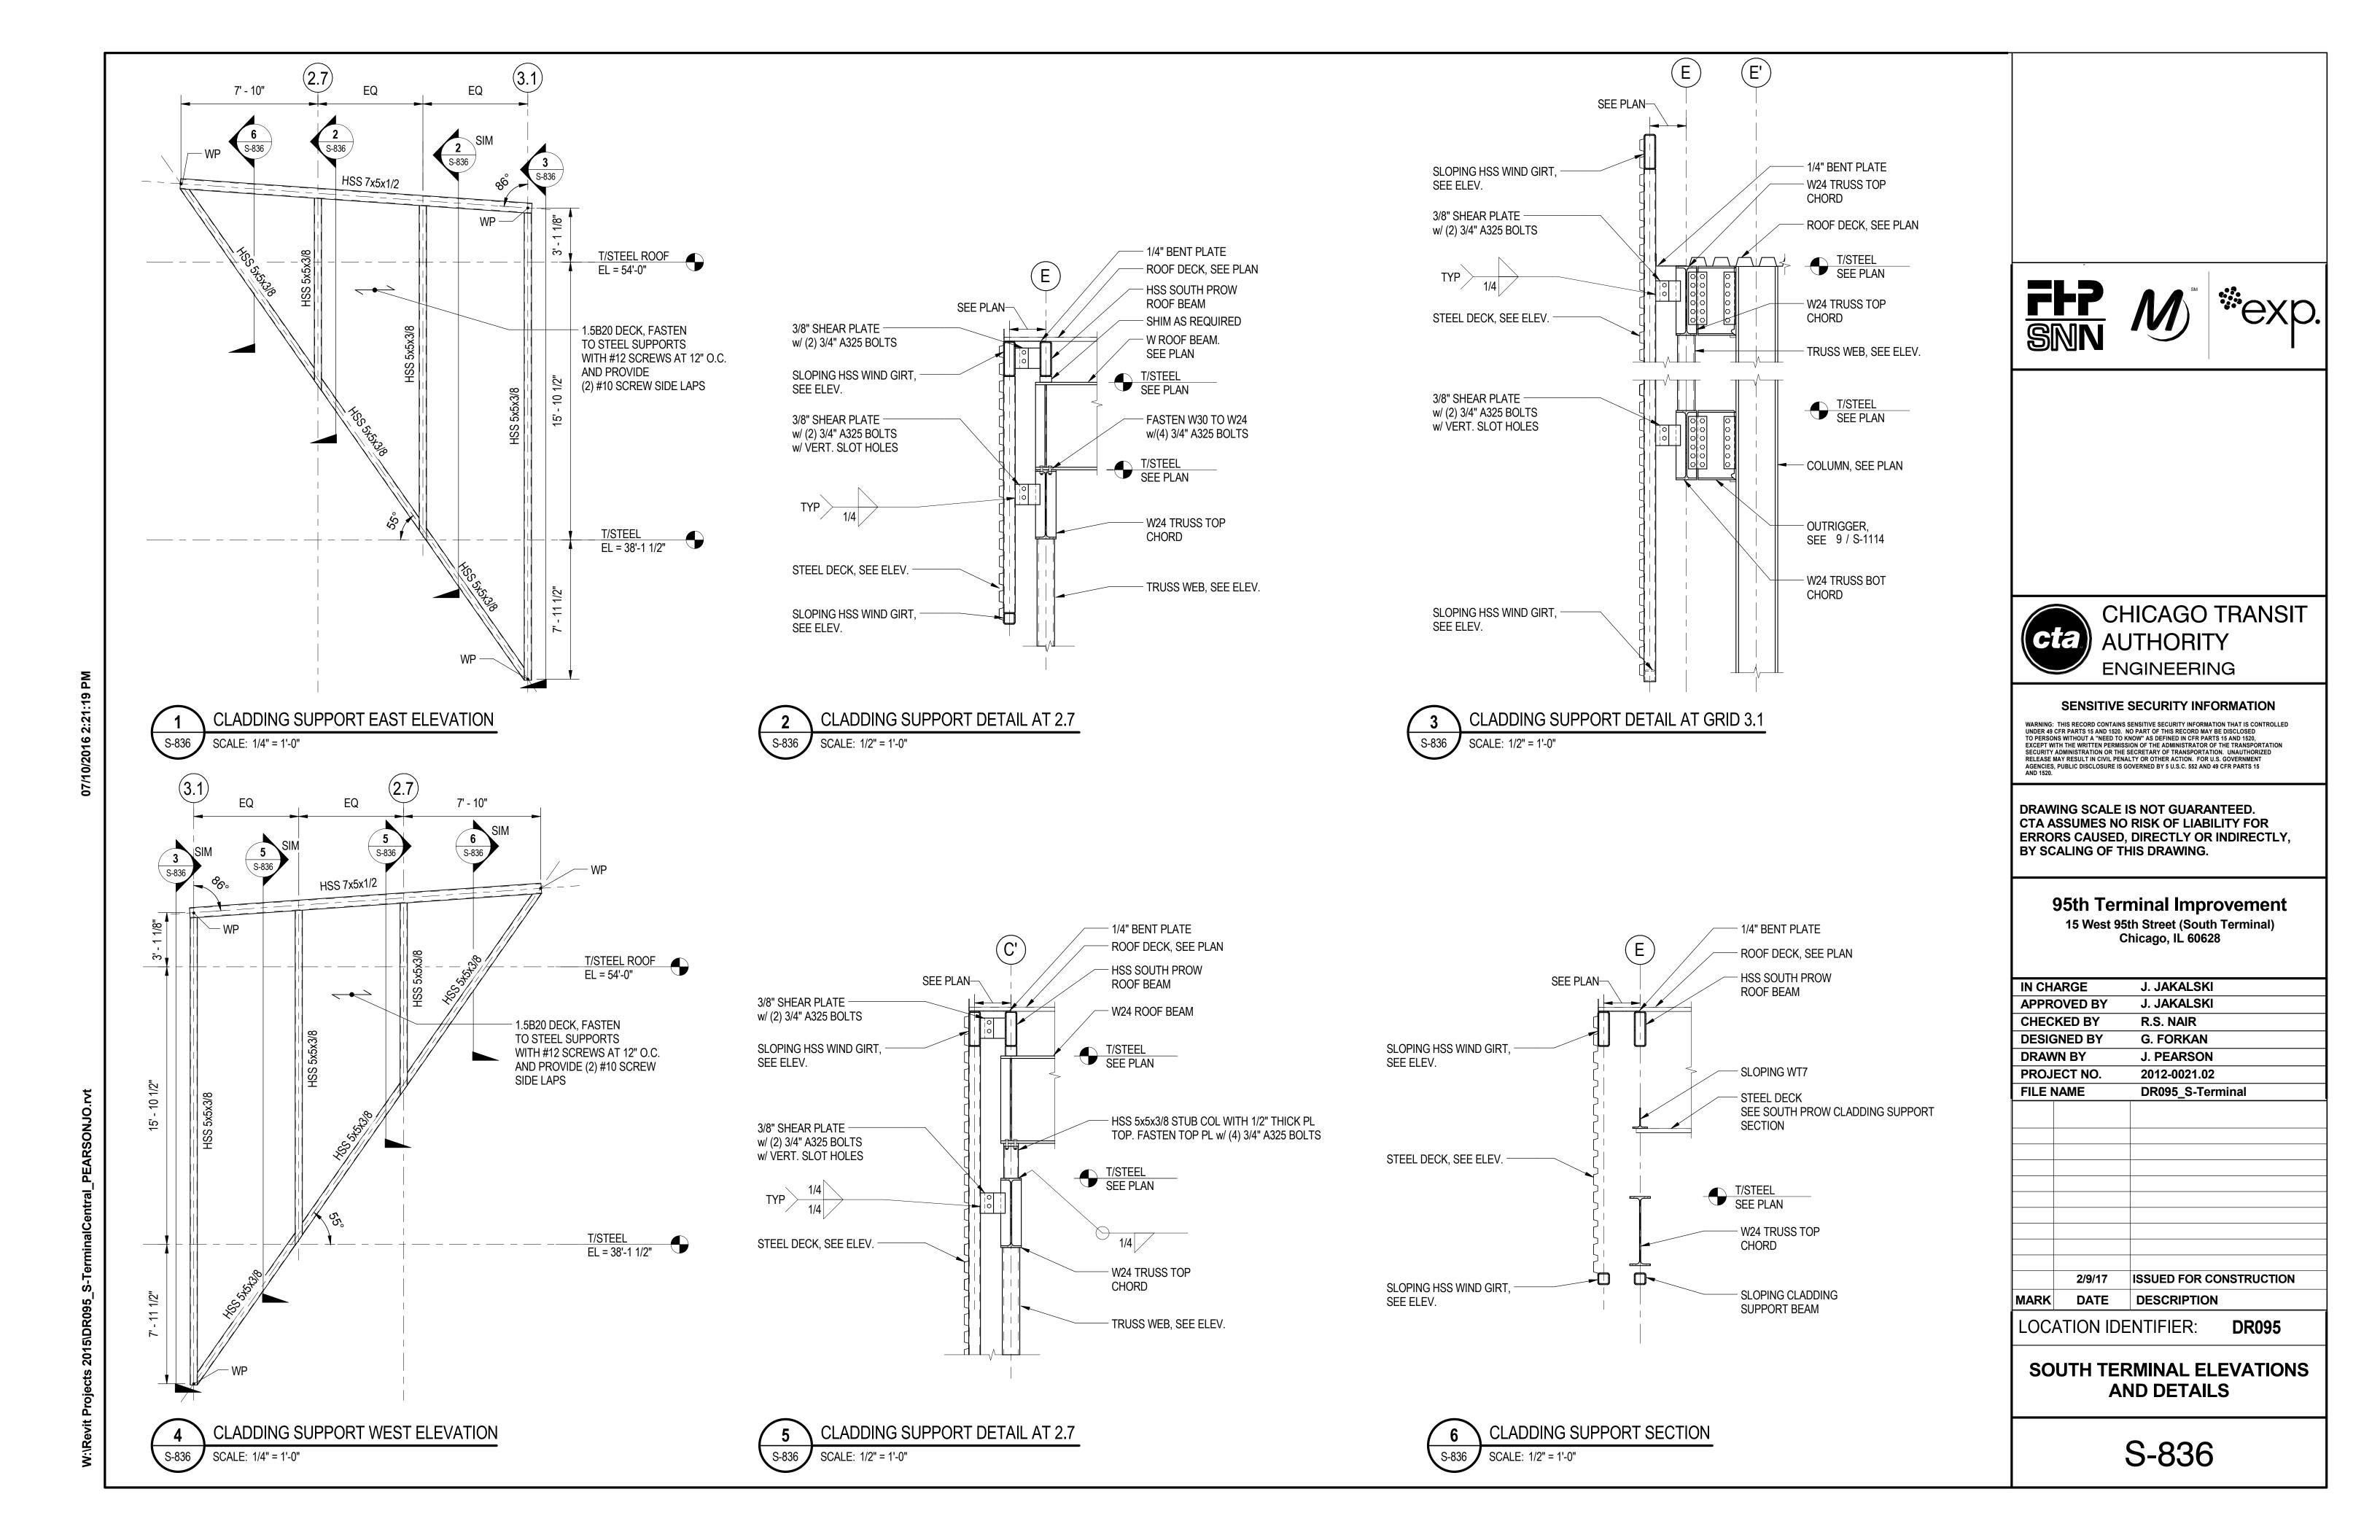
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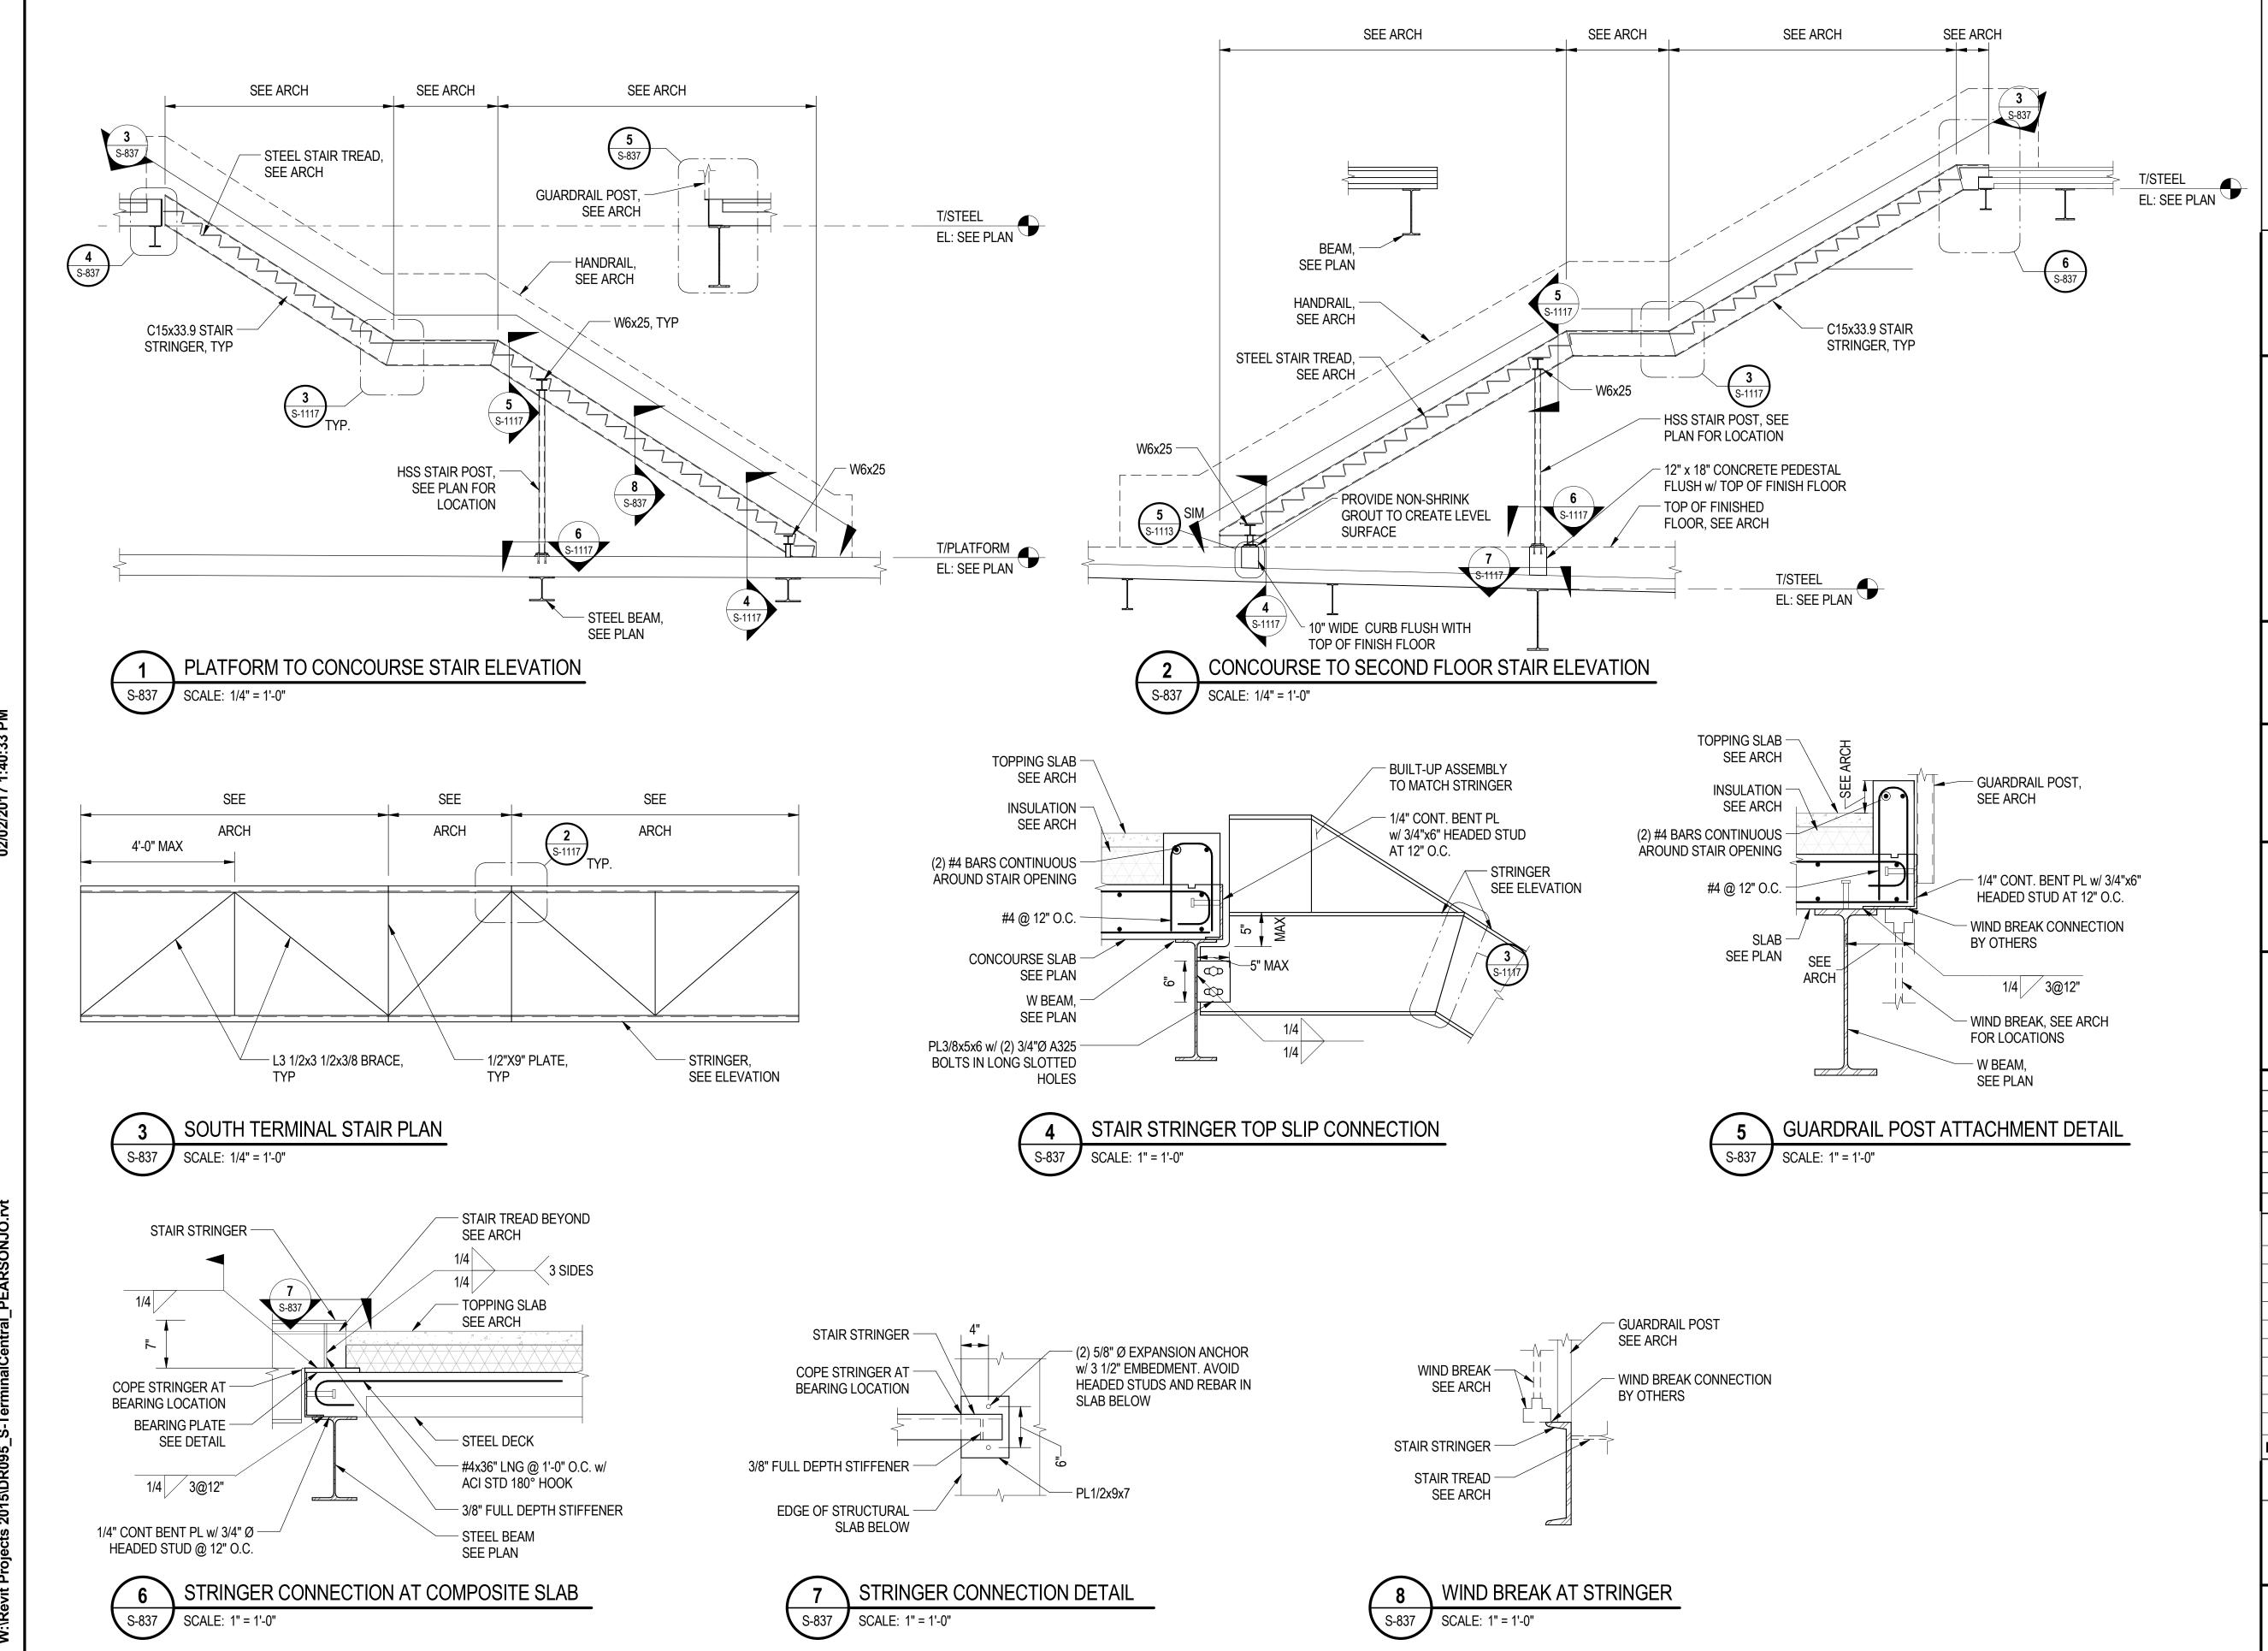
## 95th Terminal Improvement

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**AND DETAILS** 





FFP M \*exp



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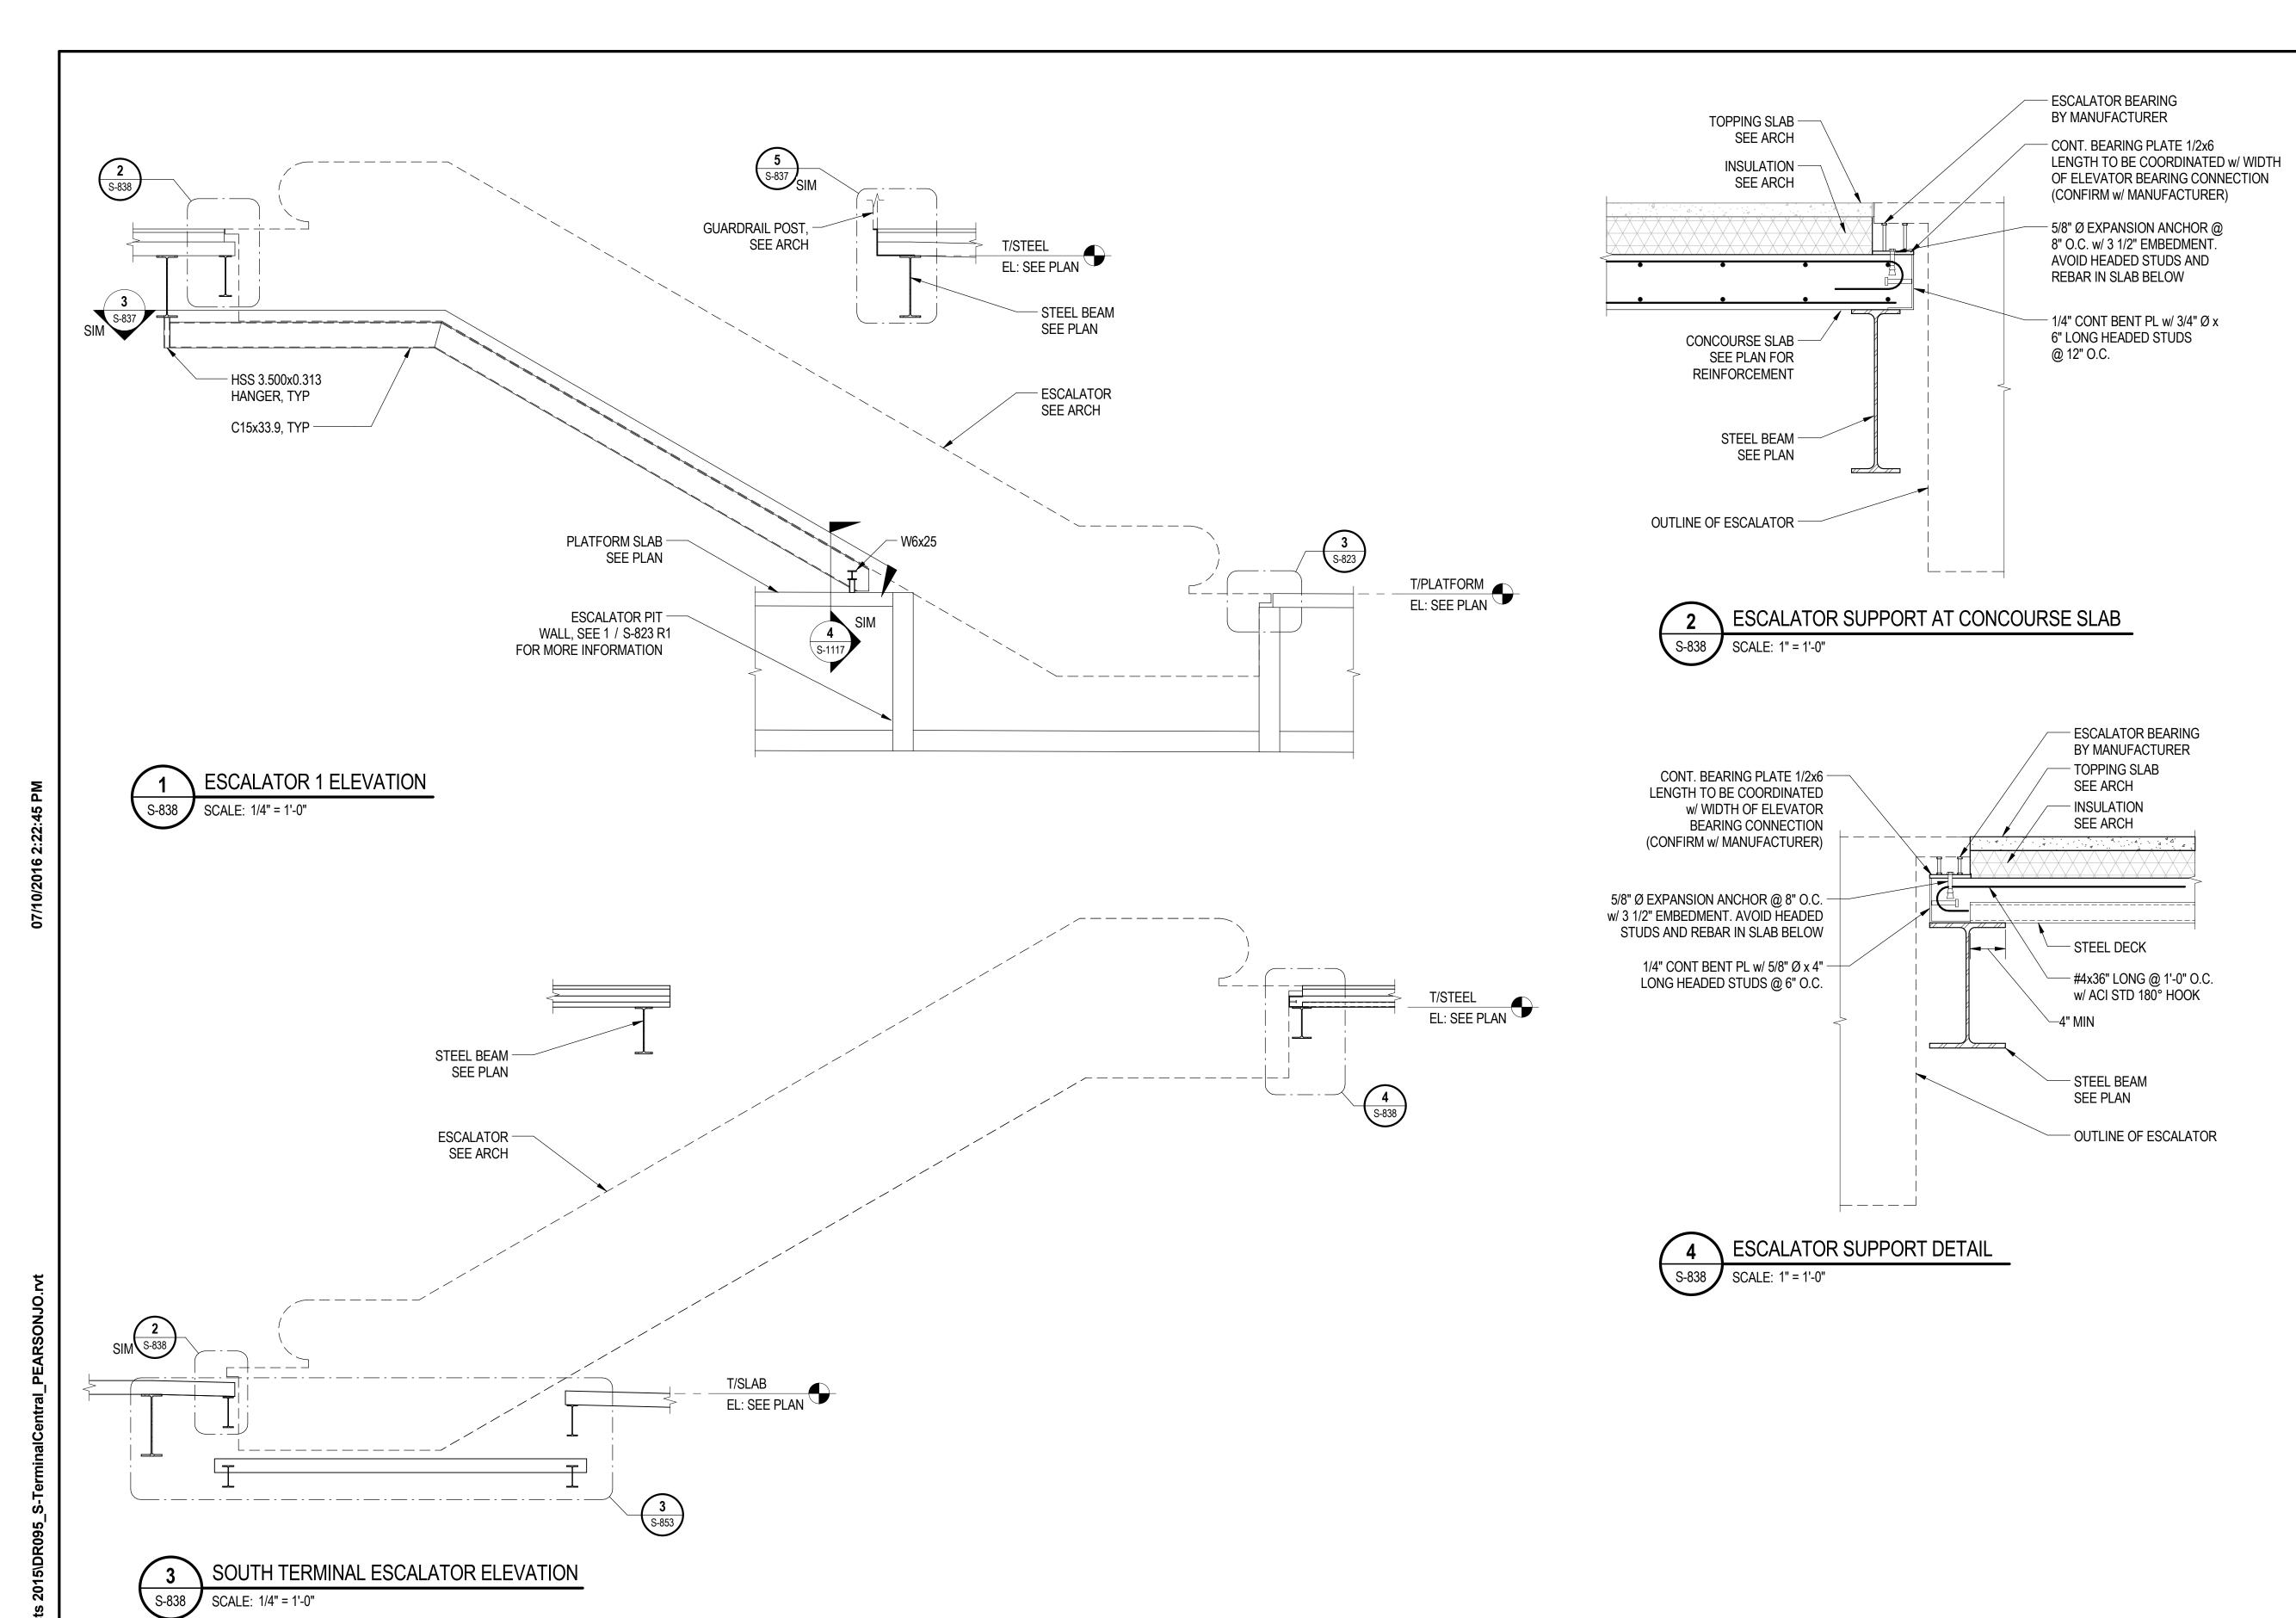
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## 95th Terminal Improvement 15 West 95th Street (South Terminal)

15 West 95th Street (South Terminal) Chicago, IL 60628

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SOUTH TERMINAL STAIR ELEVATION AND DETAILS





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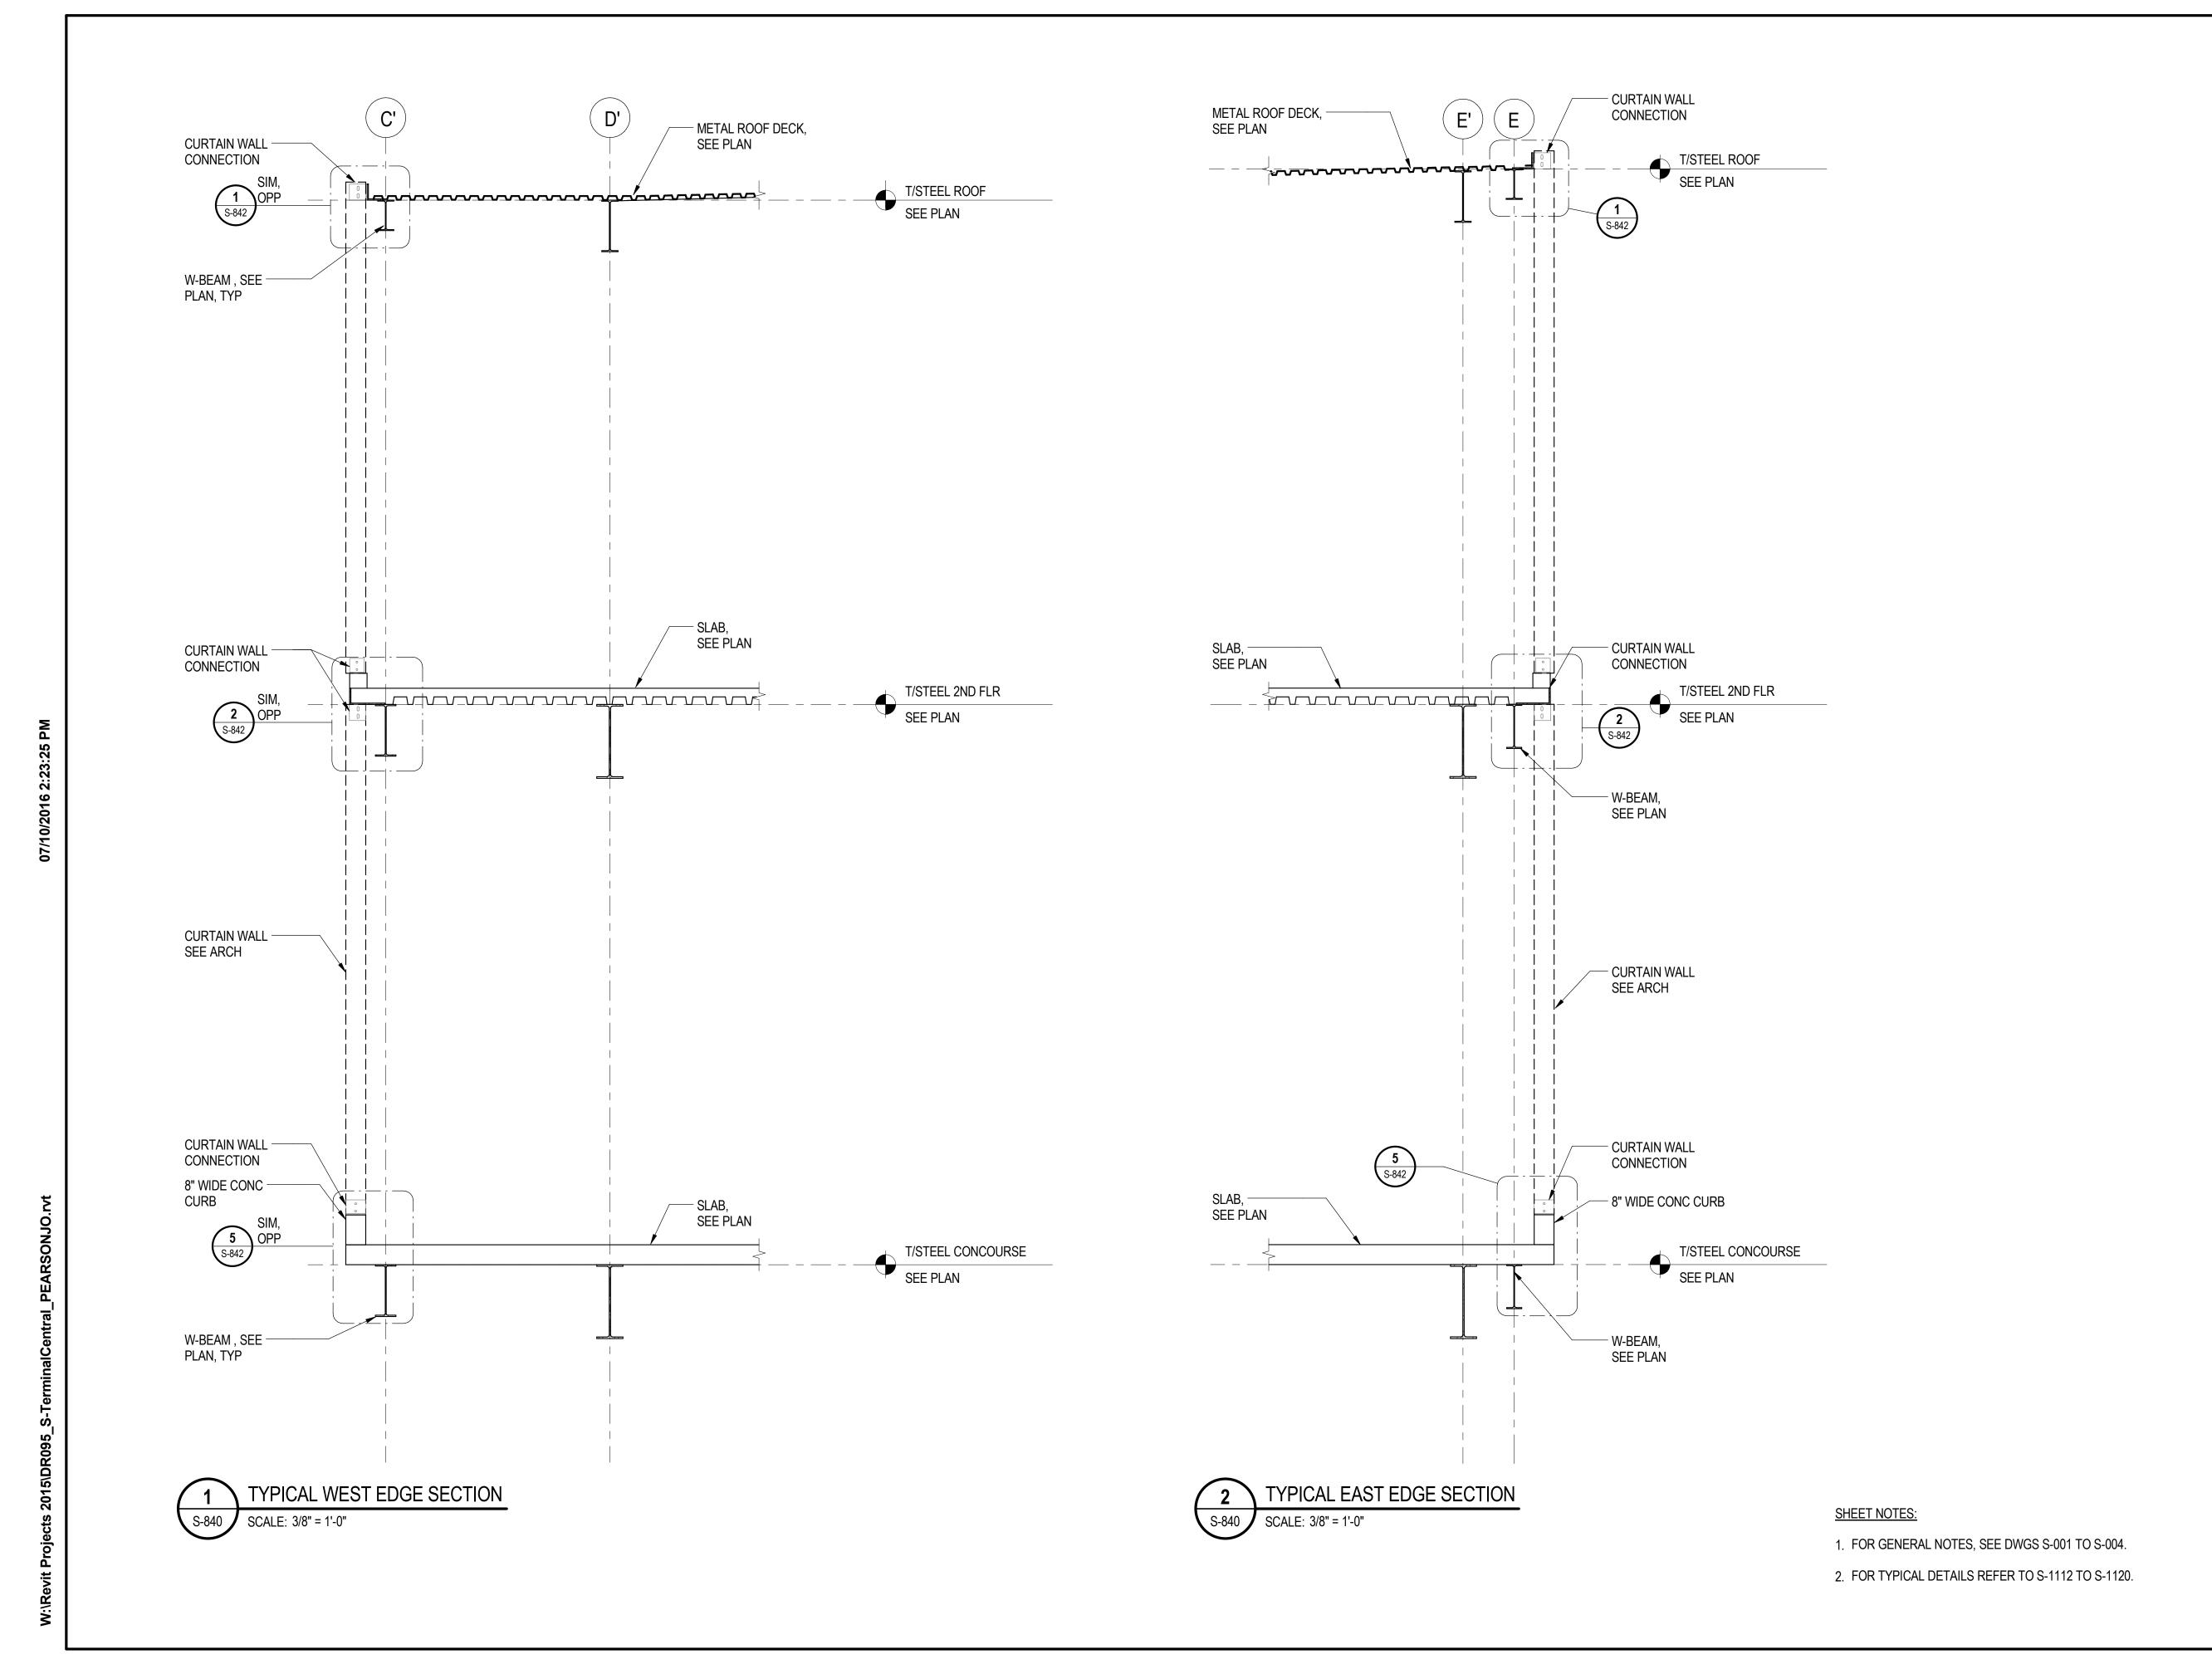
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**SOUTH TERMINAL ESCALATOR ELEVATION AND DETAILS** 



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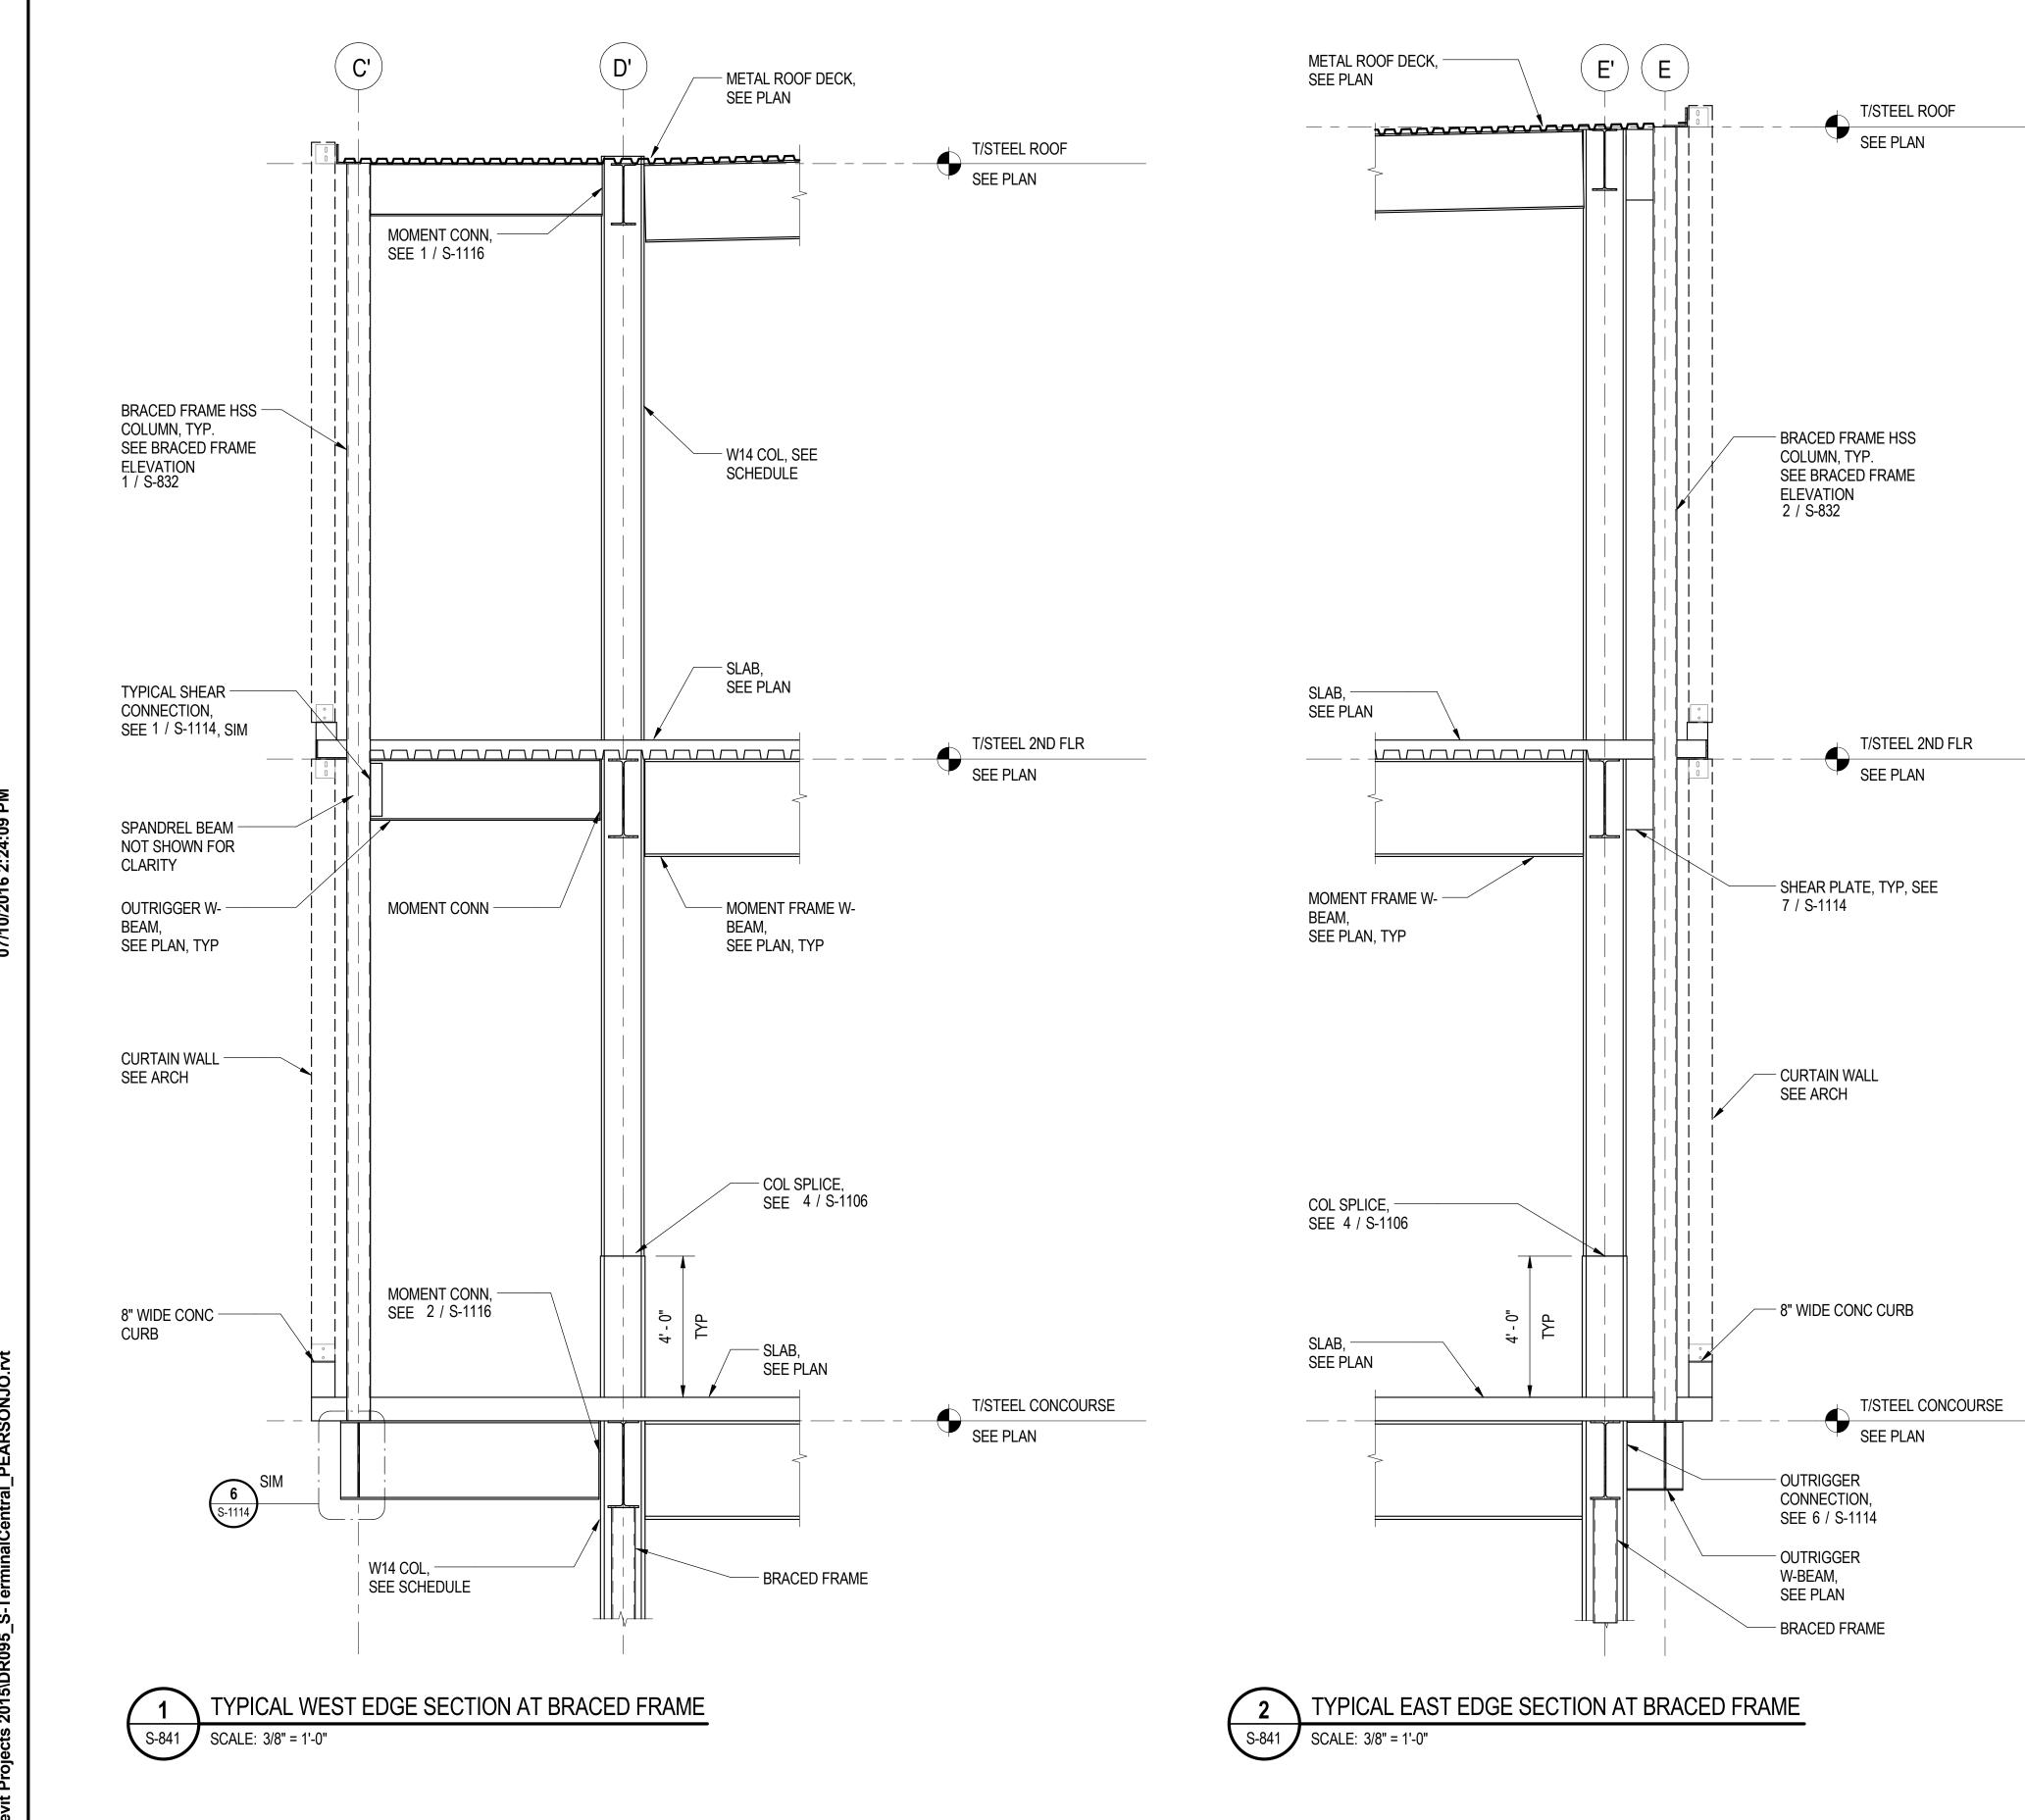
## 95th Terminal Improvement 15 West 95th Street (South Terminal)

15 West 95th Street (South Terminal) Chicago, IL 60628

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SOUTH TERMINAL SECTIONS AND DETAILS





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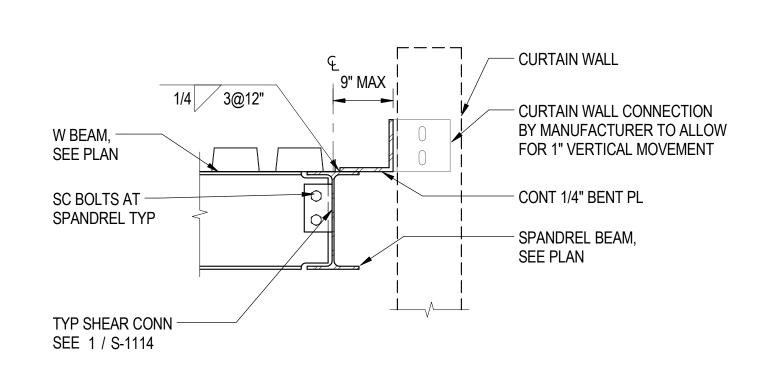
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SHEET NOTES:


1. FOR GENERAL NOTES, SEE DWGS S-001 TO S-004.

2. FOR TYPICAL DETAILS REFER TO S-1112 TO S-1120.


### SOUTH TERMINAL SECTIONS AND **DETAILS**




# SOUTH TERMINAL - CLADDING CONNECTION AT ROOF S-842 SCALE: 1" = 1'-0"

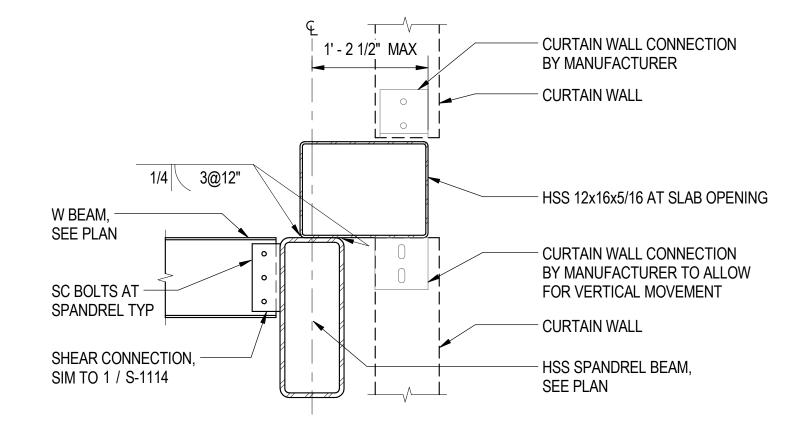


SOUTH TERMINAL - CLADDING CONNECTION AT HSS
SCALE: 1" = 1'-0"

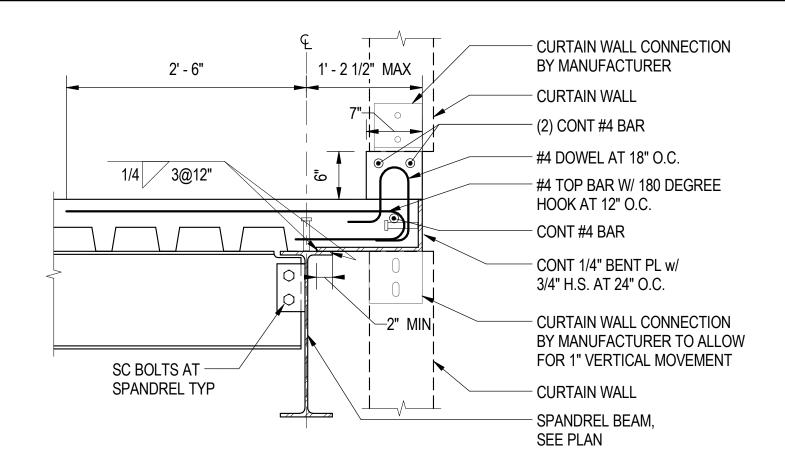

# SOUTH TERMINAL - CLADDING CONNECTION AT LEVEL 02 SCALE: 1" = 1'-0"

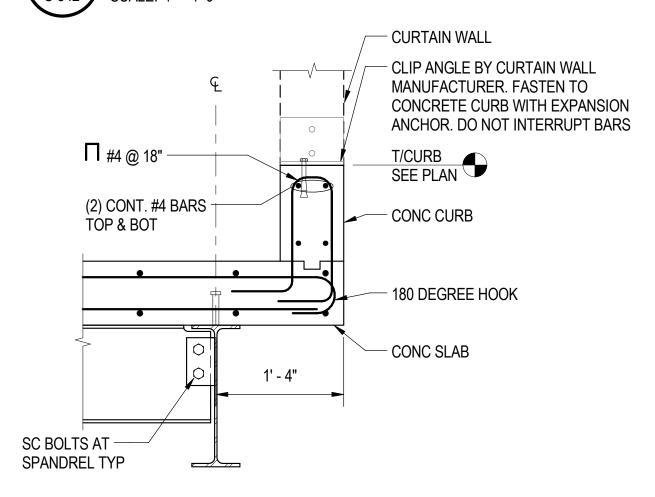

SOUTH TERMINAL - CLADDING CONNECTION AT LEVEL 01
SCALE: 1" = 1'-0"

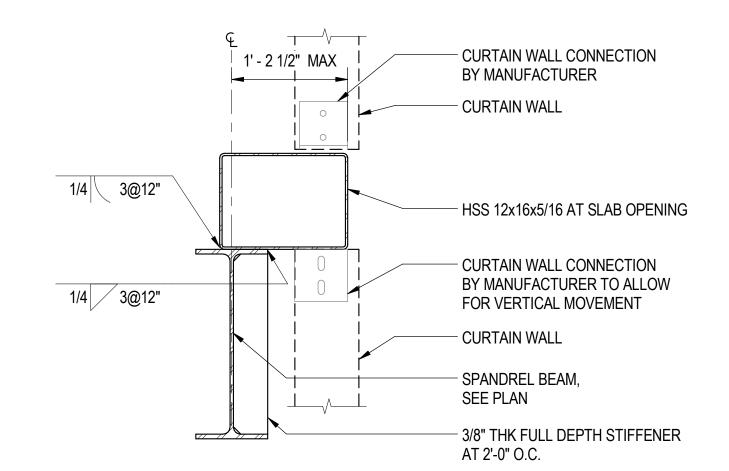

SOUTH TERMINAL - CLADDING CONNECTION AT OPENING
S-842 SCALE: 1" = 1'-0"



#### SENSITIVE SECURITY INFORMATION

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### 95th Terminal Improvement

15 West 95th Street (South Terminal) Chicago, IL 60628

IN CH	ARGE	J. JAKALSKI
APPR	OVED BY	J. JAKALSKI
CHEC	KED BY	R.S. NAIR
DESIG	NED BY	G. FORKAN
DRAW	/N BY	J. PEARSON
PROJI	ECT NO.	2012-0021.02
FILE N	IAME	DR095_S-Terminal
	2/9/17	ISSUED FOR CONSTRUCTION
MARK	DATE	DESCRIPTION


LOCATION IDENTIFIER:

SOUTH TERMINAL SECTIONS AND DETAILS


S-842

#### SHEET NOTES:


- 1. FOR GENERAL NOTES, SEE DWGS S-001 TO S-004.
- 2. FOR TYPICAL DETAILS REFER TO S-1112 TO S-1120.

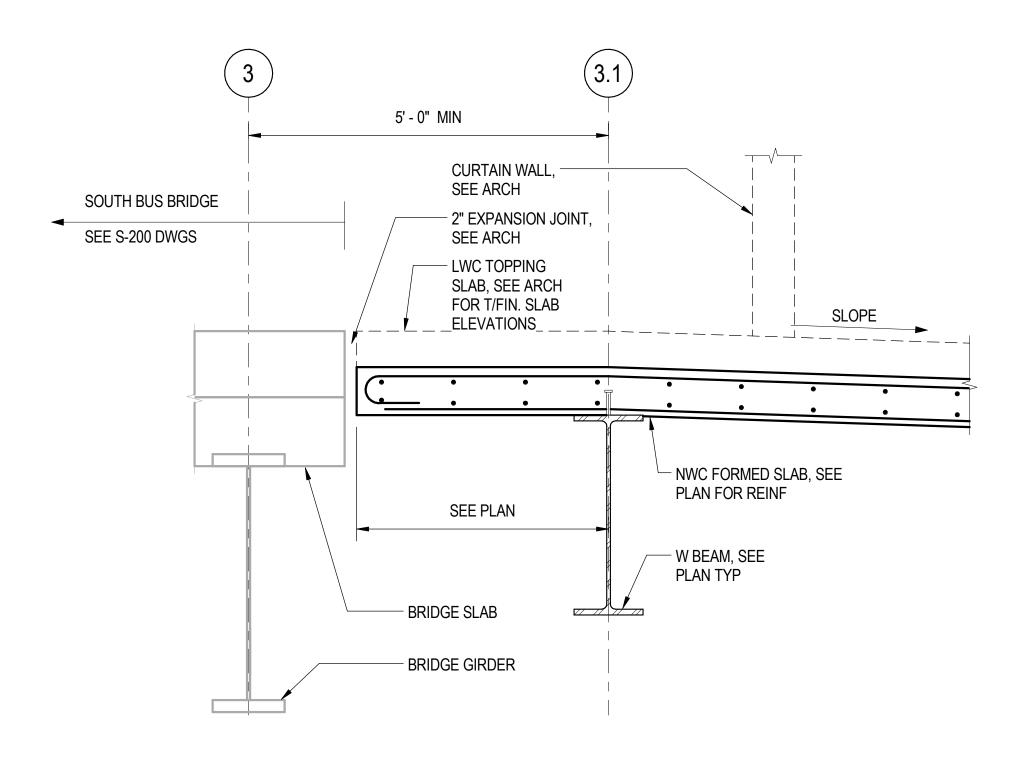


SOUTH BUS BRIDGE/BUILDING INTERFACE

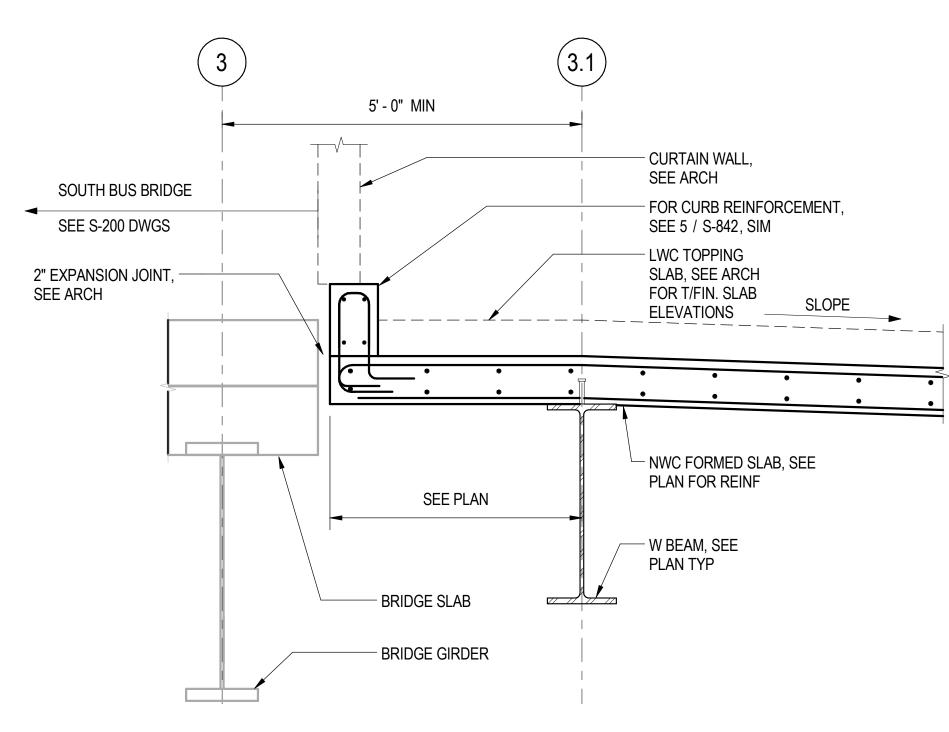

SOUTH BUS BRIDGE/BUILDING INTERFACE AT CURB SCALE: 3/4" = 1'-0"

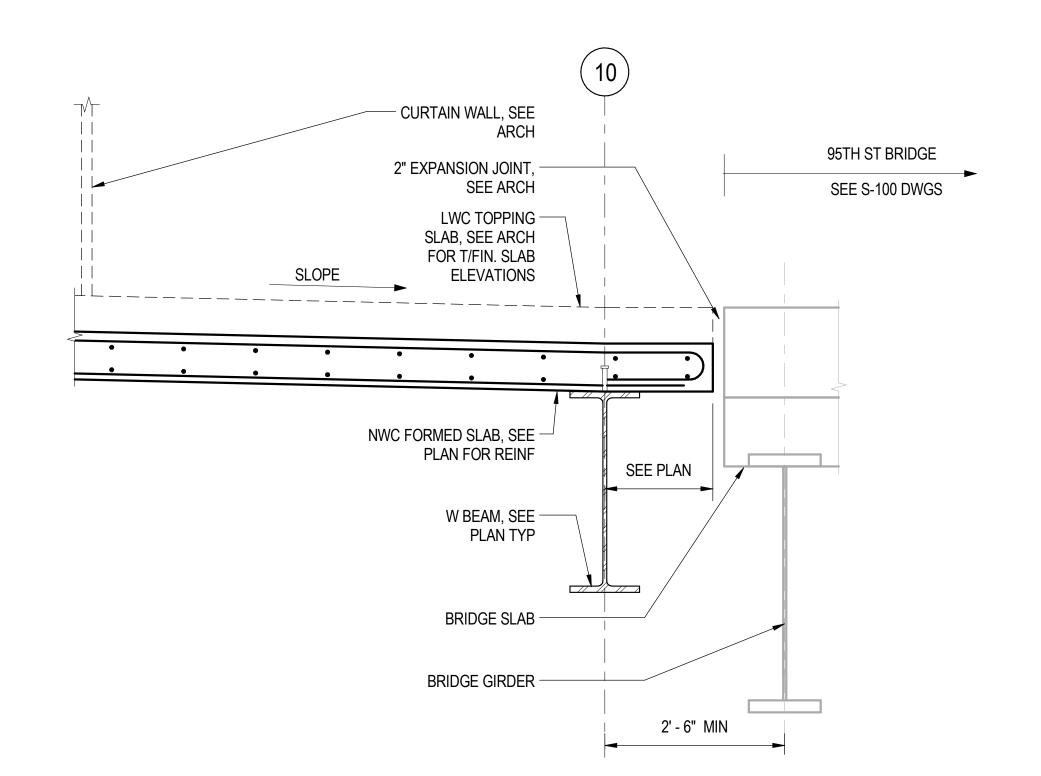

95TH STREET BRIDGE/SOUTH TERMINAL INTERFACE

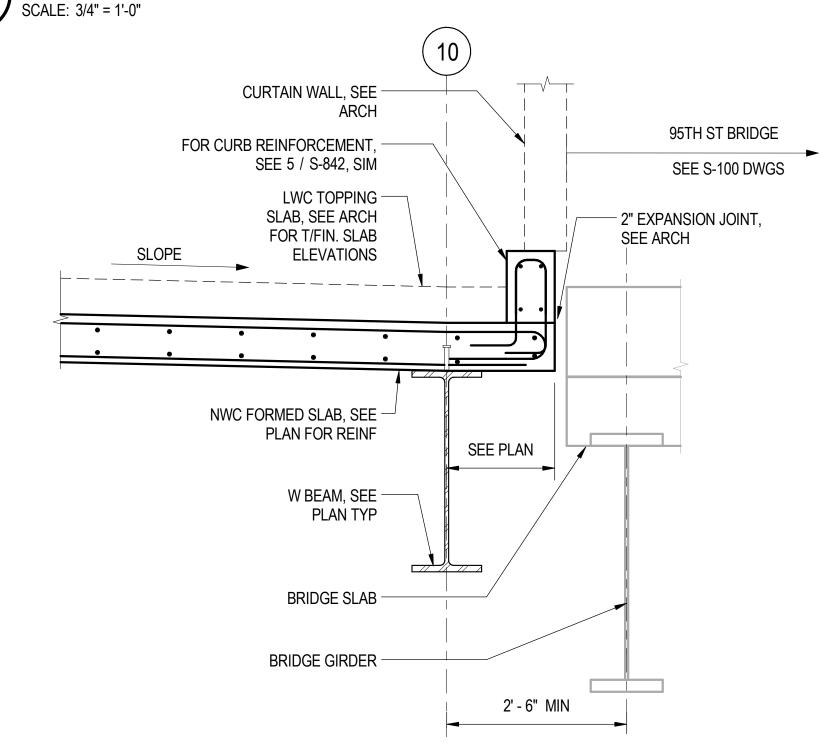

95TH STREET BRIDGE/SOUTH TERMINAL INTERFACE AT CURB SCALE: 3/4" = 1'-0"

**SHEET NOTES:** 

- 1. FOR GENERAL NOTES, SEE DWGS S-001 TO S-004.
- 2. FOR TYPICAL DETAILS REFER TO S-1112 TO S-1120.
- 3. FOR TOP OF FINISHED FLOOR ELEVATION AND INFORMATION REGARDING SLOPED SLABS, SEE PLANS AND ARCH DWGS.









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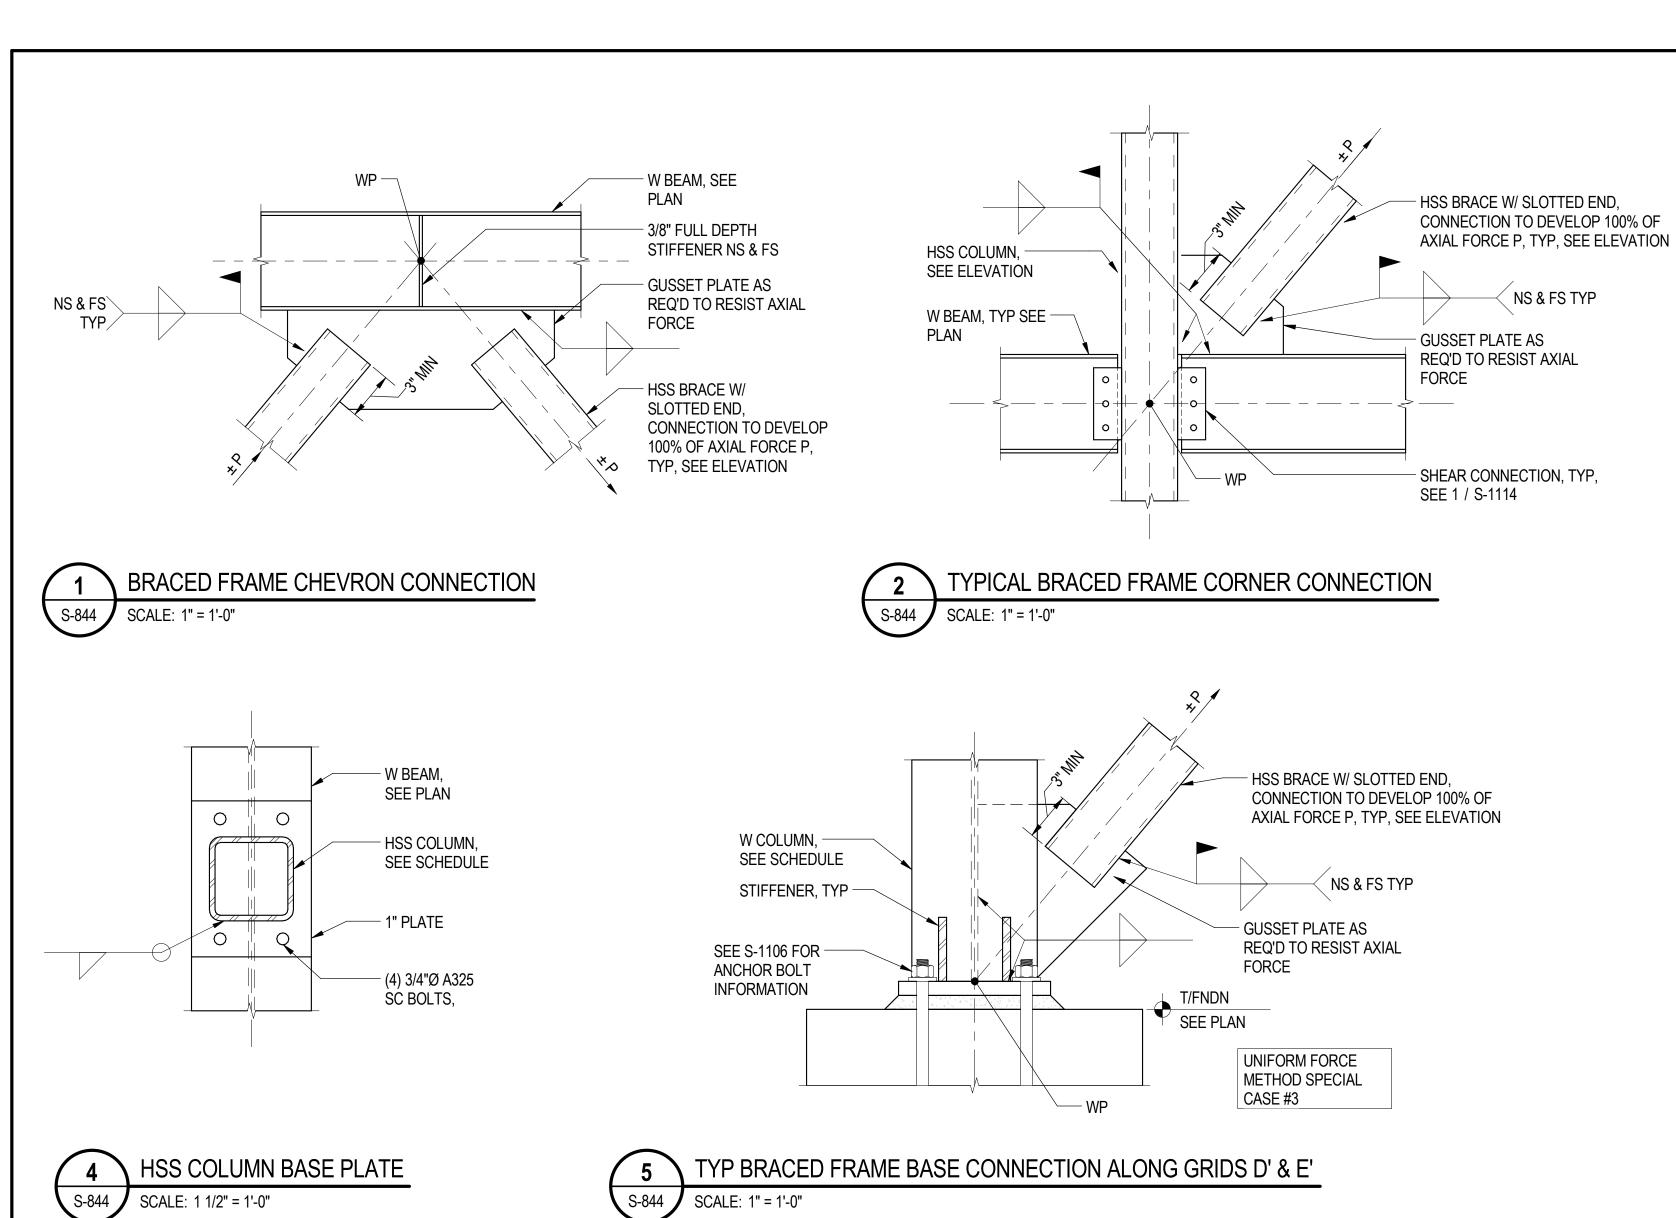
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KED BY	R.S. NAIR
NED BY	G. FORKAN
N BY	M. DONAHUE
CT NO.	2012-0021.02
AME	DR095_S-Terminal
2/9/17	ISSUED FOR CONSTRUCTION
DATE	DESCRIPTION
	NED BY N BY CT NO. AME

LOCATION IDENTIFIER.

SOUTH TERMINAL SECTIONS AND **DETAILS** 










- 1. FOR GENERAL NOTES, SEE DWGS S-001 TO S-004.
- 2. BRACE CONNECTIONS TO BE DESIGNED BY LICENSED SE IN THE STATE OF IL TO DEVELOP 100% OF INDICATED BRACE FORCES.
- ALL INDICATED BRACE FORCES ARE FACTORED AXIAL LOADS.
  FORCES TO BE CONSIDERED EITHER TENSION OR
  COMPRESSION.
- 4. BRACED FRAME JOINTS SHALL BE DESIGNED USING THE AISC UNIFORM FORCE METHOD TO AVOID MOMENTS AT CONNECTION INTERFACES OR EQUIVALENT UNLESS NOTED OTHERWISE.

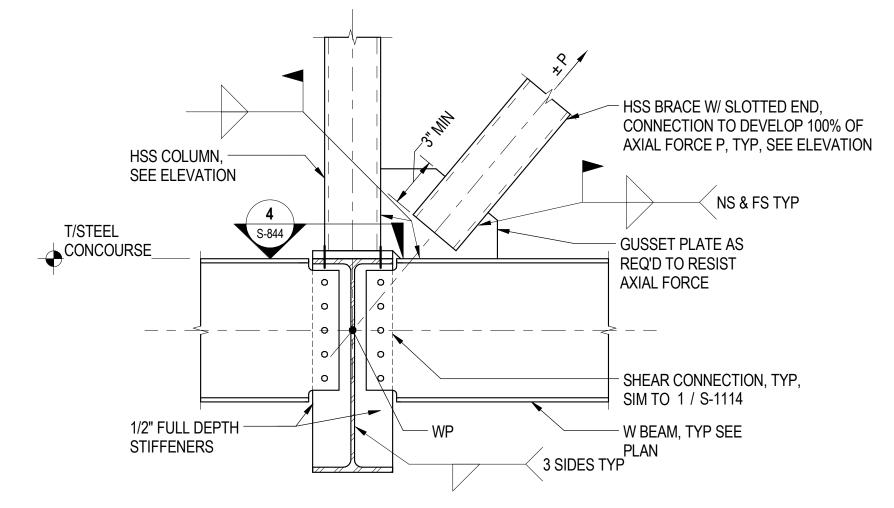

BRACED FRAME CORNER CONN. AT CONCOURSE

S-844 SCALE: 1" = 1'-0"







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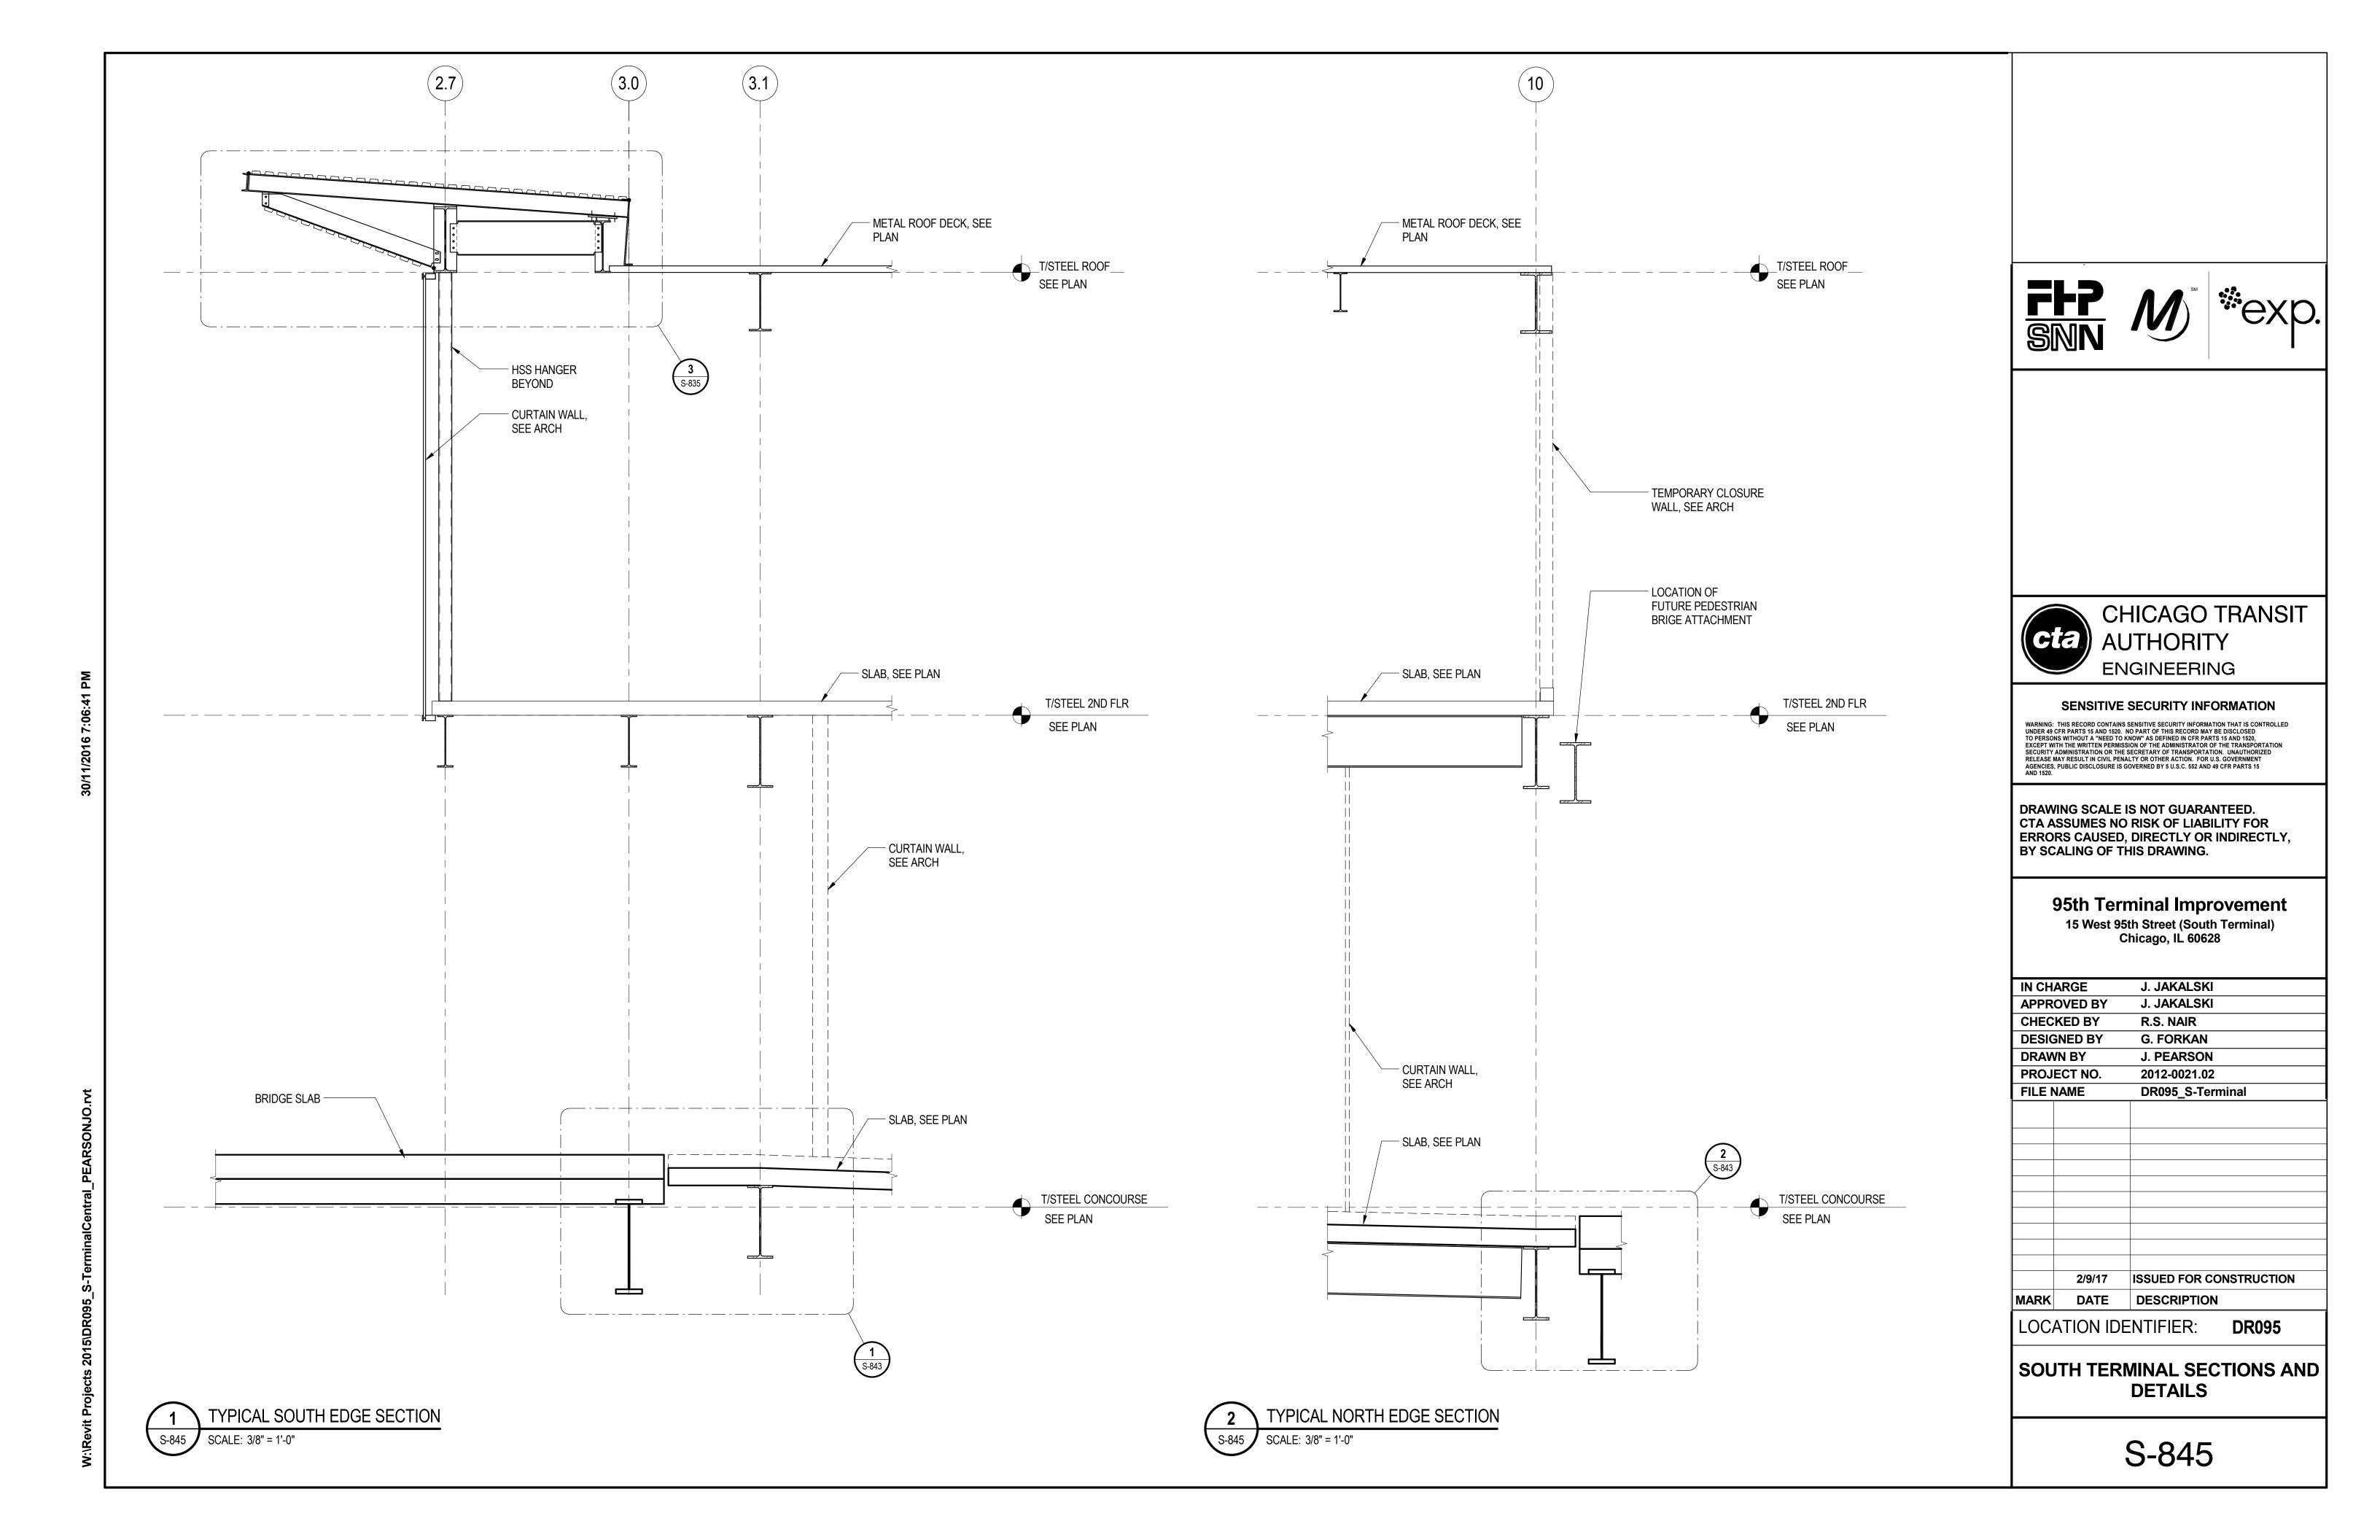
J. JAKALSKI


IN CHARGE


APPR	OVED BY	J. JAKALSKI
CHEC	KED BY	R.S. NAIR
DESIG	NED BY	G. FORKAN
DRAWN BY		J. PEARSON
PROJI	ECT NO.	2012-0021.02
FILE N	IAME	DR095_S-Terminal
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MARK	2/9/17 DATE	DESCRIPTION

LOCATION IDENTIFIER: **DR095** 

SOUTH TERMINAL SECTIONS AND DETAILS



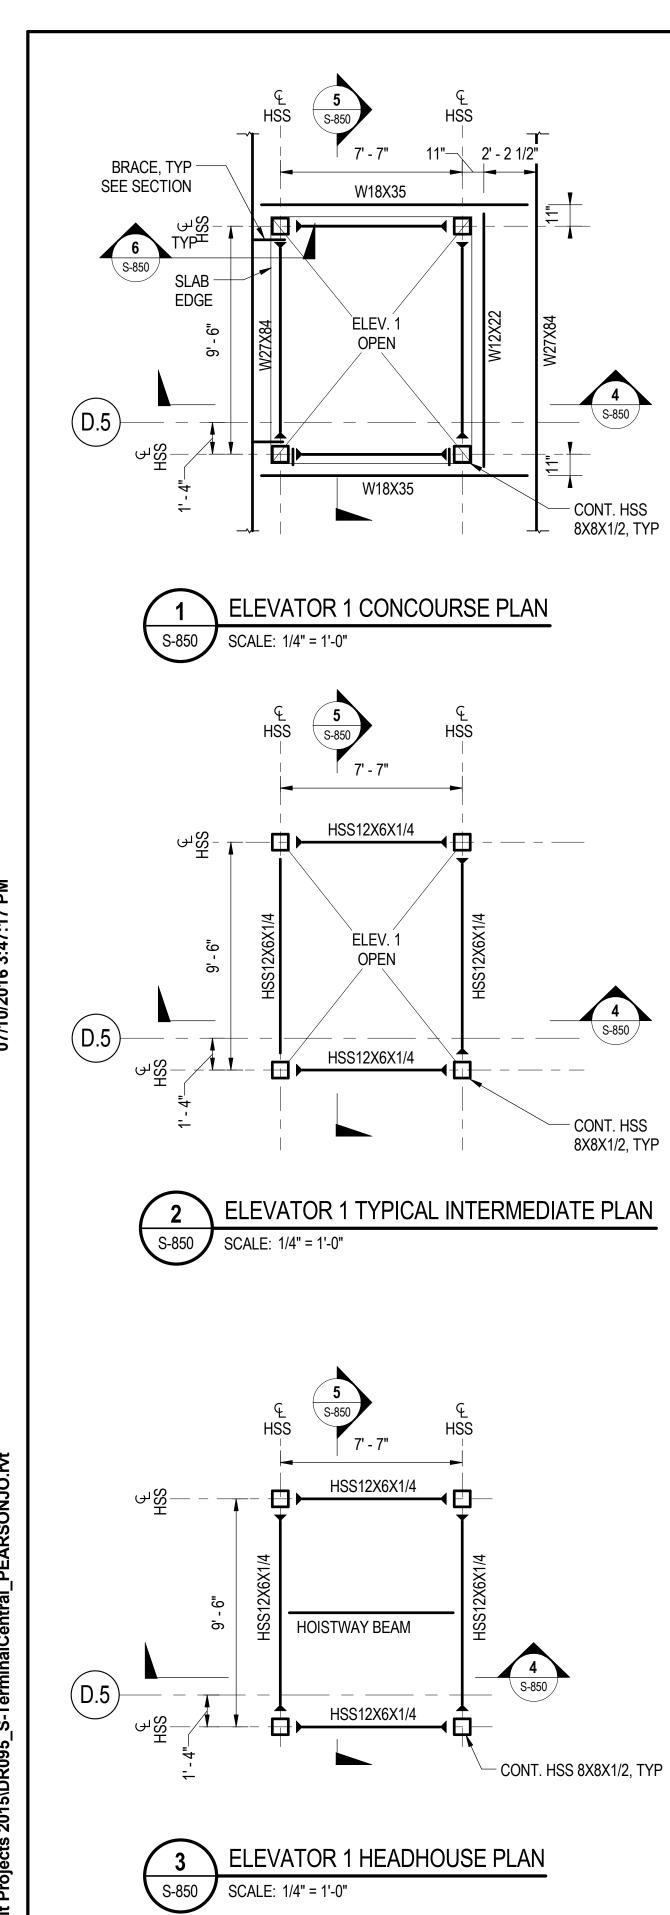

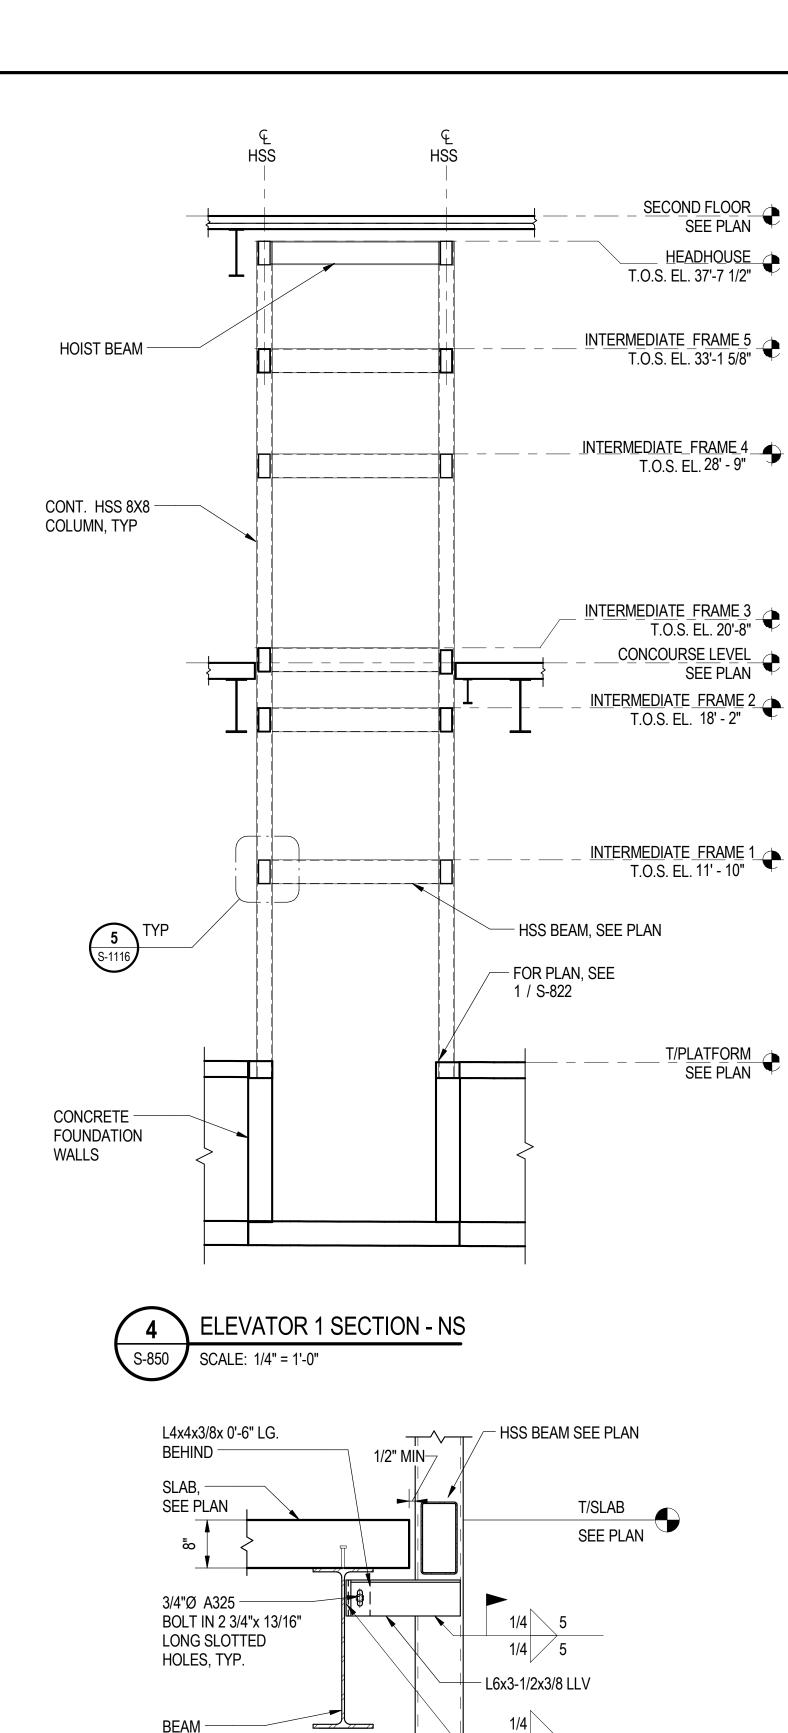


SEE PLAN

SEE PLAN

CONT. HSS 8X8,

**BRACING DETAIL** 

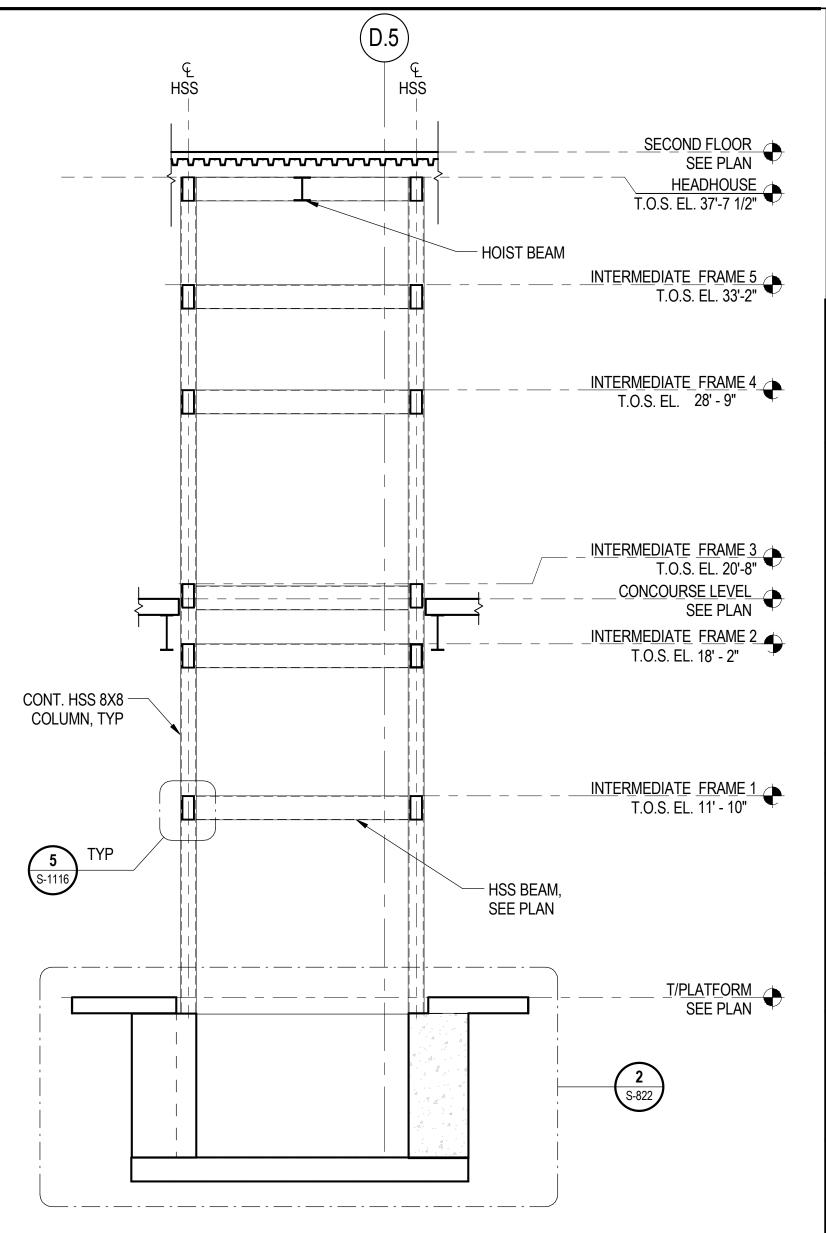

**ELEVATOR 1 SECTION - EW** 

### SHEET NOTES:

- 1. FOR GENERAL NOTES, SEE DWGS S-001 TO S-004.
- 2. FOR TYPICAL DETAILS REFER TO S-1112 TO S-1120.
- 3. HOISTWAY BEAM AND THE CONNECTIONS TO STRUCTURAL STEEL SHALL BE DESIGNED TO RESIST A CONCENTRATED LOAD OF 7,500 LBS LOCATED AT MID-SPAN IN ADDITION TO DEAD LOAD. NUMBER OF HOIST BEAMS, THEIR LOCATION AND ELEVATION SHALL BE COORDINATED WITH ELEVATOR MANUFACTURER REQUIREMENTS.
- 4. CONTRACTOR TO VERIFY ALL DIMENSIONS SHOWN BASED ON ELEVATOR MANUFACTURER REQUIREMENTS PRIOR TO PROCEEDING WITH FABRICATION OF STRUCTURAL STEEL FRAMING.
- 5. SEE S-809 FOR TYPICAL ROOF CONSTRUCTION.





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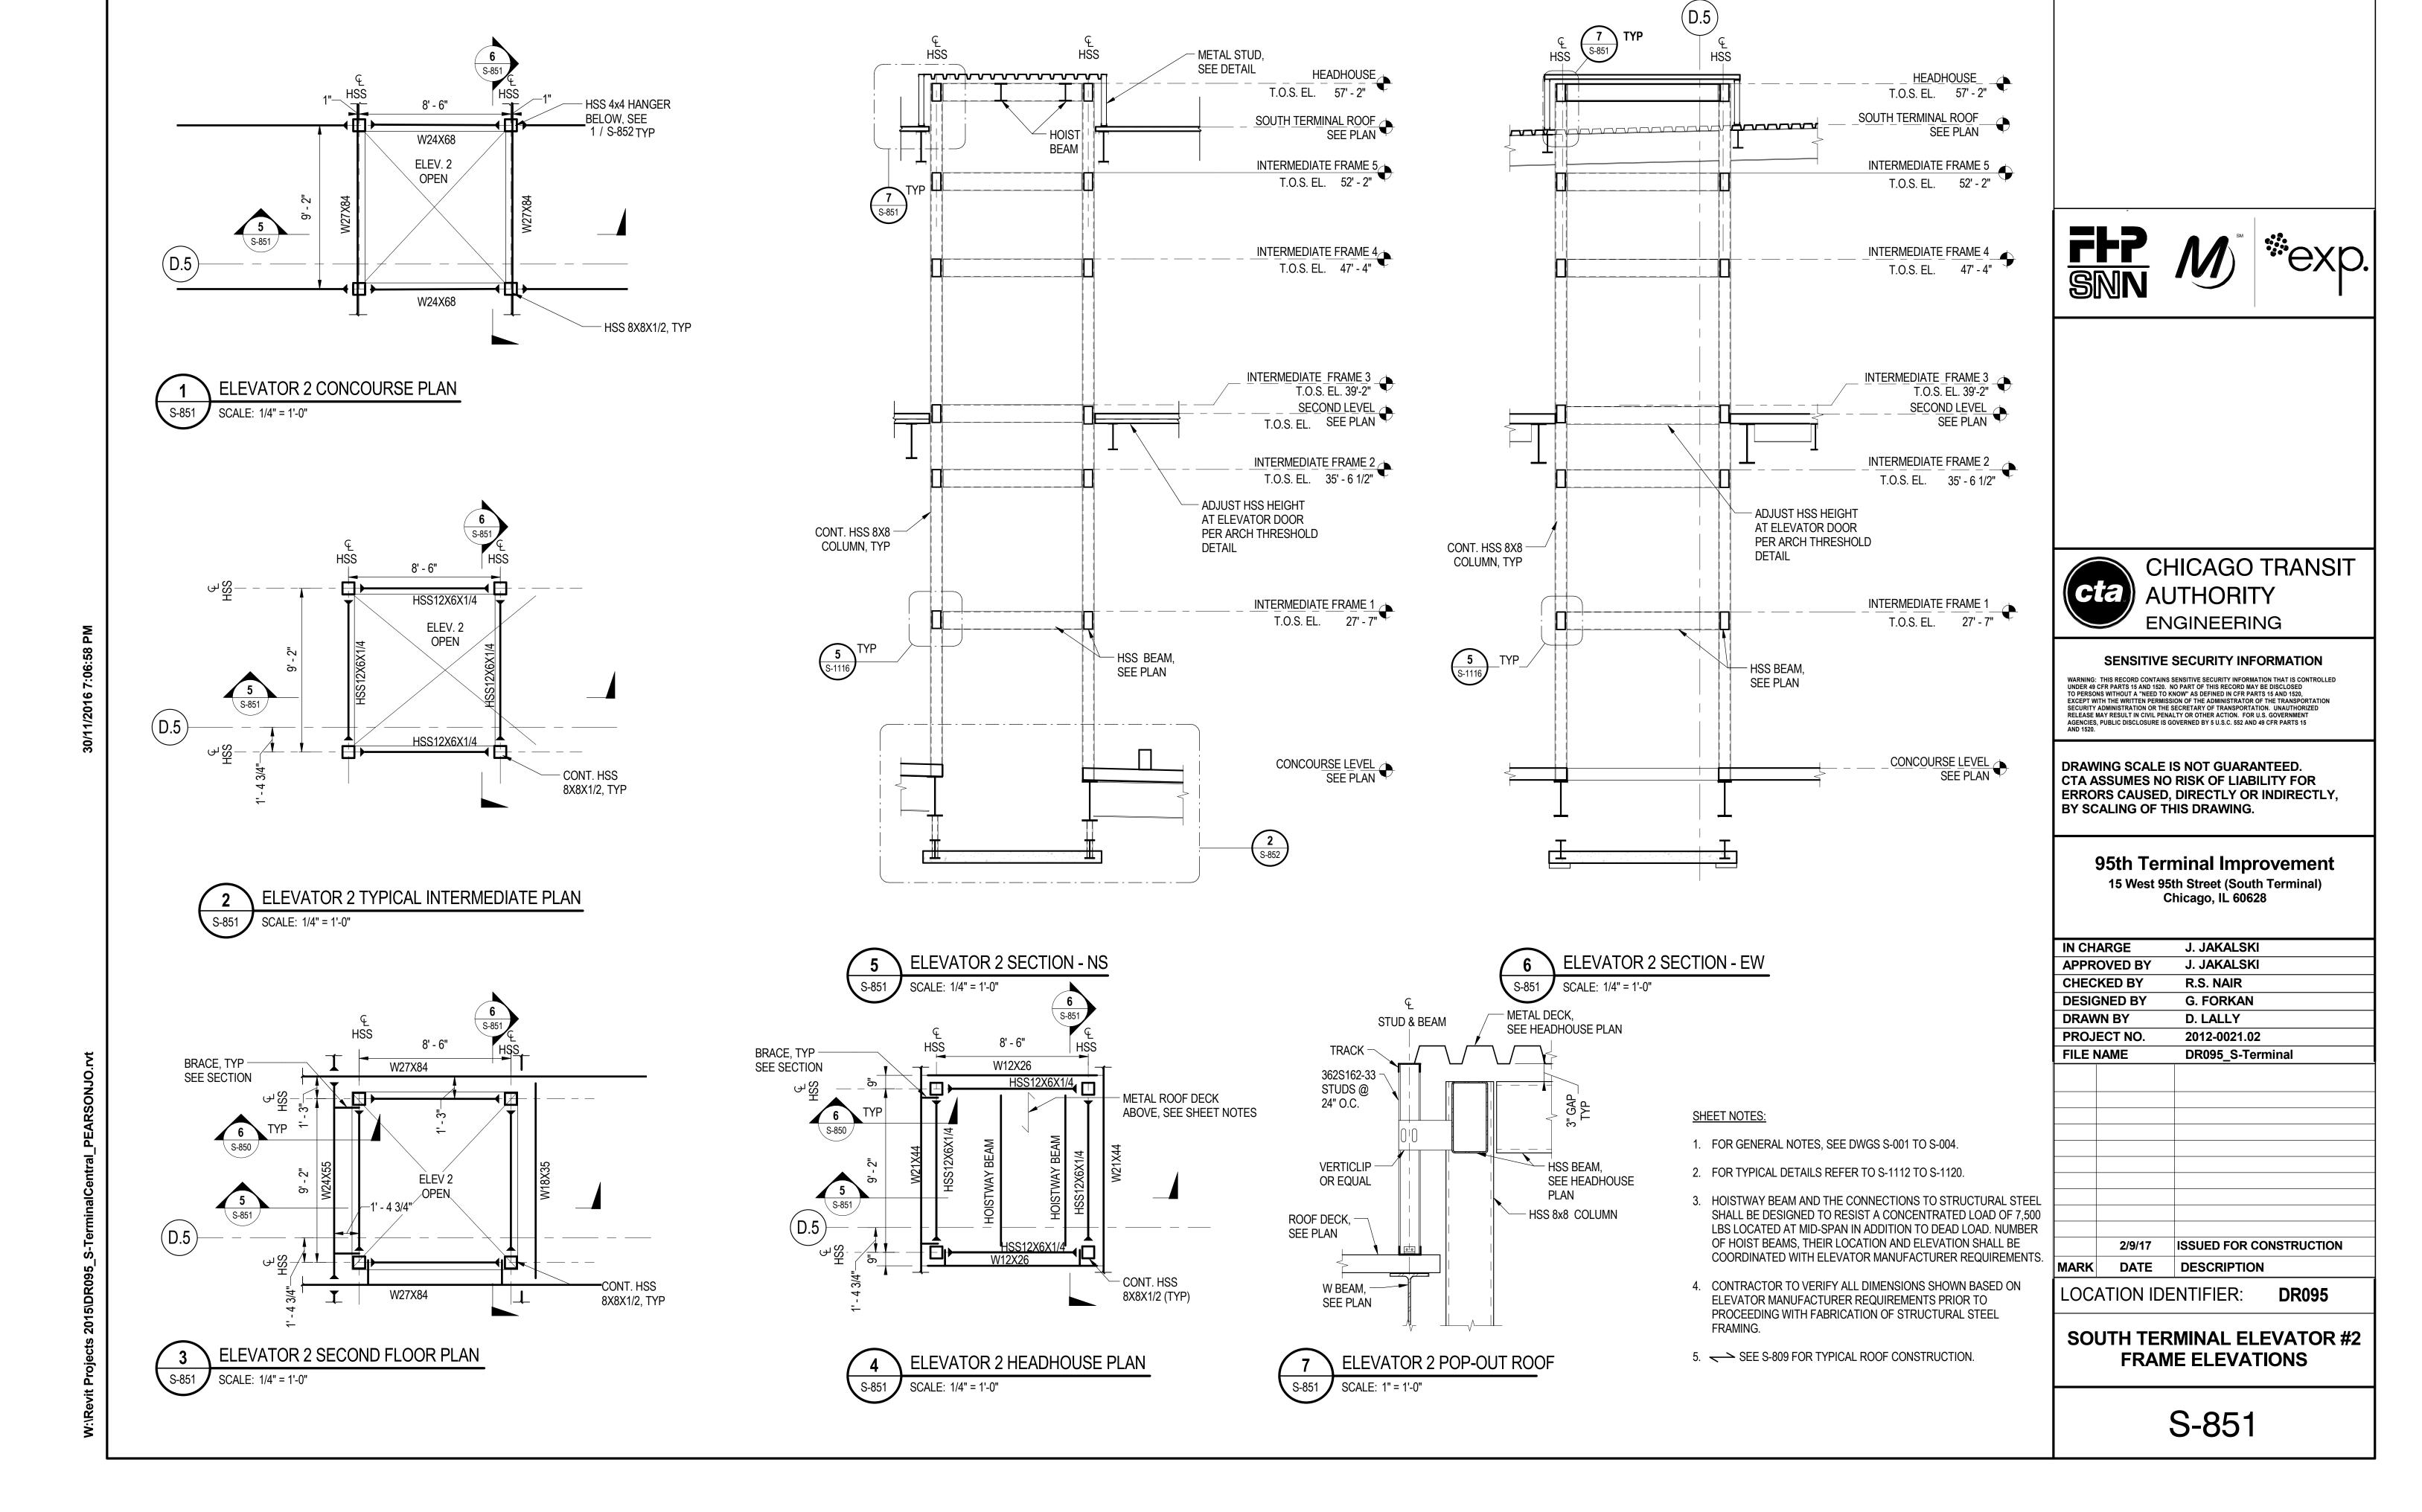
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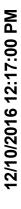
## 95th Terminal Improvement

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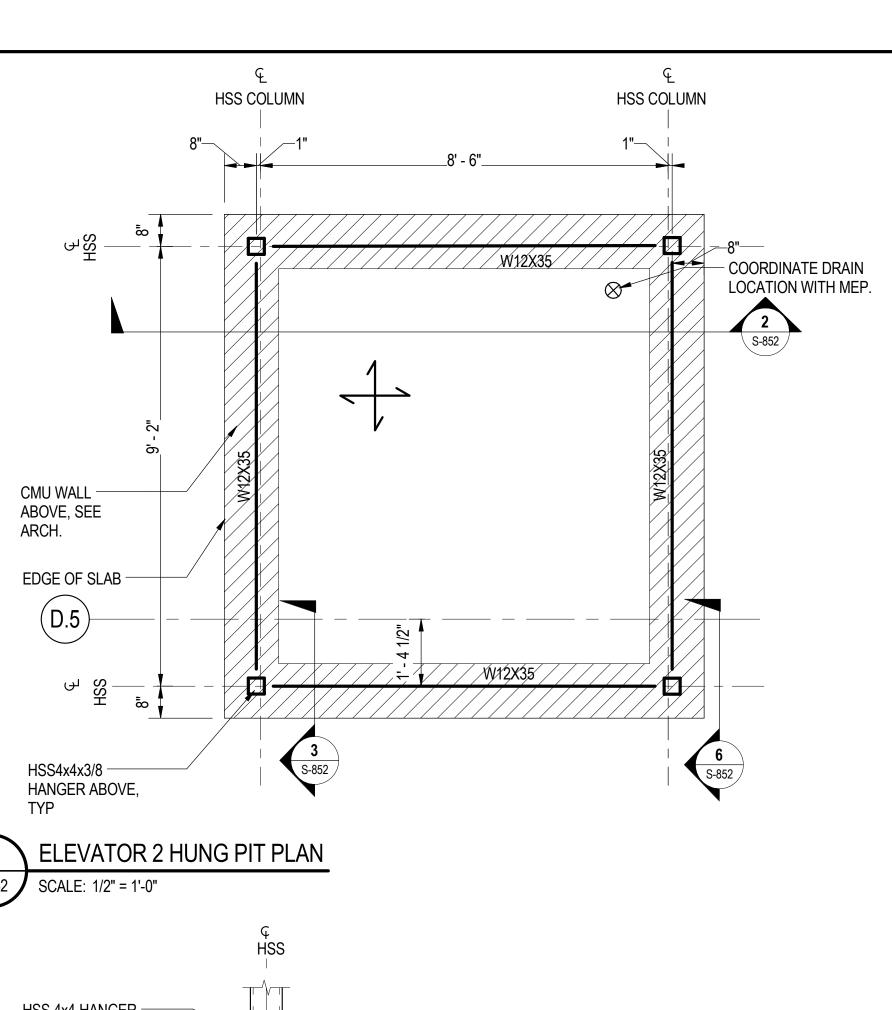
IN CHAR	GE	J. JAKALSKI
APPROVE	ED BY	J. JAKALSKI
CHECKE	D BY	R.S. NAIR
DESIGNE	D BY	G. FORKAN
DRAWN E	3Y	D. LALLY
PROJEC1	ΓNO.	2012-0021.02
FILE NAM	IE	DR095_S-Terminal
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LOCAT	ION IDE	NTIFIER: <b>DR095</b>


**SOUTH TERMINAL ELEVATOR #1 FRAME ELEVATIONS** 












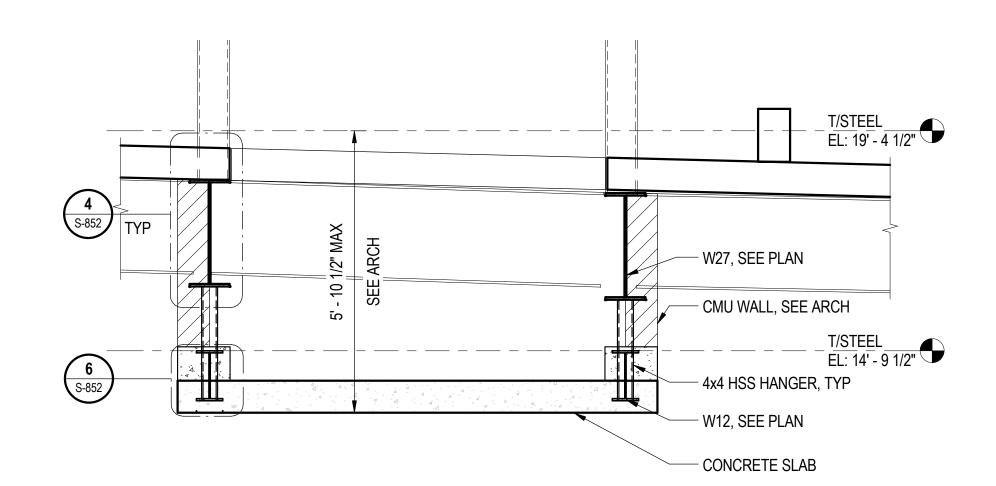

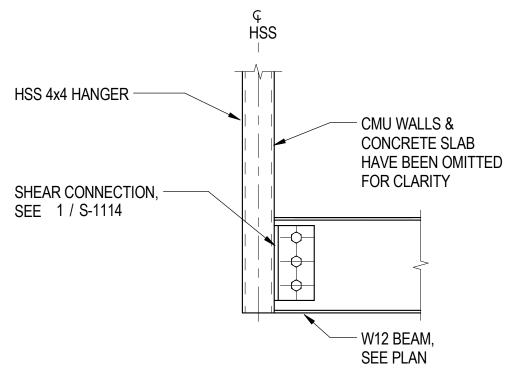

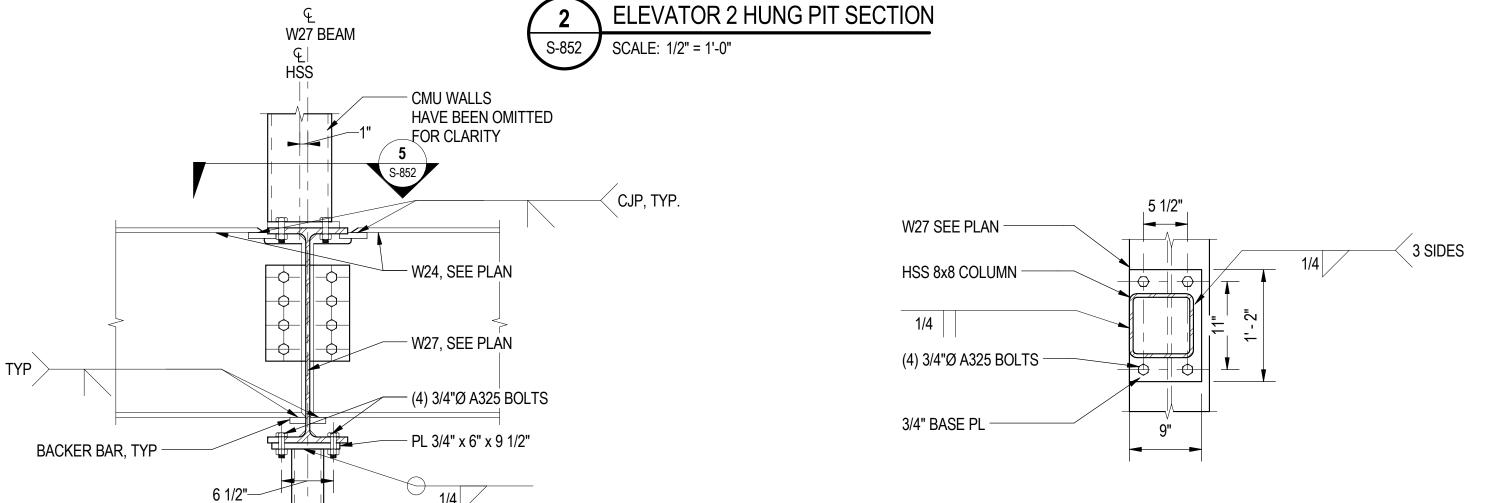

**ELEVATOR PIT BASE CONNECTION** 

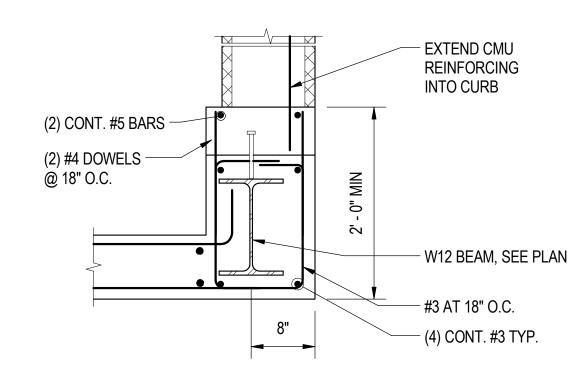

SLAB EDGE DETAIL



- HSS 4x4 HANGER

COLUMN BASE PLATE

### SHEET NOTES:

- 1. FOR GENERAL NOTES, SEE DWGS S-001 TO S-004.
- 2. FOR TYPICAL DETAILS REFER TO S-1112 TO S-1120.
- 3. CONTRACTOR TO COORDINATE PIT DIMENSIONS WITH FINAL ELEVATOR AND ESCALATOR REQUIREMENTS.
- 4. TYPICAL FLOOR CONSTRUCTION: 8" NORMAL WEIGHT CONCRETE FORMED SLAB W/ #6 BOTTOM BARS EW @ 6" O.C., #4 TOP BARS EW @ 12" O.C.

5. ALL PIT LEVEL STEEL FRAMING TO BE GALVANIZED.





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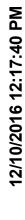
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## 95th Terminal Improvement


15 West 95th Street (South Terminal) Chicago, IL 60628

IN CH	ARGE	J. JAKALSKI
APPR	OVED BY	J. JAKALSKI
CHEC	KED BY	R.S. NAIR
DESIG	NED BY	G. FORKAN
DRAW	/N BY	D. LALLY
PROJ	ECT NO.	2012-0021.02
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**SOUTH TERMINAL ELEVATOR #2** PIT DETAILS







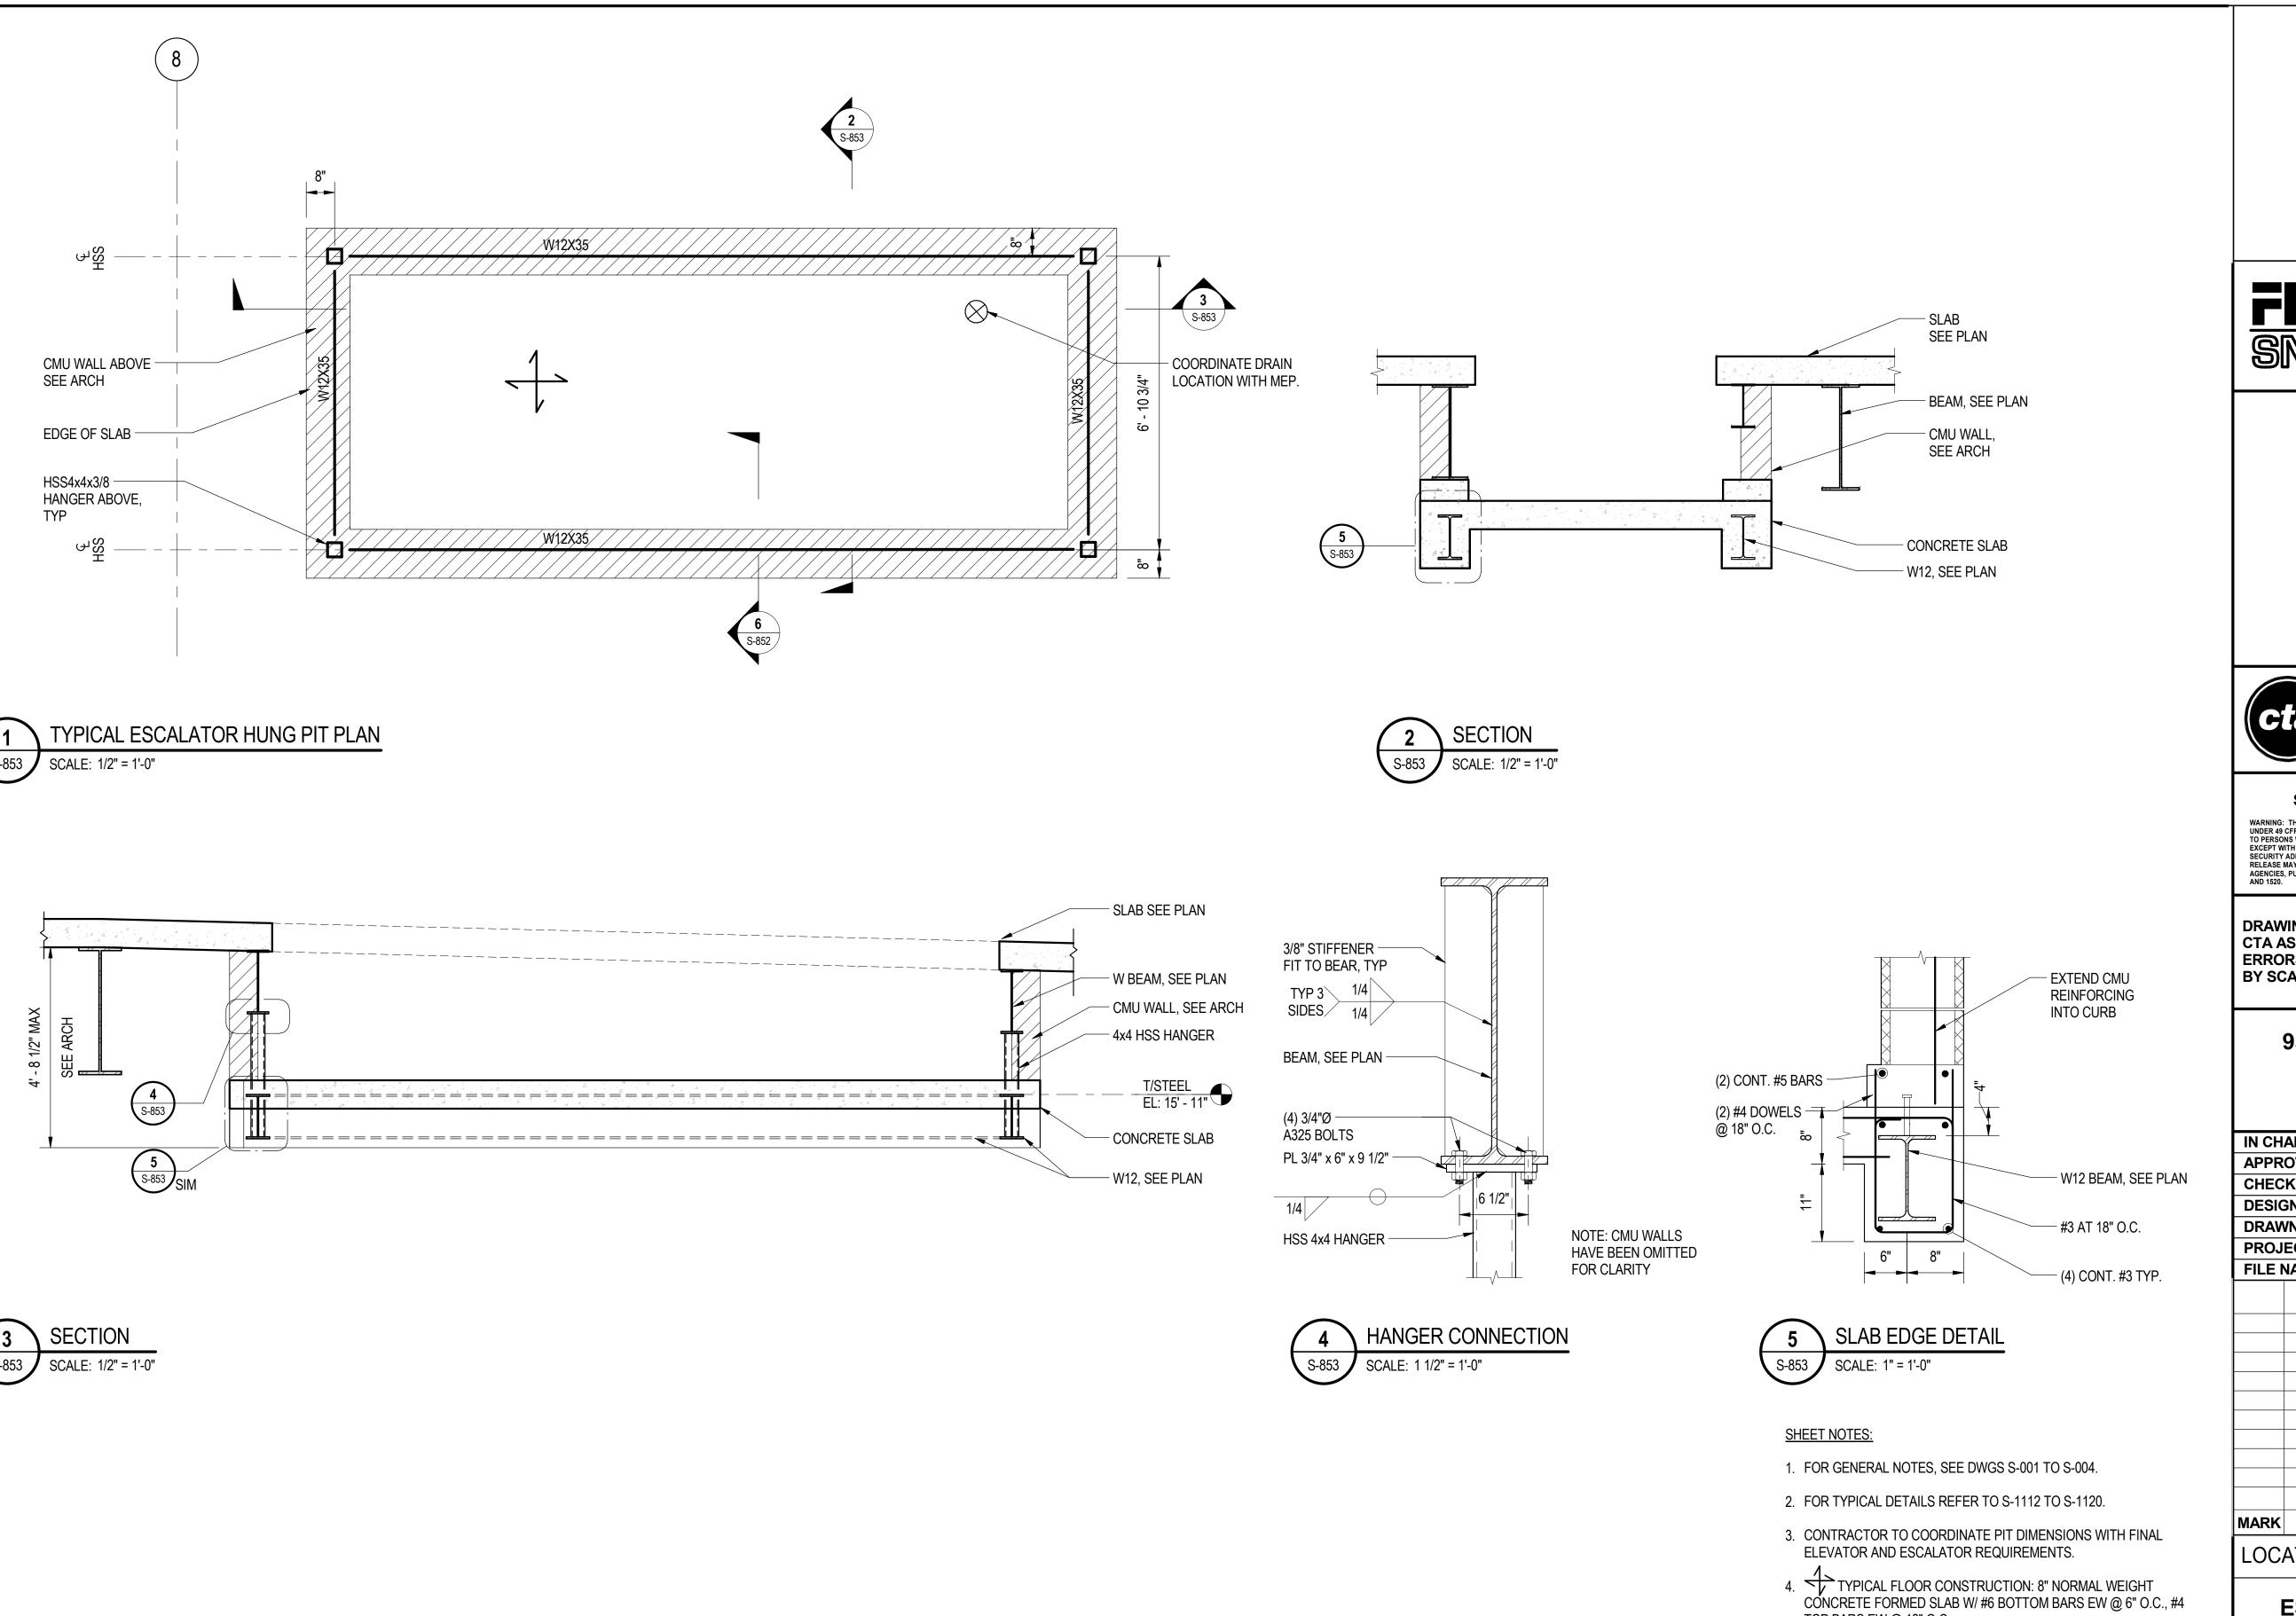

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## 95th Terminal Improvement

15 West 95th Street (South Terminal) Chicago, IL 60628

IN CH	ARGE	J. JAKALSKI	
APPR	OVED BY	J. JAKALSKI	
CHEC	KED BY	R.S. NAIR	
DESIG	ENED BY	G. FORKAN	
DRAW	/N BY	D. LALLY	D. LALLY
PROJECT NO.		2012-0021.02	
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	VIIUNI IDI	ENTIFIER:	DDOOF
LUC		INTICK.	DR095

TOP BARS EW @ 12" O.C.

5. ALL PIT LEVEL STEEL FRAMING TO BE GALVANIZED.

ESCALATOR #2 AND #3 PIT **DETAILS**